Historic Architectural Review Commission

Staff Report Item 6

Meeting Date: October 28, 2014

Applicant: Verizon Wireless

Application Number: H14-01-1106

Address: #1500 Reynolds Street

Description of Work: Installation of new wireless equipment shelter and

three antennas arrays on roof of non-historic building

at Casa Marina Hotel.

Building Facts: The building in question is a five story structure that

was built in 1986. The structure faces Seminole Avenue and is located on the northwest portion of the Casa Marina Hotel site. Casa Marina Hotel is listed as

a contributing resource and was built in 1918.

In July 13, 2010 the Commission approved the installation of similar equipment and antennas arrays on the roof of the same building for another wireless

company. That installation was completed.

In August 25, 2014 the Florida State Historic Preservation Office (FLSHPO) issued a no adverse effect letter and no visual adverse effect letter for the proposed project, if the applicant considers several recommendations. The FLSHPO review is a requirement of the National Environmental Policy Act (NEPA) for carriers to obtain FCC licenses to

telecommunication equipment.

Guidelines Cited in Review:

Air conditioning units, antennas, trash facilities and

satellite dishes (pages 42-43), specifically guidelines

1, 5 and 7.

Staff Analysis

The Certificate of Appropriateness in review proposes the installation of new wireless telecommunication equipment consisting of three arrays of antennas and a shelter, as well as their infrastructure. The proposed installation of

antennas for wireless communication will be at the top roof of the newest addition of the Casa Marina Hotel. The proposed project includes the construction of an equipment shelter structure approximately 12'-0" depth by 20'-0". The plan also includes the installation of nine wireless antennas on three mounting frames, triangular in footprint. The new antennas would extend up to eight (8) feet higher than the existing rooftop parapet wall, for a total height of 54 feet above ground level (AGL). The proposed equipment shelter will be set back from the parapet wall facing Seminole Avenue approximately twenty four feet. According to the submitted plans the westernmost mounted antennas will be approximately eight (8) feet set back from the existing parapet wall facing Seminole Avenue while the third antenna installation will be fifteen or more feet set back from the south facade.

The existing parapet wall elevates approximately 3'-5" from the roof deck. The overall height of the building is approximately 42'- 3" from roof deck to grade. Vertical metal elements, measuring two feet tall will be installed across the roof deck creating a conduit bridge.

In September 18, 2014 the proposed design obtained approval from the Planning Board (Resolution Number 2014-60) for Conditional Use and is schedule to be reviewed by the Board of Adjustments on November 18th for height variance.

The building has already three free standing telecommunication antennas located on the roof that are visible from the street. The Florida State Historic Preservation Officer letter dated August 25, 2014 includes the following recommendations in order to make a determination of no adverse visual effect;

- The new antennas are painted to match the existing color of the building.
- The equipment shelter on the roof is painted to match the existing color of the building.
- Photographic documentation of the antennas after installation is submitted to the FLSHPO.
- Removal of the communication equipment when service is disconnected.
- Restoration of the building (portions altered by this undertaking) when the communication equipment is removed.


Also in the letter there is a request to the applicant to "consider the feasibility of placing the antennas away from the edges of the roof so that they are less visible. Alternatively, mounting the antennas on the side of the building would also make them less visible".

Consistency with Guidelines

1. Two of the proposed antenna arrays, which will be located towards the northwest side of the building, will be the closest structure in the roof

- from the parapet wall facing Seminole Avenue. These antennas will be the most visible from the historic district.
- 2. The proposed shelter structure, although 4 inches higher than the existing one, will have the shortest façade facing Seminole Avenue and will be farther from the parapet wall than the existing shelter structure. Still will be visible from many streets.
- 3. The third proposed antenna array depicted in the plans towards the back portion of the structure, facing south, will not be visible from the streets.
- 4. The proposed wireless equipment will be located on the roof of a non-historic structure that contains other wireless equipment. Nevertheless the building is the highest structure within the area.

It is staff's opinion that the two arrays of antennas proposed on the northwest side of the roof and the new shelter will be visible from the streets. In order to further reduce the adverse visual impact on the historic district, the applicant shall locate the new antennas and equipment as far away from Seminole Avenue as feasible. If approved, it is staff's opinion that the recommendations from the FSHPO been incorporated as conditions to the approval.

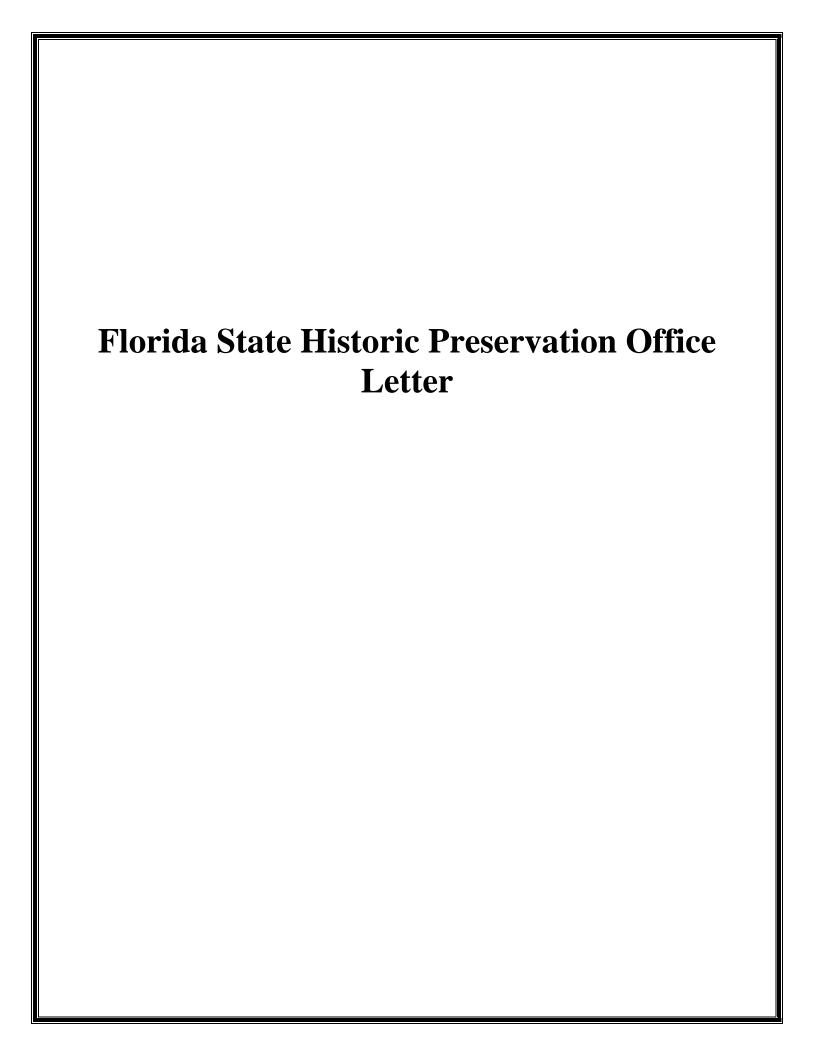



RICK SCOTT Governor

KEN DETZNER
Secretary of State

Ms. Jelane Wallace Panamerican Consultants, Inc. 5337 North Socrum Loop Road, Suite 144 Lakeland Florida 33809

August 25, 2014

RE: DHR Project File No.: 2014-3228/ Received by DHR: July 29, 2014
Federal Communications Commission
Proposed Antenna Collocation –The 62335 Casa Marina Collocation
Casa Marina Hotel Building, 1500 Reynolds Street
Key West, Monroe County, Florida

Dear Ms. Wallace:

Our office reviewed the referenced project for possible impact to historic properties listed, or eligible for listing, in the National Register of Historic Places. The review was conducted in accordance with Section 106 of the National Historic Preservation Act of 1966, as amended, 36 CFR Part 800: Protection of Historic Properties, and the National Environmental Policy Act of 1969, as amended.

We note that the proposed Verizon Wireless antennas and equipment shelter will be placed on the non-historic west wing addition (built 1986) of the Casa Marina Hotel (8MO03180). The hotel is located within the National Register listed Key West Historic District, 8MO01976. Based on the information provided, it is the opinion of this office that the proposed project will have no adverse direct effect on historic properties. In addition, if the following recommendations are followed, it is our determination that there will be no adverse visual effect on historic properties.

- The new antennas are painted to match the existing color of the building.
- The equipment shelter on the roof is painted to match the existing color of the building.
- Photographic documentation of the antennas after installation is submitted to this office.
- Removal of the communication equipment when service is discontinued.
- Restoration of the building (portions altered by this undertaking) when the communication equipment is removed.





Ms. Janssen DHR Project File No.: 2014-3228

August 25, 2014

Page 2

This office would like to ask that the applicant consider the feasibility of placing the antennas away from the edges of the roof so that they are less visible. Alternatively, mounting the antennas on the side of the building would also make them less visible. If either of these options are feasible, please notify our office and include plans for the new locations for our review and comment.

For any questions concerning our comments, please contact Robin Jackson, Historic Preservationist, by phone at 850.245.6333, or at Robin.Jackson@dos.myflorida.com. We appreciate your continued interest in protecting Florida's historic properties.

Sincerely


Robert F. Bendus, Director

Division of Historical Resources

and State Historic Preservation Officer

Pc: Enid Torregrosa, Historic Preservation Planner

Scott Wehmeyer

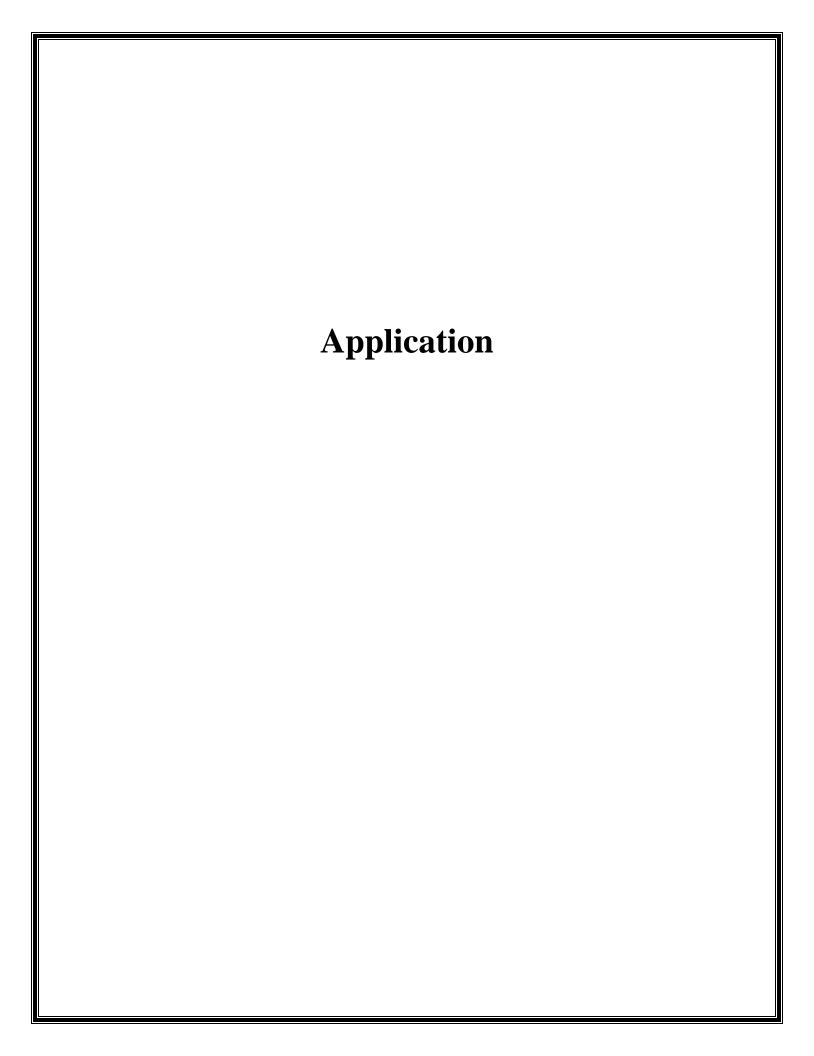



CITY OF KEY WEST BUILDING DEPARTMENT

CERTIFICATE OF APPROPRIATENENSS

APPLICATION #_-

OWNER'S	NAME:
OHILLIKO	1 47 814377

CASA MARINA LLC

DATE:

6-27-2014

OWNER'S ADDRESS:

P.O. BOX 437 BROADWAY NJ.

PHONE #:

305-296-662

APPLICANT'S NAME:

VERIZON WIRELESS

PHONE #

561-995-5500

APPLICANT'S ADDRESS:

777 N.W. 51ST. BOCARATON FL.

OF

ADDRESS OF CONSTRUCTION:

1500 REYMOLDS STREET

__ UNITS_

THERE WILL BE A FINAL INSPECTION REQUIRED UNDER THIS PERMIT

DETAILED DESCRIPTION OF WORK: INSTALLATION OF NEW WIRELESS EQUIPMENTS
SHELTER AND ANTENNAS ON ROOF AD JACENT TO EXISTING ATT
ANTENNA.

Chapter 837.06 F.S.-False Official Statements – Whoever knowingly makes a false statement in writing with the intent to mislead a public servant in the performance of his or her official duty shall be guilty of a misdemeanor of the second degree punishable as provided for in s. 775.082 or 775.083

This application for Certificate of Appropriateness must precede applications for building permits, right of way permits, variances, and development review approvals. Applications must meet or exceed the requirements outlined by the Secretary of the Interior's Standards for Rehabilitation and Key West's Historic Architectural Guidelines.

Once completed, the application shall be reviewed by staff for completeness and either approved or scheduled for presentation to the Historic Architectural Review Commission at the next available meeting. The applicant must be present at this meeting. The filing of this application does not ensure approval as submitted.

Applications that do not possess the required Submittals will be considered incomplete and will not be reviewed for approval

Date: 6-27-2014

Applicant's Signature: Asephine Conde

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TWO SETS OF SCALED DRAWINGS OF FLOOR PLAN, SITE PLAN AND EXTERIOR ELEVATIONS (for new buildings and additions)

TREE REMOVAL PERMIT (if applicable)

PHOTOGRAPHS OF EXISTING

BUILDING (repairs, rehabs, or expansions)

PHOTOGRAPHS OF ADJACENT
BUILDINGS

(new buildings and additions)

ILLUSTRATIONS OF MANUFACTURED PRODUCTS TO BE USED SUCH AS


PRODUCTS TO BE USED SUCH AS SHUTTERS, DOORS, WINDOWS, PAINT COLOR CHIPS, AND AWNING FABRIC SAMPLES OF Draw


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Fee Due:\$____


HISTORIC ARCHITECTURAL REVIEW COMMISSION USE ONLY

Approved	Denied	Deferred
Reason for Deferral or I	Denial:	
3 - 8		7 Bo - 1 F - 1 - 2
HARC Comments: Building in gu Guideh	estion in not- ins toranten	- historic nas (pages 42-43)
Limit of Work Approved Changes:	l, Conditions of Approv	val and/or Suggested
Date:		Historic Architectural Review Commission




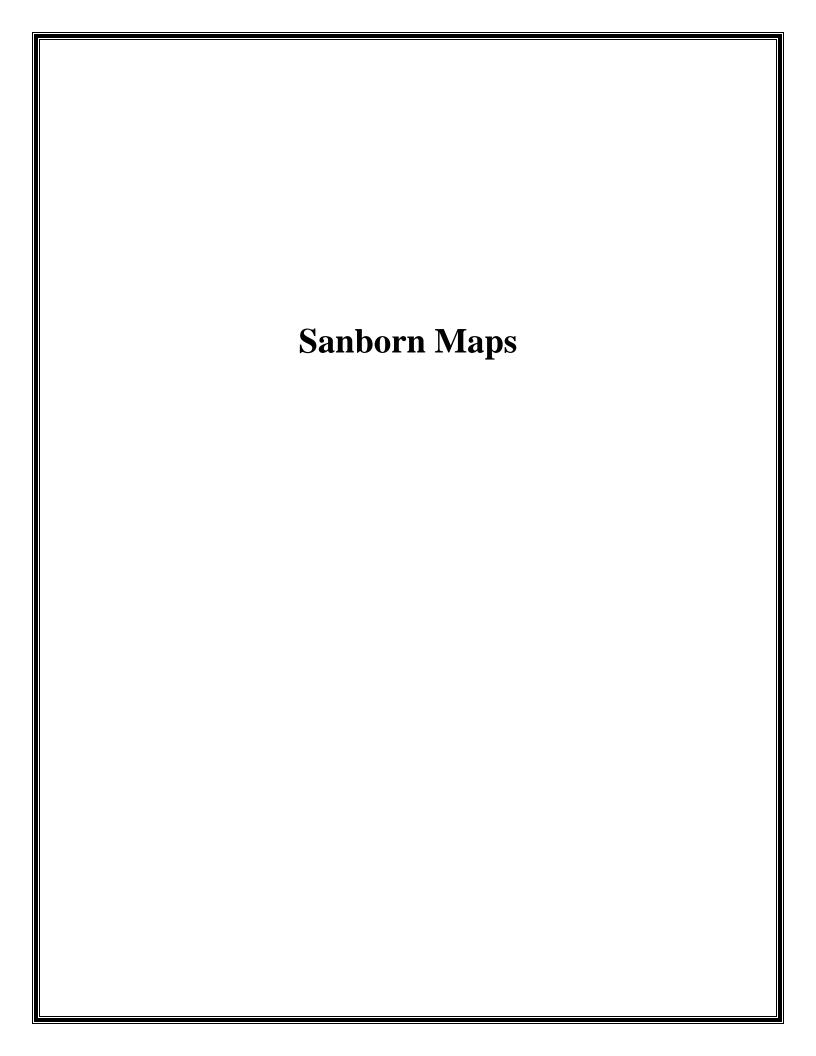
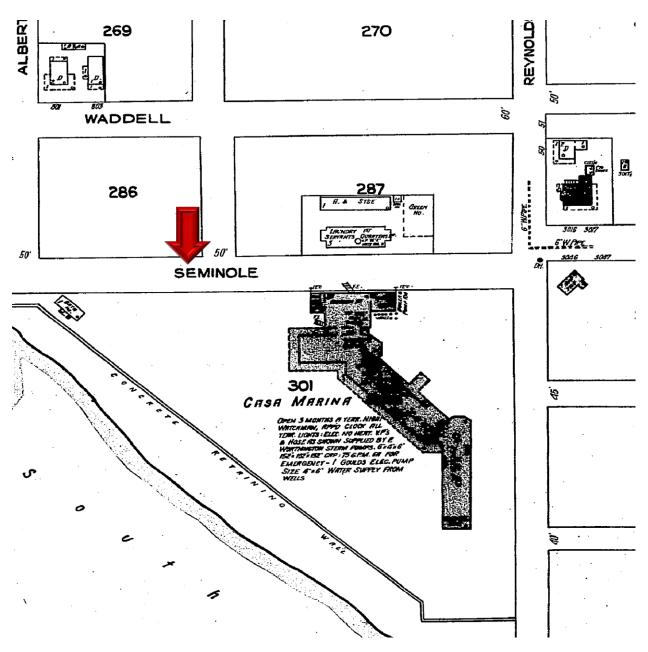
#1500 Reynolds Street Sanborn map 1926

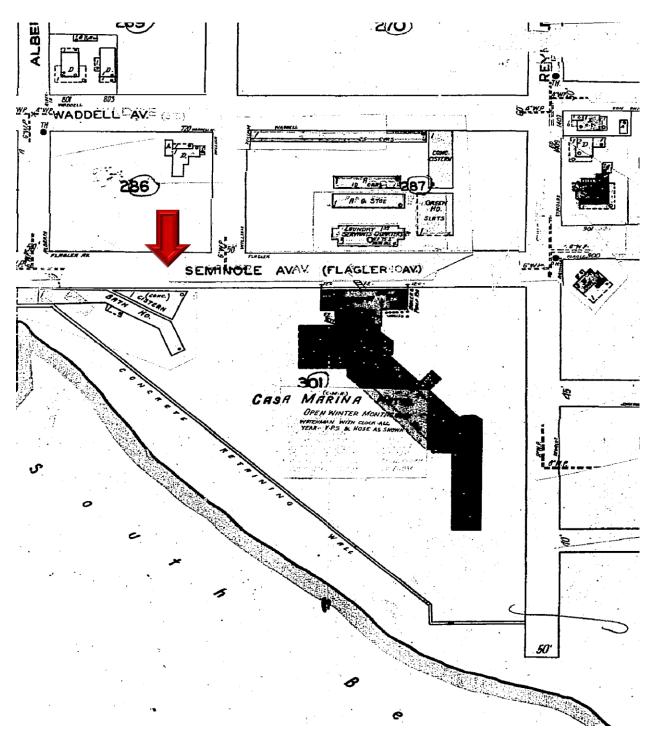


#1500 Reynolds Street Sanborn map 1948

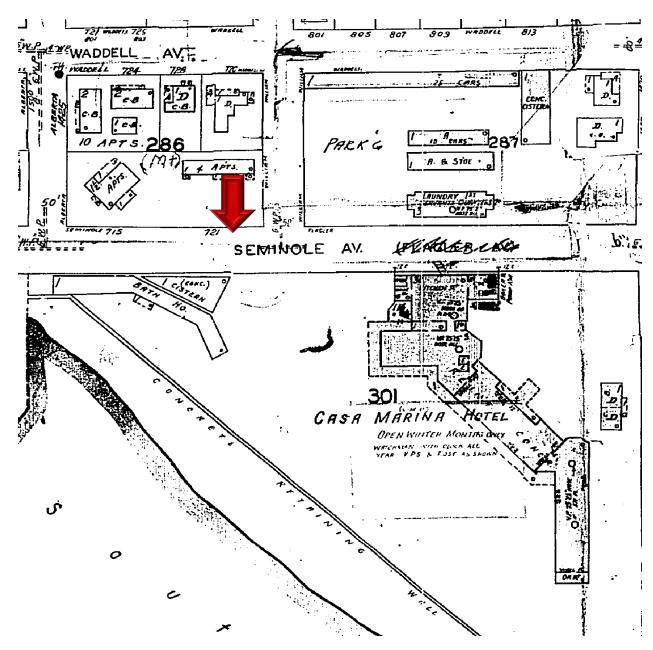


#1500 Reynolds Street Sanborn map 1962




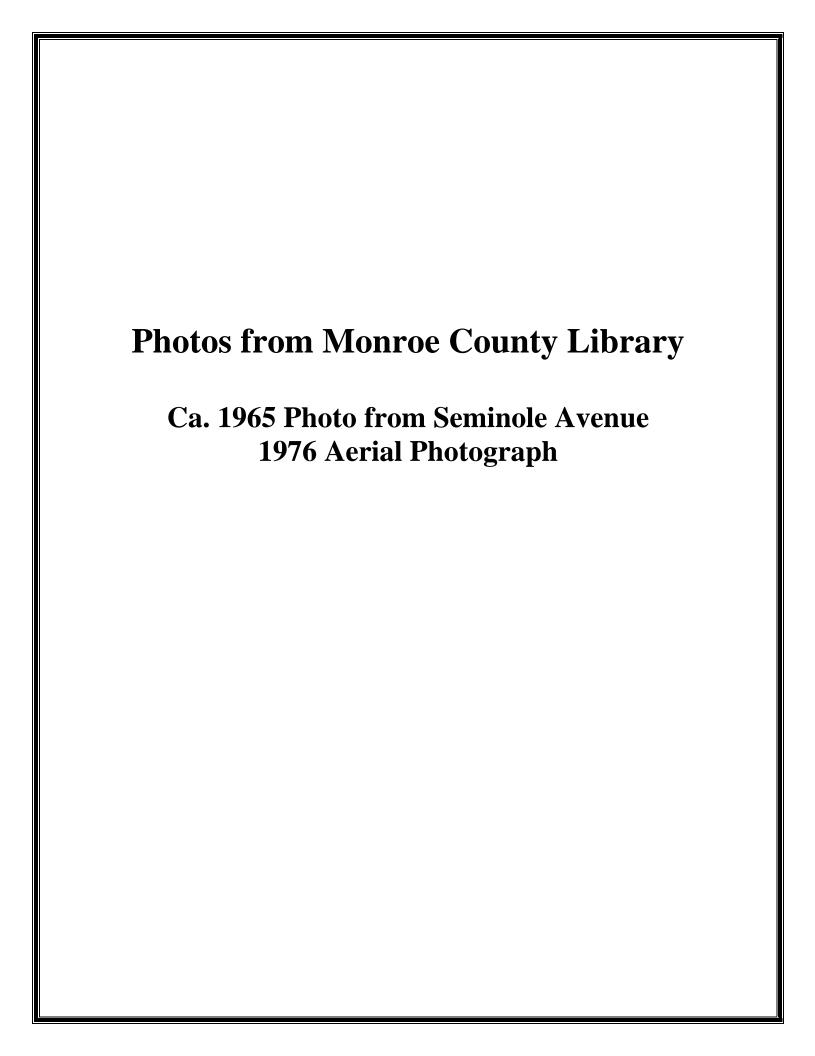







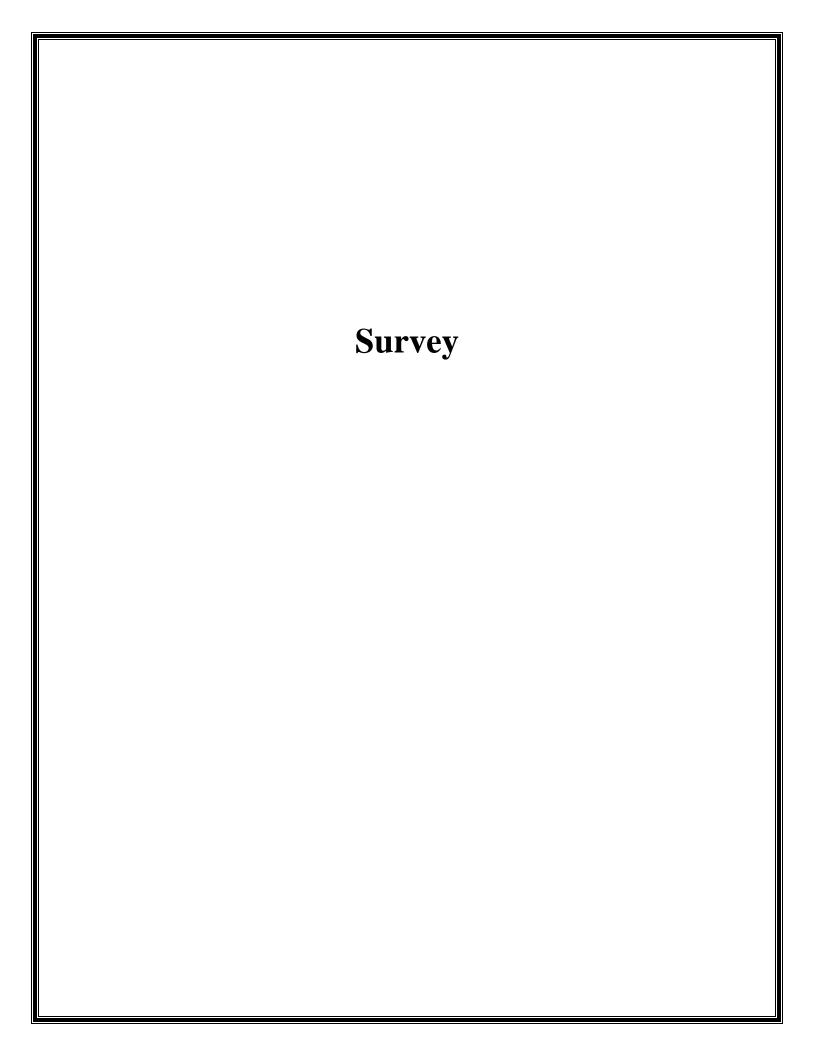

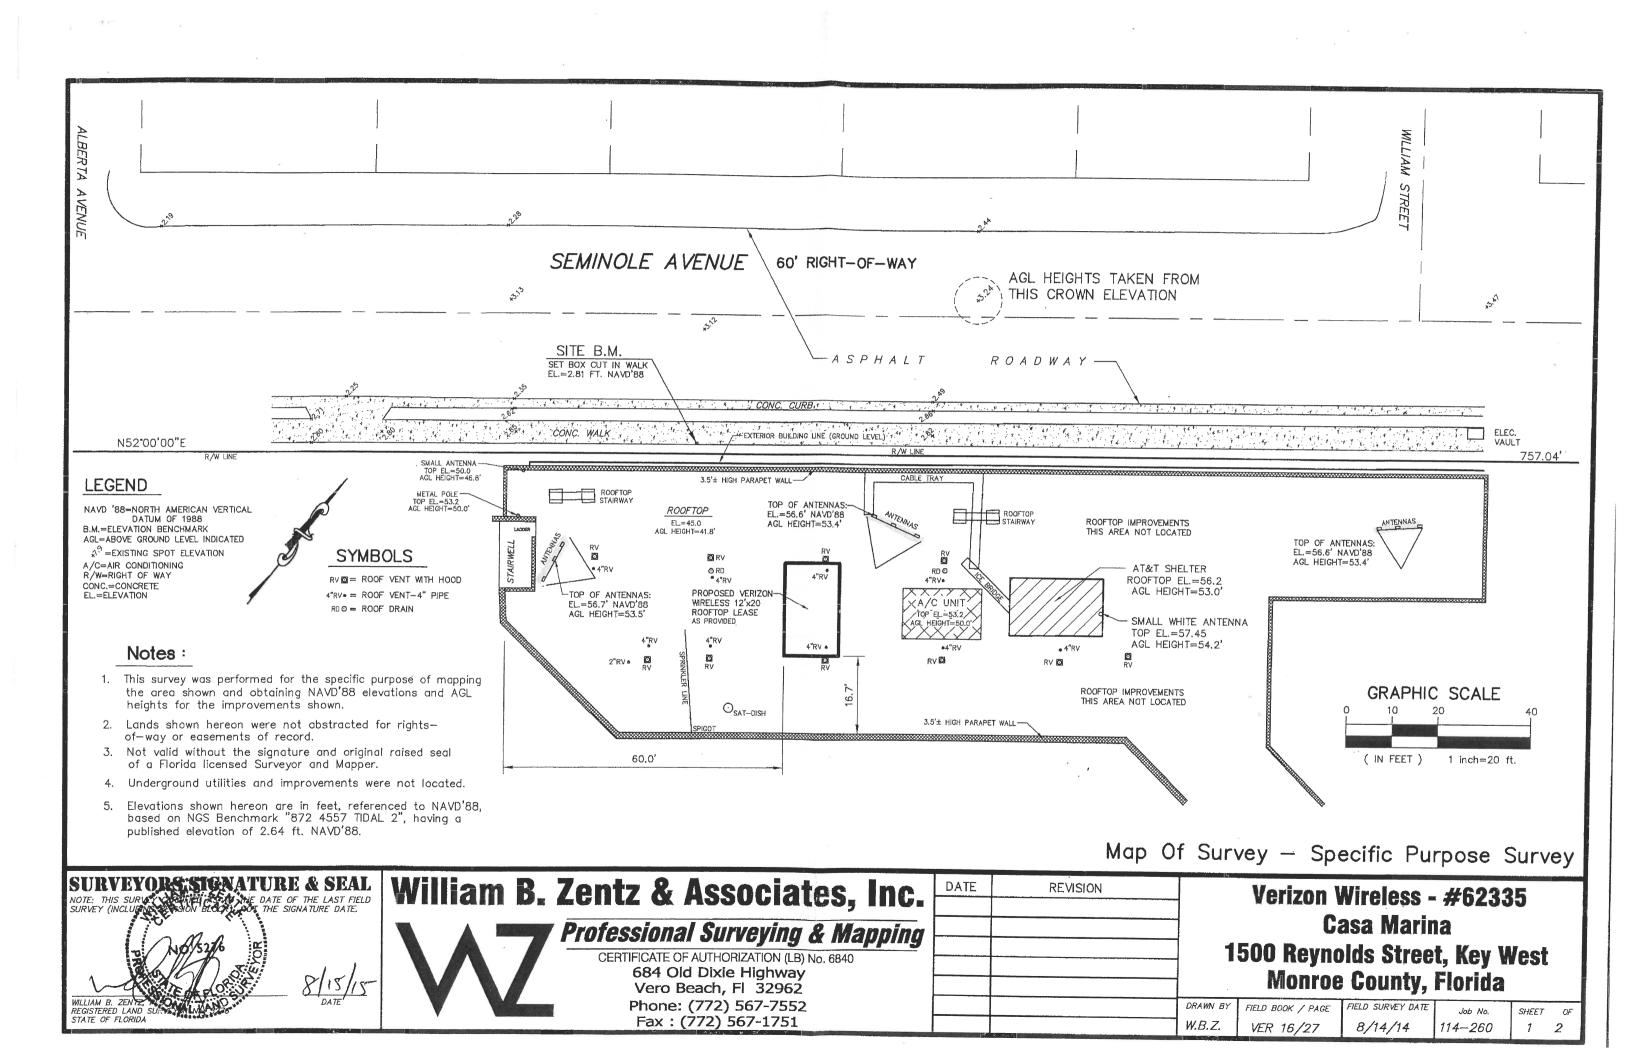

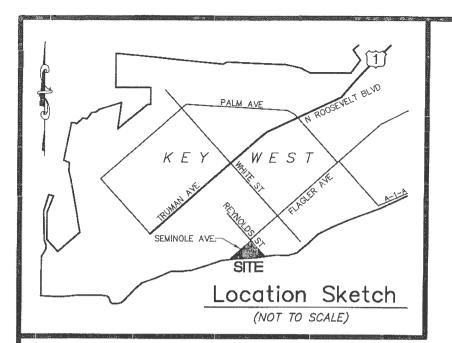

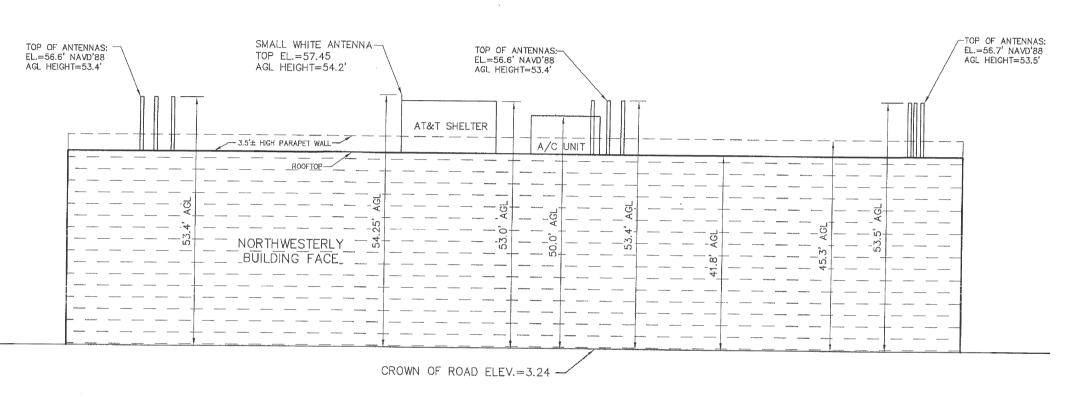

Profile View - Looking Southeasterly from Seminole Avenue

SCALE: VERTICAL: 1"=20' HORIZONTAL: NTS

Map Of Survey - Specific Purpose Survey

William B. Zentz & Associates, Inc.

WZ

Professional Surveying & Mapping

CERTIFICATE OF AUTHORIZATION (LB) No. 6840 684 Old Dixie Highway Vero Beach, Fl 32962 Phone: (772) 567-7552 Fax: (772) 567-1751

	DATE	REVISION	
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Verizon Wireless - #62335 Casa Marina 1500 Reynolds Street, Key West Monroe County, Florida

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DRAWN BY | FIELD BOOK / PAGE | FIELD SURVEY DATE | Job No. W.B.Z. | VER 16/27 | 8/14/14 | 114-260

Planning Board Resolution

PLANNING BOARD **RESOLUTION NO. 2014-60**

A RESOLUTION OF THE CITY OF KEY WEST PLANNING BOARD GRANTING WITH CONDITIONS A CONDITIONAL

USE APPROVAL FOR THE EXPANSION OF A PRIVATE UTILITY USE BY THE INSTALLATION OF NEW ROOFTOP

WIRELESS COMMUNICATION ANTENNAS AND AN

EQUIPMENT SHELTER ON PROPERTY LOCATED AT 1500

REYNOLDS STREET (RE # 00037160-000100; AK # 8735677)

WITHIN THE HISTORIC COMMERCIAL TOURIST (HCT) **ZONING DISTRICT PURSUANT TO SECTIONS 122-62 AND**

122-898(8) OF THE LAND DEVELOPMENT REGULATIONS

OF THE CODE OF ORDINANCES OF THE CITY OF KEY

WEST, FLORIDA; PROVIDING FOR AN EFFECTIVE DATE

WHEREAS, the subject property is located within the Historic Commercial Tourist (HCT)

Zoning District; and

WHEREAS, pursuant to Sections 122-62 and 122-898(8) of the Land Development

Regulations (the "LDRs") of the Code of Ordinances (the "Code") of the City of Key West, Florida

(the "City"), the applicant filed a conditional use application for the proposed installation of three

new wireless communication antenna tripods, containing three antennas each, and a new 12' x 20'

equipment shelter on the roof of a non-historic building on property located at 1500 Reynolds Street;

and

WHEREAS, City Code Section 122-62 outlines the criteria for reviewing a conditional use

application by the Planning Board; and

WHEREAS, this matter came before the Planning Board at a duly noticed public hearing on

September 18, 2014; and

Page 1 of 4

Resolution No. 2014-60

WHEREAS, the Planning Board found that the proposed use complies with the criteria in

City Code Sections 122-62 and 122-63; and

WHEREAS, the approval of the conditional use application will be in harmony with the

general purpose and intent of the LDRs, and will not be injurious to the neighborhood, or otherwise

detrimental to the public welfare.

NOW THEREFORE, BE IT RESOLVED by the Planning Board of the City of Key West,

Florida:

Section 1. That the above recitals are incorporated by reference as fully set forth herein.

Section 2. That a conditional use request, pursuant to Section 122-808 of the Code of

Ordinances of the City of Key West, Florida is hereby approved as follows: allowing three new

antenna tripods, containing three antennas each, and a 12' x 20' equipment shelter on property

located at 1500 Reynolds Street (RE # 00037160-000100; AK # 8735677), as shown on the attached

plans by Russell C. Morrison, P.E., dated June 30, 2014 with the following conditions:

General conditions:

1. The applicant shall adhere to the recommendations by the Florida State

Historic Preservation Office, according to the attached letter dated August 25, 2014.

Additionally, in order to further reduce the adverse visual impacts on the historic district, the

applicant shall locate the new antennas and equipment shelter as far away from Seminole

Avenue as possible, provided the height of the structures is not further increased.

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Chairman

 The applicant shall comply with all applicable laws and regulations, including federal requirements pertaining to air traffic safety, wireless communication facilities and

Section 106 consultation as required in the National Environmental Protection Act.

Conditions prior to issuance of a building permit:

3. The applicant shall obtain approval of a height variance from the Board of

Adjustment.

4. The proposed development shall obtain all required Certificates of

Appropriateness.

Section 3. Full, complete, and final application for all permits required for which this

resolution is wholly or partly necessary, shall be submitted in its entirety within 12 months after the

date hereof.

Section 4. This conditional use approval does not constitute a finding as to ownership or

right to possession of the property, and assumes, without finding, the correctness of applicant's

assertion of legal authority respecting the property.

Section 5. This resolution shall go into effect immediately upon its passage and adoption

and authentication by the signatures of the presiding officer and the Clerk of the Commission.

Section 6. This resolution is subject to appeal periods as provided by the City of Key

West Code of Ordinances (including the Land Development Regulations). After the City appeal

period has expired, this permit or development order will be rendered to the Florida Department of

Economic Opportunity. Pursuant to Chapter 73C-44, F.A.C., this permit or development order is not

effective for 45 days after it has been properly rendered to the DEO with all exhibits and applications

Page 3 of 4 Resolution No. 2014-60

Chairman

attached to or incorporated by reference in this approval; that within the 45-day review period the DEO can appeal the permit or development order to the Florida Land and Water Adjudicatory Commission; and that such an appeal stays the effectiveness of the permit until the appeal is resolved by agreement or order.

Read and passed on first reading at a regularly scheduled meeting held this 18th day of September, 2014.

Authenticated by the Chairman of the Planning Board and the Planning Director.

	9 30 2014
Richard Klitenick, Planning Board Chairman	Date

Attest:

Donald Letand Craig, AICP, Planning Director

Date

Filed with the Clerk:


Cheryl Smith, City Clerk

10/3/19

Date

Page 4 of 4 Resolution No. 2014-60

Chairman

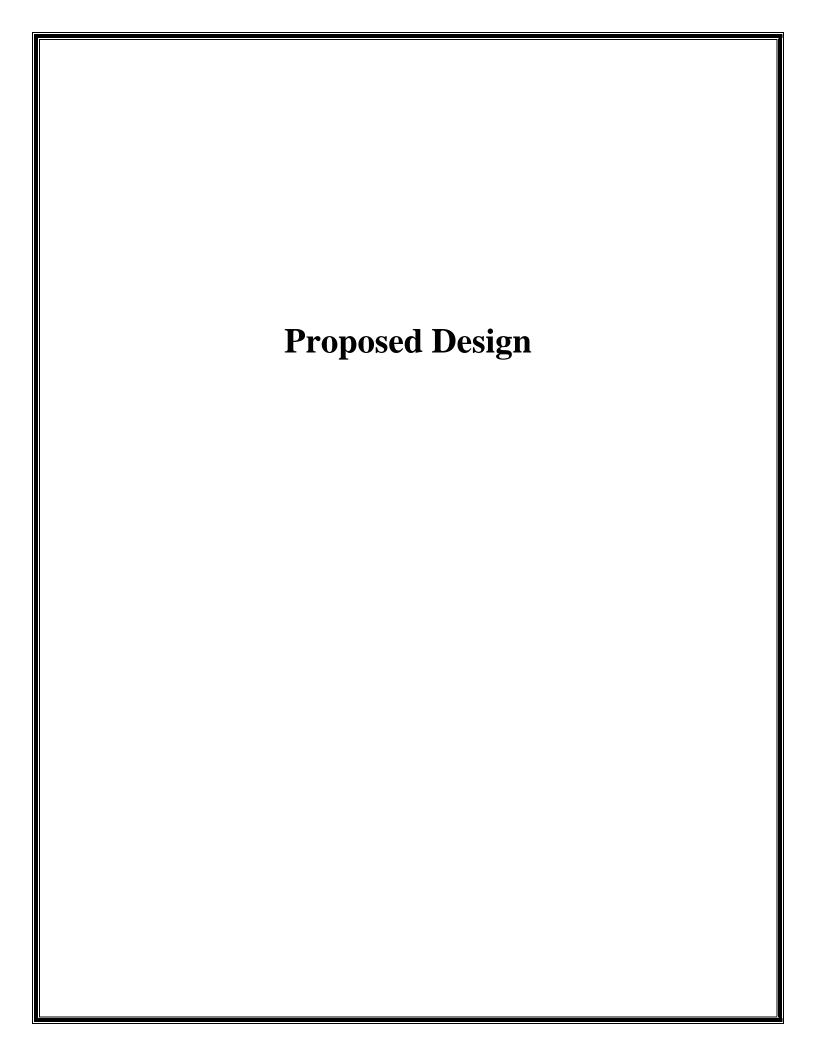




CASA MARINA

VERIZON SITE #62335

NEW PROJECT FOR WIRELESS COMMUNICATIONS SERVICE 1500 REYNOLDS STREET, KEY WEST, FLORIDA 33040

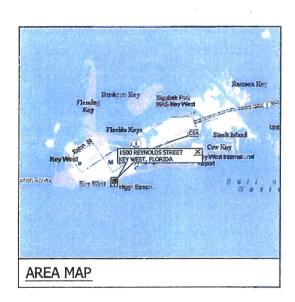



SITE NAME:	CASA MARINA						
SITE NUMBER:	62335						
SITE ADDRESS:	1500 REYNOLDS STREET						
SUITE ADDINESS:							
	KEY WEST, FL 33040						
APPLICANT: NAME:	VERTZON WIRELESS						
ADDRESS:	777 YAMATO ROAD, SUITE 600						
	BOCA RATON, FLORIDA 33431						
	a .						
LATITUDE:	24° 32' 50.41"						
LONGITUDE:	-81° 47' 29.13"						
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CEEE THEODY							
SITE INFORMATION							

SHEET	DESCRIPTION	REV.
T-1	TITLE SHEET	0
G-1	GENERAL NOTES	0
A-1	ROOF PLAN	0
A-2	BUILDING ELEVATIONS	0
A-2A	NORTHWEST BUILDING ELEVATIONS	0
A-2B	SOUTHEAST BUILDING ELEVATIONS	0
A-2C	ADJACENT PROPERTIES EXHIBIT	0
A-3	RF PLAN	0
A-4	CONSTRUCTION DETAILS	0
5-1	STRUCTURAL PLATFORM PLAN AND SECTION	0
S-2	SHELTER SECTIONS AND DETAILS	0
S-3	STRUCTURAL DETAILS	Ω
5-4	ANTENNA FRAME PLAN AND SECTIONS	٥
5-5	ANTENNA DETAILS	0
E-1	ELECTRICAL AND GROUNDING NOTES	0
E-2	ELECTRICAL SITE PLAN	0
E-3	ELECTRICAL AND TELCO RISER DIAGRAM	
E-4	ELECTRICAL DETAILS	
E-5	ELECTRICAL DETAILS	

INSTALLATION OF NEW WIRELESS EQUIPMENT AND ANTENNAS FOR ENHANCED WIRELESS COMMUNICATIONS SERVICE
PROJECT SUMMARY

APPLICANT/OWNER:



777 YAMATO ROAD, SUITE 600 BOCA RATON, FLORIDA 33431

PROJECT NAME AND LOCATION:

CASA MARINA VERIZON SITE #62335 1500 REYNOLDS STREET KEY WEST, FL 33040

PROJECT ENGINEER



ENGINEERING AND EQUIPMENT LLC

ISSUED FOR

CONSTRUCTION PLANS

SUBMITTALS

REV. DATE DESCRIPTION

PROJECT NUMBER

DRAWN BY CHECKED APPROVED

APPROVING AGENCY

CITY OF KEY WEST, FLORIDA

BUILDING CODE

2010 FLORIDA BUILDING CODE

SHEET TITLE

COVER SHEET

SHEET NUMBER

T-1

STANDARD PROVISIONS

- CONSTRUCTION PLANS AND SPECIFICATIONS DESCRIBE THE WORK TO BE PERFORMED AND THE MATERIALS REQUIRED FOR THE PROPER CONSTRUCTION
- 2. CONSTRUCTION PLANS AND SPECIFICATIONS ARE INTENDED TO BE FULLY EXPLANATORY AND COMPLEMENTARY. THOUGH, SHOULD ANY MATERIAL OR SPECIFICATION BE SHOWN, INDICATED OR SPECIFIED ON ONE SHEET AND NOT ANOTHER. IT SHALL BE THE SAME AS IF SHOWN, INDICATED OR SPECIFIED ON
- 3. THE INTENTION OF THE CONSTRUCTION DOCUMENTS IS TO INCLUDE ALL LABOR AND MATERIALS REASONABLY NECESSARY FOR THE COMPLETION OF THE WORK.
- THE PURPOSE OF ANY SPECIFICATIONS IS TO SUPPLEMENT THE INTENT OF THE CONSTRUCTION PLANS AND TO DESIGNATE A PROCEDURE, TYPE OR QUALITY OF
- MATERIALS REQUIRED TO COMPLETE THE WORK.

 5. MINOR DEVIATIONS FROM THE DESIGN LAYOUT MAY OCCUR AND SHALL BE CONSIDERED AS PART OF THE WORK. HOWEVER, NO CHANGES THAT ALTER THE INTENT OF THE DESIGN OF THE PROJECT WILL BE MADE OR PERMITTED WITHOUT PERMISSION OF THE OWNER AND ENGINEER.

- MEASUREMENTS ON THE CONSTRUCTION PLANS BEFORE ORDERING ANY MATERIAL OR PERFORMING ANY WORK. NO EXTRA COMPENSATION SHALL BE ALLOWED DUE TO DISCREPANCIES BETWEEN THE ACTUAL DIMENSIONS IN THE FIELD AND THE DIMENSIONS INDICATED ON THE CONSTRUCTION PLANS. ANY DISCREPANCY IN DIMENSION WHICH MAY INADVERTENTLY OCCUR SHALL BE SUBMITTED TO THE OWNER AND ENGINEER FOR CONSIDERATION BEFORE THE CONTRACTOR PROCEEDS WITH THE WORK IN THE AFFECTED AREA
- 2. THE CONTRACTOR, WHEN AWARDED THE CONTRACT, WILL NOT BE ALLOWED ANY EXTRA COMPENSATION BY REASON OF ANY MATTER WHICH THE CONTRACTOR DID NOT REQUEST ADDITIONAL INFORMATION ON PRIOR TO THE BID.
- 3. NO PLEA OF IGNORANCE OF CONDITIONS THAT EXIST, OR OF DIFFICULTIES ENCOUNTERED OR ANY OTHER RELEVANT MATTER CONCERNING THE WORK TO BE PERFORMED WILL BE ACCEPTED AS A REASON FOR ANY FAILURE OR OMISSION ON THE PART OF THE CONTRACTOR TO FULFILL THE OBLIGATIONS OF

- PROTECTION OF WORK AREA

 1. CONTRACTOR TO PROTECT THE WORK AREA, WHETHER INDOORS OR OUTDOORS.

 MAINTAIN FINISHED SURFACES CLEAN AND SUITABLY PROTECTED UNTIL CONSTRUCTION IS COMPLETE AND ACCEPTED BY THE OWNER OR OWNER'S
- 2. PROTECT FINISHED SURFACES, INCLUDING JAMBS AND HEADS OF OPENINGS USED AS PASSAGEWAYS THROUGH WHICH EQUIPMENT AND MATERIALS MUST
- 3. PROVIDE PROTECTION OF EQUIPMENT ROOM SURFACES PRIOR TO CONSTRUCTION ACTIVITIES IN THESE AREAS.

REPAIRS AND REPLACEMENT OF DAMAGED ITEMS 1. IN THE EVENT OF DAMAGE TO EXISTING FACILITIES, THE CONTRACTOR SHALL

PROMPTLY MAKE ALL REPLACEMENTS AND REPAIRS AT NO ADDITIONAL COST TO THE OWNER OR PROPERTY OWNER.

- STORAGE OF MATERIALS AND TOOLS

 1. CONTRACTOR IS NOT TO UTILIZE THE EXISTING BUILDING SPACE FOR STORAGE OF MATERIALS OR TOOLS WITHOUT THE APPROVAL OF THE PROPERTY OWNER

 2. ALL MATERIALS MUST BE STORED IN A LEVEL AND DRY LOCATION AND IN A
- MANNER NOT TO OBSTRUCT THE FLOW OF OTHER WORK. ALL EQUIPMENT OR MATERIAL STORAGE MUST ALSO MEET THE SPECIFICATIONS OF THE

TEMPORARY FACILITIES

. CONTRACTOR IS RESPONSIBLE FOR COORDINATING WITH LOCAL UTILITIES TO PROVIDE TEMPORARY ELECTRIC AND TELEPHONE SERVICE AS NECESSARY TO COMPLETE THE PROJECT. THE CONTRACTOR MAY USE EXISTING ELECTRIC AND TELEPHONE FACILITIES ONLY WITH OWNER APPROVAL. ANY TEMPORARY POWER CORDS MUST BE STORED DURING NON WORKING HOURS

- <u>CLEAN UP</u>

 1. CONTRACTOR SHALL KEEP THE SITE CLEAR OF DEBRIS AND TRASH DUE TO CONSTRUCTION ACTIVITIES. AT THE COMPETION OF THE PROJECT, CONTRACTOR
 TO REMOVE ALL TOOLS SCAFFOLDING AND SURPLUS MATERIALS AND SHALL LEAVE THE WORK AREA CLEAN AND READY FOR USE BY THE OWNER.
- CONTRACTOR TO VISUALLY INSPECT ALL EXTERIOR SURFACES AND REMOVE SOIL,
 WASTE MATERIALS, AND OTHER FOREIGN MATTER. REMOVE ALL SPLASHED MATERIALS FROM ALL FINISHED AND OTHER SURFACES.

 3. CONTRACTOR TO VISUALLY INSPECT ALL INTERIOR SURFACES AND REMOVE WASTE
- MATERIALS, FOREIGN MATTER, PAINT DROPPINGS, SPOTS, STAINS, AND SOIL FROM FINISHED SURFACES.

- 1. CONTRACTOR TO SUBMIT SHOP DRAWINGS AND SPECIFICATIONS AS REQUIRED TO THE OWNER AND/OR ENGINEER FOR APPROVAL.
- 2. ALL SHOP DRAWINGS TO BE REVIEWED, CHECKED, AND CORRECTED BY THE GENERAL CONTRACTOR PRIOR TO SUBMITTAL TO THE OWNER OR CONSTRUCTION

PRODUCTS AND SUBSTITUTIONS

1. SUBMIT 3 COPIES OF FACH REQUEST FOR SUBSTITUTION IN FACH REQUEST. IDENTIFY THE PRODUCT FABRICATION OR INSTALLATION METHOD TO BE REPLACED BY THE SUBSTITUTION. INCLUDE RELATED SPECIFICATION SECTION AND DRAWING NUMBERS, AND COMPLETE DOCUMENTATION SHOWING COMPLIANCE WITH THE REQUIREMENTS FOR SUBSTITUTIONS.

- COMPLIANCE

 1. ALL MATERIALS, DESIGN, AND WORKMANSHIP SHALL BE IN ACCORDANCE WITH ALL APPLICABLE LOCAL, STATE, AND FEDERAL CODES, ORDINANCES, AND AUTHORITIES.

 APPLICABLE TOWN OF THE WORK THE HAVING JURISDICTION OVER THE WORK. UPON COMPLETION OF THE WORK, THE CONTRACTOR SHALL PROVIDE THE OWNER WITH A CERTIFICATE OF OCCUPANCY (IF REQUIRED BY THE LOCAL GOVERNING JURISDICTION) AND OTHER LEGAL DOCUMENTS TO VERIFY SUCH COMPLIANCE. WHERE NO CODES EXIST, THE WORK SHALL CONFORM WITH THE 2010 FLORIDA BUILDING CODE WITH LATEST SUPPLEMENTS OR THE CONSTRUCTION PLAN SPECIFICATIONS, WHICHEVER IS MOST STRINGENT AND A DOCUMENT STATEMENT SHALL BE FURNISHED TO THAT EFFECT
- 2. IT IS THE CONTRACTOR'S RESPONSIBILITY TO VERIFY COMPLIANCE WITH GOVERNING CODES AND TO NOTIFY THE OWNER IF ANY DISCREPANCIES PRIOR TO PERFORMING
- 3. REFERENCE TO ANY STANDARD CODE OR PRACTICE IN THIS SPECIFICATION SHALL BE DEEMED TO REFLECT THE MOST CURRENT EDITION AT THE TIME OF AWARD OF THE CONTRACT. IN ADDITION, LOCAL AMENDMENTS TO STANDARD CODES WILL APPLY. THE CONTRACTOR SHALL COMPLY WITH ALL ZONING AND SITE ACQUISITION STIPULATIONS AS OUTLINED IN ANY ZONING APPROVAL OF THE
- 4. THE FOLLOWING CODES ARE THE MINIMUM THAT WILL BE REQUIRED FOR THE CONTRACTOR TO ADHERE TO THE LATEST EDITIONS OF THE:
 - -2010 FLORIDA BUILDING CODE -BUILDING OFFICIALS AND CODE ADMINISTRATORS (BOCA)
 - -NATIONAL ELECTRIC CODE (NEC)
 - -ANSI/TIA/EIA-222-REVISION G
 - -LIFE SAFETY CODE NFPA-LATEST EDITION
 - -FEDERAL AVIATION REGULATIONS-LATEST EDITION -UNDERWRITERS LABORATORIES

COORDINATION WITH LOCAL PUBLIC UTILITIES

1. THE CONTRACTOR WILL COORDINATE WITH LOCAL UTILITIES FOR THE ELECTRIC AND TELEPHONE REQUIREMENTS OF THE SITE. THE CONTRACTOR WILL ALSO COORDINATE WITH ALL OTHER RELEVANT UTILITIES INCLUDING WATER, SEWER, STORMWATER, CABLE TELEVISION, AND ANY OTHERS TO PROTECT ANY OF THESE UTILITIES ON THE PROJECT SITE DURING THE COURSE OF CONSTRUCTION.

. CONTRACTOR SHALL HAVE EVIDENCE OF ALL REQUIRED PERMITS AND LICENSES AVAILABLE ON SITE AS REQUIRED FOR LOCAL INSPECTION AUTHORITIES

I. THE CONTRACTOR SHALL NOTIFY THE OWNER AT LEAST 24 HOURS IN ADVANCE OF ALL REQUIRED INSPECTIONS. THE CONTRACTOR SHALL BE RESPONSIBLE TO ENSURE THAT REQUIRED INSPECTIONS BY PERMITTING AUTHORITIES ARE CARRIED OUT IN A TIMELY MANNER SO AS NOT TO DELAY THE PROJECT CONSTRUCTION. THE CONTRACTOR SHALL PROVIDE DOCUMENTATION OF ALL INSPECTIONS. THE CONTRACTOR IS RESPONSIBLE FOR COORDINATING WITH THE OWNER'S TESTING LABORATORY OR ENGINEERING FIRM TO OBTAIN ALL REQUIRED INSPECTIONS AND TESTING. THE CONTRACTOR IS TO PROVIDE RESULTS OF ALL TESTING TO THE OWNER.

1. THE CONTRACTOR IS RESPONSIBLE FOR ALL SAFETY INCLUDING BY NOT LIMITED TO PROTECTION OF ALL SITE PERSONNEL AND THE GENERAL PUBLIC DURING THE ENTIRE CONSTRUCTION PERIOD. THE CONTRACTOR SHALL TAKE ALL REASONABLE PRECAUTIONS TO INSTALL AND MAINTAIN ALL SAFETY DEVICES, INCLUDING, BUT NOT LIMITED TO, BARRICADES, LAMPS, SIGNS, BARRIERS. WARNING TAPES, AND OTHER ITEMS IN ACCORDANCE WITH OSHA SAFETY ACT AND ANSI OCCUPATIONAL GUIDELINES,

ENVIRONMENTAL PROTECTION

- NOISE LEVEL: THE CONTRACTOR SHALL ENSURE THAT ALL STATE AND LOCAL REGULATIONS REGARDING ACCEPTABLE NOISE LEVELS ARE ADHERED TO DURING THE COURSE OF CONSTRUCTION ACTIVITIES.
- 2. DUST CONTROL: THE CONTRACTOR SHALL IMPLEMENT NECESSARY DUST CONTROL MEASURES TO LIMIT THE RELEASE OF FUGITIVE DUST DURING THE COURSE OF CONSTRUCTION ACTIVITIES.

. EACH CONTRACTOR AND SUB-CONTRACTOR SHALL AT HIS OWN EXPENSE CARRY AND MAINTAIN FOR THE DURATION OF THE PROJECT ALL INSURANCE AND BONDS AS REQUIRED AND SHALL NOT COMMENCE WITH HIS WORK UNTIL HE HAS PRESENTED ALL CERTIFICATES OF INSURANCE TO THE OWNER.

ACTIVITIES SHALL BE REPAIRED TO A CONDITION EQUAL TO OR BETTER THAN THE CONDITION PRIOR TO THE DAMAGE OF THE FACILITIES.

AS—BUILT DRAWINGS

1. THE CONTRACTOR SHALL PREPARE A RED LINED SET OF AS—BUILT DRAWINGS IN THE FORM OF MARKED UP CONSTRUCTION PLANS THAT SHALL BE PROVIDED. TO THE OWNER. AS-BUILT PLANS WILL BE PROVIDED TO THE OWNER WITHIN 2 WEEKS OF PRACTICAL COMPLETION OF THE PROJECT.

APPLICANT/OWNER:



777 YAMATO ROAD, SUITE 600 **BOCA RATON, FLORIDA 33431**

PROJECT NAME AND LOCATION:

CASA MARINA VERIZON SITE #62335 1500 REYNOLDS STREET KEY WEST, FL 33040

PROJECT ENGINEER



ENGINEEDING AND EQUIDMENT LLC 820 W. INDIANTOWN ROAD, SUITE 105 JUPITER ELORIDA 33458 FLORIDA CA#29678

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JUNE 5, 2014

ISSUED FOR CONSTRUCTION PLANS

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DATE DESCRIPTION	

PROJECT NUMBER

1 201403-09

DRAWN BY CHECKED APPROVED

APPROVING AGENCY

CITY OF KEY WEST, FLORIDA

BUILDING CODE


2010 FLORIDA BUILDING CODE

SHEET TITLE

GENERAL NOTES

SHEET NUMBER

G-1

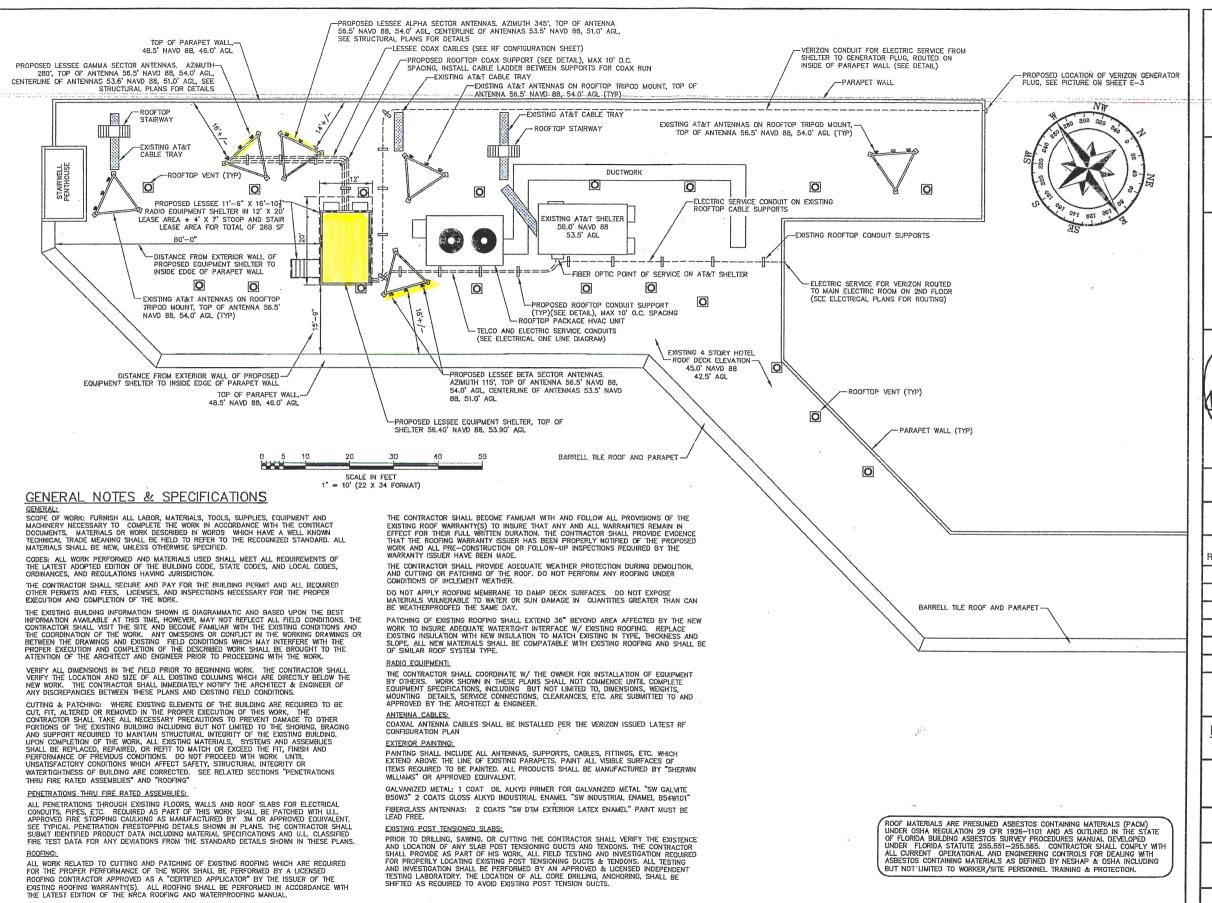

APPLICANT/OWNER:



777 YAMATO ROAD, SUITE 600 **BOCA RATON, FLORIDA 33431**

PROJECT NAME AND LOCATION:

CASA MARINA VERIZON SITE #62335 1500 REYNOLDS STREET KEY WEST, FL 33040

PROJECT ENGINEER



ENGINEERING AND EQUIPMENT LLC 820 W. INDIANTOWN ROAD, SUITE 105 JUPITER, FLORIDA 33458 Julianilli. FLORIDA CA#29673 C. MORK

ENGINEER SEAL CENSE No. 51567

STATE OF

30/14 FLORIDA RUSSELL C. MORRISON P.E. FLORIDA P.E. #51567 MA

DATE OF ISSUE/// | | | | |

JUNE 30, 2014

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APPROVING AGENCY CITY OF KEY WEST, FLORIDA

BUILDING CODE


2010 FLORIDA BUILDING CODE

SHEET TITLE **ROOF AND PENTHOUSE** PLAN

SHEET NUMBER

OVERALL ROOF PLAN-CASA MARINA RESORT-1500 REYNOLDS STREET-KEY WEST, FLORIDA


ROOF PLAN BASED ON INFORMATION PROVIDED BY PROPERTY OWNER

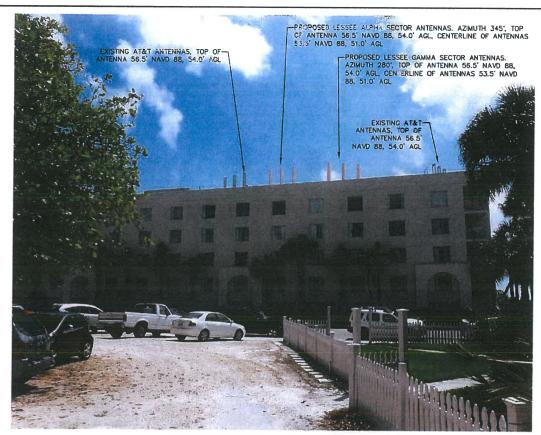

NORTHWEST BUILDING ELEVATION



SOUTHEAST BUILDING ELEVATION

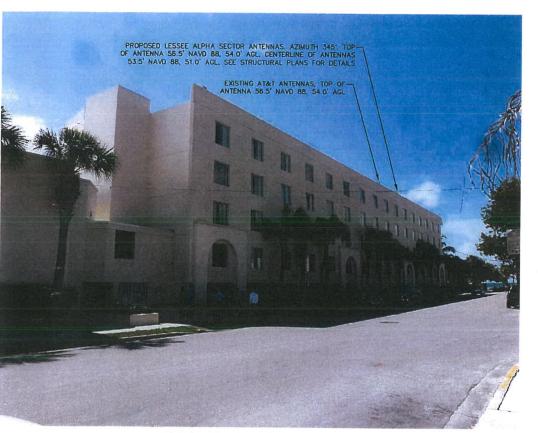

NORTHEAST BUILDING ELEVATION





777 YAMATO ROAD, SUITE 600 BOCA RATON, FLORIDA 33431

PROJECT NAME AND LOCATION:

CASA MARINA VERIZON SITE #62335 1500 REYNOLDS STREET KEY WEST, FL 33040

PROJECT ENGINEER



WAYPOINT

ENGINEERING AND EQUIPMENT LLC 820 W. INDIANTOWN ROAD, SUITE 105 JUPITER, FLORIDA 33458 PHONE: 561-252-1220 FLORIDA CA#29673

ENGINEER SEAL ON NO. 1

RUSSELL C. MORRISON P. F. FLORION P.E. #51567 ON AL

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APPROVING AGENCY

CITY OF KEY WEST, FLORIDA

BUILDING CODE

2010 FLORIDA BUILDING CODE

SHEET TITLE BUILDING ELEVATIONS

PLAN
SHEET NUMBER

A-2

BUILDING ELEVATIONS-CASA MARINA-1500 REYNOLDS STREET, KEY WEST, FLORIDA



APPLICANT/OWNER:



777 YAMATO ROAD, SUITE 600 BOCA RATON, FLORIDA 33431

PROJECT NAME AND LOCATION:

CASA MARINA VERIZON SITE #62335 1500 REYNOLDS STREET KEY WEST, FL 33040

PROJECT ENGINEER



WAYPOINT

ENGINEERING AND EQUIPMENT LLC 820 W. INDIANTOWN ROAD, SUITE 105 JUPITER FLORIDA 33458 PHONE: 561-252-1220 FLORIDA CA#29673

ENGINEER SEAL

RUSSELL C. MORRISON, P.E. FLORIDA P.E. #51567

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APPROVING AGENCY

RCM

CITY OF KEY WEST, FLORIDA

BUILDING CODE

2010 FLORIDA BUILDING CODE

SHEET TITLE
PHOTO SIMULATION

EXHIBIT
SHEET NUMBER

A-2A



APPLICANT/OWNER:



777 YAMATO ROAD, SUITE 600 BOCA RATON, FLORIDA 33431

PROJECT NAME AND LOCATION: CASA MARINA VERIZON SITE #62335 1500 REYNOLDS STREET KEY WEST, FL 33040

PROJECT ENGINEER



ENGINEERING AND EQUIPMENT LLC 820 W. INDIANTOWN ROAD, SUITE 105 JUPITER, FLORIDA 33458 PHONE: 551-252-1220 FLORIDA CA#29673

ENGINEER SEAL

RUSSELL C. MORRISON, P.E. FLORIDA P.E. #51567

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APPROVING AGENCY

CITY OF KEY WEST, FLORIDA

BUILDING CODE

2010 FLORIDA BUILDING CODE

SHEET TITLE PHOTO SIMULATION EXHIBIT

SHEET NUMBER

A-2B



NORTHWEST BUILDING ELEVATION-CASA MARINA GUEST PARKING LOT (300' +/- FROM CASA MARINA HOTEL)

PHOTO SIMULATION-CASA MARINA-1500 REYNOLDS STREET, KEY WEST, FLORIDA

APPLICANT/OWNER:



777 YAMATO ROAD, SUITE 600 BOCA RATON, FLORIDA 33431

PROJECT NAME AND LOCATION:

CASA MARINA VERIZON SITE #62335 1500 REYNOLDS STREET KEY WEST, FL 33040

PROJECT ENGINEER



ENGINEERING AND EQUIPMENT LLC 820 W. INDIANTOWN ROAD, SUITE 105 JUPITER, FLORIDA 33458 PHONE: 561-252-1220 FLORIDA CA#29673

ENGINEER SEAL

RUSSELL C. MORRISON, P.E. FLORIDA P.E. #51567

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APPROVING AGENCY CITY OF KEY WEST, FLORIDA

BUILDING CODE

2010 FLORIDA BUILDING CODE

SHEET TITLE

PHOTO SIMULATION EXHIBIT

SHEET NUMBER

A-2C



PHOTO SIMULATION-CASA MARINA-1500 REYNOLDS STREET, KEY WEST, FLORIDA

APPLICANT/OWNER:



777 YAMATO ROAD, SUITE 600 BOCA RATON, FLORIDA 33431

PROJECT NAME AND LOCATION:

CASA MARINA VERIZON SITE #62335 1500 REYNOLDS STREET KEY WEST, FL 33040

PROJECT ENGINEER



ENGINEERING AND EQUIPMENT LLC 820 W. INDIANTOWN ROAD, SUITE 105 JUPITER, FLORIDA 33458 PHONE: 561-252-1220 FLORIDA CA#29673

ENGINEER SEAL

RUSSELL C. MORRISON, P.E. FLORIDA P.E. #51567

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APPROVING AGENCY

CITY OF KEY WEST, FLORIDA

BUILDING CODE

2010 FLORIDA BUILDING CODE

SHEET TITLE PHOTO SIMULATION EXHIBIT

SHEET NUMBER

A-2D



PHOTO SIMULATION-CASA MARINA-1500 REYNOLDS STREET, KEY WEST, FLORIDA

APPLICANT/OWNER:



777 YAMATO ROAD, SUITE 600 BOCA RATON, FLORIDA 33431

PROJECT NAME AND LOCATION:

CASA MARINA VERIZON SITE #62335 1500 REYNOLDS STREET KEY WEST, FL 33040

PROJECT ENGINEER



WAYPOINT

ENGINEERING AND EQUIPMENT LLC 820 W. INDIANTOWN ROAD, SUITE 105 JUPITER, FLORIDA 33458 PHONE: 561-252-1220 FLORIDA CA#29673

ENGINEER SEAL

RUSSELL C. MORRISON, P.E. FLORIDA P.E. #51567

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APPROVING AGENCY

CITY OF KEY WEST, FLORIDA


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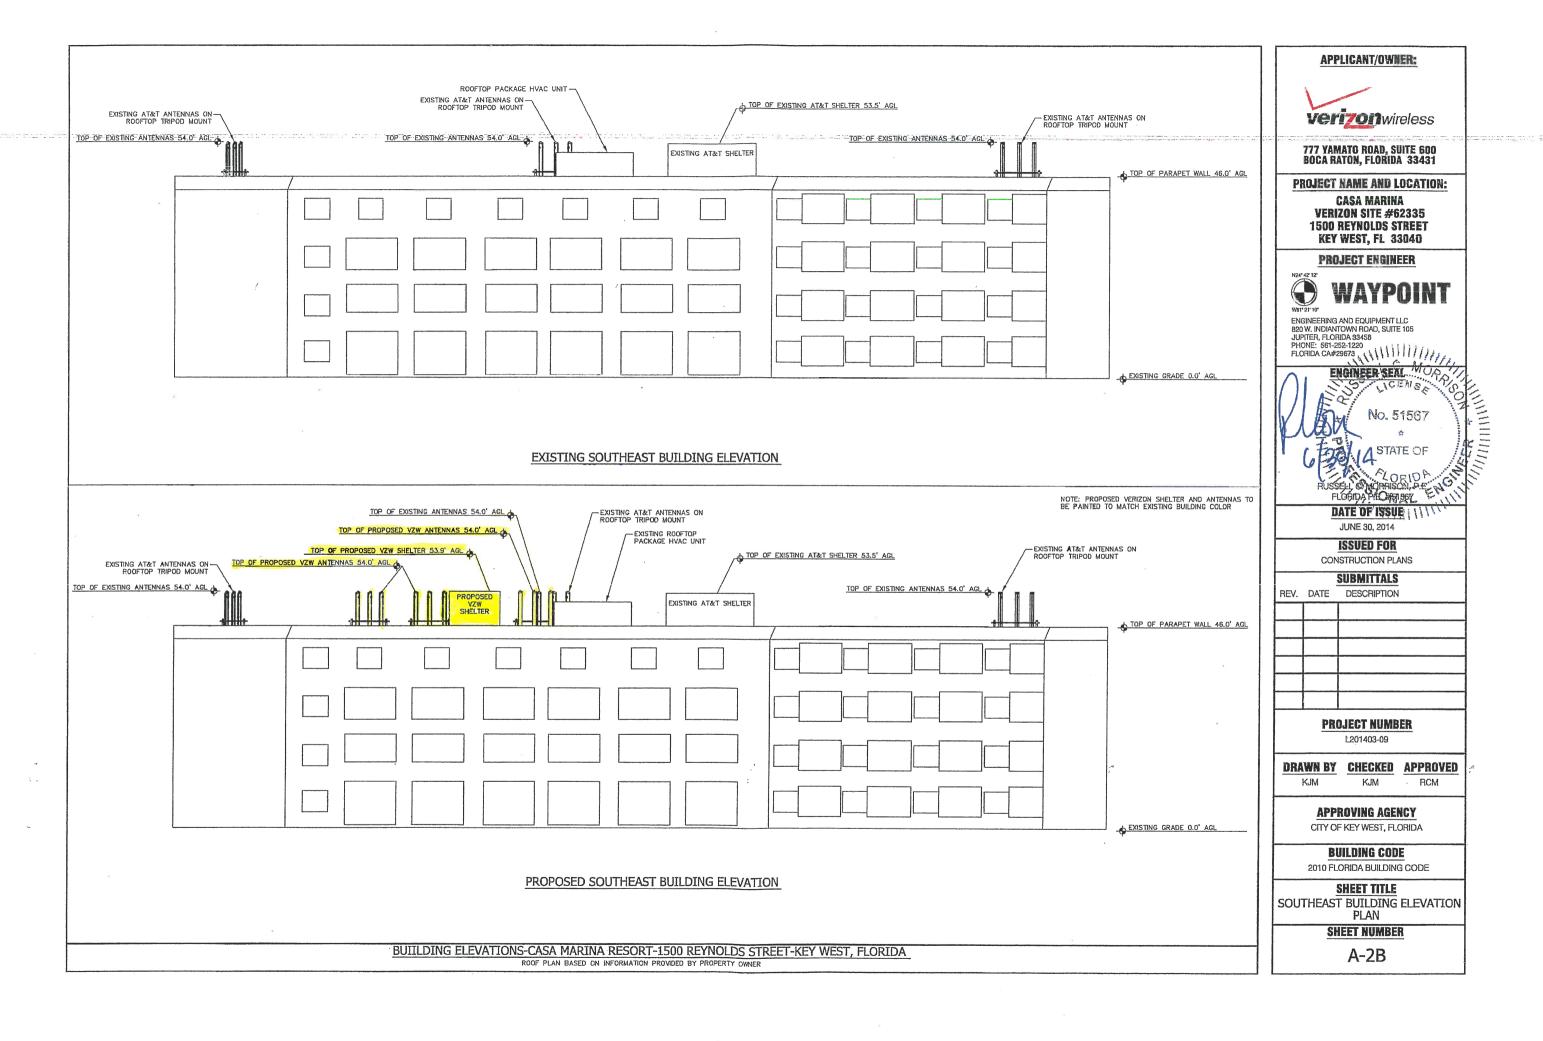
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PHOTO SIMULATION

EXHIBIT
SHEET NUMBER

A-2E





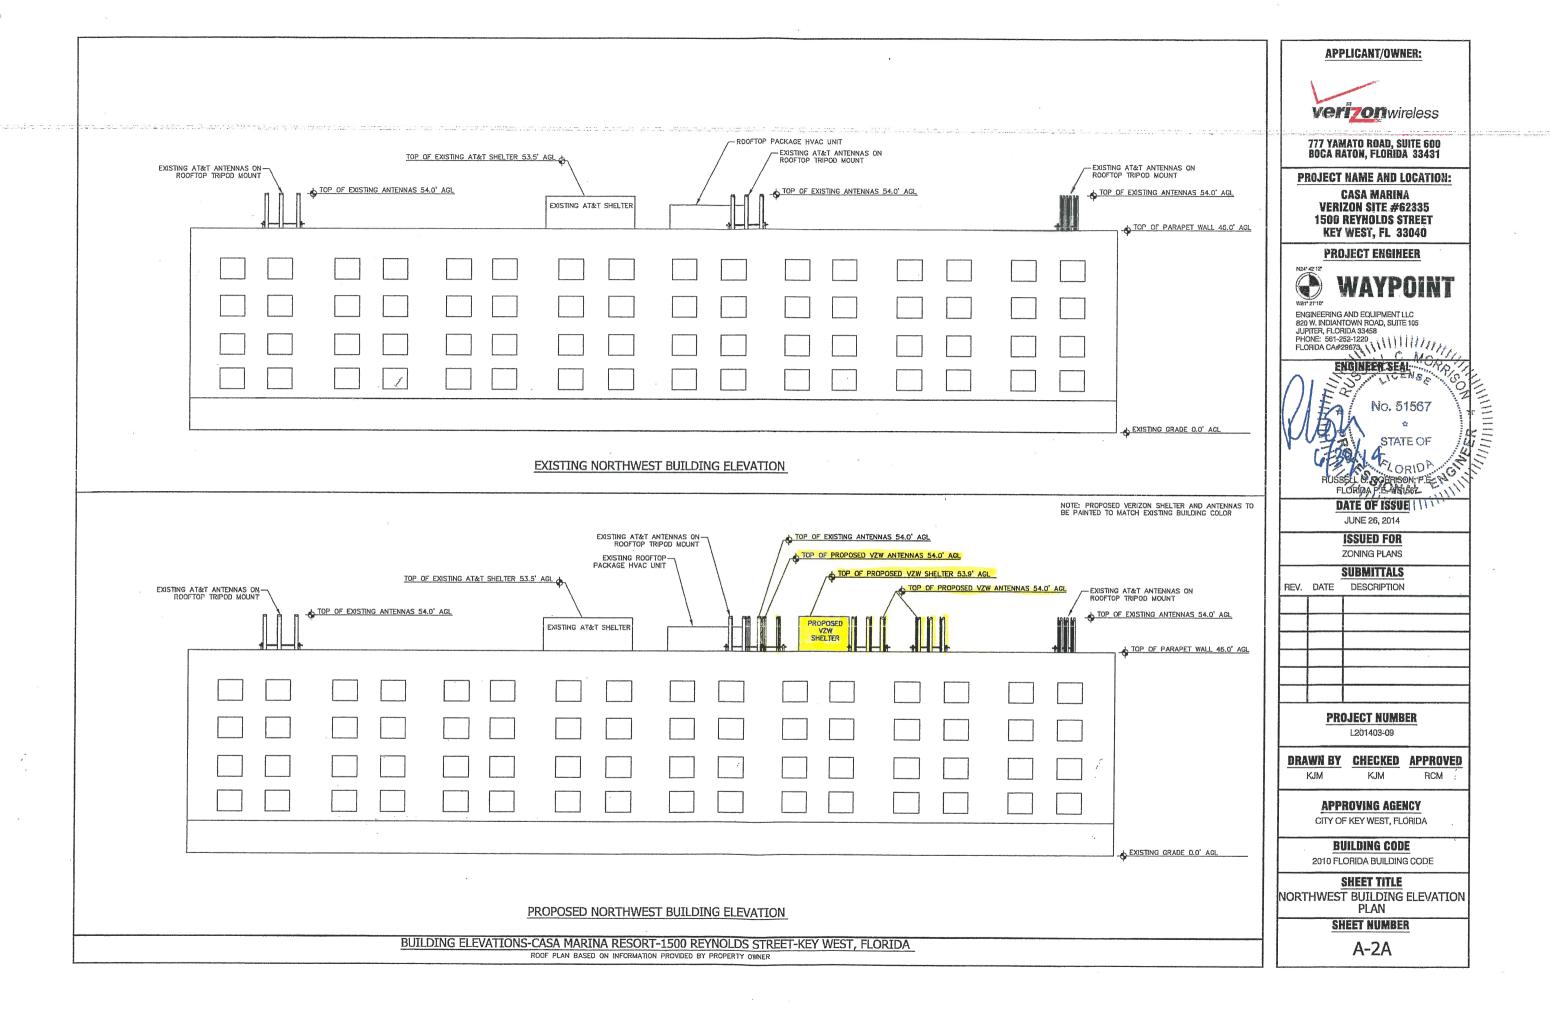

715 SEMINOLE AVENUE




761 SEMINOLE AVENUE



837 SEMINOLE AVENUE





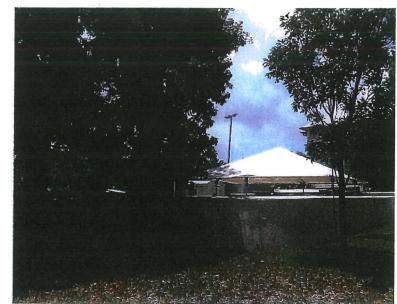

1500 ALBERTA STREET 1579 WILLIAM STREET

APPLICANT/OWNER:



777 YAMATO ROAD, SUITE 600 BOCA RATON, FLORIDA 33431

PROJECT NAME AND LOCATION:

CASA MARINA VERIZON SITE #62335 1500 REYNOLDS STREET KEY WEST, FL 33040

PROJECT ENGINEER



WAYPOINT

WEYE'I'O'
ENGINEERING AND EQUIPMENT LLC
820 W. INDIANTOWN ROAD, SUITE 105
JUPITER, FLORIDA 33458
PHONE: 561-252-1220
FLORIDA CA#29678

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ENGINEER SEAL

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APPROVING AGENCY CITY OF KEY WEST, FLORIDA


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2010 FLORIDA BUILDING CODE SHEET TITLE

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SHEET NUMBER

A-2C



APPLICANT/OWNER:

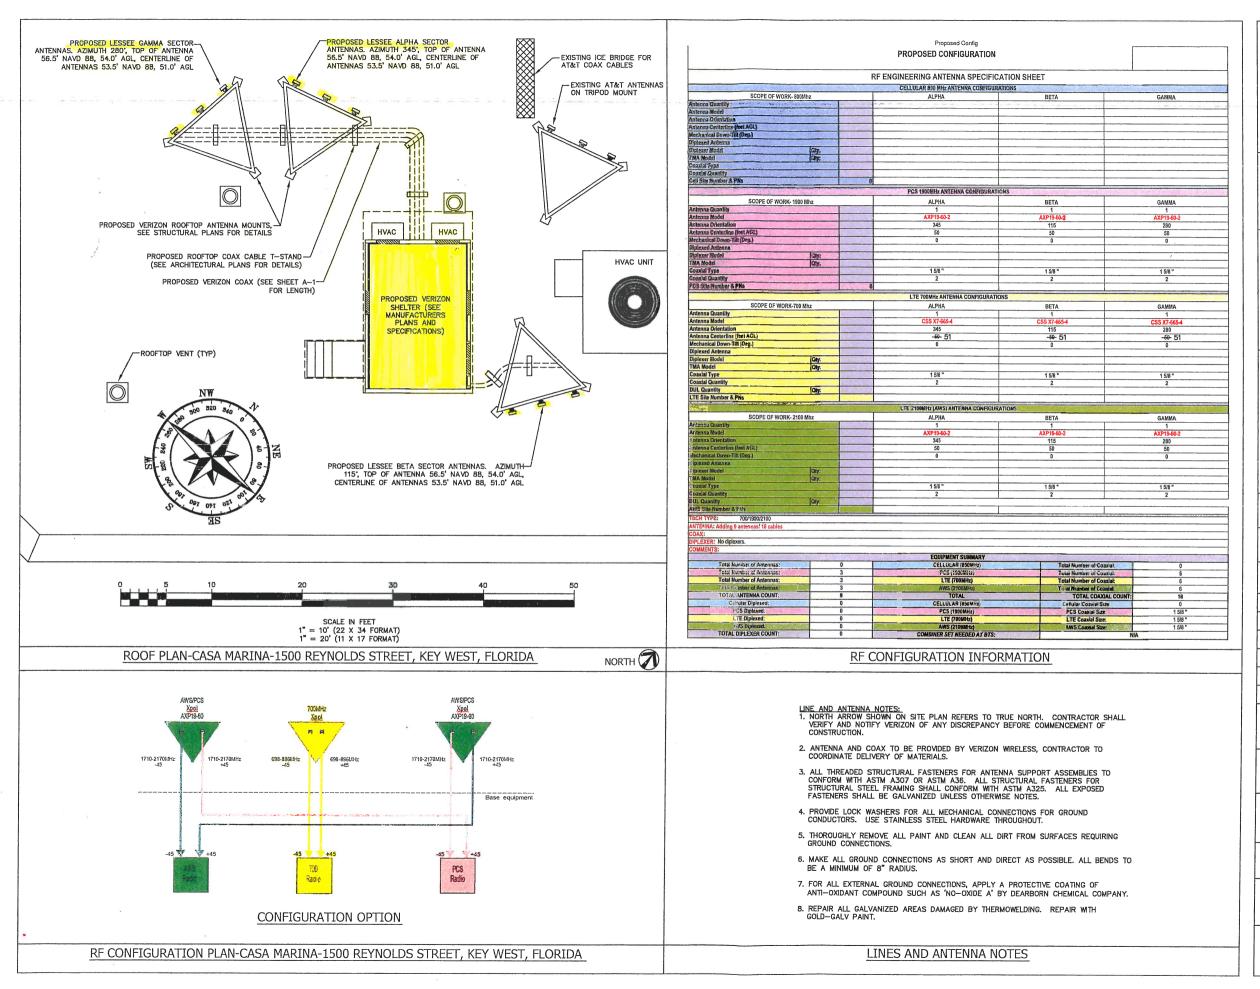

777 YAMATO ROAD, SUITE 600 BOCA RATON, FLORIDA 33431

PROJECT NAME AND LOCATION: **CASA MARINA VERIZON SITE #62335 1500 REYNOLDS STREET** KEY WEST, FL 33040

PROJECT ENGINEER



ENGINEERING AND FOLIPMENT LLC 820 W. INDIANTOWN ROAD, SUITE 105 JUPITER, FLORIDA 33458

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APPROVING AGENCY

CITY OF KEY WEST, FLORIDA

BUILDING CODE


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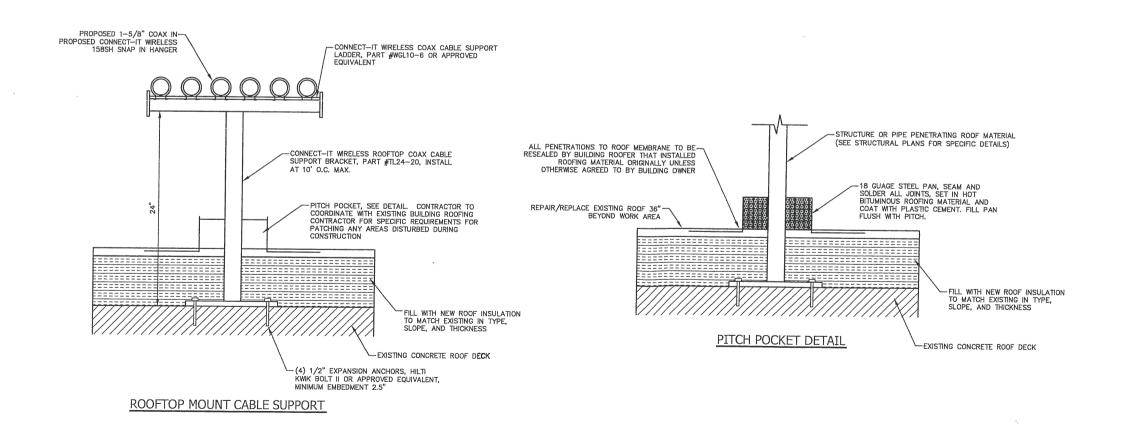
RF PLAN ANTENNAS AND LINES

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A-3



COAX CABLE MOUNT TO PARAPET WALL

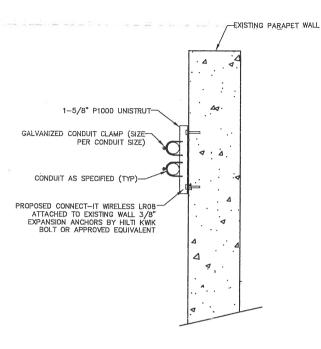


APPLICANT/OWNER: **Veri**70nwireless 777 YAMATO ROAD, SUITE 600 BOCA RATON, FLORIDA 33431 PROJECT NAME AND LOCATION: **CASA MARINA VERIZON SITE #62335 1500 REYNOLDS STREET** KEY WEST, FL 33040 **PROJECT ENGINEER** W81° 21' 10' FNGINFERING AND EQUIPMENT LLC CENGINEER SEAL No. 51567 TORIDA PE MAISON PE PE MAISON NE 5, 2014 **ISSUED FOR** CONSTRUCTION PLANS SUBMITTALS REV. DATE DESCRIPTION PROJECT NUMBER L201403-09 DRAWN BY CHECKED APPROVED KJM KJM RCM **APPROVING AGENCY** CITY OF KEY WEST, FLORIDA **BUILDING CODE** 2010 FLORIDA BUILDING CODE SHEET TITLE CONSTRUCTION DETAILS

SHEET NUMBER

A-4

CONSTRUCTION DETAILS-CASA MARINA-1500 REYNOLDS STREET, KEY WEST, FLORIDA

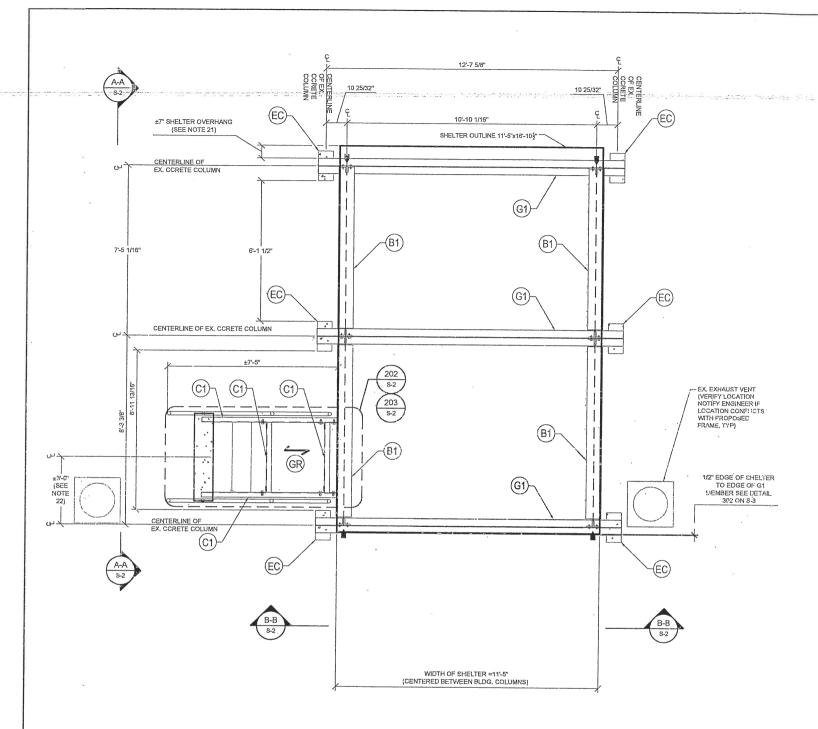

MCNICHOLS GW(19W4) 1" x 3" GAI VANIZED FINISH (GR) GRATING (INSTALL PER MANUFACTURER'S SPECIFICATIONS)

DIRECTION OF GRATING

EX. CONCRETE COLUMN, 7 \$"X 15 \arrows WI 4#5 VERTICLE REINFORCEMENT & #2 @72" O/C TIES (EC)

(G1) GIRDER, W10X33

(C1) CHANNEL C10x15.3

(B1) .BEAM, W10X33

(P1) 5.0X PIPE

(P2) 3.0X PIPE

ANTENNA (SEE CIVIL PLANS FOR DETAILS)

SHELTER PERIMETER BEAM W16x31 (INCLUDED W/ SHELTERY

(HR) HAND RAIL (SEE DETAIL 307 ON S-3) INSTALL STIFFENER (SEE DETAIL 203 ON S-2) UNDERLYING STRUCTURAL SUPPORT FOR SHELTER - PLAN VIEW

NOTES:

DESIGN: CONTRACTOR SHALL MEET THE REQUIREMENTS OF THE 2010 FLORIDA BUILDING CODE AND ANY OTHER LOCAL OR REGIONAL GOVERNING CODES DURING CONSTRUCTION.

2. WIND LOAD CRITERIA (ASCE 7-10):

STRUCTURAL FRAME:

BASIC WIND SPEED = 185 MPH (3-SECOND GUST) -STRUCTURAL CATEGORY = II

WIND EXPOSURE=D MWFRS ENCLOSED BUILDING

MATERIAL - ALL STEEL MEMBERS SHALL CONFORM WITH THE FOLLOWING SPECIFICATIONS: PIPE SHAPES SHALL CONFORM TO ASTM AS3 GRADE B (Fy = 35 ks!; Fu = 60 ks!) HSS SHAPES SHALL CONFORM TO ASTM A500 GRADE B (Fy = 46 ks!; Fu = 58 ks!) W SHAPES SHALL CONFORM WITH ASTM A992 (Fy=50ksl;Fu=65ks!) CHANNELS AND ANGLES SHALL CONFORM WITH ASTM A36 (Fy=36ksi,Fu=58ksi)
PLATES SHALL CONFORM WITH ASTM A36 (FY=36ksi,Fu=58ksi)

CONNECTIONS

DESIGN, FABRICATION, AND CONSTRUCTION SHALL CONFORM TO AISC MANUAL OF STEEL CONSTRUCTION, 14TH EDITION.

SHALL BE DONE BY AN AWS CERTIFIED WELDER AND IN COMPLIANCE WITH AWS D1.1. ALL WELDS SIZES SHALL BE THE MAXIMUM ALLOWED BY THE MATERIAL BEING WELDED WITH E70XX ELECTRODE

GALVANIZED HSS ASSEMBLIES SHOULD NOT BE COMPLETELY SEALED BECAUSE RAPID PRESSURE CHANGES DURING THE GALVANIZING PROCESS TEND TO BURST SEALED ASSEMBLIES.

SHELTER:

THIS DESIGN IS BASED AN EMAIL PROVIDED BY JOHN IRVING AT CELLXION A LIGHTWEIGHT 11'-5" x 16-10 3" x 11'-5" (LXWXH

OVERALL) IS PROPOSED TO BE INSTALLED ON TOP OF THE SUBFRAME AS DETAILED IN THESE PLANS. THE SHELTER HAS A DEAD

WEIGHT OF 22,000 LBS (SHELTER WEIGHT ONLY). THE SHELTER FLOOR HAS A W16x31 PERIMETER BEAM THAT IS PROPOSED TO

BE DIRECTLY WELDED TO THE SUBFRAME. THE LIGHTWEIGHT SHELTER SHOP DRAWINGS MUST BE PROVIDED TO JWME PRIOR TO CONSTRUCTION SO THAT JWME MAY BE ABLE TO MODIFY ANY PARTS OF THE DESIGN THAT MAY CONFLICT WITH THESE

- ALL COMPONENTS SHALL BE PROTECTED FROM WEATHER EFFECTS, USE HOT DIP GALVANIZED MATERIAL OR PAINT AS APPROPRIATE, TOUCH UP ALL FIELD WELDS AND ABRADED AREAS WITH TWO COATS OF ACCEPTABLE PAINT, REPAIR OF ABRADED OR UNCOATED AREAS SHALL CONFORM TO ASTM A780-93A.
- 6. CONTRACTOR MAY PAINT GALVANIZED HSS MEMBERS IF REQUESTED BY THE CLIENT. CONTRACTOR SHALL COORDINATE WITH PROJECT MANAGER FOR COLOR SELECTION.
- 9. CONTRACTOR / STEEL FABRICATOR SHALL CAP OR SEAL ALL PIPES AS REQUIRED TO PREVENT RAINWATER INTRUSION.
- 10. CONTRACTOR / STEEL FABRICATOR SHALL SUBMIT SHOP DRAWINGS FOR REVIEW PRIOR TO ANY STEEL FABRICATION. AT THE CONTRACTOR'S OPTION, FIELD SPLICES MAY BE USED FOR ERECTION PURPOSES. IF FIELD SPLICES ARE USED, THE SHOP DRAWINGS SHALL INCLUDE ALL DETAILS FOR THE PROPOSED FIELD SPLICES AND SHALL BE APPROVED BY THE ENGINEER PRIOR TO DETAIL STOLL.
- AT THE CONTRACTORS OPTION, SHOP WELDS MAY BE USED INSTEAD OF FIELD WELDS
- 12. SUBMIT ORIGINAL SHOP DRAWINGS, INCLUDING COMPLETE DETAILS, SCHEDULES OF FABRICATION AND ASSEMBLY.
 PROCEDURES, AND DIAGRAMS, INCLUDE DETAILS OF CUTS, CONNECTIONS, CAMBER, HOLE, AND OTHER PERTINENT DATA.
 INDICATE WELDS BY STANDARD AWS A2.1 AND A2.4 SYMBOLS, AND SHOW SIZE, LENGTH, AND TYPE OF WELD, PROVIDE SETTING
 LRAWINGS, TEMPLATES, AND DIRECTIONS FOR INSTALLATION OF ANCHOR BOLTS AND OTHER ANCHORAGES TO BE INSTALLED.
- 12. CONTRACTOR SHALL BE RESPONSIBLE FOR RESTORING ANY AREAS OF THE SITE AT THE CONTRACTOR'S EXPENSE THAT ARE DISTURBED AS A RESULT OF THE WORK ASSOCIATED WITH THE INSTALLATION OF THE PROPOSED IMPROVEMENTS
- 14. THE CONTRACTOR SHALL VERIFY PROPOSED STRUCTURAL LOCATIONS AND POTENTIAL CONFLICTS BEFORE BEGINNING CONSTRUCTION AND NOTIFY THE ENGINEER. DESIGN MODIFICATIONS MAY BE NECESSARY AS A RESULT.
- 15. CONTRACTOR SHALL VERIFY ALL DIMENSION PRIOR TO CONSTRUCTION AND NOTIFY THE ENGINEER OF ANY DISCREPANCIES BETWEEN THE CONSTRUCTION DRAWING SET AND EXISTING FIELD CONDITIONS.
- 16. JWME WAS NOT PROVIDED AN EXISTING DRAINAGE PLAN FOR THIS ROOF AND THEREFORE THE EXISTING DRAINAGE PATTERN IS UNKNOWN. THE CONTRACTOR MUST PROVIDE PROPER SLOPING AT AND AROUND SHELTER SO THAT THE EXISTING DRAINAGE PATTERN ON THE ROOF IS MAINTAINED. THIS MAY REQUIRE SOME MODIFICATION TO THE EXISTING ROOF, THE CONTRACTOR SHALL EVALUATE THE SITE PRIOR TO CONSTRUCTION AND NOTIFY JWME OF ANY POTENTIAL PROBLEMS. JWME WILL WORK WITH THE CONTRACTOR TO DEVELOP A PROPER DRAINAGE PLAN AS NECESSARY
- 17. THIS DESIGN IS BASED ON INFORMATION PROVIDED TO JWME BY WAYPOINT ENGINEERING INCLUDING: RECORD DRAWINGS BY PETER L. GLUCK ARCHITECT 80 FIFTH AVE. NEW YORK, NY 10011 & GEIGER BERGER ASSOCIATES, P.C. (STRUCTURAL ENGINEERS) 500 FIFTH AVE. NEW YORK, NY 10036 DATED 1978 PHOTOGRAPHS OF THE RECORD BUILDING DRAWINGS FROM SITE VISIT PERFORMED BY RUSSELL MORRISON OF WAYPOINT ENGINEERING, LLC ON 03/11/14 -LIGHT WEIGHT SHELTER DESIGNED BY CELLIXON (JOHN IRVING, PE). INFORMATION ON THE OVERALL DIMENSIONS AND WEIGHT OF THIS SHELTER WERE PROVIDED IN AN EMAIL FROM MR. IRVING.
- 18. CONTRACTOR MUST COORDINATE ALL SITE IMPROVEMENTS WITH THE BUILDING OWNER AND CLIENT PROJECT MANAGER.
- 19. CONTRACTOR MUST VERIFY THE PROPOSED BASE PLATES ARE LOCATED DIRECTLY ABOVE THE UNDERLYING BUILDING'S CONCRETE COLUMNS AND THAT THE CONCRETE SLAB THICKNESS IS AS INDICATED. CONTRACTOR SHALL ALSO VERIFY THAT NO EXISTING REINFORCING STEEL IN THE UNDERLYING CONCRETE DECK AND COLUMN ARE COMPROMISED WITH THE PROPOSED IMPROVEMENTS. REPORT TO ENGINEER IF DIFFERENT.
- 20. FROM THE SITE PHOTOGRAPH IT IS UNDERSTOOD THERE ARE SOME EXHAUST VENTS NEAR THE PROPOSED SITE AREA. JWME WAS NOT PROVIDED AN AS-BUILT SURVEY OF THIS ROOF TOP AND ALL EQUIPMENT IS GENERALLY LOCATED. THE CONTRACTOR MUST VERIFY THAT THE EXISTING EXHAUST VENT IS NOT IN CONFLICT WITH THE PROPOSED SITE LAYOUT AND THAT ALL CLEARANCES ARE MAINTAINED ACCORDING TO THE FEG. THE CONTRACTOR MUST CONTACT THE ENGINEER IF THERE IS A PERCEIVED CONFLICT PRIOR TO CONSTRUCTION.
- 21. THE SHELTER'S PERIMETER BEAM IS NOT LOCATED ON TOP OF THE UNDERLYING GIRDER DUE TO THE SHELTER LENGTH.
- 22. STAIRWELL MUST BE CENTERED ON SHELTER DOOR AND PROVIDE PROPER INGRESS AND EGRESS ACCESS TO SHELTER. NOTIFY ENGINEER IF SHELTER DRAWINGS CONFLICT WITH PROPOSED STAIRWELL. MODIFICATIONS MAY BE NECESSARY.

APPLICANT/OWNER:



14055 RIVEREDGE DRIVE, SUITE 600 TAMPA, FLORIDA 33637

PROJECT NAME AND LOCATION:

CASA MARINA VERIZON SITE #62335 1500 REYNOLDS STREET KEY WEST. FL 33040

PROJECT ENGINEER



ENGINEERING AND EQUIPMENT LLC R20 W. INDIANTOWN ROAD, SUITE 105
JUPITER, FLORIDA 36491
PHONE: 561-254 PM
FLORIDA CAPESTY NAYNE

NO. 25349

STATE OF

STATE OF 820 W. INDIANTOWN ROAD, SUITE 105

DATE OF ISSUE

JUNE 5, 2014

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SMR

RCM

APPROVING AGENCY

CITY OF KEY WEST, FLORIDA


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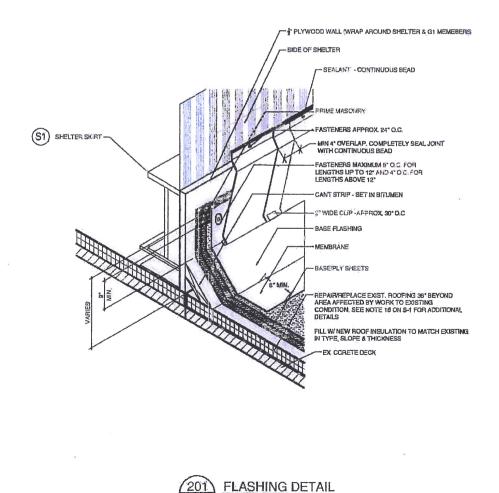
2010 FLORIDA BUILDING CODE

SHEET TITLE


STRUCTURAL PLAN AND SECTION


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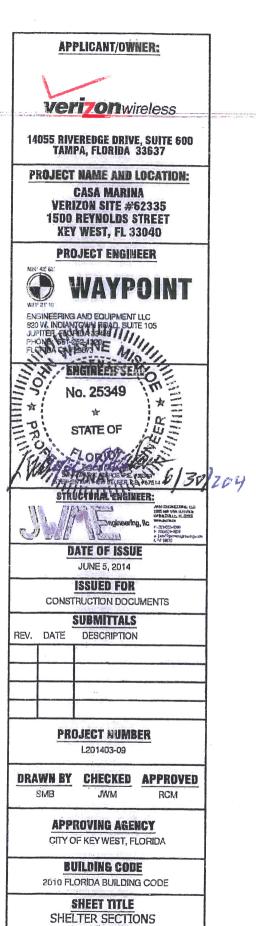


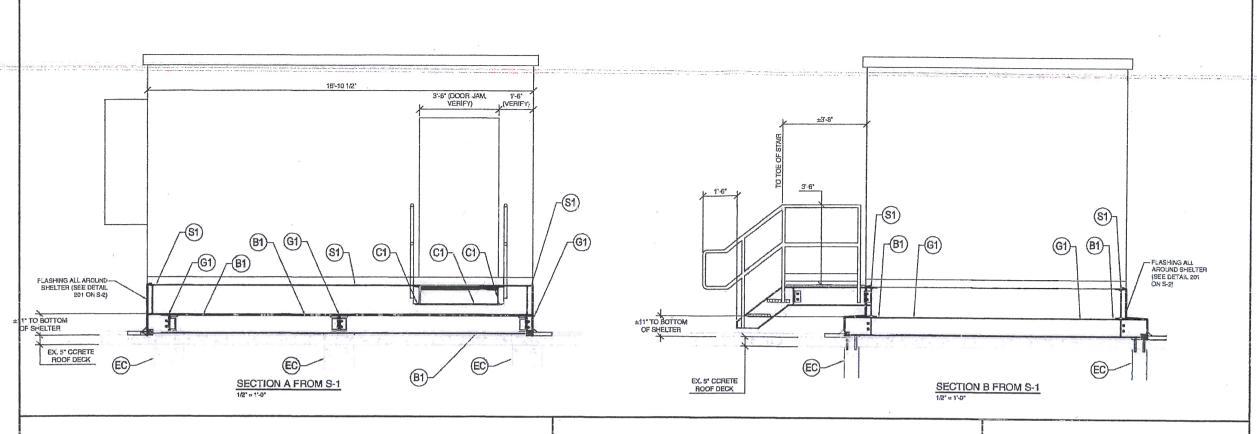

SCALE: NTS



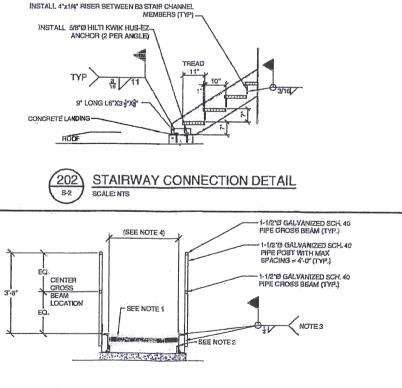


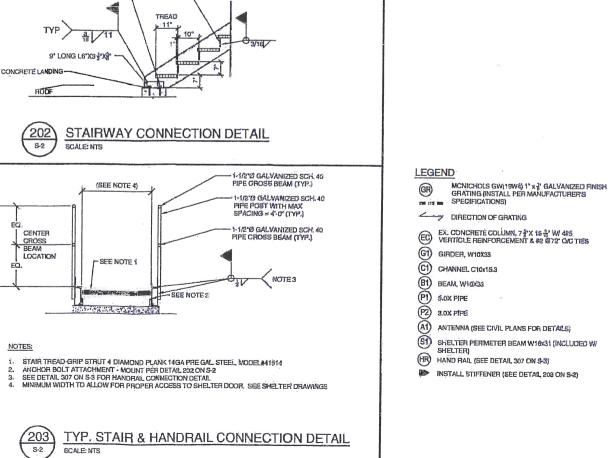

AND DETAILS SHEET MUMBER

CANCIDATE DAMES

F SET CAZ SENCEA THE BACK TAKEN

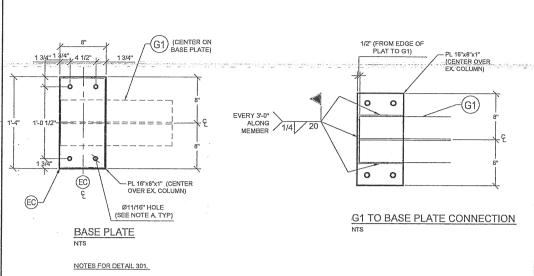



- A. INSTALL 5/8 HILTI HAS B7 CARBON STEEL THREADED ROD WITH HILTI HIT-HY
- 200 SAFE SET SYSTEM EPOXY WITH MINIMUM EMBEDMENT DEPTH OF 4"
 B. CENTER BASE PLATE OVER EXISTING COLUMN (TYP)



BASE PLATE CONNECTION DETAIL


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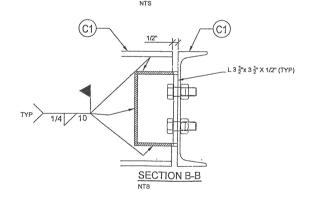


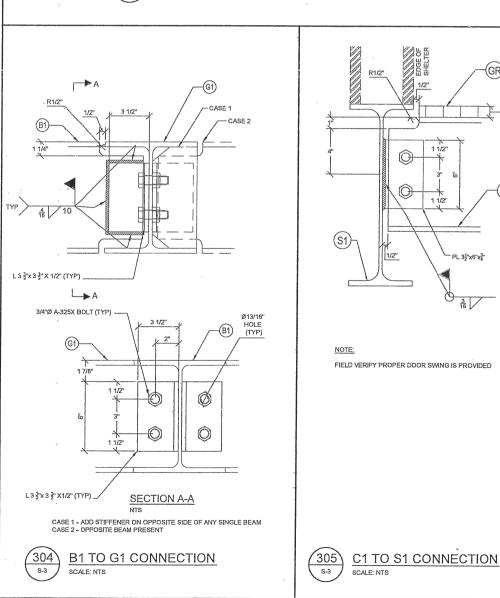


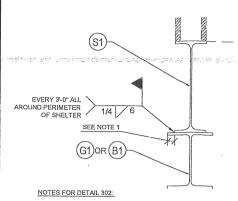A. ALIGN B1 SO THAT 3" GAP IS AVAILABLE FOR WELDING.


SHELTER CONNECTION DETAIL SCALE: NTS



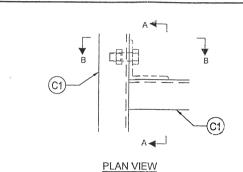

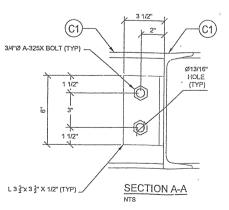




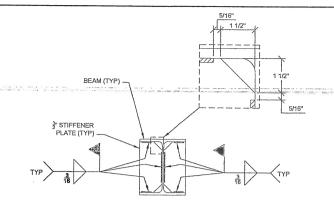



STIFFENER PLATE DETAIL

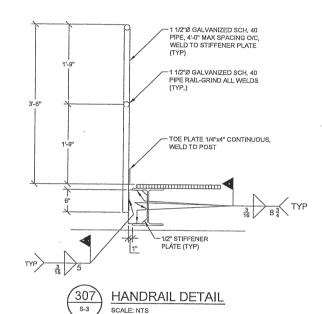


LEGEND

GR MCNICHOLS GW(19W4) 1" x 3" GALVANIZED FINISH GRATING (INSTALL PER MANUFACTURER'S SPECIFICATIONS)

DIRECTION OF GRATING

- EX. CONCRETE COLUMN, 7 %"X 15 %" WI 4#5
 VERTICLE REINFORCEMENT & #2 @72" O/C TIES
- (G1) GIRDER, W10X33
- C1) CHANNEL C10x15.3
- (B1) BEAM, W10X33
- 5.0X PIPE
- (P2) 3.0X PIPE
- ANTENNA (SEE CIVIL PLANS FOR DETAILS)
- (S1) SHELTER PERIMETER BEAM W16x31 (INCLUDED W/
- HR HAND RAIL (SEE DETAIL 307 ON S-3)
- INSTALL STIFFENER (SEE DETAIL 203 ON S-2)

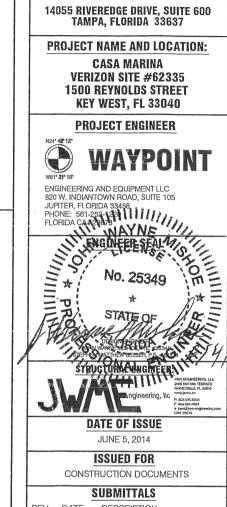

DATE OF ISSUE

JUNE 5, 2014

APPLICANT/OWNER:

Verizonwireless

CASA MARINA

ISSUED FOR CONSTRUCTION DOCUMENTS

SUBMITTALS REV. DATE DESCRIPTION

PROJECT NUMBER

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> **APPROVING AGENCY** CITY OF KEY WEST, FLORIDA

BUILDING CODE


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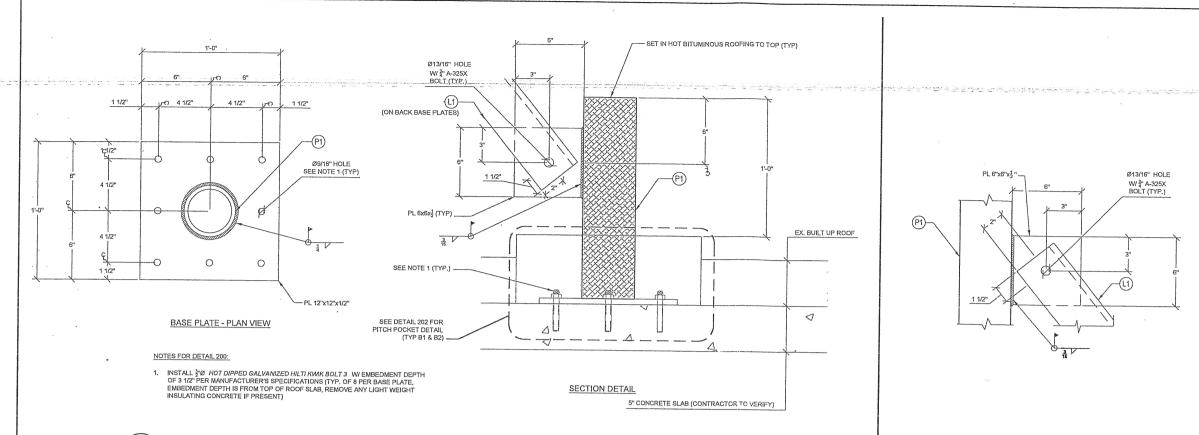
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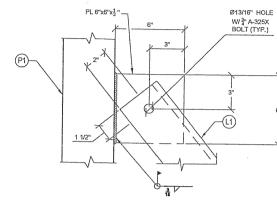
STRUCTURAL DETAILS

SHEET NUMBER

BAR IS ONE INCH ON ORIGINAL DRAWING






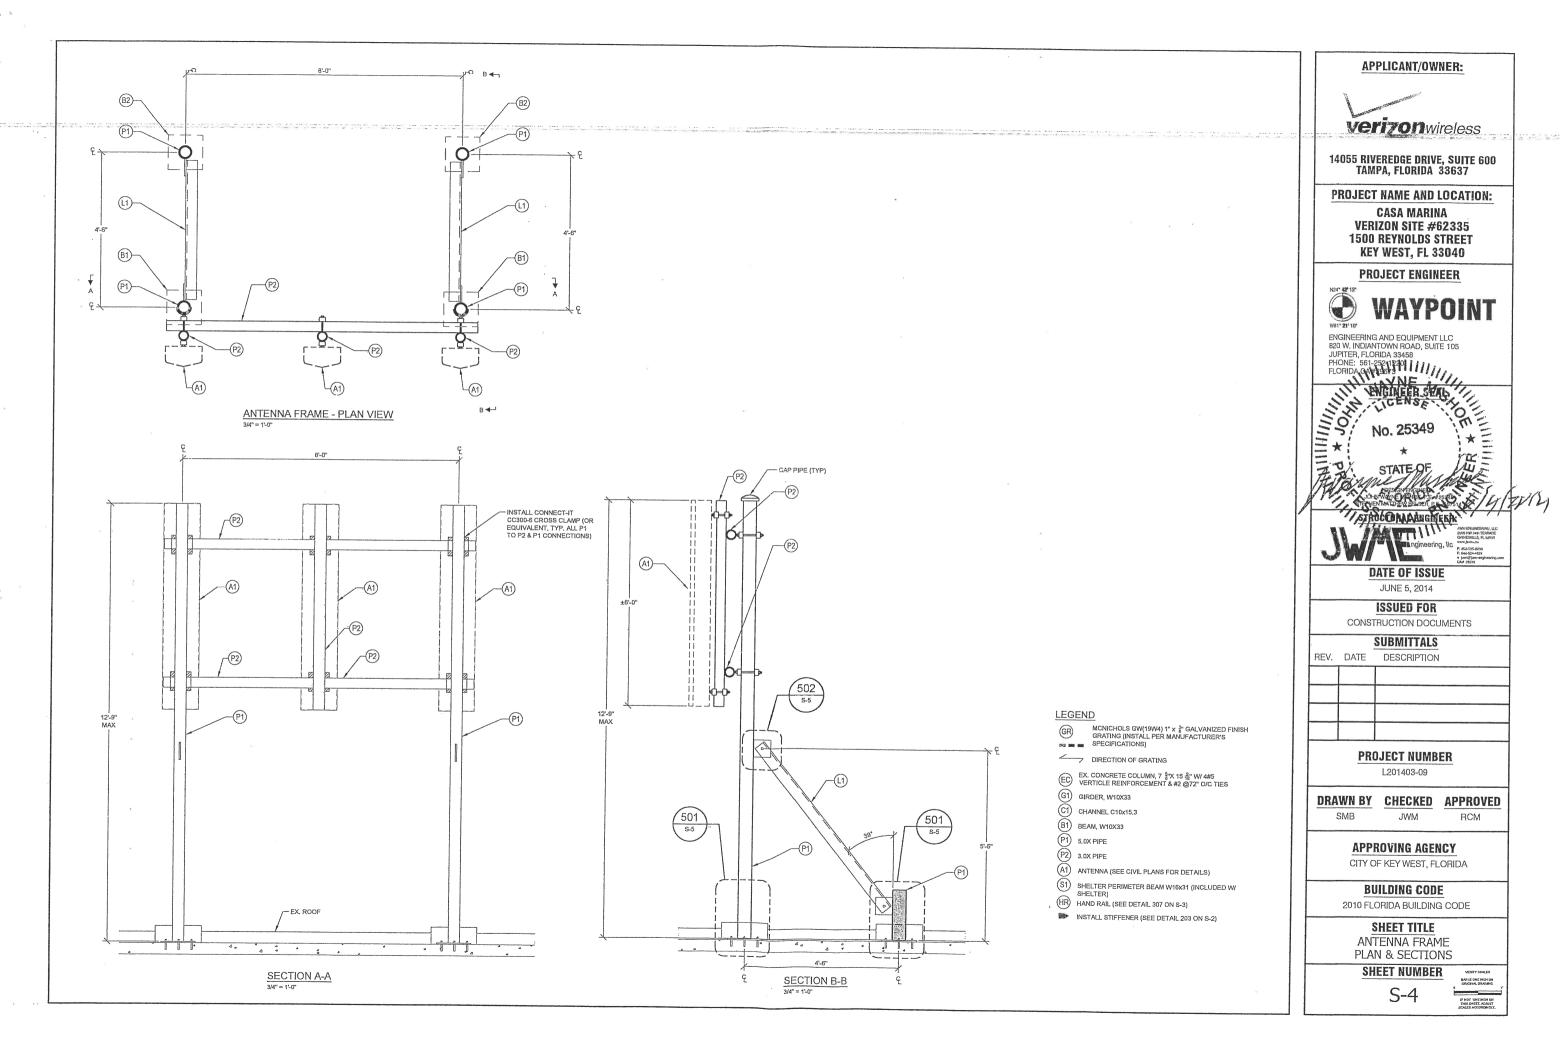

502 s-s

PLATE TO COLUMN WELD DETAIL

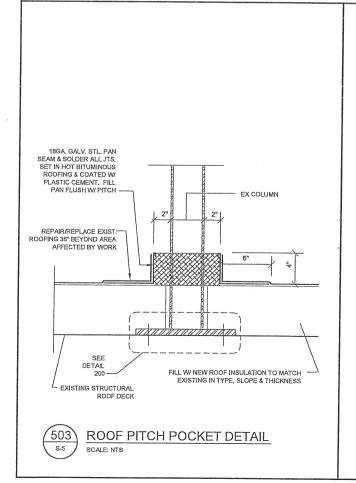

S-5

SCALE: NTS

BASEPLATE MODIFICATION DETAIL

GR MCNICHOLS GW(19W4) 1" x 2" GALVANIZED FINISH GRATING (INSTALL PER MANUFACTURER'S SPECIFICATIONS)

DIRECTION OF GRATING

- EX. CONCRETE COLUMN, 7 \$"X 15 %" WI 4#5
 VERTICLE REINFORCEMENT & #2 @72" O/C TIES
- G1) GIRDER, W10X33
- C1) CHANNEL C10x15,3
- (B1) BEAM, W10X33
- P1) 5.0X PIPE
- (P2) 3.0X PIPE
- ANTENNA (SEE CIVIL PLANS FOR DETAILS)
- S1) SHELTER PERIMETER BEAM W16x31 (INCLUDED W/
- HR HAND RAIL (SEE DETAIL 307 ON S-3)
- INSTALL STIFFENER (SEE DETAIL 203 ON S-2)

APPLICANT/OWNER:



14055 RIVEREDGE DRIVE, SUITE 600 TAMPA, FLORIDA 33637


PROJECT NAME AND LOCATION:

CASA MARINA **VERIZON SITE #62335 1500 REYNOLDS STREET** KEY WEST, FL 33040

PROJECT ENGINEER



ENGINEERING AND EQUIPMENT LLC 820 W. INDIANTOWN ROAD, SUITE 105 JUPITER, FLORIDA 33458 FLORIDA CA#29673

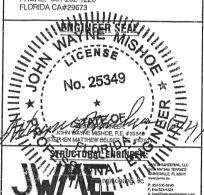

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DRAWN BY CHECKED APPROVED JWM RCM

APPROVING AGENCY CITY OF KEY WEST, FLORIDA

BUILDING CODE 2010 FLORIDA BUILDING CODE

SHEET TITLE

ANTENNA DETAILS SHEET NUMBER

ELECTRICAL SYSTEM NOTES

1 GENERAL

- A. THE CONTRACTOR SHALL PROVIDE ALL MATERIAL AND LABOR FOR A COMPLETE ELECTRICAL SYSTEM AS INDICATED ON THE DRAWINGS. ITEMS NOT SHOWN BUT OBVIOUSLY NECESSARY FOR A COMPLETE SYSTEM SHALL BE INCLUDED.
- B. THE CONTRACTOR SHALL OBTAIN ALL NECESSARY PERMITS, INSPECTIONS AND APPROVALS.
- C. ALL WORK SHALL CONFORM TO THE NATIONAL ELECTRICAL CODE AND THE LOCAL BUILDING CODES. ALL COMPONENTS SHALL BE U.L. APPROVED.
- D. THE CONTRACTOR SHALL BEFORE SUBMITTING HIS BID, WSIT THE SITE OF THE PROJECT AND BECOME FAMILIAR WITH THE CONDITIONS. NO ALLOWANCE WILL BE MADE FOR EXISTING CONDITIONS OR FAILURE OF THE CONTRACTOR TO OBSERVE
- E. EXACT LOCATION OF ALL EQUIPMENT SHALL BE COORDINATED WITH WIRELESS CARRIER, THE BUILDING OWNER AND OTHER TRADES.
- F. WHERE EQUIPMENT IS SPECIFIED BY MANUFACTURER AND TYPE, SUBSTITUTION SHALL ONLY BE MADE WITH THE APPROVAL OF THE ENGINEER. THE CONTRACTOR SHALL SUBMIT DETAILS OF PROPOSED MATERIALS, REASON FOR CHANGE AND

- A THE CONTRACTOR SHALL PROVIDE ALL ELECTRICAL WIRING AND EQUIPMENT UNLESS OTHERWISE INDICATED. MAIN COMPONENTS ARE AS FOLLOWS:
- 1. PROVIDE ELECTRICAL SERVICE AS INDICATED ON THE DRAWINGS.
- 2. PROVIDE SERVICE EQUIPMENT MOUNTED AS DIRECTED BY CARRIER AND

- 3. PROVIDE TELEPHONE CONDUIT WITH PULL WIRE AND CABLE AS INDICATED ON DRAWINGS.
- COORDINATE ELECTRICAL SERVICE WITH POWER CO. CONTACT REPRESENTATIVE & OBTAIN FAULT CURRENT LETTER PRIOR TO CONSTRUCTION. CONTRACTOR SHALL MAKE ADJUSTMENTS TO CIRCUIT BREAKERS TO MEET FAULT CURRENT WHEN NOT USING CURRENT LIMITING FUSES.
- 5. COORDINATE TELEPHONE SERVICE WITH THE TELEPHONE CO. CONTACT REPRESENTATIVE PRIOR TO CONSTRUCTION.
- 6. INSTALL WIRE AND CONDUIT AS INDICATED, PROVIDE CABLE SUPPORTS AS INDICATED.
- 7. PROVIDE GROUNDING AND LIGHTNING PROTECTION SYSTEM AS INDICATED.
- 8. RESTORE ALL AREAS TO ORIGINAL CONDITION AFTER INSTALLATION OF CONDUIT.
- 9. CONTRACTOR SHALL CLEARLY LABEL DISCONNECTS AND OTHER RELATED GEAR. AT TIME OF PLAN PERMITTING, CONTRACTOR SHALL APPLY FOR A THIRTY (30) DAY TEMPORARY POWER PERMIT FOR TESTING PURPOSES.

A CONDUIT SIZES AS SHOWN ON THE DRAWINGS ARE A MINIMUM. THE CONTRACTOR MAY INCREASE AS REQUIRED FOR EASE OF PULLING.

PERPENDICULAR TO STRUCTURAL ELEMENTS. SUPPORTS AND MOUNTING HARDWARE

- B. CONDUIT TYPES SHALL BE AS FOLLOWS UNLESS OTHERWISE INDICATED:
- 1. ALL ABOVE GRADE CONDUIT SHALL BE RIGID GALVANIZED STEEL
- 2. ALL CONDUIT BELOW GRADE SHALL BE SCHEDULE 40 PVC 3. CONCEALED CONDUIT IN WALLS OR ABOVE CEILING SHALL BE EMT.
- C. ALL EXPOSED CONDUIT SHALL BE NEATLY INSTALLED AND PLIN PARALLEL OR

- SHALL BE HOT DIPPED CALVANIZED STEEL. NYLON INSULATED BUSHINGS SHALL BE USED ON ALL CONDUIT TERMINATIONS
- D. FLEX CONDUIT SHALL BE LIQUID TIGHT FLEXIBLE METALLIC CONDUIT.
- E. NO CONDUIT SHALL BE INSTALLED IN LIFE SAFETY AREAS SUCH AS
- F. CONDUIT ROUTES ARE SCHEMATIC, FIELD VERIFY ROUTE REFORE BID. COORDINATE ROUTE WITH WIRELESS CARRIER AND BUILDING
- G. WEATHERPROOF HUBS SHALL BE USED FOR ALL TOP AND SIDE PENETRATIONS TO ENCLOSURE LOCATED OUTDOORS.

- A. CONDUCTORS SHALL BE STRANDED COPPER TYPE THWN WITH 90 DEGREE C RISE INSULATION.
- 5. PULL BOXES AND JUNCTION BOXES
- A. INTERIOR ENCL. SHALL BE NEMA 1. EXTERIOR ENCL. SHALL BE NEMA 3R.

- A. PROVIDE GROUND SYSTEM AS INDICATED ON THE DRAWINGS AND AS REQUIRED BY THE NATIONAL ELECTRIC CODE AND RADIO EQUIPMENT MANUFACTURER.
- B. ALL RACEWAYS REQUIRE GROUNDING CONDUCTORS. BONDING CONDUCTORS THROUGH ALL MACEMATS REQUIRE GROUNDING COMPUCTIONS. BONDING CONDUCTIONS THROUGH THE RACEMAY SYSTEM SHALL BE CONTINUOUS FROM MAIN SWITCH GROUND BUSES TO PANEL GROUND BARS, AND FROM PANEL GROUNDING BARS TO BRANCH CIRCUIT OUTLETS, MOTORS, LIGHTS, ETC. THESE GROUND CONDUCTORS ARE REQUIRED THROUGHOUT THE PROJECT REGARDLESS OF WHETHER CONDUIT RUNS SHOW GROUND CONDUCTORS ON THE DRAWINGS,
- C. COORDINATE WITH ENCLOSURE SUPPLIER TO INSTALL TELCO GROUND BARS BELOW THE TELCO BOARD, CONNECT TO MAIN GROUNDING SYSTEM.

GROUNDING PROTECTION SYSTEM NOTES

- 1. PROVIDE "CABLE ENTRANCE GROUND BAR" (CEGB), 3"H X 6"L X 1/4"D, MOUNT AT TELCO CABINET. COORD, INSTALLATION WITH CPM...

 11. ELECTRICAL CONTRACTOR SHALL TAKE MEGGER READINGS OF GROUND. THE RESULTS SHALL NOT BE GREATER THAN 5 OHMS.
- RING SHALL BE INSTALLED A MINIMUM OF 2'-0" AWAY FROM THE FOUNDATION UNLESS SHOWN ON DRAWING.
- UNILESS STOWN UN DIRWING.

 3. BOND FENCE POST TO GROUND RING USING AN EXOTHERMIC WELD. BOND FENCE GATE TO POST WITH A FLEXIBLE COPPER JUMPER STRAP MECHANICALLY OR EXOTHERMICALLY. TYPICAL FOR ALL FENCE PLANES WITHIN 12 FEET OF TOWER FOUNDATION. FOR FENCE PLANES BEYOND 12', EXTEND 1#2 TO EACH FENCE PLANE TO ANY PLANES WITHIN 50'.
- 4. BOND DISCONNECT SWITCH, METER, TELEPHONE CABINET AND SERVICE CONDUITS TO BURIED GROUND RING AS THEY CROSS.
- 5. EACH LEG OF THE WAVEGUIDE STRUCTURE SHALL BE INDIVIDUALLY BONDED TO THE BURIED GND RING. EXOTHERMICALLY WELD CONNECTIONS AT POST FOR WAVEGUIDE STRUCTURE AND BURIED GND RING. PLACE 5/B"X10" COPPERCLAD GND ROD AT 10' INTERVALS ALONG WAVEGUIDE PATH.
- 6. BDND REBAR IN CONCRETE FOR COMMUNICATION STRUCTURE AND EQUIPMENT PAD TO BURIED GROUND RING. EXOTHERMICALLY WELD A #2 TINNED SOLID COPPER CONDUCTOR TO THE REBAR AND CONNECT TO THE BURIED GROUND RING.
- 7. PROVIDE INSPECTION SLEEVE AT MAIN SERVICE GROUNDS. EXOTHERMIC CONNECTIONS.
- B. PROVIDE BONDING CONDUCTOR(S) FROM THE BURIED GROUND RING TO THE ANTENNA CABLE BUS BAR AT POINT JUST INSIDE OF THE COMMUNICATION STRUCTURE EXIT, VERIFY EXACT LOCATION OF COPPER BUS BAR FOR PROPER CONDUCTOR LENGTH. FINAL EXOTHERMIC WELDS TO COPPER BUS BAR BY THE ANTENNA CABLE INSTALLER.
- EXOTHERMICALLY WELD BONDING CONDUCTOR TO COMMUNICATION STRUCTURE LEG AT 1'-0" ABOVE PAD AND BOND TO BURIED GROUND RING. PROVIDE A 3/4" PVC SLEEVE WITH A GRADUAL BEND IN THE CONCRETE FOUNDATION.
- 5/8"X10"-0" LONG COPPER CLAD GND ROD AS SHOWN ON PLAN (NON-LINEAR). TYPICAL FOR ALL GROUND RODS SHOWN. USE STAINLESS STEEL HARDWARE WHERE APPLICABLE.

- 12. ALL CONNECTIONS TO GROUND SYSTEM SHALL BE MADE IN LINE WITH BENDS NOMINAL 12" RADIUS IN THE DIRECTION OF CURRENT FLOW. T—CONNECTIONS WILL NOT BE
- 13. ALL BENDS IN GROUND WIRES SHALL BE NOMINAL 12" RADIUS.
- ANTENNA CABLES SHALL BE BONDED AT EACH END. RUNS GREATER THAN 150' SHALL BE BONDED TOWARDS MIDDLE OF LENGTH, COORDINATE LOCATION WITH WIRELESS CARRIER'S PROJECT MANAGER.
- WHEN APPLICABLE, CONTRACTOR SHALL BOND FRAMES TO EACH OTHER AND TO GND RING VIA TWO PATHS. COORDINATE WITH WIRELESS CARRIER PROJECT MANAGER.
- CONTRACTOR CAN PROVIDE ONE OF THE FOLLOWING AS DIRECTED BY THE PROJECT MANAGER: THE SECOND OPTION IS PREFERRED.
 - A. CADWELD EACH CABINET GROUND WIRE TO GROUND RING AS SHOWN IN EQUIPMENT GROUND DETAIL. B. CADWELD EACH WIRE TO A 1/4"X4"X24" MIN. COPPER BUS BAR LOCATED BEHIND RADIO CABINET. EXTEND A #2 WIRE FROM EACH END OF COPPER BUS BAR TO GROUND RING.
- PROVIDED BRAIDED BONDING JUMPERS BETWEEN EACH GATE AND POST (OPTIONAL).
- CONTRACTOR SHALL PROVIDE EXOTHERMIC BONDING AT ALL BURIED GROUND RING CONNECTIONS, STRUCTURAL EQUIPMENT FRAME, SERVICE RACK(S), EXISTING TOWER GROUND RINGS, AND AS INSTRUCTED BY METROPCS CPM.
- CONTRACTOR SHALL PROVIDE MECHANICAL BONDING AT ALL ANTENNA SECTOR GROUND BARS, ALL ELECTRICAL EQUIPMENT DISCONNECTS, TRANSFORMERS, J-BOXES, PANEL-BOARDS, CABINETS, AND MAIN GROUND BAR AS DIFFECTED BY METROPES CPM. ALL MECHANICAL CONNECTIONS SHALL BE PROPERLY TERMINATED W/ LUGS, NUTS & BOLTS.
- CONTRACTOR SHALL COAT WITH NOX-OX ALL POINTS OF CONTACT BETWEEN DISSIMILAR METALS.

ABBREVIATIONS

ANTENNA

AWG AMERICAN WIRE GAUGE

BCW BARE COPPER WIRE

RWY RACEWAY

RIGID GALVANIZED STEEL

ELECTRICAL METALLIC TUBING DRAWING

LIGHTNING PROTECTION SYSTEM STAINLESS STEEL

DWG LPS. S.S. PNL. CLF. CURRENT LIMITING FUSI

CADWELD TYPE CONNECTION

5/8" X10'-0" COPPERCLAD GRND. ROD W/INSP. SLEEVE

5/8" X10'-0" COPPERCLAD GRND, ROD

0 MECHANICAL TYPE CONNECTION

--- #2 TINNED SOLID BARE CU WIRE --- UNDER GROUND TELCO CONDUIT

---- UNDER GROUND ELECTRIC CONDUIT

COI) CONDUIT TAG 1; REFER TO RISER M-1,3) CONDUIT TAG 1; PANEL SCHEDULE



GENERATOR RECEPTACLE





APPLICANT/OWNER:

777 YAMATO ROAD, SUITE 600 **BOCA RATON, FLORIDA 33431**

PROJECT NAME AND LOCATION:

CASA MARINA VERIZON SITE #62335 1500 REYNOLDS STREET KEY WEST, FL 33040

PROJECT ENGINEER



A

ONE

ENGINEERING AND EQUIPMENT LLC 820 W INDIANTOWN BOAD SLITE 105

No. 51567 STATE OF

ENGINEER SEAL

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CITY OF KEY WEST, FLORIDA


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SHEET TITLE

ELECTRICAL NOTES SHEET NUMBER

F-1



240V LOAD CALCULATION

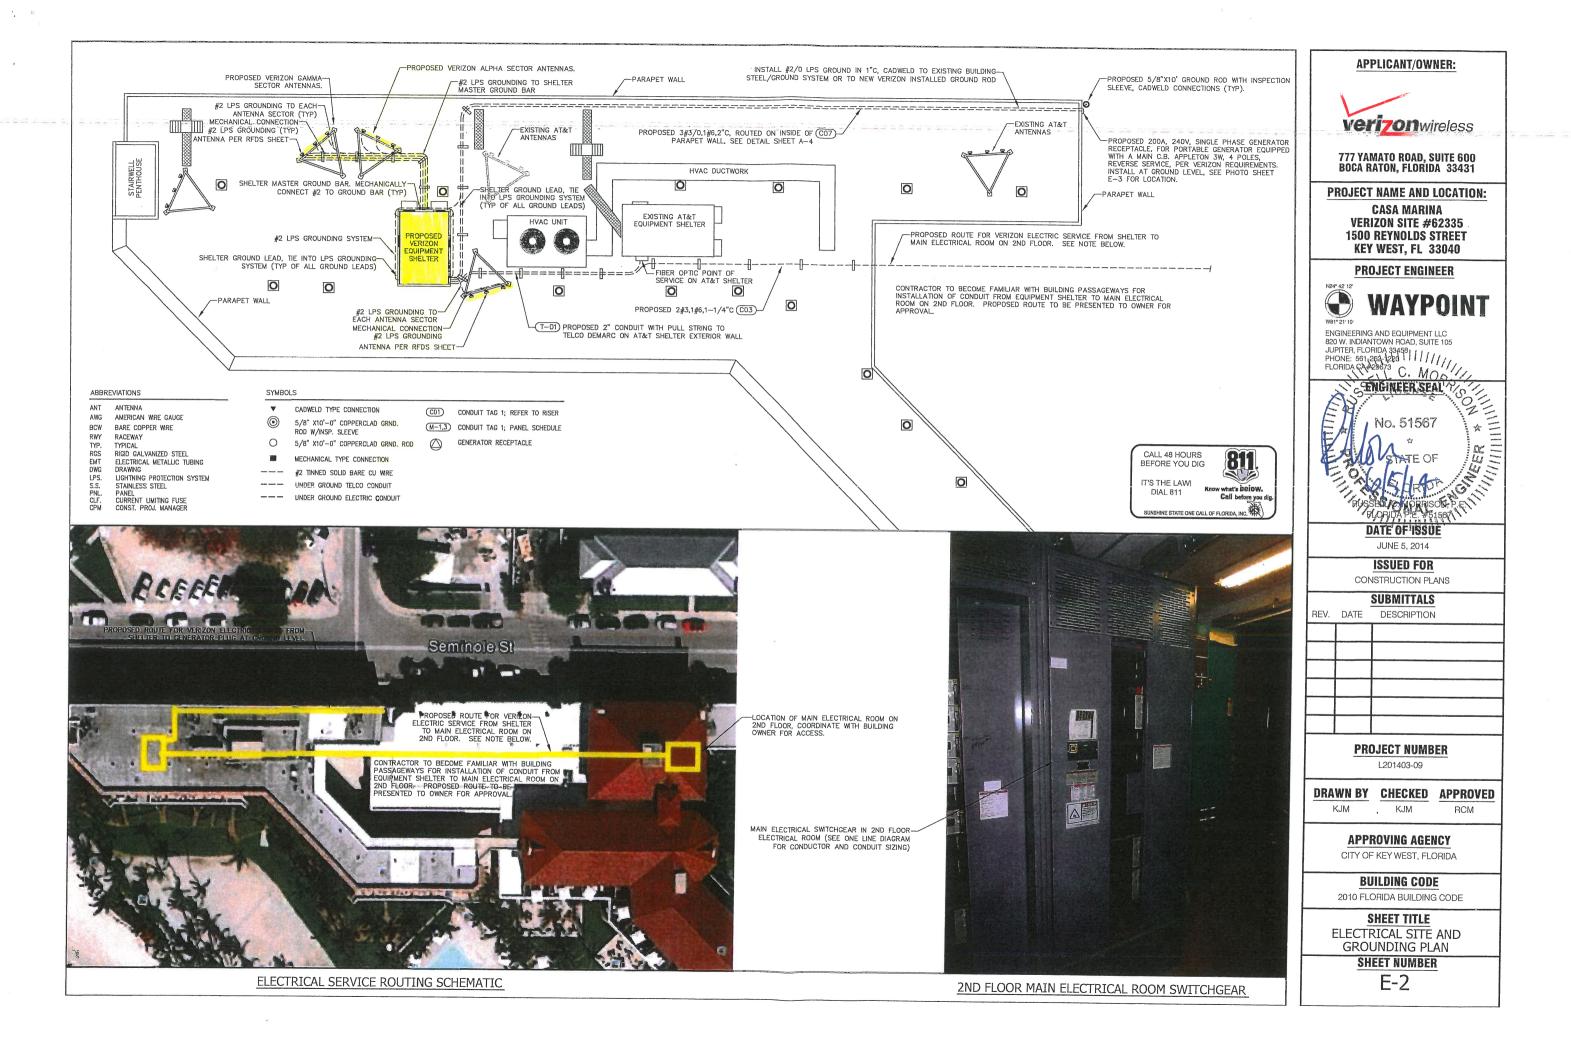LOAD	AMPS
VERIZON WIRELESS CONNECTED LOAD	75
TOTAL	75

VOLTAGE PROVIDED: 240V, SINGLE PHASE, 3 WRE, AMPS PROVIDED: 200AMPS, 1C/PHASE, 3/0 CU


-VERIZON ATS (SUPPLIED WITH SHELTER) AT&T TELCO DEMARC ON-PROPOSED 3#3/0,1#6,2"C (CO6)-AT&T SHELTER WALL PROPOSED 2P-200A/200A FUSIBLE DISC. SW., NEMA 3R, 100KAIC--VERIZON MTS AND LOAD CENTER (SUPPLIED WITH SHELTER) EXISTING AT&T SHELTER-PROPOSED 3#3/0,1#6,2"C (CO5)-PROPOSED 50KVA. 48DV: 120/240V XEMR WITH RAINSHIELDS. PROPOSED 2#3,1#6,1-1/4"C CO4)-PROPOSED 2P-100A/100A NF DISC. SW. 600V-RATED, NEMA 3R, 100KAIC -SEE VERIZON SHELTER PLANS FOR INTERNAL WIRING SCHEMATIC INTERNAL VERIZON TELCO— BACKBOARD (SUPPLIED WITH SHELTER) PROPOSED 2" CONDUIT WITH PULL STRING TO (T-01)-TELCO DEMARC ON AT&T SHELTER EXTERIOR WALL ROOF LEVEL

INSTALL #2/O LPS GROUND, CADWELD TO— EXISTING BUILDING STEEL/GROUND SYSTEM OR TO NEW VERIZON INSTALLED GROUND ROD


CONTRACTOR SHALL PROVIDE A RECORDING AMPMETER FOR 30 DAYS MIN. PER NEC 220—87. CONTRACTOR TO SUBMIT TO ENGINEER/OWNER THE MAXIMUM RECORDED VALUE OF THE HIGHEST AMP LOAD. THE EXISTING MAXIMUM DEMAND SHALL BE MULTIPLIED BY 125%. THE NEW LOAD SHALL BE ADDED TO THE MAXIMUM LOAD X 125%. THIS NEW TOTAL VALUE SHALL BE LESS THAN 80% OF THE AMP RATING OF THE SERVICE CONDUCTORS. DO NOT BEGIN OTHER WORK UNTIL THESE REQUIREMENTS ARE MET.



2000A 277/480V PANEL MAIN ELECTRICAL ROOM

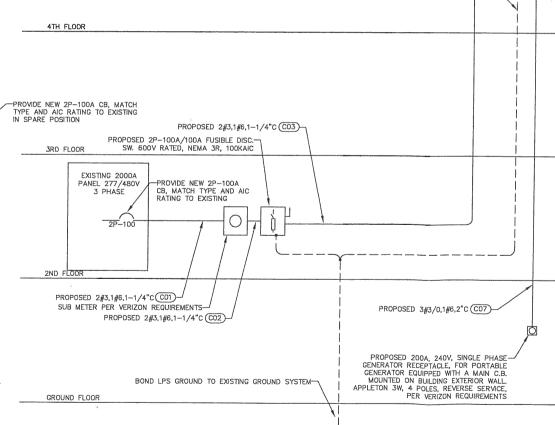



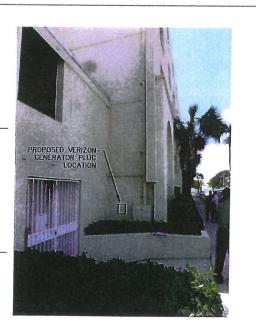

ELECTRICAL AND TELCO RISER DIAGRAM

APPLICANT/OWNER:



777 YAMATO ROAD, SUITE 600 **BOCA RATON, FLORIDA 33431**

PROJECT NAME AND LOCATION:

CASA MARINA VERIZON SITE #62335 1500 REYNOLDS STREET KEY WEST, FL 33040

PROJECT ENGINEER



ENGINEERING AND EQUIPMENT LLC 820 W, INDIANTOWN ROAD, SUITE 105 820 W. INDIANTOWN HOAD, SUITE TOS JUPITER, FLORIDA 33458 PHONE: 561-252-1220

ENGINEER SEAL P No. 51567 SECTO MORRISON:

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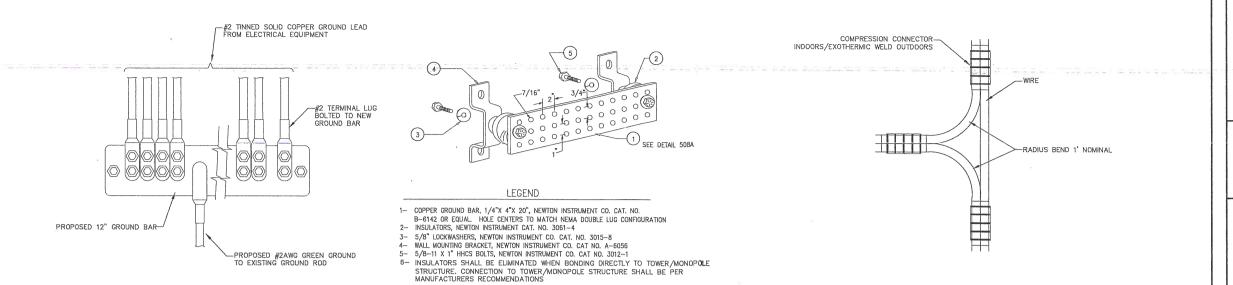
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ELECTRICAL RISER TELCO RISER


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E-3




GROUND BAR DETAIL

NON-DIRECTIONAL SPLICE

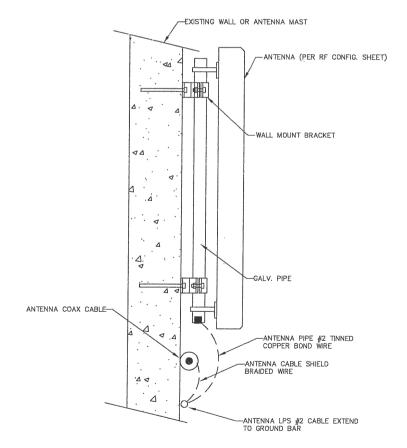

ANTENNA LPS DETAIL

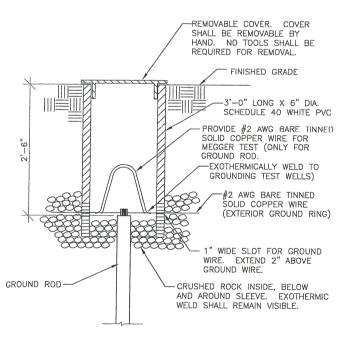

GROUND ROD INSPECTION SLEEVE DETAIL

ELECTRICAL DETAILS

APPLICANT/OWNER:



777 YAMATO ROAD, SUITE 600 **BOCA RATON, FLORIDA 33431**

PROJECT NAME AND LOCATION:

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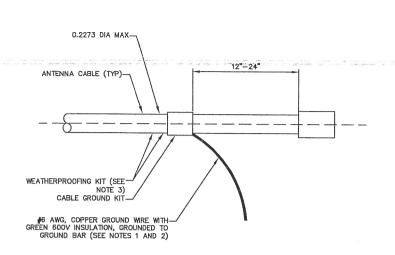
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SHEET TITLE

ELECTRICAL DETAILS

SHEET NUMBER

E-4




- 1. DO NOT INSTALL CABLE GROUND KIT AT A BEND AND ALWAYS DIRECT GROUND WIRE DOWN TO GROUND BAR
- 2. GROUND KIT WILL BE TYPE AND PART NUMBER AS SUPPLIED OR RECOMMENDED BY CABLE MANUFACTURER
- 3. WEATHER PROOFING SHALL BE TYPE AND PART NUMBER AS SUPPLIED OR RECOMMENDED BY CABLE MANUFACTURER

CONNECTION OF GROUND CABLE KIT TO ANTENNA CABLE


-GROUNDING CLAMP (TYP)

-1/8" MIN, 1/4" MAX

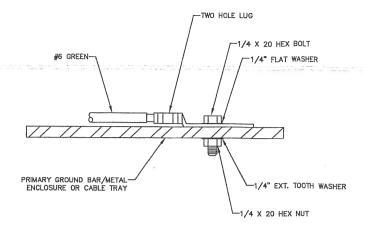

- 1. CHOOSE BOLT LENGTH TO ALLOW FOR A MINIMUM OF 2 EXPOSED THREADS
- 2. BURNISH MOUNTING AREA TO REMOVE PAINT OR SCALING IN AREA FOR LUG TO BE MOUNTED
- 3. APPLY ANTI OXIDANT COMPOUND TO MATING SURFACE OF LUG AND WIPE CLEAN EXCESS COMPOUND
- 4. USE SOLID COPPER WIRE AND TWO HOLE LUG FOR ALL EXTERIOR GROUNDING APPLICATIONS

GROUNDING CONNECTION DETAIL

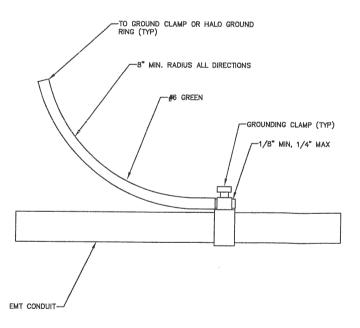




-COUPLING

₫6 GREEN-


EMT CONDUIT


CONDUIT BOND DETAIL

ELECTRICAL DETAILS

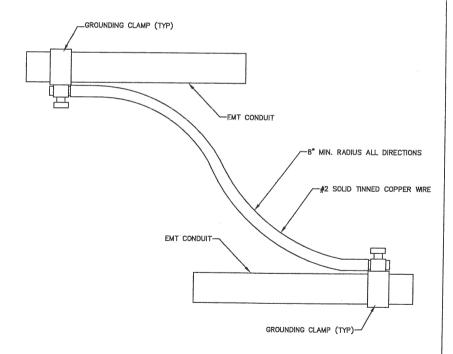

MULTIPLE CONDUIT GROUNDING DETAIL

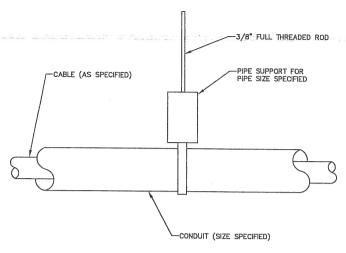

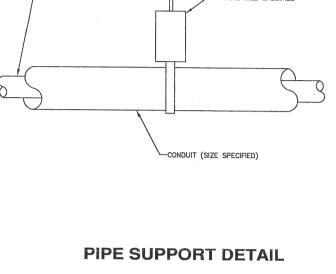

APPLICANT/OWNER:



777 YAMATO ROAD, SUITE 600 BOCA RATON, FLORIDA 33431


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PROJECT ENGINEER



ENGINEERING AND EQUIPMENT LLC 820 W. INDIANTOWN ROAD, SUITE 105 JUPITER, FLORIDA 33458



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ELECTRICAL DETAILS

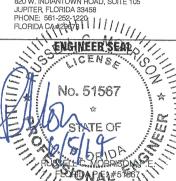SHEET NUMBER


E-5




AXP19-60 Xpol, 60° H-Beams


1710-2170 MHz

Electrical Specifications		Mechanical Specifications	Link to Mechanical Drawing
Frequency	1710-2170 MHz	Input Connector (female)	Back 7/16 DIN or w/bot, opt.
Polarization	Slant +/- 45	Antenna Dimensions (LxWxD)	69.1 x 6.7 x 4.1 in. (1755 x 170 x 104mm)
Gain @ 1710 MHz	19.0 dBi	Antenna Dimensions with Opt-"ip"	69.1 x 6.7 x 4.5 in. (1755 x 170 x 114mm)
Gain @ 1920 MHz	19.3 dBi	*Antenna Weight	15.0 lbs
Gain @ 2170 MHz	19.6 dBi	Bracket Weight	13.2 lbs
Horizontal Beam (3dB Points)	60°	RF Distribution	Printed Microstrip Substrate
Vertical Beam (3dB Points)	5°	Radome	Ultra High-Strength Luran
Elect. Downtilt Range, 2º Increments	0-6°	Weatherability	UV Stabilized, ASTM D1925
VSWR / Return Loss	<1.40:1 / 15.6 dB	Radome Water Absorption	ASTM D570, 0.45%
VSWR / Return Loss w/ip	<1.50:1 / 14.0 dB	Environmental	MIL-STD-810E
Front-to-Back at Horizon	>30 dB	Wind Survival	150 mph
Upper Side Lobe Suppression	<-18 dB	Front Wind Load @100mph	105 lbf
Impedance	50 Ohms	Equivalent Flat Plate @100mph	2.13 sq-ft. (c=2)
Power Input Per Connector	250 CW at 1900 MHz	Mounting Brackets	Fits 3.5 Inch Max. O.D. Pipe
Isolation	< -28 dB	Mechanical Downtilt Range	0-12°·
Intermodulation (2x20W)	typ -150 dBc	Clamps/Bolts	Galvanized Steel/Stainless Steel

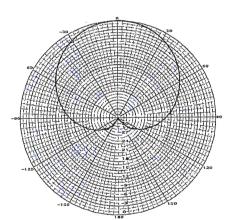

and back mounted connectors, bottom mounted connectors

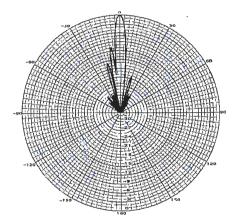

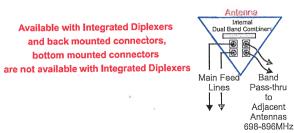

Integrated Pass-Thru Diplexers will work with TMA's

Recommended Connector Coupling Torque 7/16 DIN: 220-265 lbf-in (25-30 N-m)

Ordering Information & Options

AXP19-60-X AXP19-60-xip AXP19-60-x-bot "-x" is a placeholder for the built-in fixed electrical downtilt in degrees, set to 0, 2, 4 or 6

"ip" option includes pass-thu integrated diplexer(s) which pass DC to the diplexer port(s)

for bottom mounted connectors, add "-bot" (otherwise antenna comes standard with back mounted connectors)








X7-665 Xpol, 65° H-Beam

698-800 MHz

Link to Mechanical Drawing

Electrical Specifications		Mechanical Specifications	
Frequency	698-800 MHz	Input Connector (female)	Back 7/16 DIN or w/bot. opt.
Polarization	Slant +/- 45	Antenna Dimensions (LxWxD)	72.0 x 12.5 x 7.1 in. (1829 x 318 x 180mm)
Gain @ 698 MHz	15.3 dBi	*Antenna Weight	30.0 lbs
Gain @ 752 MHz	15.6 dBi	Bracket Weight	13.2 lbs
Gain @ 782 MHz	15.8 dBi	Lightning Protection	Direct Ground
Horizontal Beam (3dB Points)	65°	RF Distribution	Printed Microstrip Substrate
Vertical Beam (3dB Points)	10°	Radome	Ultra High-Strength Luran
Elect. Downtilt Range, 2º Increments	0-10°	Weatherability	UV Stabilized, ASTM D1925
VSWR / Return Loss	<1.40:1 / 15.6 dB	Radome Water Absorption	ASTM D570, 0.45%
Front-to-Back at Horizon	>30 dB	Environmental	MIL-STD-810E
Upper Side Lobe Suppression	<-18 dB	Wind Survival	150 mph
Impedance	50 Ohms	Front Wind Load @100mph	177.4 lbf
Power Input Per Connector	500 CW at 800 MHz	Equivalent Flat Plate @100mph	3.6 sq-ft. (c=2)
Isolation	<-28 dB	Mounting Brackets	Fits 3.5 Inch Max. O.D. Pipe
Intermodulation (2x20W)	<-150 dBc	Mechanical Downtilt Range	0-12°
		Clamps/Bolts	Galvanized Steel/Stainless Steel

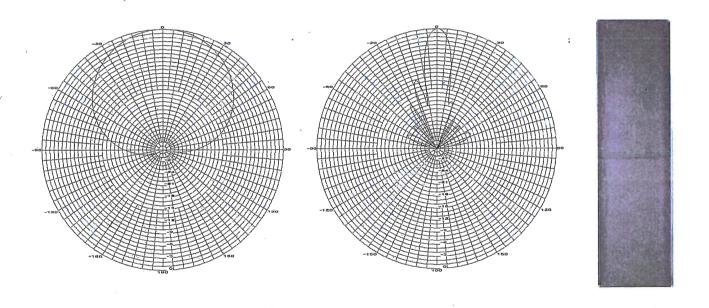

Recommended Connector Coupling Torque 7/16 DIN: 220-265 lbf-in (25-30 N-m)

Ordering Information & Options

X7-665-x X7-665-x-bot "-x" is a placeholder for the built-in fixed electrical downtilt in degrees, set to 0, 2, 4, 6, 8 or 10 for bottom mounted connectors, add "-bot" (otherwise antenna comes standard with back mounted connectors)






www.cssantenna.com

^{*}Antenna Weight may vary slightly with options.

^{*}Antenna Weight may vary slightly with options.

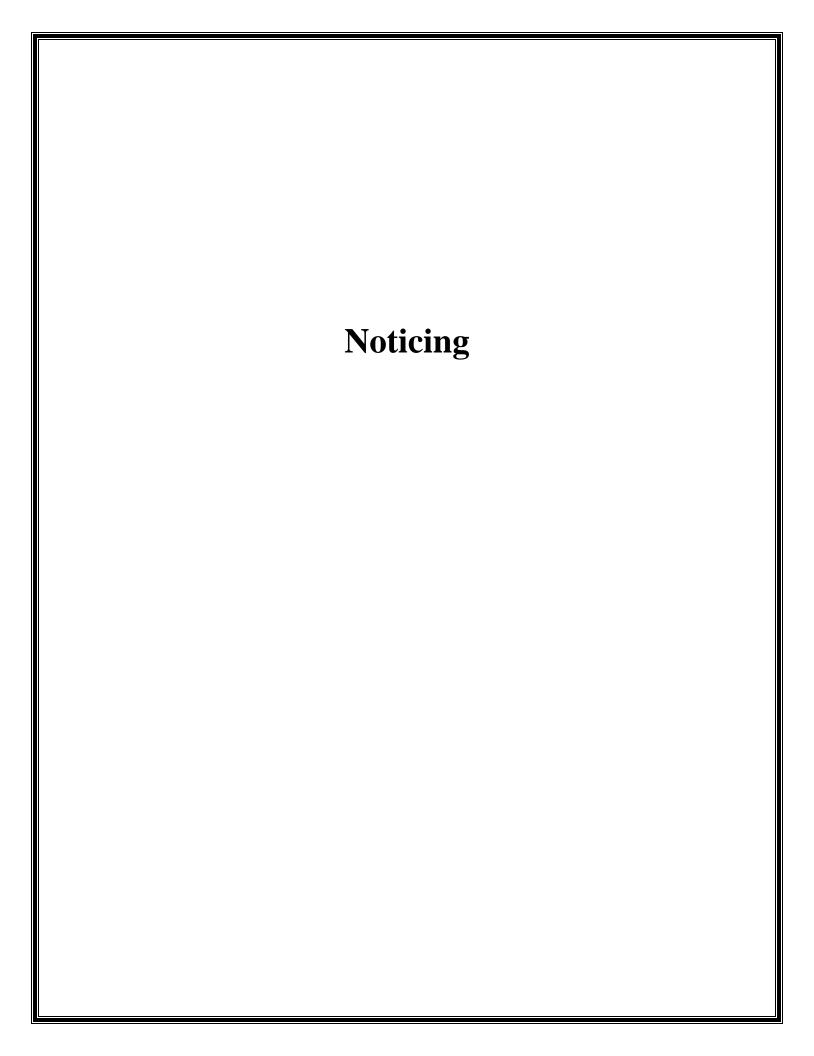

The Historic Architectural Review Commission will hold a special public hearing <u>at 5:30 p.m., October 28, 2014</u> <u>at Old City Hall, 510 Greene Street</u>, Key West, Florida. The purpose of the hearing will be to consider a request for:

INSTALLATION OF NEW WIRELESS EQUIPMENT SHELTER AND THREE ARRAYS OF ANTENNAS ON ROOF OF NON-HISTORIC CASA MARINA STRUCTURE.


FOR- #1500 REYNOLDS STREET

Applicant- Verizon Wireless

Application # H14-01-1106

If you wish to see the application or have any questions, you may visit the Planning Department during regular office hours at 3140 Flagler Avenue, call 809-3973 or visit our website at www.cityofkeywest-fl.gov.

THIS NOTICE CAN NOT BE REMOVED FROM THE SITE UNTIL HARC FINAL DETERMINATION

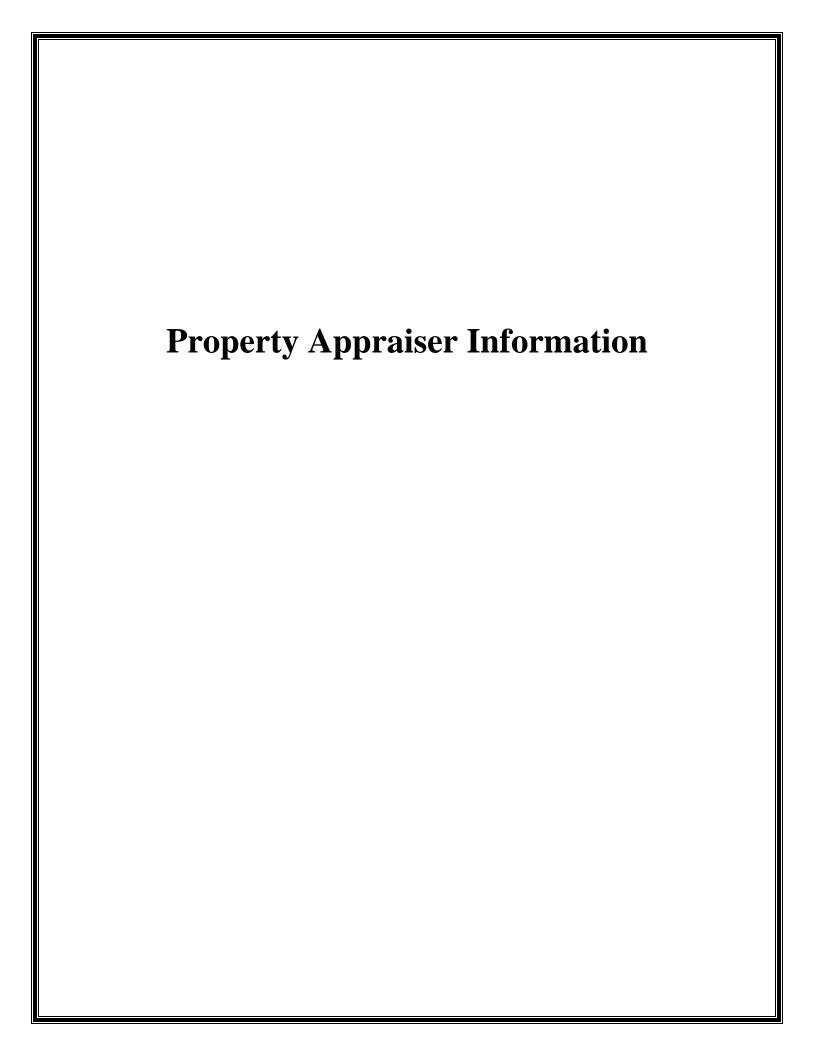

» Tax Collector

Monroe County Cities

- » City of Key West
- » City of Marathon
- » City of Key Colony Beach
- » City of Layton
- » Islamorada, Village of Islands

First Time Home Buyer (IRS)

- » Cancellation of Debt Flyer (English)
- » Cancellation of Debt Flyer (Spanish)
- » 1st Time Homebuyers Fact Sheet
- » 1st Time Homebuyers Basic Information
- » 1st Time Homebuyers Scenarios
- » 1st Time Homebuyers Q& A's

IRS Links

- » Make Work Pay Credit
- » Energy Conservation Credit

Other Links

- » FL Dept Rev Property Tax Oversight
- » Census Info

Property Record Card -

Maps are now launching the new map application version.

Return to Search Results | Modify Search | New Search | Send Email to MCPA Regarding this Parcel | Estimate Taxes on this Parcel

Previous Record Alternate Key: 8735677 Parcel ID: 00037160-000100 Next Record

Ownership Details

Mailing Address: CASA MARINA OWNER LLC PO BOX 437 BROADWAY, NJ 08808-0437

Property Details

Property Search -- Monroe County Property Appraiser

PC Code: 39 - HOTELS, MOTELS

Millage Group:

10KW

Affordable

No

Housing:

Section-

Township-05-68-25

Range:

Property 1500 REYNOLDS ST KEY WEST Location: 811 SEMINOLE ST KEY WEST Subdivision: Key West Investment Co's Sub

> KW KW INVESTMENT CO SUB PB1-69 SQRS 1 THRU 5 & PT SQR 6 & SQR 7 TR 17 G6-103 G37-65/67 G70-508/9 OR175-144/45 OR214-88/89 OR274-337/38 OR332-35 OR387-997/99 OR388-

826/28 OR399-599/600 OR427-61/62 OR534-1098 OR660-860/887 OR695-8/9OR1033-627/632

Legal

OR1033-633/648 OR1033-649/664 OR1350-357/368(LEASE) OR1350-385/91-C OR1359-

Description:

745/774(LEASE) OR1436-592/597OR1436-598/608 OR1437-275/278Q/C OR1624-743/763(LEASE)

OR1624-764/779(LEASE) OR1701-931/932Q/C OR2115-141/147 OR2326-1954/1959(REST)

OR2347-648/666(II LEASE) OR2414-19/25(REST)

Click Map Image to open interactive viewer



Land Details

Land Use Code	Frontage	Depth	Land Area
100W - COMMERCIAL WATERFRON	0	0	290,110.00 SF
100D - COMMERCIAL DRY	0	0	83,000.00 SF

Building Summary

Number of Buildings: 7 Number of Commercial Buildings: 7

Total Living Area: 183188 Year Built: 1901

Building 1 Details

Extra Fix

Building Type		Condi	tion	G	Quality Grade	450
Effective Age	21	Perim	eter	918	Depreciation %	27
Year Built	1901	Specia	al Arch	0	Grnd Floor Area	11,610
Functional Obs	0	Econo	omic Obs	0		
Inclusions:						
Roof Type		Roof	Cover		Foundation	
Heat 1		Heat 2	2		Bedrooms	0
Heat Src 1		Heat S	Src 2			
Extra Features:						
2 Fix Bath		0	Vacuum			0
3 Fix Bath		0	Garbage Disp	osal		0
4 Fix Bath		0	Compactor			0
5 Fix Bath		0	Security			0
6 Fix Bath		0	Intercom			0
7 Fix Bath		0	Fireplaces			0

Dishwasher

0

9



Sections:

Nbr	Type	Ext Wall	# Stories	Year Built	Attic A/C	Basement %	Finished Basement %	Area
1	FLA		1	1986				3,870
2	FLA		1	1986				3,870
3	FLA		1	1986				3,870

Interior Finish:

Section Nbr	Interior Finish Nbr	Type	Area %	Sprinkler	A/C
	15708	WAREHOUSE/MARINA A	100	N	N
	15709	WAREHOUSE/MARINA A	100	N	N
	15710	WAREHOUSE/MARINA A	100	N	N

Exterior Wall:

Interior Finish Nbr	Туре	Area %
5411	MIN WOOD SIDING	100

Building 2 Details

Building Type		Condition	G	Quality Grade	450
Effective Age	19	Perimeter	1,213	Depreciation %	23
Year Built	1916	Special Arch	0	Grnd Floor Area	92,058

Functional Obs	0	Econom	ic Obs	0		
Inclusions:						
Roof Type		Roof Co	ver		Foundation	
Heat 1		Heat 2			Bedrooms	0
Heat Src 1		Heat Src	2			
Extra Features:						
2 Fix Bath		0	Vacuum			0
3 Fix Bath		0	Garbage Dispo	osal		0
4 Fix Bath		0	Compactor			0
5 Fix Bath		0	Security			0
6 Fix Bath		0	Intercom			0
7 Fix Bath		0	Fireplaces			0
Extra Fix		0	Dishwasher			0

Building Sketch Image



Sections:

Nbr	Type	Ext Wall	# Stories	Year Built	Attic A/C	Basement %	Finished Basement %	Area
1	FLA		1	1915				92,058
2	CPF		1	1915				405
3	OPF		1	1915				7,084

Interior Finish:


Section Nbr	Interior Finish Nbr	Interior Finish Nbr Type		Sprinkler	A/C
	15711	HOTELS/MOTEL A	100	Y	Y
	15712	CPF	100	N	N
	15713	OPF	100	N	N

Exterior Wall:

Interior Finish Nbr	Type	Area %
5412	REIN CONCRETE	100

Building 3 Details

Building Type Effective Age Year Built Functional Obs	19 1979 0	-		G 760 0 0	Quality Grade Depreciation % Grnd Floor Area	450 23 13,704
Inclusions:						
Roof Type		Roof (Cover		Foundation	
Heat 1		Heat 2	2		Bedrooms	0
Heat Src 1		Heat S	Src 2			
Extra Features:						
2 Fix Bath		0	Vacuum			0
3 Fix Bath		0	Garbage Dispo	sal		0
4 Fix Bath		0	Compactor			0
5 Fix Bath		0	Security			0
6 Fix Bath		0	Intercom			0
7 Fix Bath		0	Fireplaces			0
Extra Fix		0	Dishwasher			0

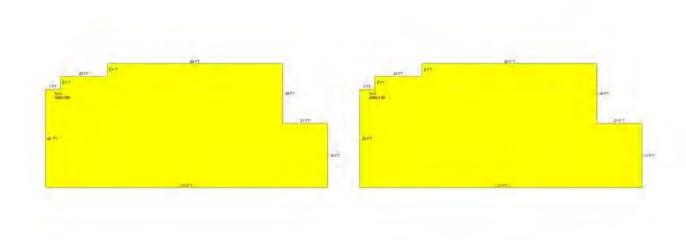

Sections:

Nbr	Type	Ext Wall	# Stories	Year Built	Attic A/C	Basement %	Finished Basement %	Area
1	FLA		1	1978				6,852
2	FLA		1	1978				6,852

Interior Finish:

Section Nbr	Interior Finish Nbr	Type	Area %	Sprinkler	A/C
	15714	HOTELS/MOTEL A	100	Y	Y
	15715	HOTELS/MOTEL A	100	Y	Y

Exterior Wall:

Interior Finish Nbr	Type	Area %
5413	C.B.S.	100

Building 4 Details

Building Type		Condition	G	Quality Grade	450
Effective Age	19	Perimeter	1,045	Depreciation %	23
Year Built	1979	Special Arch	0	Grnd Floor Area	52,446
Functional Obs	0	Economic Obs	0		

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ı	n	C	119	C1	Ωn	S.

Roof Type	Roof Cover		Foundation	
Heat 1	Heat 2		Bedrooms	0
Heat Src 1	Heat Src 2			
Extra Features:				
2 Fix Bath	0	Vacuum		0
3 Fix Bath	160	Garbage Disposal		0
4 Fix Bath	0	Compactor		0
5 Fix Bath	0	Security		0
6 Fix Bath	0	Intercom		0
7 Fix Bath	0	Fireplaces		0
Extra Fix	0	Dishwasher		0

Building Sketch Image



Sections:

Nbr	Type	Ext Wall	# Stories	Year Built	Attic A/C	Basement %	Finished Basement %	Area
1	SBU		1	1978				5,495
2	SBF		1	1978				5,863
3	FLA		1	1978				1,232
4	OUF		1	1978				30,006
5	EPB		1	1978				1,800
							·	

6	FLA	1	1978	51,214
7	PTO	1	1978	13,433

Interior Finish:

Section Nbr	Interior Finish Nbr	Туре	Area %	Sprinkler	A/C
	15716	SBU	100	N	N
	15717	SBF	100	N	N
	15718	OFF BLDG 1 STY-A	100	Y	Y
	15719	OUF	100	N	N
	15720	EPB	100	N	Y
	15721	HOTELS/MOTEL A	100	Y	Y
	15722	PTO	100	N	N

Exterior Wall:

Interior Finish Nbr	Type	Area %
5414	C.B.S.	100


Building 5 Details

Building Type Effective Age Year Built Functional Obs	19 1986 0	Condition Perimeter Special Arch Economic Obs	E 638 0 0	Quality Grade Depreciation % Grnd Floor Area	450 23 6,972
Inclusions: Roof Type		Roof Cover		Foundation	
Heat 1		Heat 2		Bedrooms	0

Heat Src 2

Heat Src 1
Extra Factures:

Extra Features:			
2 Fix Bath	0	Vacuum	0
3 Fix Bath	0	Garbage Disposal	0
4 Fix Bath	0	Compactor	0
5 Fix Bath	0	Security	0
6 Fix Bath	0	Intercom	0
7 Fix Bath	0	Fireplaces	0
Extra Fix	252	Dishwasher	0

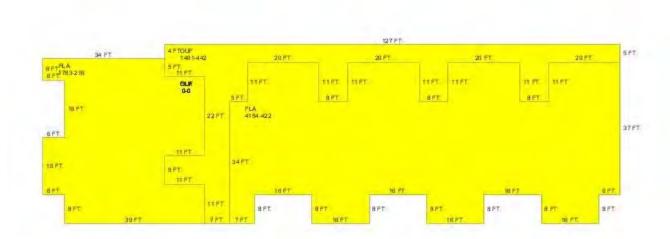

Sections:

Nbr	Type	Ext Wall	# Stories	Year Built	Attic A/C	Basement %	Finished Basement %	Area
1	FLA		3	1986				1,783
2	OUF		1	1985				1,401
3	FLA		1	1985				4,154
4	FLA		1	1986				1,035
5	OUF		1	1986				2,760
6	OUF		1	1986				2,802

Interior Finish:


Section Nbr	Interior Finish Nbr	Type	Area %	Sprinkler	A/C
	15723	HOTELS/MOTEL A	100	Y	Y
	15724	OUF	100	N	N
	15725	HOTELS/MOTEL A	100	Y	Y
	15726	HOTELS/MOTEL A	100	Y	Y
	15727	OUF	100	N	N
	15728	OUF	100	N	N

Exterior Wall:

Interior Finish Nbr	Type	Area %
5415	CUSTOM	100

Building 6 Details

Building Type Effective Age Year Built Functional Obs	19 1986 0	-		G 592 0 0	Quality Grade Depreciation % Grnd Floor Area	450 23 5,822
Inclusions:						
Roof Type		Roof	Cover		Foundation	
Heat 1		Heat	2		Bedrooms	0
Heat Src 1		Heat	Src 2			
Extra Features:						
2 Fix Bath		0	Vacuum			0
3 Fix Bath		0	Garbage Disposal			0
4 Fix Bath		0	Compactor			0
5 Fix Bath		0	Security			0
6 Fix Bath		0	Intercom			0
7 Fix Bath		0	Fireplaces			0
Extra Fix		0	Dishwasher			0

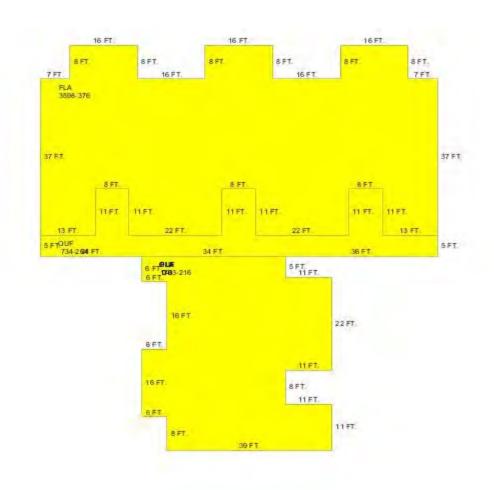

Sections:

Nbr	Type	Ext Wall	# Stories	Year Built	Attic A/C	Basement %	Finished Basement %	Area
1	FLA		3	1986				1,783
2	FLA		3	1986				3,598
3	OUF		1	1986				734
4	OUF		1	1986				1,104
5	OUF		1	1986				1,468
6	FLA		1	1986				441

Interior Finish:

Section Nbr	Interior Finish Nbr	Type	Area %	Sprinkler	A/C
	15729	HOTELS/MOTEL A	100	Y	Y
	15730	HOTELS/MOTEL A	100	Y	Y
	15731	OUF	100	N	N
	15732	OUF	100	N	N
	15733	OUF	100	N	N
	15734	HOTELS/MOTEL A	100	Y	Y

Exterior Wall:

Interior Finish Nbr	Type	Area %
5416	CUSTOM	100

Condition

Quality Grade


450

G

Building 7 Details

Building Type

\mathcal{E} 31						
Effective Age	19	Perin	neter	100	Depreciation %	23
Year Built	1979	Spec	ial Arch	0	Grnd Floor Area	576
Functional Obs	0	Ecor	nomic Obs	0		
Lachariana						
inclusions:						
Roof Type		Roof	f Cover		Foundation	
Heat 1		Heat	2		Bedrooms	0
Heat Src 1		Heat	Src 2			
Extra Features:						
2 Fix Bath		0	Vacuum			0
3 Fix Bath		0	Garbage Disposal			0
4 Fix Bath		0	Compactor			0
5 Fix Bath		0	Security			0
6 Fix Bath		0	Intercom			0
7 Fix Bath		0	Fireplaces			0
Extra Fix		0	Dishwasher			0
	Year Built Functional Obs Inclusions: Roof Type Heat 1 Heat Src 1 Extra Features: 2 Fix Bath 3 Fix Bath 4 Fix Bath 5 Fix Bath 6 Fix Bath 7 Fix Bath	Year Built 1979 Functional Obs 0 Inclusions: Roof Type Heat 1 Heat Src 1 Extra Features: 2 Fix Bath 3 Fix Bath 4 Fix Bath 5 Fix Bath 6 Fix Bath 7 Fix Bath	Year Built 1979 Spect Functional Obs 0 Econ Inclusions: Roof Type Roof Heat 1 Heat Heat Src 1 Heat Extra Features: 2 Fix Bath 0 3 Fix Bath 0 0 4 Fix Bath 0 0 5 Fix Bath 0 7 Fix Bath 0 0	Year Built Functional Obs 1979 Special Arch Economic Obs Inclusions: Roof Type Heat 1 Heat 2 Heat Src 1 Heat Src 2 Extra Features: 2 Fix Bath	Year Built 1979 Special Arch 0 Functional Obs 0 Economic Obs 0 Inclusions: Roof Type Roof Cover Heat 1 Heat 2 Heat Src 1 Heat Src 2 Extra Features: 2 Fix Bath 0 Vacuum 3 Fix Bath 0 Garbage Disposal 4 Fix Bath 0 Compactor 5 Fix Bath 0 Security 6 Fix Bath 0 Intercom 7 Fix Bath 0 Fireplaces	Year Built 1979 Special Arch 0 Grnd Floor Area Functional Obs 0 Economic Obs 0 Inclusions: Roof Type Roof Cover Foundation Heat 1 Heat 2 Bedrooms Heat Src 1 Heat Src 2 Extra Features: 2 Fix Bath 0 Vacuum 3 Fix Bath 0 Garbage Disposal 4 Fix Bath 0 Compactor 5 Fix Bath 0 Security 6 Fix Bath 0 Intercom 7 Fix Bath 0 Fireplaces

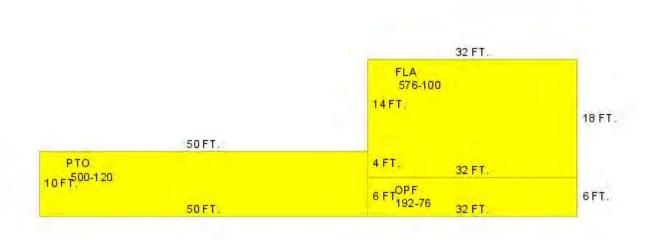

Sections:

Nbr	Type	Ext Wall	# Stories	Year Built	Attic A/C	Basement %	Finished Basement %	Area
1	FLA		1	1978				576
2	OPF		1	1978				192
3	PTO		1	1978				500

Interior Finish:

Section Nbr	Interior Finish Nbr	Type	Area %	Sprinkler	A/C
	15735	1 STY STORE-A	100	Y	Y
	15736	OPF	100	N	N
	15737	PTO	100	N	N

Exterior Wall:

Interior Finish Nbr	Type	Area %
5417	C.B.S.	100

Misc Improvement Details

Nbr	Type	# Units	Length	Width	Year Built	Roll Year	Grade	Life
0	PO5:COMM POOL	2,500 SF	0	0	2007	2014	3	50
1	DK4:WOOD DOCKS	3,840 SF	240	16	2000	2001	5	40

2	DK3:CONCRETE DOCK	2,338 SF	167	14	1979	1980	5	60
3	DK4:WOOD DOCKS	1,650 SF	150	11	2000	2001	5	40
4	TK2:TIKI	509 SF	0	0	1979	1980	4	40
5	AP2:ASPHALT PAVING	49,200 SF	0	0	1979	1980	2	25
6	RW2:RETAINING WALL	720 SF	180	4	1979	1980	3	50
7	PT2:BRICK PATIO	2,762 SF	0	0	1979	1980	5	50
8	PT2:BRICK PATIO	13,662 SF	0	0	1979	1980	2	50
9	AP2:ASPHALT PAVING	19,311 SF	0	0	1979	1980	2	25
10	PT3:PATIO	962 SF	0	0	1985	1986	2	50
11	PT3:PATIO	440 SF	0	0	1969	1970	2	50
12	RW2:RETAINING WALL	136 SF	68	2	1969	1970	4	50
13	AP2:ASPHALT PAVING	34,240 SF	0	0	1985	1986	2	25
14	PO5:COMM POOL	2,500 SF	0	0	2007	2014	3	50
15	HT2:HOT TUB	1 UT	0	0	1979	1980	5	50
16	CL2:CH LINK FENCE	256 SF	0	0	1993	1994	3	30
18	WD2:WOOD DECK	3,900 SF	0	0	1995	1996	2	40
19	CL2:CH LINK FENCE	360 SF	60	6	1989	1990	1	30
20	PT3:PATIO	765 SF	51	15	2000	2001	2	50
21	DK4:WOOD DOCKS	676 SF	26	26	2000	2001	5	40
23	TK2:TIKI	94 SF	0	0	2000	2001	5	40
24	FN2:FENCES	988 SF	247	4	2001	2002	4	30
25	FN2:FENCES	122 SF	0	0	2001	2002	2	30
26	BL2:BOAT LIFT	1 UT	0	0	2003	2004	2	20
27	WD2:WOOD DECK	200 SF	20	10	2003	2004	2	40

Appraiser Notes

2003-01-10 (241) 314 HOTEL ROOMS

DR-219 ATTACHED TO OR2115-141/147 STATES THE SALES PRICE IS \$107,500,000, BUT THE DOCUMENTARY STAMPS ON DEED CALCULATE THE SALES PRICE TO \$104,316,200 TPP 8538421 - WYNDHAM MARRIOTTCASA MARINA TPP 8695128 - THE MASSAGE STUDIO INC TPP 8930010 - HEARTLAND CASH NETWORK LLC FOR ATM @ CASA MARINA

TPP 8538421 - WYNDHAM MARRIOTTCASA MARINA TPP 8695128 - THE MASSAGE STUDIO INC TPP 8930010 - HEARTLAND CASH NETWORK LLC FOR ATM @ CASA MARINA

Building Permits

Bld	g Number	Date Issued	Date Completed	Amount	Description	Notes
21	09-4523	07/06/2009	07/06/2009	0	Commercial	ISSUED C/O
	10 3531	11/18/2010)	15,000	Commercial	INSTALLATION OF 200 AMP SERVICE, DATA AND GROUNDING ON ROOF TOP FOR ANTENNAS AND ASSOCIATED EQUIPMENT
	10-3530	11/18/2010)	30,000	Commercial	INSTALL WIRELESS TELECOMMUNICATION FACILITY ON EXISTING ROOF TOP.
	10-2776	08/24/2010)	6,000	Commercial	PICK UP AND RELAY BRICK PAVER DRIVEWAY APPROXIMATELY 3000SF NO NEW IMPERVIOUS AREAS WILL BE ADDED.

	10-1232 04/20/2010	11,000	Commercial	ERECT REPLACEMENT OF TWO 3.5 TON CHILLER UNITS FOR HALLWAYS, MAIN BUILDING. UNIT REPLACEMENT OF IDENTICAL SIZE AND DESIGN, NO DUCT. RECONNECT TO EXISTING PIPING. UNITS LOCATED INSIDE BUILDING ABOVE LOBBY.
	10-1081 05/13/2010	2,500	Commercial	AFTER THE FACT: REPLACE 1000 WATT POLE LIGHTS WITH 400 WATT LIGHTS. NEW LIGHTING ON EXISTING POLE. NEW LIGHTS TO MATCH EXISTING. SHIELDS TO BE INSTALLED AS NEEDED. LIGHT POST AND FIXTURES TO MATCH.
	10-0584 02/25/2010	8,000	Commercial	INSTALL WIRELESS CELLULAR PHONE SYSTEM WITH INSIDE ANTENNAE PROVIDING SIGNAL.
	10-1042 04/10/2010	26,936	Commercial	CONSTRUCT ROADWAY ENTRANCE 360SF PAVE PREPARED SURFACE 13,500SF WITH HOT ASPHALT, STRIPE 124 PARKING SPACES, 13 COMPACT SPACES AND 5 HANDICAP SPACES AS PER CITY AND ADA SPECS, SUPPLY AND INSTALL 60 CONCRETE CAR STOPS
	06-4050 07/06/2009 07/06/2009	0	Commercial	RENOVATED STRUCTURE (20 DEED RESTRICTED EFFICIENCY UNITS) INCLUDING PLUMBING ELECTRIC, MECHANICAL AND ROOFING.
	05-1104 04/11/2005	30,000	Commercial	REHABILITATION OF EXISTING WOOD ROOF FRAMING IN THE SPORTS HUT
	05-3219 08/02/2005	700	Commercial	REPLACE 30SF OF EXISTING DECKING
	05-3348 08/14/2005	11,000	Commercial	ALL TEMPORARY CONSTRUCTION FENCES MUST BE SECURED IF KEY WEST IF PLACED UNDER A HURRICANE WATCH OR WARNING. REPAIR OF FENCING AROUND TENNIS COURTS (200LF/6' H)
	05-3347 08/17/2005	60,250	Commercial	REPAIR/REPLACE CHAINLINK FENCE FOOTING ON TEH EAST SIDE (100LF). REPAIR BLOCK WALL ON THE WEST SIDE 180SF. REPAIR DOCK AND SWIMMING PIER.
	05-4328 10/12/2005	0	Commercial	REVISION TO EXISTING PERMIT (05-3348) REPLACE 100LF OF DAMAGES CHAIN LINK FENCE WITH ALUMINUM PICKET FENCE.
	05-2583 11/18/2005	2,400	Commercial	INSTALL TEMPORARY POWER FOR SIX SLEEPER TRAILER.
	05-5739 12/16/2005	29,988	Commercial	HURRICANE REPAIRS: RELEVEL THE FRONT OF THE DECK AND REPLACE THE BOARDS ON IT. BUILD THE HANDRAILS BACK AT THE END OF THE PIER. 12' REPAIR THE HANDRAIL AT THE FRONT OF THE PIER. 9' MATERIAL IS ACQ WOOD TREATMENT. REPAIR MISSING BOARDS.
Γ	05-5740 12/16/2005	70,850	Commercial	HURRICANE REPAIRS TO PIER
	06-0143 01/12/2006	10,000	Commercial	HURRICANE REPAIRS TO FENCEES
	06-0531 01/30/2006	1,000	Commercial	DEMO OF DRYWALL, WING WALLS TUB AND TRIM
	06-1228 04/12/2006	33,000	Commercial	HURRICANE DAMAGE: REPAIRS TO A/C SYSTEMS.
	06-2336 04/17/2006	11,600	Commercial	REPLACE/INSTALL NEW 110LF OF 3 & 4 FT OF WOOD PICKET FENCING AROUND MANAGERS

			OFFICE.
06/2582 04/25/2006	1,000	Commercial	EXTEND PERMIT FOR TEMPOARARY TRAILER THAT SITS ON CASA MARINA/ REACH PROPERTY
06-2897 06/15/2006	0		
06-5024 08/30/2006	20,000	Commercial	CARPET, FURNITURE, DRYWALL, DOORS AND RAILING DEMOLITION.
06-5031 08/30/2006	400,000	Commercial	REPLACE WATER CLOSETS, LAVATORIES, SHOWER AND SHOWER VALVES 981 AND 321 WATER LINES.
06-5962 10/30/2006	6,000	Commercial	RELOCATION OF EXISTING FIRE SPRINKLER HEADS
07-1522 03/29/2007	54,740	Commercial	INSTALL 1600SF NEW ROOFING
07-1557 04/02/2007	197,000	Commercial	DEMO OF POOL AREA 5500SF
07-1899	310,000		NEW RETAINING WALLS, POOL AREA CONCRETE, ALL CONCRETE HARD SCAPES, INCLUDING FILL PLACEMENT
07-2034 04/24/2007	95,000	Commercial	REFLECTING FOUNTAIN
07-2519 05/30/2007	280,000	Commercial	CONSTRUCT NEW COMMERCIAL POOL
07-3376 07/06/2007	160,000	Commercial	ADD NEW PAVILLION ONTO EXISTING KITCHEN STRUCTURE OF 6X6 POST V-GROOVE CEILING WITH CEDAR SHAKE ROOF. NEW CONCRETE FLOOR AT SUN SUN BAR AND KITCHEN REPAIR ROOF AT SUN SUN BAR.
07-1636 04/09/2007	0	Commercial	TEMPORARY CONSTRUCTION TRAILERS
07-4413 10/10/2007	80,000	Commercial	INSTALL NEW CABINTRY FOR NEW LOBBY BAR TO INCLUDE PAINT AND INTERIOR FINISHES.
07-3942 08/08/2007	100,000	Commercial	DEMO ALL SIDEWALKS AND FRONT ENTRY INSTALL NEW HEADER CURBS AT SIDEWALK.
07-4402 10/11/2007	9,500	Commercial	ISNTALLATION OF CONDUITS, PULL BOXES FOR LOW VOLTAGE WIRING, BRANCH CIRCUITS, WIRING DEVICES AND CONNECTION AS INDICATED ON PLANS.
14-1994 06/26/2014	258,000	Commercial	RENOVATE APPOXIMATELY 1263SF OF EXISTING SPA, REMOVE EXISTING WALL FINISHES AND FLOORING, BUILD NEW WALLS, DRYWALL, BASEBOARDS, INSTALL NEW ACT DROP CEILING AND FLOORING. INSTALL NEW INTERIOR DOORS AND CABINETS
07-5128 11/28/2007	1,000	Commercial	REPLACE EXISTING GAS LINE TO OUTDOOR KITCHEN, REPLACE MAINFOLD IN OUTDOOR KITCHEN, HOOK APPLIANCES.
07-5200 12/19/2007	27,000	Commercial	REMOVE EXISTING 4 K TANK AND INSTALL ONE NEW 2 K FIREGARD TANK ON EXISTING CONCRETE REQ CONNECT TO EXISTING PIPING.
07-5496 12/21/2007	15,000	Commercial	SEAL-COAT FRONT MAIN PARKING LOT AND SUITE BUILDING PARKING LOT; STRIPE BACK PARKING LOT TO PLAN SPECIFICATIONS AND TO EXISTING STANDARDS (MAIN PARKING AND SUITE PARKING ONLY). ADA/HANDICAP SPACES TO BE INCLUDED PER PLANS. AND AUXILIERY

				LOT.
	08-0658 03/19/2008	95,000	Commercial	COMMERICAL POOL RENOVATION.
	08-0499 02/26/2008	15,000	Commercial	REPLACE EXISTING 1250 GAL GREASE TRAP
	08-4582 02/02/2009	3,500	Commercial	ADD/RELOCATE FIRE SPRINKLER HEADS
	08-4583 02/02/2009	3,500	Commercial	ADD/RELOCATE FIRE SPRINKLER HEADS.
	07-0276 02/20/2007	40,000	Commercial	ADA ROOMS ONLY: APPLY NEW DRYWALL, PAINT AND FINISH INSTALLATION OF NEW FURNITURE.
	07-0716 02/14/2007	587,000	Commercial	REPLACE CHILLED WATER FAN COILS IN GUEST ROOMS (195 ROOMS)
	06-6802 02/02/2007	8,000	Commercial	REPLACE 5 WINDOWS AND 2 DOORS, ALL NEW GLASS IS LAMINATED IMPACT ROOM #402.
	07-0498 02/01/2007	30,178	Commercial	REMOVE AND ROOF ON BUILDING 7,8,9,10. INSTALLING SARNAFIL G-410 ENERGY SMART ROOFING MEMBRANE
	06-3951 01/16/2007	355,955	Commercial	
1	01-3978 12/14/2001 09/18/2002	22,000	Commercial	AWNING
2	02-0322 04/11/2002 09/18/2002	50,000	Commercial	SIDEWALK & DUCT
3	02-0635 04/22/2002 09/18/2002	99,800	Commercial	ANTENNAS
4	03-1400 04/21/2003 01/01/2004	61,000	Commercial	NEW ELECTRIC
5	02-1549 06/14/2002 09/18/2003	2,125	Commercial	INSTALLED NEW AWNING
6	03-3169 09/12/2003 09/18/2003	5,500	Commercial	REPLACED LIGHT FIXTURES
7	03-3425 09/25/2003 10/02/2003	1,800	Commercial	INSTALLED NEW CEILING WOR
8	03-2912 09/24/2003 10/02/2003	25,900	Commercial	INSTALLED 15 PITCH PANS
9	03-2406 09/26/2003 10/02/2003	20,350	Commercial	REPLACED PARTS A/C
10	03-2285 10/01/2003 10/08/2003	16,230	Commercial	INSTALLED NEW DECK 200SF
11	03-3806 11/03/2004 11/10/2003	21,000	Commercial	REPAIRED DECKING
12	03-3721 10/31/2003 11/08/2003	7,500	Commercial	REPAIRED ROOF DECK
13	04-2422 07/21/2004 12/17/2004	27,000	Commercial	REPLACE HALLWAY DOORS
14	05-3349 08/14/2005 12/11/2005	19,000	Commercial	REPAIR EXTERIOR LIGHTING IN COMMON AREAS,ALSO FANS .
15	06-6161 11/21/2006 04/15/2007	4,000	Commercial	DEMO 4469 SF OF WOOD FLOORING IN BAR AND RESTAURANT AREA
16	06-6162 11/27/2006 04/15/2007	88,000		DEMO 14,500 SF OF INTERIOR PUBLIC SPACE.THIS WILL INCLUDE BUILD BACK OF MENTIONED WORK
17	06-3951 01/16/2007 04/15/2007	355,955	Commercial	REMOVE OLD ROOF. REPLACE.5 WOOD FIBER OVER ISO SET IN HOT ASPHALT
18	07-0280 03/20/2007 04/15/2007	22,000	Commercial	REPLACE PLUMBING AT FLAGLER
19	07-4803 10/22/2007 11/22/2007	2,000	Commercial	INSTALL IRRIGATION SYSTEM
20	07-4822 10/24/2007 11/22/2007	7,500	Commercial	COVER DUCT FIRST FLOOR DRYWALL & METAL STUDS

Parcel Value History

Certified Roll Values.

View Taxes for this Parcel.

Roll Year	Total Bldg Value	Total Misc Improvement Value	Total Land Value	Total Just (Market) Value	Total Assessed Value	School Exempt Value	School Taxable Value
2014	27,550,765	656,655	18,220,567	65,621,679	30,934,707	0	65,621,679
2013	27,550,765	435,867	17,359,656	44,324,443	28,122,461	0	44,324,443
2012	28,949,152	446,565	17,359,656	25,565,874	25,565,874	0	25,565,874
2011	28,949,152	454,505	18,986,124	33,331,182	26,220,827	0	33,331,182
2010	30,372,154	465,125	14,397,600	23,837,116	23,837,116	0	23,837,116
2009	30,372,154	478,775	20,659,724	23,181,570	23,181,570	0	23,181,570
2008	30,388,565	493,423	34,432,873	60,000,000	60,000,000	0	60,000,000
2007	25,926,075	497,417	34,432,873	69,316,439	69,316,439	0	69,316,439
2006	25,926,075	335,472	44,563,750	74,743,668	74,743,668	0	74,743,668
2005	26,229,701	343,222	21,556,600	45,887,445	45,887,445	0	45,887,445
2004	26,814,915	505,548	21,556,600	45,887,445	45,887,445	0	45,887,445
2003	26,814,915	514,362	19,316,380	53,082,953	53,082,953	0	53,082,953
2002	26,814,915	528,119	19,316,380	53,082,953	53,082,953	0	53,082,953
2001	32,146,185	531,828	13,521,466	53,082,953	53,082,953	0	53,082,953
2000	32,051,273	161,846	11,026,169	47,461,104	47,461,104	0	47,461,104
1999	34,776,245	167,609	11,026,169	44,949,658	44,949,658	0	44,949,658
1998	23,184,164	172,915	11,026,169	44,949,658	44,949,658	0	44,949,658
1997	23,547,698	178,888	10,503,815	42,351,368	42,351,368	0	42,351,368
1996	0	168,380	10,503,815	10,672,195	10,672,195	0	10,672,195
1995	0	173,890	10,503,815	10,677,705	10,677,705	0	10,677,705
1994	0	180,785	10,503,815	10,684,600	10,684,600	0	10,684,600
1993	0	189,061	10,503,815	10,692,876	10,692,876	0	10,692,876
1992	0	197,041	10,503,815	10,700,856	10,700,856	0	10,700,856
1991	0	205,530	10,503,815	10,709,345	10,709,345	0	10,709,345
1990	0	213,299	9,350,374	9,563,673	9,563,673	0	9,563,673
1989	0	221,786	9,285,080	9,506,866	9,506,866	0	9,506,866
1988	0	156,967	8,762,726	8,919,693	8,919,693	0	8,919,693

Parcel Sales History

NOTE: Sales do not generally show up in our computer system until about two to three months after the date of sale. If a recent sale does not show up in this list, please allow more time for the sale record to be processed. Thank you for your patience and understanding.

Sale Date	Official Records Book/Page	Price	Instrument	Qualification
5/10/2005	2115 / 141	104,316,200	WD	Q
12/1/1996	1436 / 0592	54,346,000	WD	O
11/1/1987	1033 / 640	9,500,000	WD	M

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Monroe County Monroe County Property Appraiser Scott P. Russell, CFA P.O. Box 1176 Key West, FL 33041-1176