

# **Application For Variance**

City of Key West, Florida • Planning Department
3140 Flagler Avenue • Key West, Florida 33040-4602 • 305-809-3720 • www.keywestcity.com

Application Fee: \$1,150.00 / After-the-Fact: \$2,150.00 PLANNING DEPT. (includes \$100.00 advertising/noticing fee and \$50.00 fire review fee)

Please complete this application and attach all required documents. This will help staff process your request quickly and obtain necessary information without delay. If you have any questions, please call 305-809-3720.

PROPERTY DESCRIPTION: Site Address:
Zoning District: H CT Real Estate (RE) #: 00037160-000100
Property located within the Historic District? Yes \(\sigma\) No
APPLICANT: Owner Authorized Representative  Name: VERIZON WIRELESS - CHUCK FINK SBA-AGENT
Mailing Address:         777 Νω. 51 ST STREET           City:         BOCA RATON           State:         FL           Zip:         33487
City: BOCA RATON State: FL Zip: 33487
Home/Mobile Phone: 954-205-8932 Office: 561-226-9485 Fax:
Email:CFINK & SBASITE.COM
PROPERTY OWNER: (if different than above)  Name: CASA MARINA OWNER  Mailing Address: 501 E. CAMINO REAL  City: BOCA RATON State: FL- Zip: 33487
Home/Mobile Phone: Office: 561-447-3269 Fax:
Email:
Description of Proposed Construction, Development, and Use:  Add Verizon cellular antenna and equipment shelter to the roof of the Casa Marina Hotel. Collocate
with existing ATT installation at similar height.
List and describe the specific variance(s) being requested:
Variance from the HCT Zoning District height restrictions of 35'. The proposed Verizon antenna and shelter will not exceed height of 53.5' AGL. Height Variance requested of 18.5' to match existing ATT equipment.
Are there any easements, deed restrictions or other encumbrances attached to the property? $\Box$ Yes
f yes, please describe and attach relevant documents:

Will any work be within the dripline (canopy) of any tree on or off the property? If yes, provide date of landscape approval, and attach a copy of such approval.		No
Is this variance request for habitable space pursuant to Section 122-1078?	□ Yes	No

Please fill out the relevant Site Data in the table below. For Building Coverage, Impervious Surface, Open Space and F.A.R. provide square footages and percentages.

Site Data Table				
	Code Requirement	Existing	Proposed	Variance Request
Zoning			,1	
Flood Zone				
Size of Site				
Height	35'	54'	53,5'	18.5
Front Setback				
Side Setback				
Side Setback				
Street Side Setback				
Rear Setback				
F.A.R				
Building Coverage			-	
Impervious Surface		a a		
Parking				
Handicap Parking				
Bicycle Parking				
Open Space/ Landscaping				
Number and type of units				
Consumption Area or				
Number of seats				

This application is reviewed pursuant to Section 90-391 through 90-397 of the City of Key West Land Development Regulations (LDRs). The City's LDRs can be found in the Code of Ordinances online at <a href="http://www.municode.com/Library/FL/Key\_West">http://www.municode.com/Library/FL/Key\_West</a> under Subpart B.

<sup>\*</sup>Please note, variances are reviewed as quasi-judicial hearings, and it is improper for the owner or applicant to speak to a Planning Board member or City Commissioner about the hearing.

#### Standards for Considering Variances

Before any variance may be granted, the Planning Board and/or Board of Adjustment must find all of the following requirements are met:

- 1. Existence of special conditions or circumstances. That special conditions and circumstances exist which are peculiar to the land, structure or building involved and which are not applicable to other land, structures or buildings in the same zoning district.
  - Cellular phones are considered an essential public service. In order to meet service requirements and coverage within the area of the Casa Marina hotel a height of greater than 35' is required. Verizon has determined the height of the antenna center line to be 51' AGL with the top of the antenna at approximately 53.5' which will allow coverage in the area to meet minimum service needs.
- 2. Conditions not created by applicant. That the special conditions and circumstances do not result from the action or negligence of the applicant.
  - In order to provide adequate coverage in the selected area, a certain height must be utilized in order to receive and broadcast the cellular signals. The height of the antenna is determined by conditions in the area including adjoining buildings and the desired area to be serviced. An antenna height lower than requested would eliminate the service to the selected area.
- 3. Special privileges not conferred. That granting the variance(s) requested will not confer upon the applicant any special privileges denied by the land development regulations to other lands, buildings or structures in the same zoning district.
  - The City of Key West approved a similar variance for ATT in 2010 therefor Verizon is seeking no special privileges.
- 4. Hardship conditions exist. That literal interpretation of the provisions of the land development regulations would deprive the applicant of rights commonly enjoyed by other properties in this same zoning district under the terms of this ordinance and would work unnecessary and undue hardship on the applicant.
  Because cellular service is considered an essential public service technical requirements must be met or the service can not be provided. As noted below, the minimum height requirement to fill the gap in cellular service

in this area is 51' for the center of the antenna with an overall height not to exceed 53.5' AGL.

- 5. Only minimum variance(s) granted. That the variance(s) granted is/are the minimum variance(s) that will make possible the reasonable use of the land, building or structure.
  - Verizon is requesting the minimum height variance which is needed to provide cellular service in the immediate area of the Casa Marina Hotel. This area is a known dead zone for service and is needed to fill this gap in coverage. Verizon engineering has determined the height requested is the minimum needed.

#### City of Key West . Application for Variance

- 6. Not injurious to the public welfare. That granting of the variance(s) will be in harmony with the general intent and purpose of the land development regulations and that such variances will not be injurious to the area involved or otherwise detrimental to the public interest or welfare.
  The granting of the variance will not have a deleterious impact to the citizens of the area or the City of Key West but will in fact be beneficial to many citizens and tourist alike. The HCT Zoning District provides for public and private utilities through a conditional use approval. The City of Key West Planning Board approved the Verizon Conditional Use request on September 18<sup>th</sup> 2014. The approval of the Conditional Use Application establishes the use of proposed site by Verizon to be in harmony with the general intent and purpose of the LDRs.
- 7. Existing nonconforming uses of other property shall not be considered as the basis for approval. That no other nonconforming use of neighboring lands, structures, or buildings in the same district, and that no other permitted use of lands, structures or buildings in other districts shall be considered grounds for the issuance of a variance.

Non-conforming properties are not considered as the basis for this request.

### The Planning Board and/or Board of Adjustment shall make factual findings regarding the following:

- That the standards established in Section 90-395 have been met by the applicant for a variance.
- That the applicant has demonstrated a "good neighbor policy" by contacting or attempting to contact all noticed property owners who have objected to the variance application, and by addressing the objections expressed by these neighbors. Please describe how you have addressed the "good neighbor policy."

REQUIRED SUBMITTALS: All of the following must be submitted in order to have a complete application. Please submit one paper copy and one electronic copy of all materials.

Correct application fee. Check may be payable to "City of Key West."
Notarized verification form signed by property owner or the authorized representative
Notarized authorization form signed by property owner, if applicant is not the owner.
☑ Copy of recorded warranty deed
Property record card
☑ Signed and sealed survey
Site plan (plans MUST be signed and sealed by an Engineer or Architect)
$\square$ Floor plans $\mathcal{N}/\mathcal{A}$ $\square$ Stormwater management plan $/\mathcal{N}/\mathcal{A}$
$\square$ Stormwater management plan $/ \sim /A$



September 26, 2014

City of Key West Planning Department Donald Craig, Planning Director 3140 Flagler Avenue Key West, FL 33040

Re: Verizon Wireless Application for Height Variance Wireless Supported Services Facility
Property Location – 1500 Reynolds Street
Folio No. – 00037160-000100
Project name – 62335 – Casa Marina – Verizon

Dear Mr. Craig:

As you know, Verizon Wireless is proposing to collocate antenna and an unoccupied equipment shelter at 1500 Reynolds Street, Key West, Florida. Verizon's application for a conditional use was recently approved by the Planning Board with a condition that Verizon apply for a height variance as the proposed antenna and unoccupied shelter exceed the allowable height of 35' within the HCT, Historic Commercial District Zoning District. Attached hereto please find the City of Key West Application for Variance along with the application fee in the amount of \$1,150.

The proposed installation includes three antenna support tripods with three antenna each and an unoccupied equipment shelter on the west side of the Casa Marina Hotel. The proposed Verizon equipment will be located on the same roof section as the existing ATT installation. The current ATT equipment and shelter range in height from 53.5' AGL, (above grade level) for two of the antenna arrays and 53.0' AGL for the equipment shelter. The top of the existing Casa Marina hotel is 54' AGL with numerous appurtenances exceeding that height.

The proposed Verizon installation would include three antenna arrays at a height of approximately 53.3' AGL and the equipment shelter at 53.2' AGL. None of the antenna or the shelter would exceed the height of the existing ATT antenna. In addition all of the antenna and equipment will be painted to match the existing building with all support wires below the building parapet. The attached drawings show the specific rooftop location with the proposed antenna and proposed shelter. Pages A-2A through A-2G are photo simulations of the installation from numerous views.

This facility is necessary in order to provide greater reliability of service to the south area of Key West. The location selected is designed by Verizon's engineers to meet coverage requirements as there are no other tower facilities in the area to collocate to provide this level of service. As mentioned above, this is an unmanned communications facility and as a result, will not generate additional traffic that will degrade the level of service on any road nor place any additional demands on public services beyond the capacity of those services.

- 1. Application for Variance
- 2. Application fee in the amount of \$1,150.00
- 3. Authorization Form.
- 4. Justification Statement, this letter.
- 5. Zoning drawings pages T1-E-5, photo-sims, antenna specifications and propagation maps.
- 6. Field survey dated August 15<sup>th</sup>, 2014.

### **Summary and Conclusion**

The proposed Verizon installation will have a maximum height of 53.3' AGL (above grade level) including both the antenna arrays and the equipment shelter. The specific height requested in the Variance Application is 53.5' in order to assure uniformity in measurements from the ground and to match the survey of existing rooftop equipment. The height of the equipment will not exceed the height of the existing hotel nor will it exceed the height of the existing antenna installed by ATT. There is a lack of service for Verizon customers in the area of the proposed location as evidenced by the attached back-up materials. The proposed facility will enhance the service availability in the area and is being collocated on a structure already being utilized for such use.

Based upon the forgoing, we request your favorable consideration of this application at the November 5<sup>th</sup>, 2014 Board of Adjustment. Should you have any questions regarding this application, please contact me at 561-226-9485.

Yours truly,

Chuck Fink

SBA Network Services

Agent for Verizon Wireless

# **Authorization Form**

# City of Key West Planning Department



# Authorization Form

(Where Owner is a Business Entity)

matter.
I. Please Print Name of person with authority to execute documents on behalf of entity
MANAGING MEMBER OF CASA MARINA OWNER LLC  Name of office (President, Managing Member)  Name of owner from deed
authorize  ROBERT RUBENSTEIN  Please Print Name of Representative
to be the representative for this application and act on my/our behalf before the City of Key West
Signature of person with a thorize to exceed documents on behalf on entity owner
Subscribed and sworn to (or affilmed) before me on this  Date
Nume of person with authority to execute documents on behalf on entity owner
Me/She is personally known to me or has presented  NA as identification.  Notary 's Signature and Seal  Maria L. D. Dio
Name of Acknowledger typed, printed or stamped  MARIA L D'DIO  MY COMMISSION # EE 129524  EXPIRES: November 5, 2015  Bonded Thru Notary Public Underwriters

# City of Key West Planning Department



# **Authorization Form**

(Where Owner is a Business Entity)

Please complete this form if someone other than the owner is representing the property owner in this matter.
I, ROBERT RUBENSTEIN  Please Print Name of person with authority to execute documents on behalf of entity  as
Name of office (President, Managing Member) of CASA MARINA OWNER LLC
authorize CHARLES FINK SBA  Please Print Name of Representative
Please Print Name of Representative
to be the representative for this application and act on my/our behalf before the City of Key West.
17-1/4
Y / / ( )// ( )// ( )
Signature of person with authority to execute documents on behalf on entity owner
Subscribed and sworn to (or affirmed) before me on this 7/1/14
BERT RUBENSTEIN
Name of person with authority to execute documents on behalf on entity owner
He/She is personally known to me or has presented as identification.
Notary's Signature and Seal  A Rea L. Diblo  MARIA L. D'DIO  MY COMMISSION # EE 129524  EXPIRES: November 5, 2015  Bonded Thru Notary Public Underwriters  MARIA L. D'DIO  MY COMMISSION # EE 129524  EXPIRES: November 5, 2015  Bonded Thru Notary Public Underwriters
Name of Acknowledger typed, printed or stamped
#EE 129524  Commission Number, if any
Commission Number, if any

# **Verification Form**

# **City of Key West Planning Department**



# **Verification Form**

(Where Authorized Representative is an individual)

I, CHARLES FINE, being duly sworn, depose and say that I am the Authorized Representative of the Owner (as appears on the deed), for the following property identified as the subject matter of this application:
/500 7ZEYIVOLDS STREET  Street address of subject property
Street address of subject property
All of the answers to the above questions, drawings, plans and any other attached data which make up the application, are true and correct to the best of my knowledge and belief. In the event the City or the Planning Department relies on any representation herein which proves to be untrue or incorrect, any action or approval based on said representation shall be subject to revocation.
Signature of Authorized Representative
Subscribed and sworn to (or affirmed) before me on this 9-17-14 by  CHANGES F. FINK.  Name of Authorized Representative
He/She is personally known to me or has presented as identification.
Notary's Signature and Seal
Name of Acknowledger typed, printed or started by Expires Dec. 09, 2014  Commission Number, if any
Commission Number, if any



730 23

Record & Return to: LandAmerica - Brigitte Sawicki 1302 N. 19th Street, Suite 200 Tampa, FL 33605 File # 7-053331

This instrument prepared by:

Sung Lee, Esq. Akin Gump Strauss Hauer & Feld LLP 1700 Pacific Avenue, Suite 4100 Dallas, Texas 75201-4675 Doc# 1517059 05/18/2005 3:34PM Filed & Recorded in Official Records of MONROE COUNTY DANNY L. KOLHAGE

DEED DOC STAMP CL: JILL \$730,213.40

Doc# 1517059 Bk# 2115 Pg# 141

#### GENERAL WARRANTY DEED

STATE OF FLORIDA \$ \$ KNOW ALL MEN BY THESE PRESENTS THAT: COUNTY OF MONROE \$

THAT CASA MARINA REALTY PARTNERSHIP, L.P., a Delaware limited partnership (hereinafter called "Grantor"), whose mailing address is c/o Wyndham International, Inc., 1950 Stemmons Freeway, Suite 6001, Dallas, Texas 75207, for and in consideration of the sum of TEN AND NO/100 Dollars (\$10.00) and other good and valuable consideration in hand paid by CASA MARINA OWNER, LLC, a Delaware limited liability company (hereinafter called "Grantee"), whose mailing address is c/o Wyndham International, Inc., 1950 Stemmons Freeway, Suite 6001, Dallas, Texas 75207, the receipt and sufficiency of which are hereby acknowledged. has GRANTED, SOLD AND CONVEYED and by these presents does GRANT, SELL AND CONVEY unto Grantee that certain real property situated in Monroe County, Florida, and more particularly described on Exhibit A attached hereto and made a part hereof for all purposes (the "Land"), together with Grantor's interest in and to all rights, titles, benefits, easements, privileges, remainders, tenements, hereditaments, interests, reversions and appurtenances thereunto belonging or in any way appertaining, and all of the estate, right, title, interest, claim or demand whatsoever of Grantor therein, in and to adjacent strips and gores, if any, between the Land and abutting properties, and in and to adjacent streets, highways, roads, alleys or rights-ofway, and the beds thereof, either at law or in equity, in possession or expectancy, now or hereafter acquired (all of the above-described properties together with the Land are hereinafter collectively referred to as the "Property").

This conveyance is made and accepted subject and subordinate to (a) standby fees, taxes and assessments by any taxing authority for the current year and subsequent years, and subsequent taxes and assessments by any taxing authority for prior years due to change in land usage or ownership by Grantee, its successors or assigns, which standby fees, taxes and assessments Grantee assumes and agrees to pay, (b) zoning laws and regulations and ordinances of municipal and other governmental authorities affecting the Property, and (c) all matters listed on Exhibit B attached hereto and made a part hereof for all purposes (all of those items described in (a) through (c) above are hereinafter collectively referred to as the "Permitted Encumbrances").

#### Doc# 1517059 Bk# 2115 Pg# 142

TO HAVE AND TO HOLD the Property, together with all and singular the rights and appurtenances thereto in any wise belonging unto Grantee, Grantee's legal representatives, successors and assigns forever and subject to the Permitted Encumbrances, and Grantor does hereby bind itself, its successors and assigns, to WARRANT AND FOREVER DEFEND all and singular the Property unto Grantee, Grantee's legal representatives, successors and assigns, against every person whomsoever lawfully claiming or to claim the same or any part thereof.

### Doc# 1517059 Bk# 2115 Pg# 143

f May, 2005, to be effective for all purposes, 2005.
ANTOR:
SA MARINA REALTY PARTNERSHIP, L.P., a aware limited partnership
Casa Marina Realty Corporation, a Delaware corporation, its general partner
By:
*
thority, on this day personally appeared Gregory Moundary Corporation, a Delaware corporation, general partner RSHIP, L.P., a Delaware limited partnership, known to ribed to the foregoing instrument, and acknowledged to purposes and consideration therein expressed, in the deed of said corporation and limited partnership.
AND SEAL OF OFFICE, this the
TIFFANY KIM Notary's Printed Name
returned to:

Wyndham Resorts Casa Marina Key West, FL 012665-0348 WEST 5722675 v1

# Exhibit A to General Warranty Deed

Description of Land

Doc# 1517059 Bk# 2115 Pg# 144

#### Exhibit A

Doc# 1517059 Bk# 2115 Pg# 145 Policy Number: Proforma

Exhibit A-1:

Parcel I:

All that land in the City of Key West, Monroe County, Florida, lying and being situate within a triangle formed by Seminole Avenue, Reynolds Street and the low water mark of the shore known as South Beach, the said triangle embracing Blocks 1, 2, 3, 4, 5 and 6 and the space between them formerly laid out as streets, but heretofore vacated as streets by the City Council of the City of Key West, all shown on the Plat of the KEY WEST INVESTMENT COMPANY'S SUBDIVISION OF PART OF TRACT 17, recorded in Plat Book 1, at page 69 of the Public Records of Monroe County, Florida; and also all the land under water lying in front of and all riparian rights belonging or appurtenant to the said triangle; less, however, that portion of Block 6 which is not included in Parcel II described herein and all of the land under water lying in front of and all riparian rights belonging or appurtenant thereto.

Subject to encroachment by Reynolds Street being more particularly described by metes and bounds as follows:

Commencing at the Northeast corner of Block 4 of KEY WEST INVESTMENT COMPANY'S SUBDIVISION OF PART OF TRACT 17, Key West, Monroe County, Florida and recorded in Plat Book 1, at page 69 of the Public Records of Monroe County, Florida, said corner is also known as the Point of Beginning of the land hereinafter described:

From said Point of Beginning bear South 37°32'30" East for a distance of 706.00 feet, more or less, to the shore line of said plat; thence meander the shoreline of said plat in a Westerly direction to a point which is 10.21 feet measured at right angles to the preceeding course; thence bear North 37°32'30" West for a distance of 678.00 feet, more or less, to a point; thence continue bearing Northwesterly for a distance of 20.00 feet, more or less, to a point on the Southeasterly property line of Seminole Avenue; said point also bearing South 52°00'00" West from the Point of Beginning; thence bear North 52°00'00" East for a distance of 17.81 feet back to the Point of Beginning.

#### Parcel II:

On the Island of Key West, Monroe County, Florida and being a part of Block 6 of KEY WEST INVESTMENT COMPANY'S SUBDIVISION OF PART OF TRACT 17 as recorded in Plat Book 1, at page 69 of the Public Records of Monroe County, Florida and being more particularly described by metes and bounds as follows:

Begin at a point on the Southeasterly property line of Seminole Avenue at the intersection of the Southwesterly property line of Alberta Street extended on its course Southeasterly; thence Southwesterly along the Southeasterly property line of Seminole Avenue for a distance of 14.83 feet; thence run Southeasterly and parallel with the said Alberta Street for a distance of 67.00 feet, more or less, to the Mean High Tide Line of the Straits of Florida; thence run Easterly along the said Mean High Tide Line for a distance of 18.00 feet, more or less to the Easterly boundary of said Block 6; thence run Northwesterly along the Easterly boundary of said Block 6 for a distance of 78.00 feet, more or less, back to the Point of Beginning; together with all the land under water lying in front of and all riparian rights belonging or appurtenant thereto.

#### Parcel III:

A concrete dock or pier situated on the following described property:

A parcel of submerged land lying in the Straits of Florida adjacent to Block 6 of the KEY WEST INVESTMENT COMPANY'S SUBDIVISION OF PART OF TRACT 17 as recorded in Plat Book 1, at page 69 of

the Public Records of Monroe County, Florida and being more particularly described by metes and bounds as follows:

Commencing at a point on the Southeasterly property line of said Seminole Avenue at the intersection of the Southwesterly property line of Alberta Street extended on its course Southeasterly; thence run Southeasterly along the Easterly boundary of said Block 6 for a distance of 78.00 feet, more or less, to the Mean High Water Line of the Straits of Florida and the Point of Beginning of the parcel of land herein being described: Thence continue Southeasterly along the extension of the Easterly boundary of said Block 6 for a distance of 106.00 feet; thence run Southerly along a line deflected 41°09'30" to the right for a distance of 270.00 feet; thence at right angles in a Westerly direction for a distance of 25.00 feet; thence at right deflected 41°09'30" to the left for a distance of 262.00 feet; thence run Northwesterly along a line deflected 41°09'30" to the left for a distance of 115.00 feet, more or less, to the Mean High Tide Line of the Straits of Florida; thence run Easterly along the said Mean High Tide Line a distance of 28.00 feet, more or less, back to the Point of Beginning.

#### Parcel IV:

On the island of Key West, Florida being Lots 1 through 16, inclusive, all being in Block Seven (7) as shown on the plat of the Key West Investment Company's Subdivision of part of Tract Seventeen (17), recorded in Plat Book Number 1, page 69, of the Public Records of Monroe County, Florida.

Doc# 1517059 Bk# 2115 Pg# 146

# Exhibit B to General Warranty Deed

### Permitted Encumbrances

All matters of record affecting the Property which are valid and subsisting.

MONROE COUNTY OFFICIAL RECORDS

# FLORIDA DEPARTMENT OF STATE DIVISION OF CORPORATIONS



# **Detail by Entity Name**

### Foreign Limited Liability Company

CASA MARINA OWNER, LLC

#### **Filing Information**

**Document Number** 

M05000002214

**FEI/EIN Number** 

N/A

**Date Filed** 

04/28/2005

State

DE

**Status** 

ACTIVE

Last Event

LC AMENDMENT

**Event Date Filed** 

01/28/2013

**Event Effective Date** 

NONE

#### **Principal Address**

501 E. CAMINO REAL BOCA RATON, FL 33432

Changed: 04/13/2012

#### **Mailing Address**

501 E. CAMINO REAL BOCA RATON, FL 33432

Changed: 04/13/2012

#### Registered Agent Name & Address

CORPORATION SERVICE COMPANY 1201 HAYS STREET TALLAHASSEE, FL 32301-2525

#### Authorized Person(s) Detail

#### Name & Address

Title MGR

BEOVICH, ANTHONY 501 EAST CAMINO REAL BOCA RATON, FL 33432

Title MGR

GRAY, JONATHAN D

501 EAST CAMINO REAL BOCA RATON, FL 33432

Title MGR

SUMERS, GARY M 501 E. CAMINO REAL BOCA RATON, FL 33432

Title MGR

STEIN, WILLIAM J 501 E. CAMINO REAL BOCA RATON, FL 33432



Title MGR

MCDONAGH, DENNIS 501 E. CAMINO REAL BOCA RATON, FL 33432

Title MGR

CAPLAN, KENNETH A 501 E. CAMINO REAL BOCA RATON, FL 33432

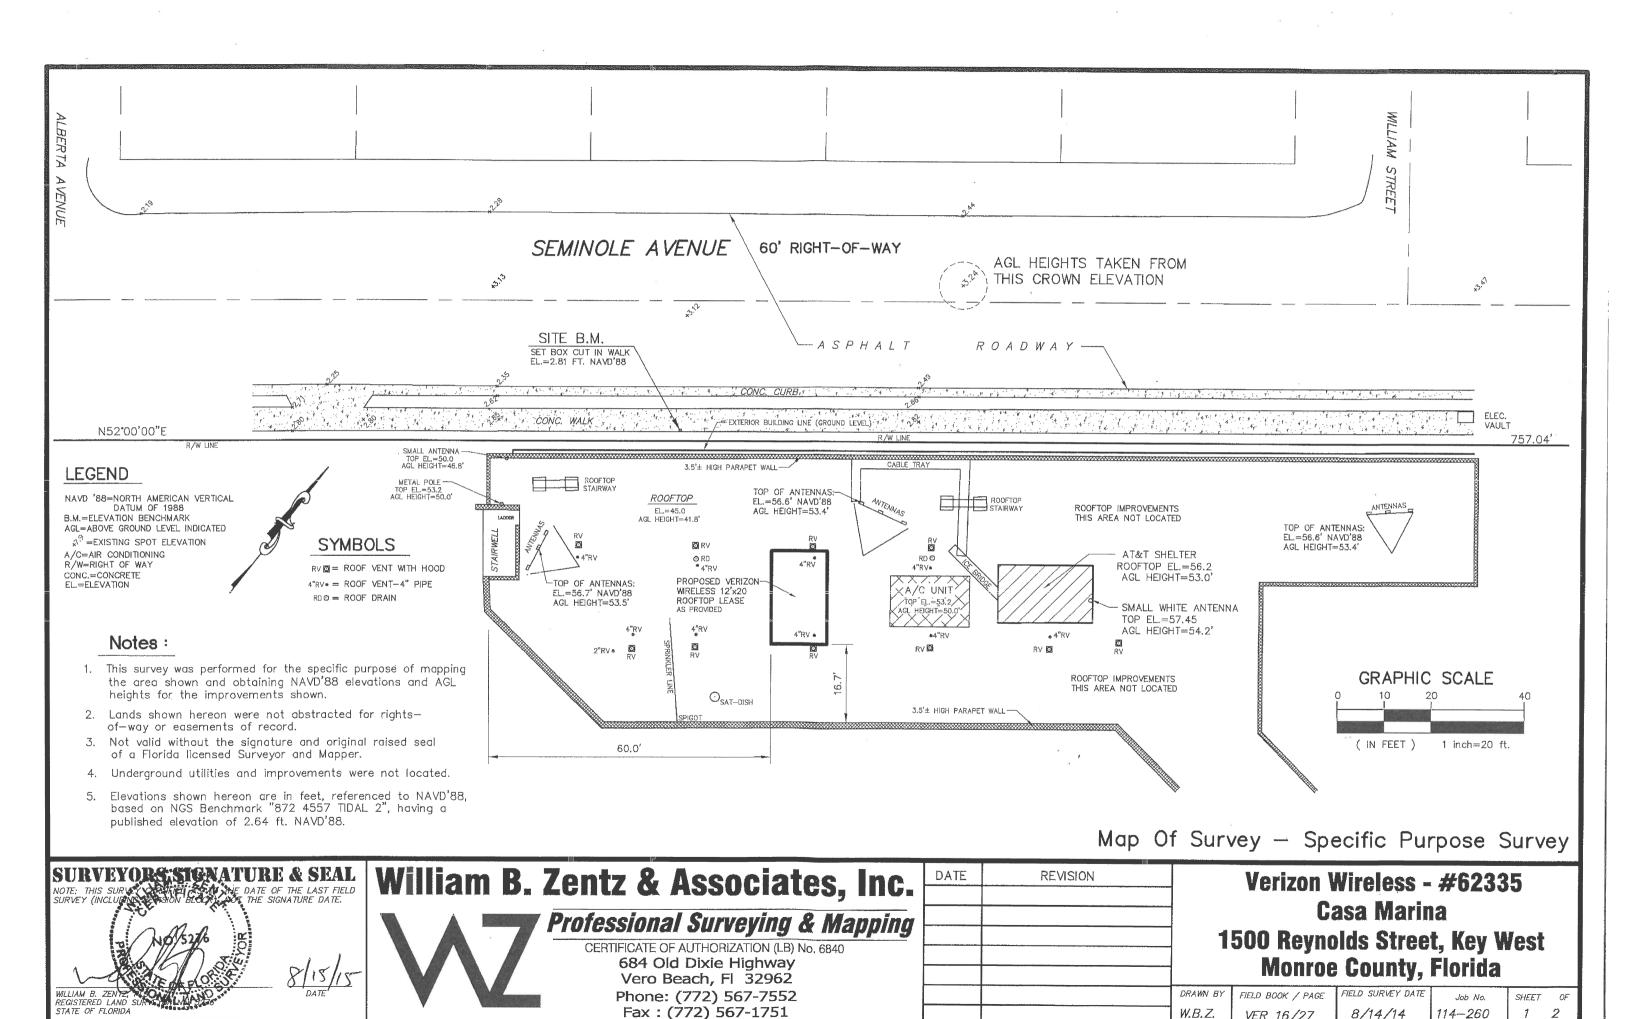
### **Annual Reports**

Report Year	Filed Date
2012	04/13/2012
2013	04/02/2013
2014	04/18/2014

#### **Document Images**


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04/02/2013 ANNUAL REPORT	View image in PDF format
01/28/2013 LC Amendment	View image in PDF format
04/13/2012 ANNUAL REPORT	View image in PDF format
04/13/2011 ANNUAL REPORT	View image in PDF format
03/18/2010 ANNUAL REPORT	View image in PDF format
03/20/2009 ANNUAL REPORT	View image in PDF format
04/28/2008 ANNUAL REPORT	View image in PDF format ⊸
04/30/2007 ANNUAL REPORT	View image in PDF format
10/03/2006 REINSTATEMENT	View image in PDF format
08/14/2006 LC Amendment	View image in PDF format
04/28/2005 Foreign Limited	View image in PDF format






8/14/14

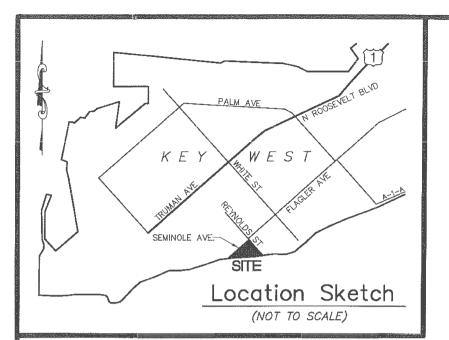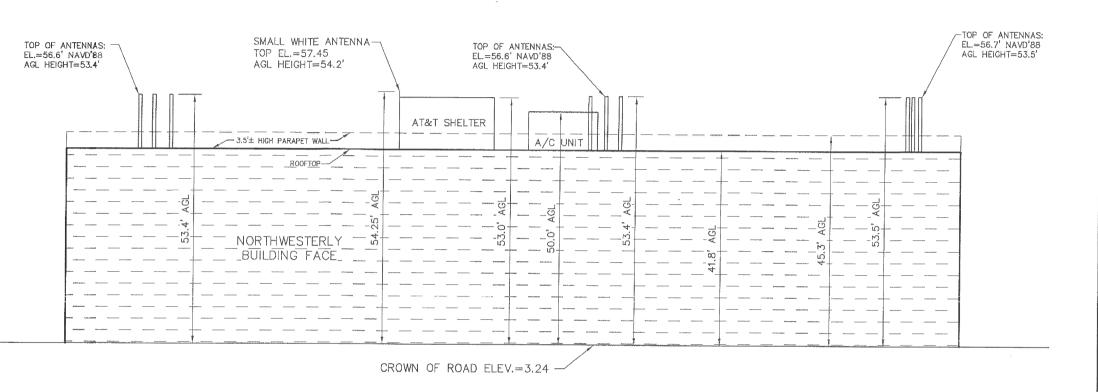VER 16/27





# **Profile View - Looking Southeasterly from Seminole Avenue**

SCALE: VERTICAL: 1"=20' HORIZONTAL: NTS

Map Of Survey - Specific Purpose Survey

# William B. Zentz & Associates, Inc. **Professional Surveying & Mapping**

CERTIFICATE OF AUTHORIZATION (LB) No. 6840 684 Old Dixie Highway Vero Beach, Fl 32962

Phone: (772) 567-7552 Fax: (772) 567-1751

DAIL	REVISION	
		DRAWN

Verizon Wireless - #62335 Casa Marina 1500 Reynolds Street, Key West **Monroe County, Florida** 

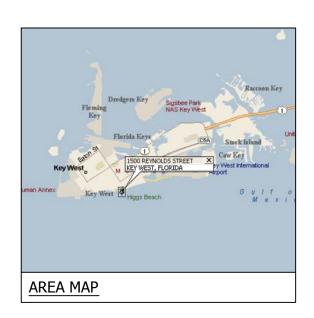
N BY FIELD BOOK / PAGE FIELD SURVEY DATE W.B.Z. 114-260 VER 16/27 8/14/14

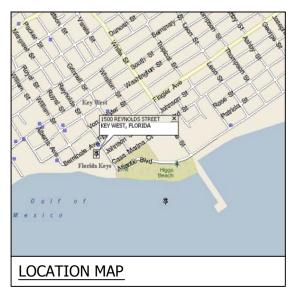




# CASA MARINA VERIZON SITE #62335

NEW PROJECT FOR WIRELESS COMMUNICATIONS SERVICE 1500 REYNOLDS STREET, KEY WEST, FLORIDA 33040





SITE NAME: SITE NUMBER:	CASA MARINA 62335
SITE ADDRESS:	1500 REYNOLDS STREET KEY WEST, FL 33040
APPLICANT: NAME: ADDRESS:	VERIZON WIRELESS 777 YAMATO ROAD, SUITE 600 BOCA RATON, FLORIDA 33431
LATITUDE: LONGITUDE:	24° 32' 50.41" -81° 47' 29.13"
SITE INFORMATION	

SHEET	DESCRIPTION	REV.
T-1	TITLE SHEET 0	
G-1	GENERAL NOTES	}0
A-1	ROOF PLAN	$\left \left\langle \begin{array}{c} 1 \end{array}\right\rangle \right $
A-2	BUILDING ELEVATIONS	0(
A-2A	NORTHWEST BUILDING ELEVATIONS	0
A-2B	SOUTHEAST BUILDING ELEVATIONS	0
A-2C	ADJACENT PROPERTIES EXHIBIT	0
A-3	RF PLAN	0
A-4	CONSTRUCTION DETAILS	0
S-1	STRUCTURAL PLATFORM PLAN AND SECTION	0
S-2	SHELTER SECTIONS AND DETAILS	0
S-3	STRUCTURAL DETAILS	0
S-4	ANTENNA FRAME PLAN AND SECTIONS	0
S-5	ANTENNA DETAILS	0
E-1	ELECTRICAL AND GROUNDING NOTES	0
E-2	ELECTRICAL SITE PLAN	0
E-3	ELECTRICAL AND TELCO RISER DIAGRAM	0
E-4	ELECTRICAL DETAILS	0
E-5	ELECTRICAL DETAILS	0

## SHEET INDEX

INSTALLATION OF NEW WIRELESS EQUIPMENT AND ANTENNAS FOR ENHANCED WIRELESS COMMUNICATIONS SERVICE

PROJECT SUMMARY

#### APPLICANT/OWNER:



777 YAMATO ROAD, SUITE 600 BOCA RATON, FLORIDA 33431

#### **PROJECT NAME AND LOCATION:**

CASA MARINA VERIZON SITE #62335 1500 REYNOLDS STREET KEY WEST, FL 33040

#### **PROJECT ENGINEER**



# WAYPOINT

ENGINEERING AND EQUIPMENT LLC 820 W. INDIANTOWN ROAD, SUITE 105 JUPITER, FLORIDA 33458 PHONE: 561-252-1220 FLORIDA CA#29673

#### **ENGINEER SEAL**

RUSSELL C. MORRISON, P.E. FLORIDA P.E. #51567

# DATE OF ISSUE

AUGUST 15, 2014

#### **ISSUED FOR**

CONSTRUCTION PLANS

#### SUBMITTALS

REV DATE DESCRIPTION

nLv.	DAIL	DESCRIPTION
$\bigcirc$	9-25-14	ANTENNAS MOVED 1' TO S.E.

### PROJECT NUMBER

L201403-09

## DRAWN BY CHECKED APPROVED

Noivi Noivi

#### APPROVING AGENCY

CITY OF KEY WEST, FLORIDA

#### BUILDING CODE

2010 FLORIDA BUILDING CODE

#### SHEET TITLE

COVER SHEET

#### SHEET NUMBER

T-1

#### STANDARD PROVISIONS

- 1. CONSTRUCTION PLANS AND SPECIFICATIONS DESCRIBE THE WORK TO BE PERFORMED AND THE MATERIALS REQUIRED FOR THE PROPER CONSTRUCTION OF THE PROJECT.
- 2. CONSTRUCTION PLANS AND SPECIFICATIONS ARE INTENDED TO BE FULLY EXPLANATORY AND COMPLEMENTARY. THOUGH, SHOULD ANY MATERIAL OR SPECIFICATION BE SHOWN, INDICATED OR SPECIFIED ON ONE SHEET AND NOT ANOTHER, IT SHALL BE THE SAME AS IF SHOWN, INDICATED OR SPECIFIED ON
- 3. THE INTENTION OF THE CONSTRUCTION DOCUMENTS IS TO INCLUDE ALL LABOR AND MATERIALS REASONABLY NECESSARY FOR THE COMPLETION OF THE WORK. 4. THE PURPOSE OF ANY SPECIFICATIONS IS TO SUPPLEMENT THE INTENT OF THE
- CONSTRUCTION PLANS AND TO DESIGNATE A PROCEDURE, TYPE OR QUALITY OF MATERIALS REQUIRED TO COMPLETE THE WORK.
- MINOR DEVIATIONS FROM THE DESIGN LAYOUT MAY OCCUR AND SHALL BE CONSIDERED AS PART OF THE WORK. HOWEVER, NO CHANGES THAT ALTER THE INTENT OF THE DESIGN OF THE PROJECT WILL BE MADE OR PERMITTED WITHOUT PERMISSION OF THE OWNER AND ENGINEER.

- 1. THE CONTRACTOR AND SUBCONTRACTORS SHALL BE RESPONSIBLE FOR VISITING THE PROJECT SITE PRIOR TO CONSTRUCTION AND VERIFICATION OF ALL MEASUREMENTS ON THE CONSTRUCTION PLANS BEFORE ORDERING ANY MATERIAL OR PERFORMING ANY WORK. NO EXTRA COMPENSATION SHALL BE ALLOWED DUE TO DISCREPANCIES BETWEEN THE ACTUAL DIMENSIONS IN THE FIELD AND THE DIMENSIONS INDICATED ON THE CONSTRUCTION PLANS. ANY DISCREPANCY IN DIMENSION WHICH MAY INADVERTENTLY OCCUR SHALL BE SUBMITTED TO THE OWNER AND ENGINEER FOR CONSIDERATION BEFORE THE CONTRACTOR PROCEEDS WITH THE WORK IN THE AFFECTED AREA.

  2. THE CONTRACTOR, WHEN AWARDED THE CONTRACT, WILL NOT BE ALLOWED ANY
- EXTRA COMPENSATION BY REASON OF ANY MATTER WHICH THE CONTRACTOR DID NOT REQUEST ADDITIONAL INFORMATION ON PRIOR TO THE BID.

  3. NO PLEA OF IGNORANCE OF CONDITIONS THAT EXIST, OR OF DIFFICULTIES
- ENCOUNTERED OR ANY OTHER RELEVANT MATTER CONCERNING THE WORK TO BE PERFORMED WILL BE ACCEPTED AS A REASON FOR ANY FAILURE OR OMISSION ON THE PART OF THE CONTRACTOR TO FULFILL THE OBLIGATIONS OF THE CONSTRUCTION CONTRACT

- PROTECTION OF WORK AREA

  1. CONTRACTOR TO PROTECT THE WORK AREA, WHETHER INDOORS OR OUTDOORS. MAINTAIN FINISHED SURFACES CLEAN AND SUITABLY PROTECTED UNTIL CONSTRUCTION IS COMPLETE AND ACCEPTED BY THE OWNER OR OWNER'S
- 2. PROTECT FINISHED SURFACES, INCLUDING JAMBS AND HEADS OF OPENINGS USED AS PASSAGEWAYS THROUGH WHICH EQUIPMENT AND MATERIALS MUST
- 3. PROVIDE PROTECTION OF EQUIPMENT ROOM SURFACES PRIOR TO CONSTRUCTION ACTIVITIES IN THESE AREAS.

REPAIRS AND REPLACEMENT OF DAMAGED ITEMS

1. IN THE EVENT OF DAMAGE TO EXISTING FACILITIES, THE CONTRACTOR SHALL PROMPTLY MAKE ALL REPLACEMENTS AND REPAIRS AT NO ADDITIONAL COST TO

- STORAGE OF MATERIALS AND TOOLS

  1. CONTRACTOR IS NOT TO UTILIZE THE EXISTING BUILDING SPACE FOR STORAGE
- OF MATERIALS OR TOOLS WITHOUT THE APPROVAL OF THE PROPERTY OWNER

  2. ALL MATERIALS MUST BE STORED IN A LEVEL AND DRY LOCATION AND IN A MANNER NOT TO OBSTRUCT THE FLOW OF OTHER WORK. ALL EQUIPMENT OR MATERIAL STORAGE MUST ALSO MEET THE SPECIFICATIONS OF THE

TEMPORARY FACILITIES

1. CONTRACTOR IS RESPONSIBLE FOR COORDINATING WITH LOCAL UTILITIES TO PROVIDE TEMPORARY ELECTRIC AND TELEPHONE SERVICE AS NECESSARY TO COMPLETE THE PROJECT. THE CONTRACTOR MAY USE EXISTING ELECTRIC AND TELEPHONE FACILITIES ONLY WITH OWNER APPROVAL. ANY TEMPORARY POWER CORDS MUST BE STORED DURING NON WORKING HOURS.

- 1. CONTRACTOR SHALL KEEP THE SITE CLEAR OF DEBRIS AND TRASH DUE TO CONSTRUCTION ACTIVITIES. AT THE COMPLETION OF THE PROJECT, CONTRACTOR TO REMOVE ALL TOOLS SCAFFOLDING AND SURPLUS MATERIALS AND SHALL LEAVE THE WORK AREA CLEAN AND READY FOR USE BY THE OWNER.
- 2. CONTRACTOR TO VISUALLY INSPECT ALL EXTERIOR SURFACES AND REMOVE SOIL, WASTE MATERIALS, AND OTHER FOREIGN MATTER. REMOVE ALL SPLASHED MATERIALS FROM ALL FINISHED AND OTHER SURFACES.
- 3. CONTRACTOR TO VISUALLY INSPECT ALL INTERIOR SURFACES AND REMOVE WASTE MATERIALS, FOREIGN MATTER, PAINT DROPPINGS, SPOTS, STAINS, AND SOIL FROM

- 1. CONTRACTOR TO SUBMIT SHOP DRAWINGS AND SPECIFICATIONS AS REQUIRED TO THE OWNER AND/OR ENGINEER FOR APPROVAL.
- ALL SHOP DRAWINGS TO BE REVIEWED, CHECKED, AND CORRECTED BY THE GENERAL CONTRACTOR PRIOR TO SUBMITTAL TO THE OWNER OR CONSTRUCTION

#### PRODUCTS AND SUBSTITUTIONS

SUBMIT 3 COPIES OF EACH REQUEST FOR SUBSTITUTION. IN EACH REQUEST IDENTIFY THE PRODUCT FABRICATION OR INSTALLATION METHOD TO BE REPLACED. BY THE SUBSTITUTION. INCLUDE RELATED SPECIFICATION SECTION AND DRAWING NUMBERS, AND COMPLETE DOCUMENTATION SHOWING COMPLIANCE WITH THE REQUIREMENTS FOR SUBSTITUTIONS.

#### **COMPLIANCE**

- 1. ALL MATERIALS, DESIGN, AND WORKMANSHIP SHALL BE IN ACCORDANCE WITH ALL APPLICABLE LOCAL, STATE, AND FEDERAL CODES, ORDINANCES, AND AUTHORITIES HAVING JURISDICTION OVER THE WORK. UPON COMPLETION OF THE WORK, THE CONTRACTOR SHALL PROVIDE THE OWNER WITH A CERTIFICATE OF OCCUPANCY (IF REQUIRED BY THE LOCAL GOVERNING JURISDICTION) AND OTHER LEGAL DOCUMENTS TO VERIFY SUCH COMPLIANCE. WHERE NO CODES EXIST, THE WORK SHALL CONFORM WITH THE 2010 FLORIDA BUILDING CODE WITH LATEST SUPPLEMENTS OR THE CONSTRUCTION PLAN SPECIFICATIONS, WHICHEVER IS MOST STRINGENT AND A DOCUMENT STATEMENT SHALL BE FURNISHED TO THAT EFFECT.
- 2. IT IS THE CONTRACTOR'S RESPONSIBILITY TO VERIEY COMPLIANCE WITH GOVERNING CODES AND TO NOTIFY THE OWNER IF ANY DISCREPANCIES PRIOR TO PERFORMING
- 3. REFERENCE TO ANY STANDARD CODE OR PRACTICE IN THIS SPECIFICATION SHALL BE DEEMED TO REFLECT THE MOST CURRENT EDITION AT THE TIME OF AWARD OF THE CONTRACT. IN ADDITION, LOCAL AMENDMENTS TO STANDARD CODES WILL APPLY. THE CONTRACTOR SHALL COMPLY WITH ALL ZONING AND SITE ACQUISITION STIPULATIONS AS OUTLINED IN ANY ZONING APPROVAL OF THE
- 4. THE FOLLOWING CODES ARE THE MINIMUM THAT WILL BE REQUIRED FOR THE CONTRACTOR TO ADHERE TO THE LATEST EDITIONS OF THE:
  - -2010 FLORIDA BUILDING CODE

  - -BUILDING OFFICIALS AND CODE ADMINISTRATORS (BOCA)
  - -NATIONAL ELECTRIC CODE (NEC) -ANSI/TIA/FIA-222-REVISION G
  - -LIFE SAFETY CODE NFPA-LATEST EDITION
  - -FEDERAL AVIATION REGULATIONS—LATEST EDITION
  - -UNDERWRITERS LABORATORIES

COORDINATION WITH LOCAL PUBLIC UTILITIES

1. THE CONTRACTOR WILL COORDINATE WITH LOCAL UTILITIES FOR THE ELECTRIC AND TELEPHONE REQUIREMENTS OF THE SITE. THE CONTRACTOR WILL ALSO COORDINATE WITH ALL OTHER RELEVANT UTILITIES INCLUDING WATER, SEWER, STORMWATER, CABLE TELEVISION, AND ANY OTHERS TO PROTECT ANY OF THESE UTILITIES ON THE PROJECT SITE DURING THE COURSE OF CONSTRUCTION.

1. CONTRACTOR SHALL HAVE EVIDENCE OF ALL REQUIRED PERMITS AND LICENSES AVAILABLE ON SITE AS REQUIRED FOR LOCAL INSPECTION AUTHORITIES

THE CONTRACTOR SHALL NOTIFY THE OWNER AT LEAST 24 HOURS IN ADVANCE
OF ALL REQUIRED INSPECTIONS. THE CONTRACTOR SHALL BE RESPONSIBLE TO
ENSURE THAT REQUIRED INSPECTIONS BY PERMITTING AUTHORITIES ARE CARRIED OUT IN A TIMELY MANNER SO AS NOT TO DELAY THE PROJECT CONSTRUCTION. THE CONTRACTOR SHALL PROVIDE DOCUMENTATION OF ALL INSPECTIONS. THE CONTRACTOR IS RESPONSIBLE FOR COORDINATING WITH THE OWNER'S TESTING LABORATORY OR ENGINEERING FIRM TO OBTAIN ALL REQUIRED INSPECTIONS AND TESTING. THE CONTRACTOR IS TO PROVIDE RESULTS OF ALL TESTING TO THE OWNER.

1. THE CONTRACTOR IS RESPONSIBLE FOR ALL SAFETY INCLUDING BY NOT LIMITED TO PROTECTION OF ALL SITE PERSONNEL AND THE GENERAL PUBLIC DURING THE ENTIRE CONSTRUCTION PERIOD. THE CONTRACTOR SHALL TAKE ALL REASONABLE PRECAUTIONS TO INSTALL AND MAINTAIN ALL SAFETY DEVICES, INCLUDING, BUT NOT LIMITED TO, BARRICADES, LAMPS, SIGNS, BARRIERS, WARNING TAPES, AND OTHER ITEMS IN ACCORDANCE WITH OSHA SAFETY ACT AND ANSI OCCUPATIONAL GUIDELINES.

- ENVIRONMENTAL PROTECTION

  1. NOISE LEVEL: THE CONTRACTOR SHALL ENSURE THAT ALL STATE AND LOCAL REGULATIONS REGARDING ACCEPTABLE NOISE LEVELS ARE ADHERED TO DURING THE COURSE OF CONSTRUCTION ACTIVITIES.
- 2. DUST CONTROL: THE CONTRACTOR SHALL IMPLEMENT NECESSARY DUST CONTROL MEASURES TO LIMIT THE RELEASE OF FUGITIVE DUST DURING THE COURSE OF CONSTRUCTION ACTIVITIES.

. EACH CONTRACTOR AND SUB-CONTRACTOR SHALL AT HIS OWN EXPENSE CARRY AND MAINTAIN FOR THE DURATION OF THE PROJECT ALL INSURANCE AND BONDS AS REQUIRED AND SHALL NOT COMMENCE WITH HIS WORK UNTIL HE HAS PRESENTED ALL CERTIFICATES OF INSURANCE TO THE OWNER

 ANY EXISTING FACILITIES DAMAGED DURING THE COURSE OF CONSTRUCTION
 ACTIVITIES SHALL BE REPAIRED TO A CONDITION EQUAL TO OR BETTER THAN THE CONDITION PRIOR TO THE DAMAGE OF THE FACILITIES.

S-BUILL DRAWINGS
THE CONTRACTOR SHALL PREPARE A RED LINED SET OF AS-BUILT DRAWINGS IN
THE FORM OF MARKED UP CONSTRUCTION PLANS THAT SHALL BE PROVIDED TO THE OWNER. AS-BUILT PLANS WILL BE PROVIDED TO THE OWNER WITHIN 2 WEEKS OF PRACTICAL COMPLETION OF THE PROJECT.

## APPLICANT/OWNER:



777 YAMATO ROAD, SUITE 600 **BOCA RATON, FLORIDA 33431** 

#### PROJECT NAME AND LOCATION:

**CASA MARINA VERIZON SITE #62335 1500 REYNOLDS STREET KEY WEST. FL 33040** 

#### **PROJECT ENGINEER**



ENGINEERING AND EQUIPMENT LLC 820 W. INDIANTOWN ROAD, SUITE 105 JUPITER, FLORIDA 33458 PHONE: 561-252-1220 FLORIDA CA#29673

### **ENGINEER SEAL**

RUSSELL C. MORRISON, P.E. FLORIDA P.E. #51567

# DATE OF ISSUE

JUNE 5, 2014

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CONSTRUCTION PLANS

SUBMITTALS			
REV.	DATE	DESCRIPTION	

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L201403-09

DRAWN BY CHECKED APPROVED KJM RCM

#### **APPROVING AGENCY** CITY OF KEY WEST, FLORIDA

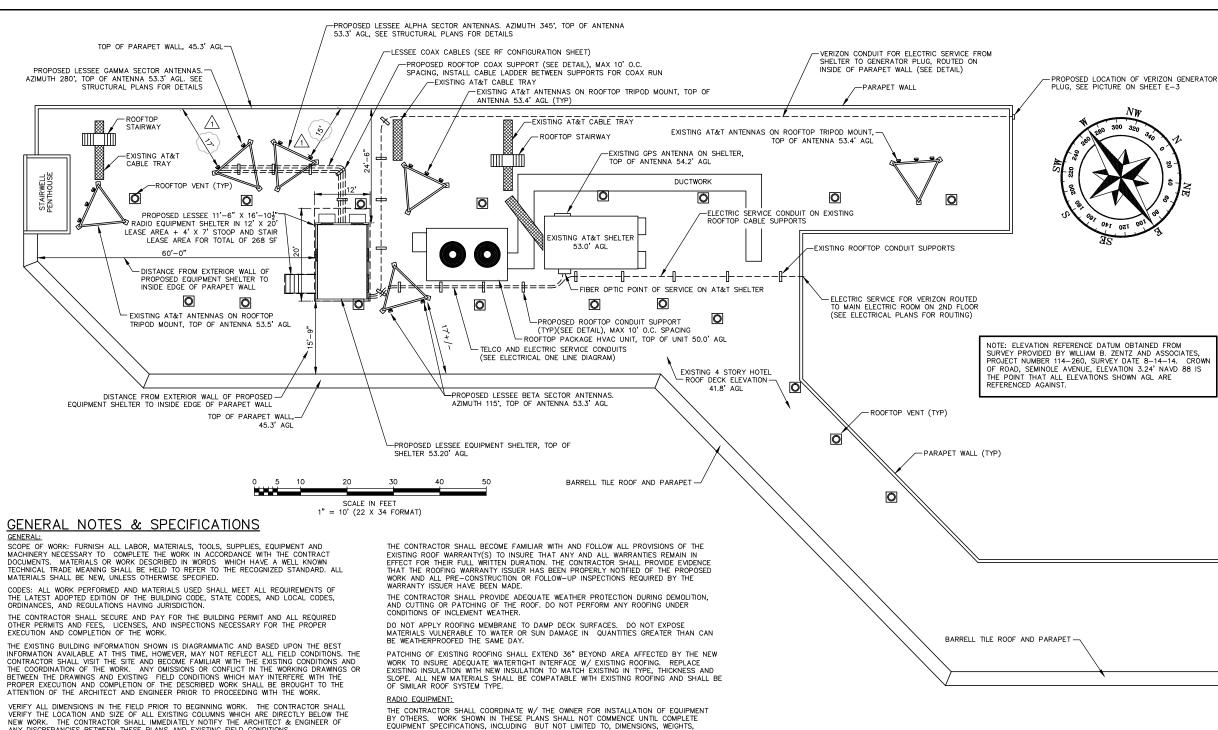
### **BUILDING CODE**

2010 FLORIDA BUILDING CODE

#### SHEET TITLE

**GENERAL NOTES** 

#### SHEET NUMBER



VERIFY THE LOCATION AND SIZE OF ALL EXISTING COLUMNS WHICH ARE DIRECTLY BELOW THE NEW WORK. THE CONTRACTOR SHALL IMMEDIATELY NOTIFY THE ARCHITECT & ENGINEER OF ANY DISCREPANCIES BETWEEN THESE PLANS AND EXISTING FIELD CONDITIONS.

CUTING & PATCHING: WHERE EXISTING ELEMENTS OF THE BUILDING ARE REQUIRED TO BE CUT, FIT, ALTERED OR REMOVED IN THE PROPER EXECUTION OF THIS WORK, THE CONTRACTOR SHALL TAKE ALL NECESSARY PRECAUTIONS TO PREVENT DAMAGE TO OTHER PORTIONS OF THE EXISTING BUILDING INCLUDING BUT NOT LIMITED TO THE SHORING, BRACING AND SUPPORT REQUIRED TO MAINTAIN STRUCTURAL INTEGRITY OF THE EXISTING BUILDING. UPON COMPLETION OF THE WORK, ALL EXISTING MATCHERIALS, SYSTEMS AND ASSEMBLIES SHALL BE REPLACED, REPAIRED, OR REFIT TO MATCH OR EXCEED THE FIT, FINISH AND PERFORMANCE OF PREVIOUS CONDITIONS. DO NOT PROCEED WITH WORK UNTIL UNSATISFACTORY CONDITIONS WHICH AFFECT SAFETY, STRUCTURAL INTEGRITY OR WATERTIGHTNESS OF BUILDING ARE CORRECTED. SEE RELATED SECTIONS "PENETRATIONS THRU FIRE RATED ASSEMBLIES" AND "ROOFING"

#### PENETRATIONS THRU FIRE RATED ASSEMBLIES:

ALL PENETRATIONS THROUGH EXISTING FLOORS, WALLS AND ROOF SLABS FOR ELECTRICAL CONDUITS, PIPES, ETC. REQUIRED AS PART OF THIS WORK SHALL BE PATCHED WITH U.L. APPROVED FIRE STOPPING CAULKING AS MANUFACTURED BY 3M OR APPROVED EQUIVALENT. SEE TYPICAL PENETRATION FIRESTOPPING DETAILS SHOWN IN PLANS. THE CONTRACTOR SHALL SUBMIT IDENTIFIED PRODUCT DATA INCLUDING MATERIAL SPECIFICATIONS AND U.L. CLASSIFIED FIRE TEST DATA FOR ANY DEVIATIONS FROM THE STANDARD DETAILS SHOWN IN THESE PLANS.

ALL WORK RELATED TO CUTTING AND PATCHING OF EXISTING ROOFING WHICH ARE REQUIRED FOR THE PROPER PERFORMANCE OF THE WORK SHALL BE PERFORMED BY A LICENSED ROOFING CONTRACTOR APPROVED AS A "CERTIFIED APPLICATOR" BY THE ISSUER OF THE EXISTING ROOFING WARRANTY(S). ALL ROOFING SHALL BE PERFORMED IN ACCORDANCE WITH THE LATEST EDITION OF THE NRCA ROOFING AND WATERPROOFING MANUAL. THE CONTRACTOR SHALL COORDINATE W/ THE OWNER FOR INSTALLATION OF EQUIPMENT BY OTHERS. WORK SHOWN IN THESE PLANS SHALL NOT COMMENCE UNTIL COMPLETE EQUIPMENT SPECIFICATIONS, INCLUDING BUT NOT LIMITED TO, DIMENSIONS, WEIGHTS, MOUNTING DETAILS, SERVICE CONNECTIONS, CLEARANCES, ETC. ARE SUBMITTED TO AND APPROVED BY THE ARCHITECT & ENGINEER.

#### ANTENNA CABLES:

COAXIAL ANTENNA CABLES SHALL BE INSTALLED PER THE VERIZON ISSUED LATEST RF

#### EXTERIOR PAINTING:

PAINTING SHALL INCLUDE ALL ANTENNAS, SUPPORTS, CABLES, FITTINGS, ETC. WHICH EXTEND ABOVE THE LINE OF EXISTING PARAPETS. PAINT ALL VISIBLE SURFACES OF ITEMS REQUIRED TO BE PAINTED. ALL PRODUCTS SHALL BE MANUFACTURED BY "SHERWN WILLIAMS" OR APPROVED EQUIVALENT.

GALVANIZED METAL: 1 COAT OIL ALKYD PRIMER FOR GALVANIZED METAL "SW GALVITE B50W3" 2 COATS GLOSS ALKYD INDUSTRIAL ENAMEL "SW INDUSTRIAL ENAMEL B54W101" FIBERGLASS ANTENNAS: 2 COATS "SW DTM EXTERIOR LATEX ENAMEL" PAINT MUST BE

#### EXISTING POST TENSIONED SLABS:

PRIOR TO DRILLING, SAWING, OR CUTTING THE CONTRACTOR SHALL VERIFY THE EXISTENCE AND LOCATION OF ANY SLAB POST TENSIONING DUCTS AND TENDONS. THE CONTRACTOR SHALL PROVIDE AS PART OF HIS WORK, ALL FIELD TESTING AND INVESTIGATION REQUIRED FOR PROPERLY LOCATING EXISTING POST TENSIONING DUCTS & TENDONS. ALL TESTING AND INVESTIGATION SHALL BE PERFORMED BY AN APPROVED & LICENSED INDEPENDENT TESTING LABORATORY. THE LOCATION OF ALL CORE DRILLING, ANCHORING, SHALL BE SHIFTED AS REQUIRED TO AVOID EXISTING POST TENSION DUCTS.

ROOF MATERIALS ARE PRESUMED ASSESTOS CONTAINING MATERIALS (PACM) ROOF MATERIALS ARE PRESUMED ASBESTOS CONTAINING MATERIALS (PACM) UNDER OSHA REGULATION 29 CFR 1926-1101 AND AS OUTLINED IN THE STATE OF FLORIDA BUILDING ASBESTOS SURVEY PROCEDURES MANUAL DEVELOPED UNDER FLORIDA STATUTE 255.551-255.565. CONTRACTOR SHALL COMPLY WITH ALL CURRENT OPERATIONAL AND ENGINEERING CONTROLS FOR DEALING WITH ASBESTOS CONTAINING MATERIALS AS DEFINED BY NESHAP & OSHA INCLUDING

UT NOT LIMITED TO WORKER/SITE PERSONNEL TRAINING & PROTECTION.

# NORTH 🖊





777 YAMATO ROAD. SUITE 600 **BOCA RATON, FLORIDA 33431** 

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**CASA MARINA VERIZON SITE #62335 1500 REYNOLDS STREET KEY WEST. FL 33040** 

#### **PROJECT ENGINEER**



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K.IM

# APPROVING AGENCY

CITY OF KEY WEST, FLORIDA

### **BUILDING CODE**

2010 FLORIDA BUILDING CODE

#### SHEET TITLE

**ROOF AND PENTHOUSE** PLAN

#### **SHEET NUMBER**

A-1



NORTHWEST BUILDING ELEVATION



SOUTHEAST BUILDING ELEVATION



NORTHEAST BUILDING ELEVATION

#### APPLICANT/OWNER:



777 YAMATO ROAD, SUITE 600 BOCA RATON, FLORIDA 33431

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RCM

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CITY OF KEY WEST, FLORIDA

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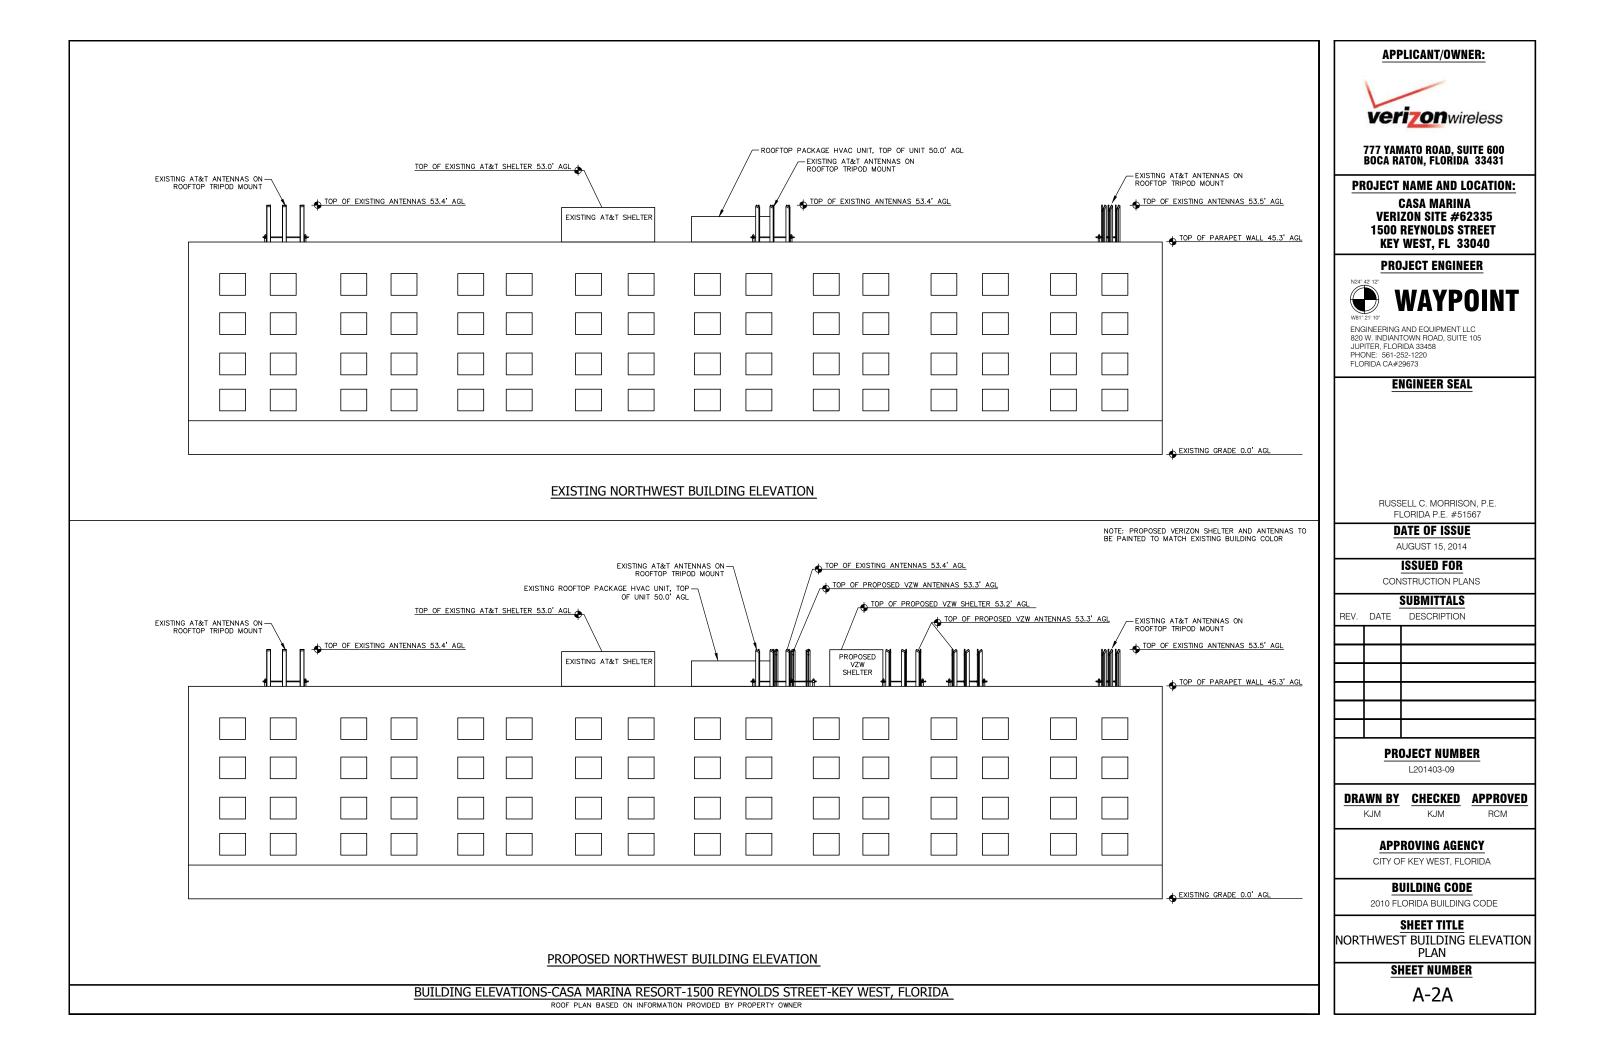
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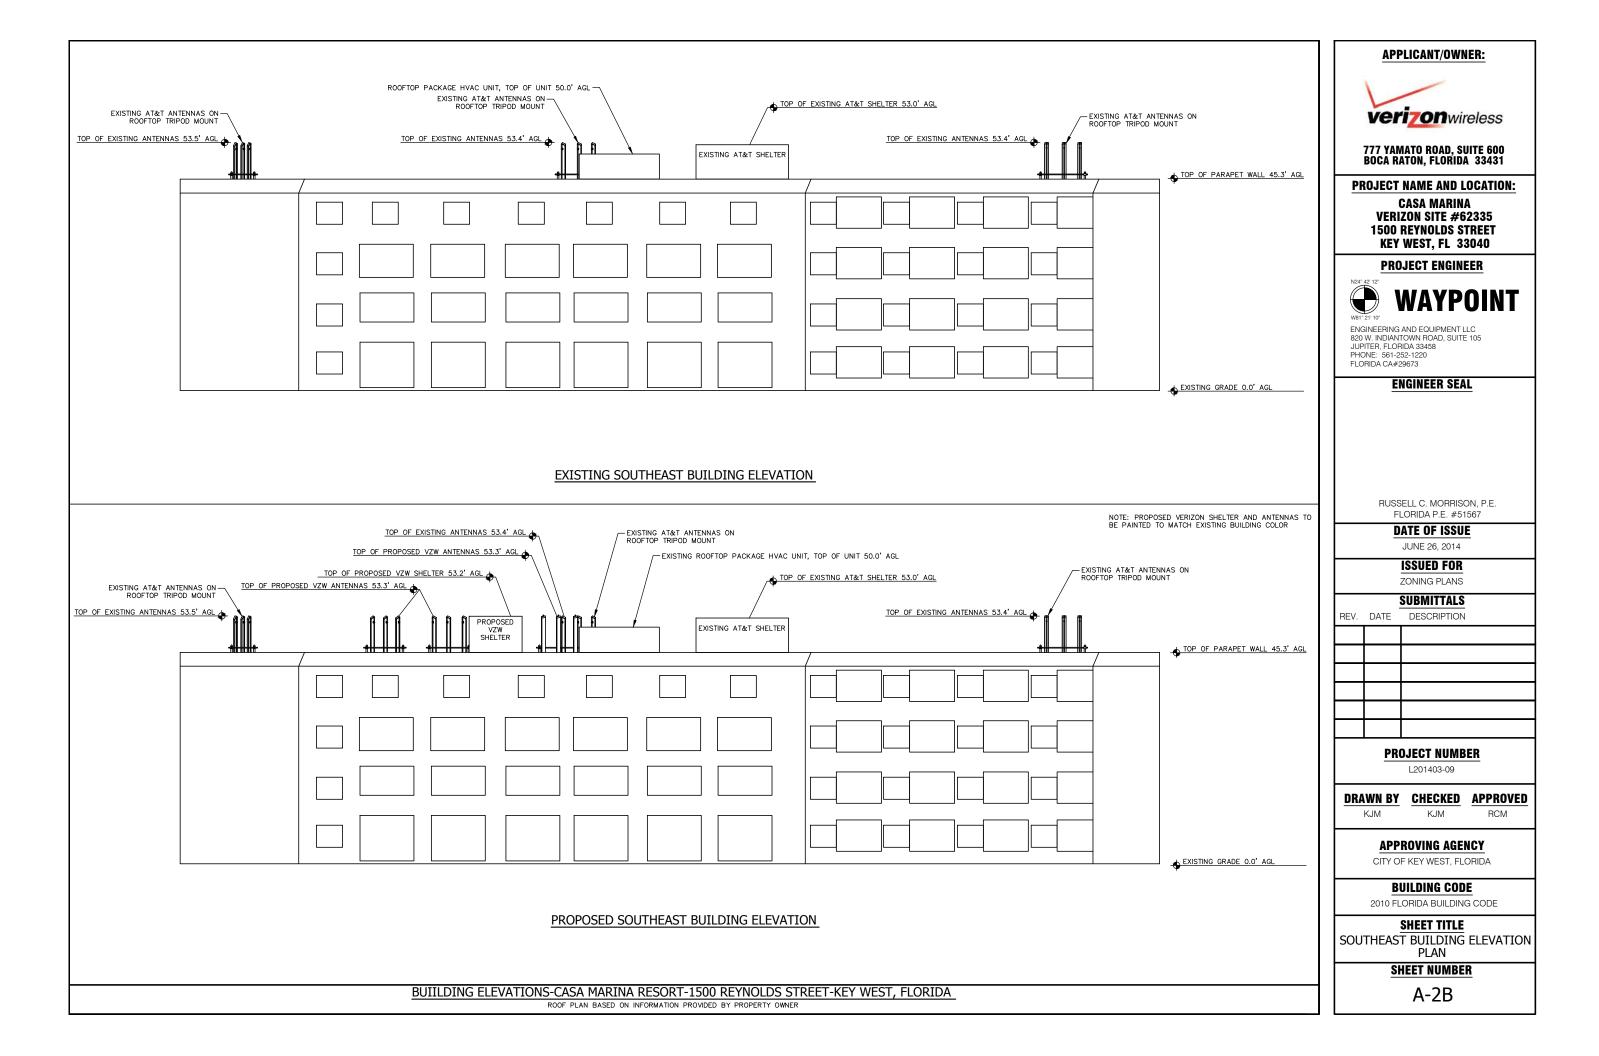
#### SHEET TITLE

BUILDING ELEVATIONS PLAN

#### SHEET NUMBER

A-2











715 SEMINOLE AVENUE 761 SEMINOLE AVENUE 837 SEMINOLE AVENUE







850 SEMINOLE AVENUE 1500 ALBERTA STREET 1579 WILLIAM STREET

#### APPLICANT/OWNER:



777 YAMATO ROAD, SUITE 600 BOCA RATON, FLORIDA 33431

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KJM KJM RCM

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CITY OF KEY WEST, FLORIDA

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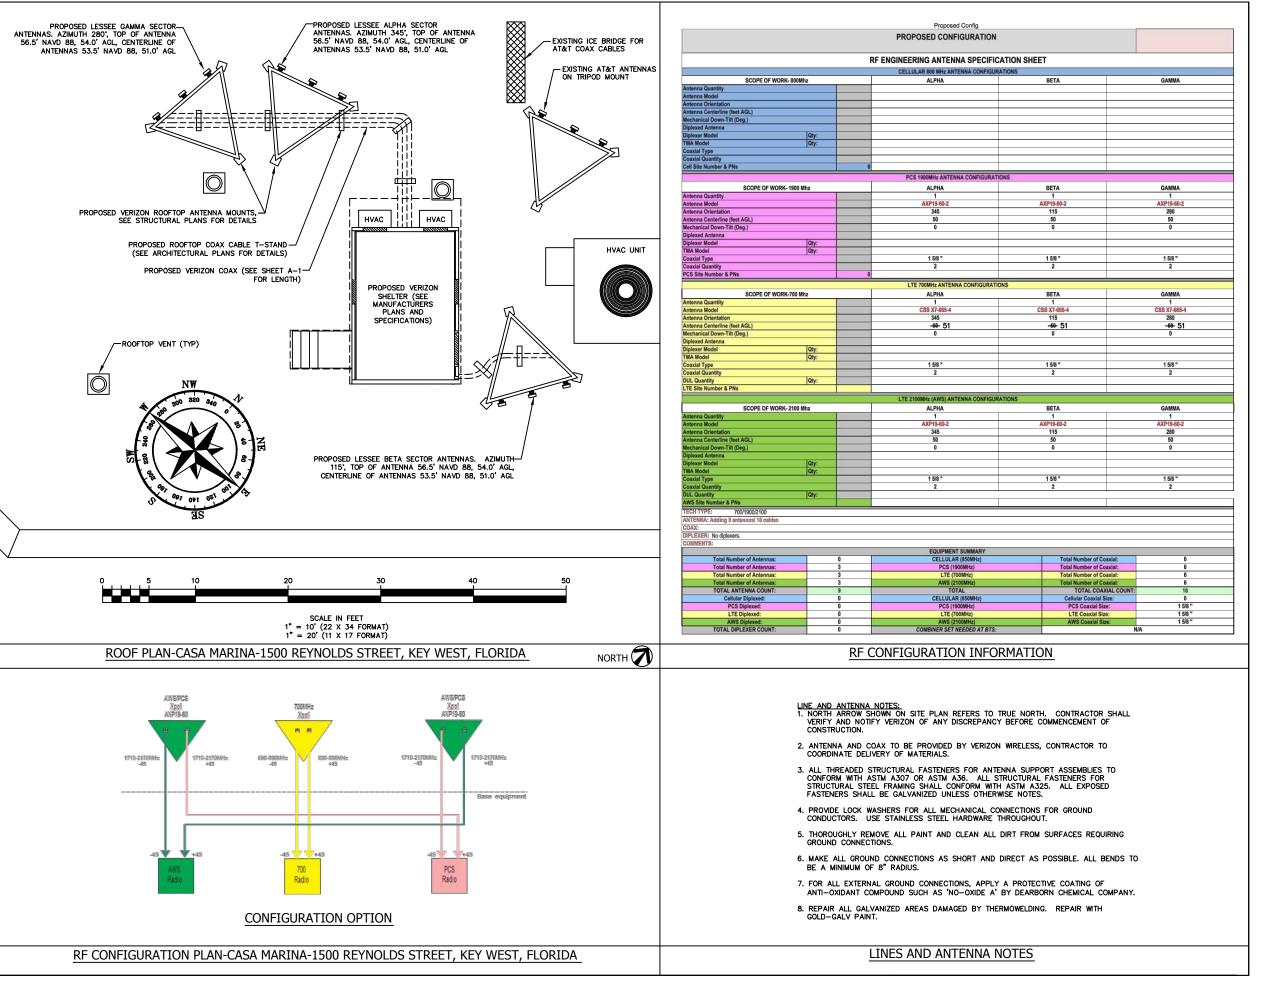
2010 FLORIDA BUILDING CODE

### SHEET TITLE

ADJACENT PROPERTIES EXHIBIT

### SHEET NUMBER

A-2C



APPLICANT/OWNER:



777 YAMATO ROAD, SUITE 600 BOCA RATON, FLORIDA 33431

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KJM KJM

## APPROVING AGENCY

CITY OF KEY WEST, FLORIDA

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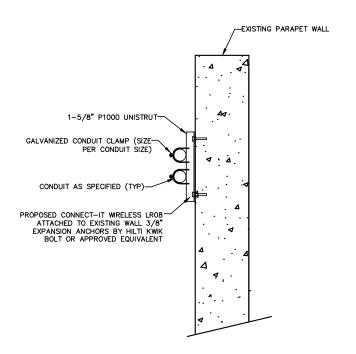
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#### SHEET TITLE


RF PLAN ANTENNAS AND LINES

#### SHEET NUMBER

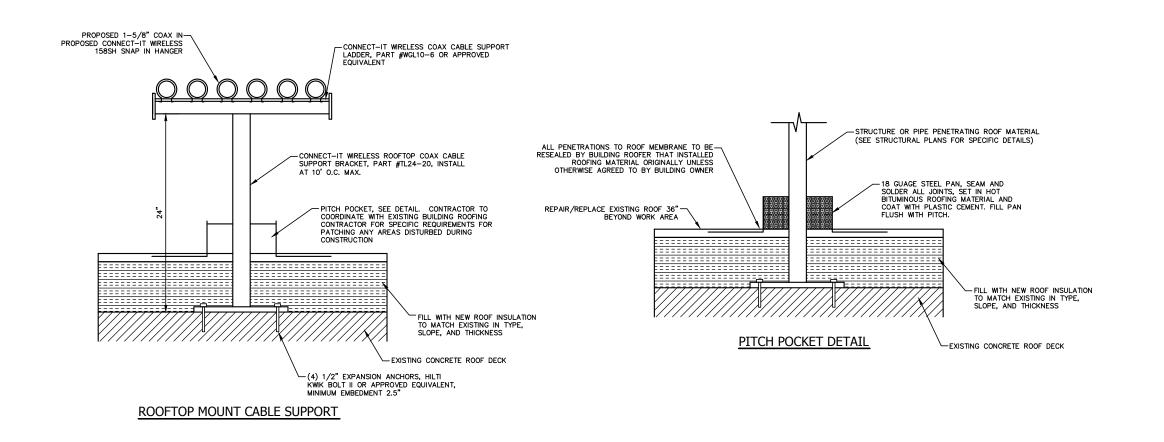A-3



#### COAX CABLE MOUNT TO PARAPET WALL



#### **APPLICANT/OWNER:**



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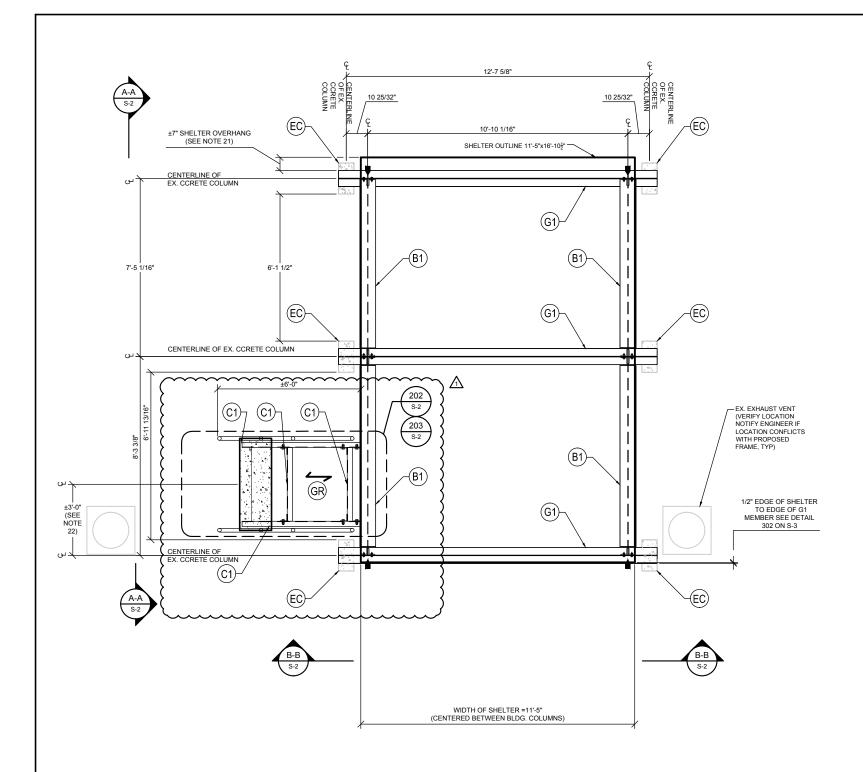
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#### SHEET TITLE

CONSTRUCTION DETAILS

#### SHEET NUMBER

CONSTRUCTION DETAILS-CASA MARINA-1500 REYNOLDS STREET, KEY WEST, FLORIDA



#### **LEGEND**

MCNICHOLS GW(19W4) 1" x 3" GALVANIZED FINISH GRATING (INSTALL PER MANUFACTURER'S SPECIFICATIONS)

DIRECTION OF GRATING

EX. CONCRETE COLUMN, 7 5"X 15 6" W/ 4#5 VERTICAL REINFORCEMENT & #2 @72" O/C TIES

G1) GIRDER, W10X33

CHANNEL C10x15.3

(B1) BEAM, W10X33

(P1) 5.0X PIPE

(P2) 3.0X PIPE

(A1) ANTENNA (SEE CIVIL PLANS FOR DETAILS)

(HR) HAND RAIL (SEE DETAIL 307 ON S-3)

INSTALL STIFFENER (SEE DETAIL 203 ON S-2)

### UNDERLYING STRUCTURAL SUPPORT FOR SHELTER - PLAN VIEW

#### NOTES:

CONTRACTOR SHALL MEET THE REQUIREMENTS OF THE 2010 FLORIDA BUILDING CODE AND ANY OTHER LOCAL OR REGIONAL

2. WIND LOAD CRITERIA (ASCE 7-10)

STRUCTURAL FRAME: BASIC WIND SPEED = 185 MPH (3-SECOND GUST) STRUCTURAL CATEGORY = II MWFRS ENCLOSED BUILDING

STRUCTURAL STEEL:

MATERIAL - ALL STEEL MEMBERS SHALL CONFORM WITH THE FOLLOWING SPECIFICATIONS. PIPE SHAPES SHALL CONFORM TO ASTM A53 GRADE B (Ev = 35 ksi: Fu = 60 ksi HSS SHAPES SHALL CONFORM TO ASTM A500 GRADE B (Fy = 46 ksi; Fu = 58 ksi) W SHAPES SHALL CONFORM WITH ASTM A992 (Fy=50ksi,Fu=65ksi) CHANNELS AND ANGLES SHALL CONFORM WITH ASTM A36 (Fv=36ksi,Fu=58ksi) PLATES SHALL CONFORM WITH ASTM A36 (FY=36ksi,Fu=58ksi

DESIGN FABRICATION AND CONSTRUCTION SHALL CONFORM TO AISC MANUAL OF STEEL CONSTRUCTION 14TH EDITION

SHALL BE DONE BY AN AWS CERTIFIED WELDER AND IN COMPLIANCE WITH AWS D1.1. ALL WELDS SIZES SHALL BE THE MAXIMUM

GALVANIZED ASSEMBLIES:

GALVANIZED HSS ASSEMBLIES SHOULD NOT BE COMPLETELY SEALED BECAUSE RAPID PRESSURE CHANGES DURING THE

THIS DESIGN IS BASED AN EMAIL PROVIDED BY JOHN IRVING AT CELLXION A LIGHTWEIGHT 11'-5" x 16'-10\frac{1}{2}" x 11'-5" (Lxwxh OVERALL) IS PROPOSED TO BE INSTALLED ON TOP OF THE SUBFRAME AS DETAILED IN THESE PLANS. THE SHELTER HAS A DEAD WEIGHT OF 22,000 LBS (SHELTER WEIGHT ONLY). THE SHELTER FLOOR HAS A W16x31 PERIMETER BEAM THAT IS PROPOSED TO BE DIRECTLY WELDED TO THE SUBFRAME. THE LIGHTWEIGHT SHELTER SHOP DRAWINGS MUST BE PROVIDED TO JWME PRIOR TO CONSTRUCTION SO THAT JWME MAY BE ABLE TO MODIFY ANY PARTS OF THE DESIGN THAT MAY CONFLICT WITH THESE

- 5. ALL COMPONENTS SHALL BE PROTECTED FROM WEATHER EFFECTS. USE HOT DIP GALVANIZED MATERIAL OR PAINT AS APPROPRIATE, TOUCH UP ALL FIELD WELDS AND ABRADED AREAS WITH TWO COATS OF ACCEPTABLE PAINT, REPAIR OF ABRADED OR UNCOATED AREAS SHALL CONFORM TO ASTM A780-93A.
- 6. CONTRACTOR MAY PAINT GALVANIZED HSS MEMBERS IF REQUESTED BY THE CLIENT. CONTRACTOR SHALL COORDINATE WITH
- ). CONTRACTOR / STEEL FABRICATOR SHALL CAP OR SEAL ALL PIPES AS REQUIRED TO PREVENT RAINWATER INTRUSION.
- 10. CONTRACTOR / STEEL FABRICATOR SHALL SUBMIT SHOP DRAWINGS FOR REVIEW PRIOR TO ANY STEEL FABRICATION. AT THE CONTRACTOR'S OPTION, FIELD SPLICES MAY BE USED FOR ERECTION PURPOSES. IF FIELD SPLICES ARE USED, THE SHOP DRAWINGS SHALL INCLUDE ALL DETAILS FOR THE PROPOSED FIELD SPLICES AND SHALL BE APPROVED BY THE ENGINEER PRIOR
- 11. AT THE CONTRACTORS OPTION, SHOP WELDS MAY BE USED INSTEAD OF FIELD WELDS.
- 12. SUBMIT ORIGINAL SHOP DRAWINGS, INCLUDING COMPLETE DETAILS, SCHEDULES OF FABRICATION AND ASSEMBLY, PROCEDURES, AND DIAGRAMS. INCLUDE DETAILS OF CUTS, CONNECTIONS, CAMBER, HOLE, AND OTHER PERTINENT DATA. INDICATE WELDS BY STANDARD AWS A2 1 AND A2 4 SYMBOLS, AND SHOW SIZE LENGTH, AND TYPE OF WELD, PROVIDE SETTING WINGS, TEMPLATES, AND DIRECTIONS FOR INSTALLATION OF ANCHOR BOLTS AND OTHER ANCHORAGES TO BE INSTALLED
- 13. CONTRACTOR SHALL BE RESPONSIBLE FOR RESTORING ANY AREAS OF THE SITE AT THE CONTRACTOR'S EXPENSE THAT ARE
- 14. THE CONTRACTOR SHALL VERIFY PROPOSED STRUCTURAL LOCATIONS AND POTENTIAL CONFLICTS BEFORE BEGINNING
- 15. CONTRACTOR SHALL VERIEY ALL DIMENSION PRIOR TO CONSTRUCTION AND NOTIFY THE ENGINEER OF ANY DISCREPANCIES. BETWEEN THE CONSTRUCTION DRAWING SET AND EXISTING FIELD CONDITIONS.
- 16. JWME WAS NOT PROVIDED AN EXISTING DRAINAGE PLAN FOR THIS ROOF AND THEREFORE THE EXISTING DRAINAGE PATTERN IS UNKNOWN. THE CONTRACTOR MUST PROVIDE PROPER SLOPING AT AND AROUND SHELTER SO THAT THE EXISTING DRAINAGE PATTERN ON THE ROOF IS MAINTAINED. THIS MAY REQUIRE SOME MODIFICATION TO THE EXISTING ROOF. THE CONTRACTOR SHALL EVALUATE THE SITE PRIOR TO CONSTRUCTION AND NOTIFY JWME OF ANY POTENTIAL PROBLEMS. JWME WILL WORK WITH THE CONTRACTOR TO DEVELOP A PROPER DRAINAGE PLAN AS NECESSARY
- 17. THIS DESIGN IS BASED ON INFORMATION PROVIDED TO JWME BY WAYPOINT ENGINEERING INCLUDING:
   RECORD DRAWINGS BY PETER L. GLUCK ARCHITECT 80 FIFTH AVE. NEW YORK, NY 10011 & GEIGER BERGER ASSOCIATES, P.C. (STRUCTURAL ENGINEERS) 500 FIFTH AVE NEW YORK NY 10036 DATED 1978 PHOTOGRAPHS OF THE RECORD BUILDING DRAWINGS FROM SITE VISIT PERFORMED BY RUSSELL MORRISON OF WAYPOINT

ENGINEERING, LLC ON 03/11/14 LIGHT WEIGHT SHELTER DESIGNED BY CELLIXON (JOHN IRVING, PE). INFORMATION ON THE OVERALL DIMENSIONS AND WEIGHT OF THIS SHELTER WERE PROVIDED IN AN EMAIL FROM MR. IRVING

- 18. CONTRACTOR MUST COORDINATE ALL SITE IMPROVEMENTS WITH THE BUILDING OWNER AND CLIENT PROJECT MANAGER.
- 19. CONTRACTOR MUST VERIFY THE PROPOSED BASE PLATES ARE LOCATED DIRECTLY ABOVE THE UNDERLYING BUILDING'S CONCRETE COLUMNS AND THAT THE CONCRETE SLAB THICKNESS IS AS INDICATED. CONTRACTOR SHALL ALSO VERIFY THAT NO EXISTING REINFORCING STEEL IN THE LINDERLYING CONCRETE DECK AND COLUMN ARE COMPROMISED WITH THE PROPOSED IMPROVEMENTS. REPORT TO ENGINEER IF DIFFERENT
- 20. FROM THE SITE PHOTOGRAPH IT IS UNDERSTOOD THERE ARE SOME EXHAUST VENTS NEAR THE PROPOSED SITE AREA. JWME WAS NOT PROVIDED AN AS-BUILT SURVEY OF THIS ROOF TOP AND ALL EQUIPMENT IS GENERALLY LOCATED. THE CONTRACTOR MUST VERIFY THAT THE EXISTING EXHAUST VENT IS NOT IN CONFLICT WITH THE PROPOSED SITE LAYOUT AND THAT ALL CLEARANCES ARE MAINTAINED ACCORDING TO THE FBC. THE CONTRACTOR MUST CONTACT THE ENGINEER IF THERE IS A
- PERCEIVED CONFLICT PRIOR TO CONSTRUCTION. 21. PER CONVERSATIONS WITH THE SHELTER MANUFACTURER, WAYPOINT ENGINEERING, AND VERIZON THE SHELTER IS TO CONSTRUCTED WITH A 5" THICK CONCRETE SLAB FLOOR IN LIFU OF THE W 16x31 PERIMETER BEAM THAT WAS IN THE PREVIOUS VERSION. AS A RESULT THE ATTACHMENT METHOD (AS SHOWN IN DETAIL 308 ON 5.3) OF THE FRAME TO THE STEEL SUB-STRUCTURE HAS BE MODIFIED. AT THE TIME OF THIS CHANGE JWME WAS NOT PROVIDED AS-BUILTS OF THE PROPOSED SHELTER. THE CONTRACTOR MUST PROVIDE SHOP DRAWINGS OF THE SHELTER TO THE STRUCTURAL ENGINEER PRIOR TO CONSTRUCTION TO VERIFY THE PROPOSED CONNECTION METHOD WILL BE ACCEPTABLE. DESIGN MODIFICATIONS MAY BE NECESSARY AND MAY IMPACT THE CONSTRUCTION SCHEDULE AS A RESULT.
- 22. STAIRWELL MUST BE CENTERED ON SHELTER DOOR AND PROVIDE PROPER INGRESS AND EGRESS ACCESS TO SHELTER. NOTIFY ENGINEER IF SHELTER DRAWINGS CONFLICT WITH PROPOSED STAIRWELL. MODIFICATIONS MAY BE NECESSARY

#### APPLICANT/OWNER:



14055 RIVEREDGE DRIVE, SUITE 600 TAMPA, FLORIDA 33637

#### PROJECT NAME AND LOCATION:

**CASA MARINA VERIZON SITE #62335 1500 REYNOLDS STREET** KEY WEST, FL 33040

#### **PROJECT ENGINEER**



ENGINEERING AND EQUIPMENT LLC 820 W. INDIANTOWN ROAD, SUITE 105 JUPITER, FLORIDA 33458 PHONE: 561-252-1220 FLORIDA CA#29673

#### **ENGINEER SEAL**

DESIGN ENGINEER: JOHN WAYNE MISHOE, P.E. #25349 STEPHEN MATTHEW BELSER, P.E. #67514

#### STRUCTURAL ENGINEER:



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٧.	DATE	DESCRIPTION

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CITY OF KEY WEST, FLORIDA

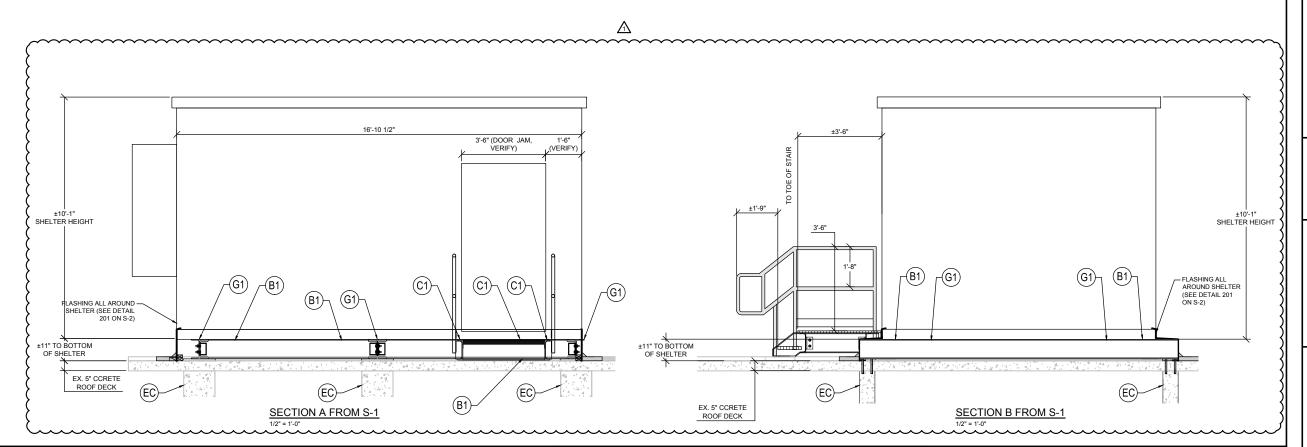
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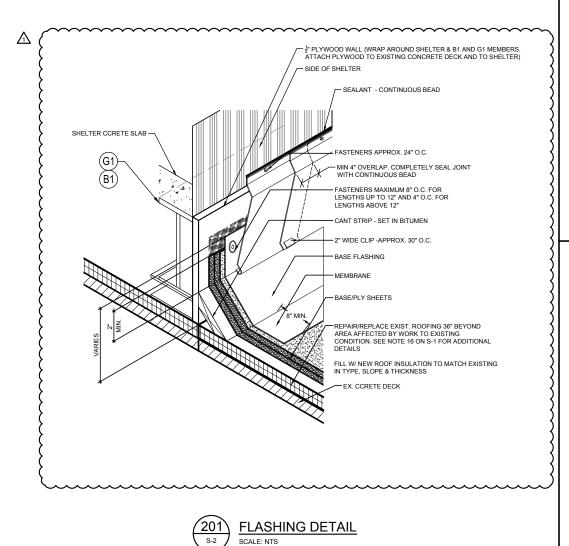
2010 FLORIDA BUILDING CODE

#### SHEET TITLE STRUCTURAL PLAN

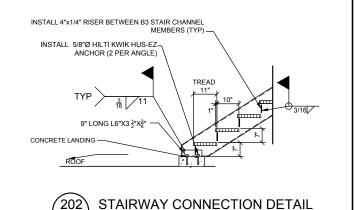
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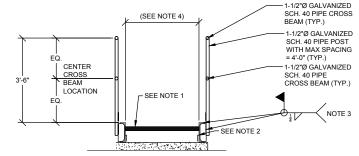
SHEET NUMBER





SCALE: NTS





#### DETAIL 203 NOTES:

S-2

SCALE: NTS

- STAIR TREAD-GRIP STRUT 4 DIAMOND PLANK 14GA PRE GAL. STEEL, MODEL#41514
- ANCHOR BOLT ATTACHMENT MOUNT PER DETAIL 202 ON S-2
  SEE DETAIL 307 ON S-3 FOR HANDRAIL CONNECTION DETAIL
  MINIMUM WIDTH TO ALLOW FOR PROPER ACCESS TO SHELTER DOOR. SEE
- SHELTER DRAWINGS

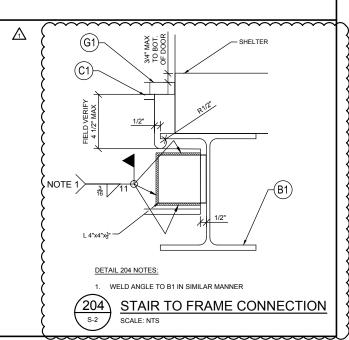


TYP. STAIR & HANDRAIL CONNECTION DETAIL SCALE: NTS

# **LEGEND**

MCNICHOLS GW(19W4) 1" x  $\frac{1}{8}$ " GALVANIZED FINISH GRATING (INSTALL PER MANUFACTURER'S SPECIFICATIONS)

- EX. CONCRETE COLUMN, 7  $_8^{\rm m}$ X 15  $_{\rm f6}^{\rm o}$  W/ 4#5 VERTICAL REINFORCEMENT & #2 @72" O/C TIES
- (G1)
- (C1) CHANNEL C10x15.3
- (B1) BEAM, W10X33
- 5.0X PIPE
- (P2) 3.0X PIPE
- (A1) ANTENNA (SEE CIVIL PLANS FOR DETAILS)
- HAND RAIL (SEE DETAIL 307 ON S-3)
- INSTALL STIFFENER (SEE DETAIL 203 ON S-2)



#### **APPLICANT/OWNER:**



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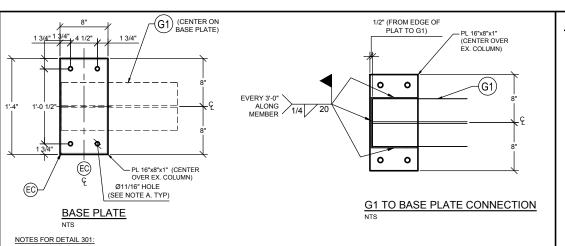
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SHELTER SECTIONS AND DETAILS

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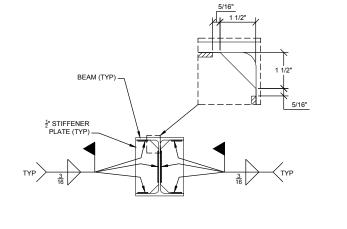


# **DETAIL REMOVED**

S-3

SCALE: NTS



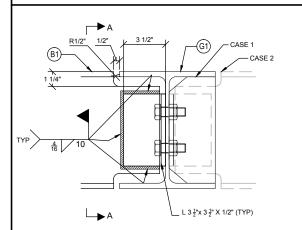


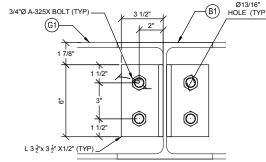
#### STIFFENER PLATE DETAIL SCALE: NTS

A. INSTALL 5/8 HILTI HAS B7 CARBON STEEL THREADED ROD WITH HILTI HIT-HY 200 SAFE SET SYSTEM EPOXY WITH MINIMUM EMBEDMENT DEPTH OF 4" B. CENTER BASE PLATE OVER EXISTING COLUMN (TYP)



BASE PLATE CONNECTION DETAIL SCALE: NTS





CASE 1 - ADD STIFFENER ON OPPOSITE SIDE OF ANY SINGLE BEAM CASE 2 - OPPOSITE BEAM PRESENT

SECTION A-A




**B1 TO G1 CONNECTION** SCALE: NTS

#### **LEGEND**

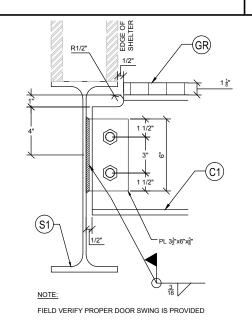MCNICHOLS GW(19W4) 1" x 1/8" GALVANIZED FINISH GRATING (INSTALL PER MANUFACTURER'S (GR) SPECIFICATIONS)


DIRECTION OF GRATING

- EX. CONCRETE COLUMN, 7 5 "X 15 5" W/ 4#5 VERTICAL REINFORCEMENT & #2 @72" O/C TIES
- (G1) GIRDER, W10X33
- (C1) CHANNEL C10x15.3
- (B1) BEAM, W10X33
- (P1) 5.0X PIPE
- (P2) 3.0X PIPE
- (A1) ANTENNA (SEE CIVIL PLANS FOR DETAILS)
- (HR) HAND RAIL (SEE DETAIL 307 ON S-3)
- ► INSTALL STIFFENER (SEE DETAIL 203 ON S-2)





C1 TO S1 CONNECTION

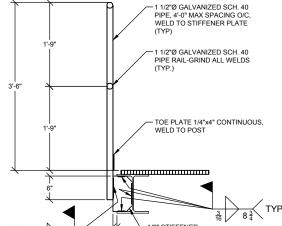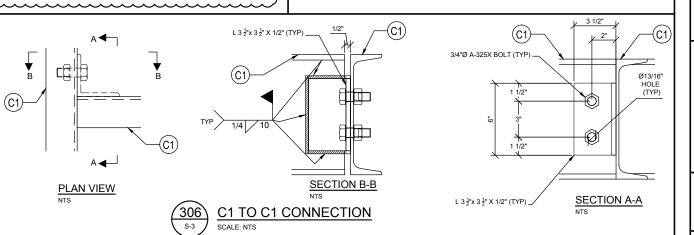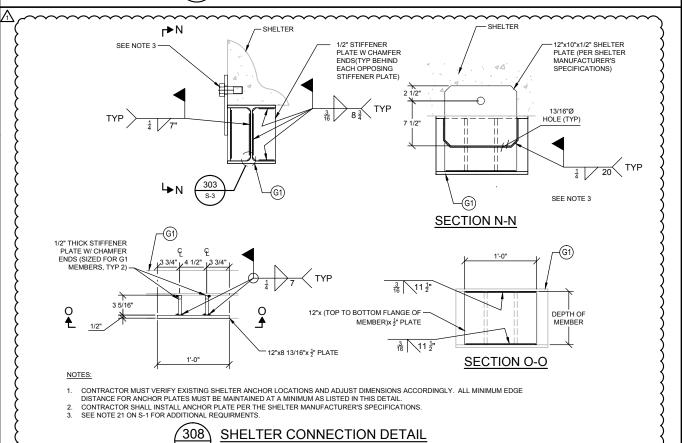SCALE: NTS









S-3

SCALE: NTS





14055 RIVEREDGE DRIVE, SUITE 600 TAMPA. FLORIDA 33637

#### PROJECT NAME AND LOCATION:

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#### **PROJECT ENGINEER**



ENGINEERING AND EQUIPMENT LLC 820 W. INDIANTOWN ROAD, SUITE 105 JUPITER, FLORIDA 33458 PHONE: 561-252-1220 FLORIDA CA#29673

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CITY OF KEY WEST, FLORIDA

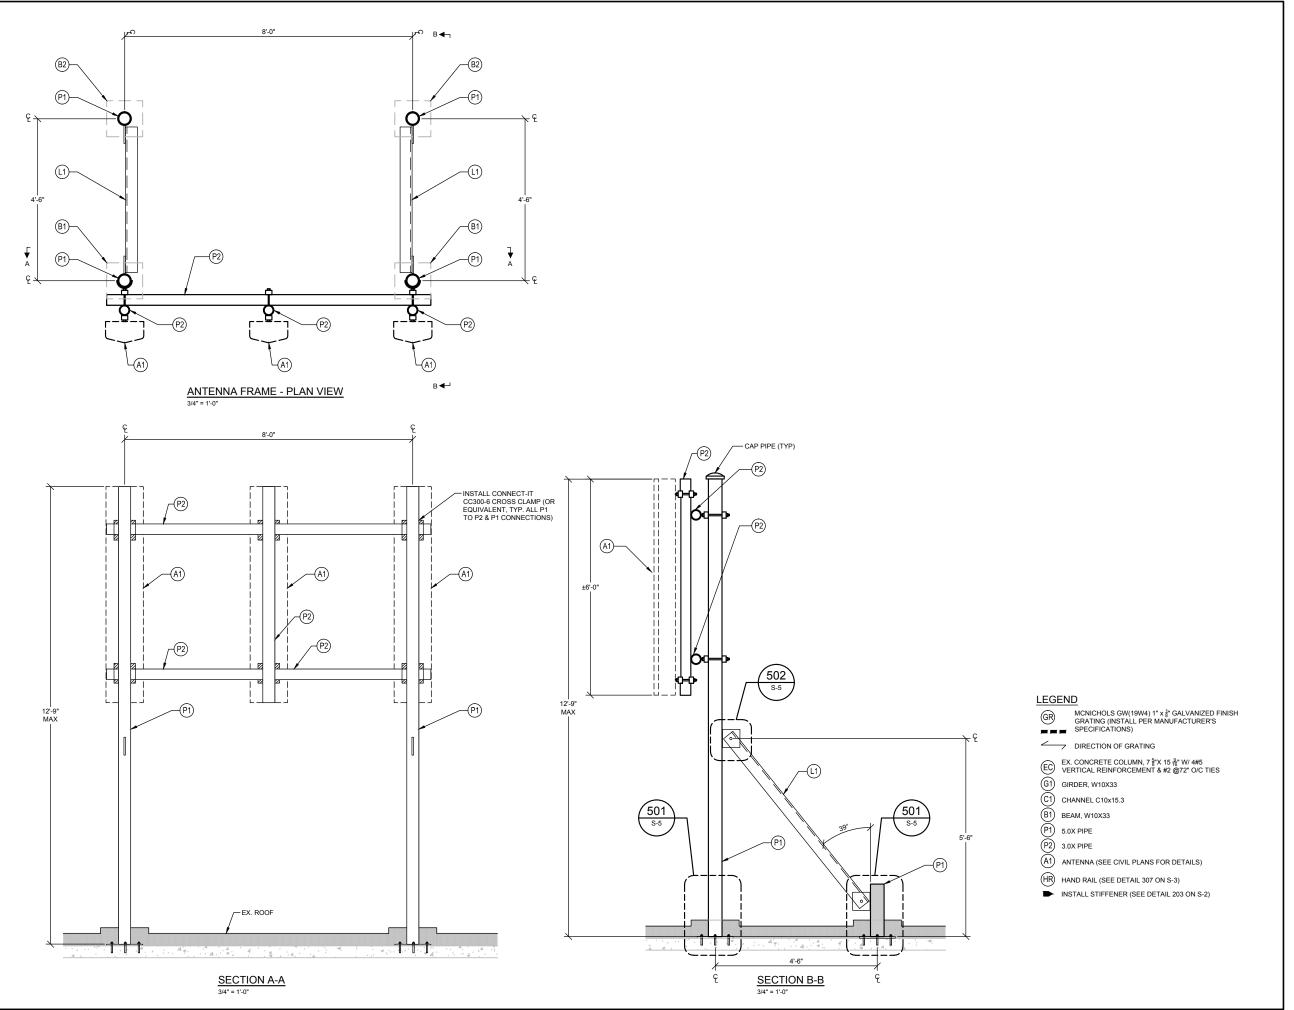
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RCM

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CITY OF KEY WEST, FLORIDA


#### **BUILDING CODE**

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#### SHEET TITLE

ANTENNA FRAME PLAN & SECTIONS

#### SHEET NUMBER

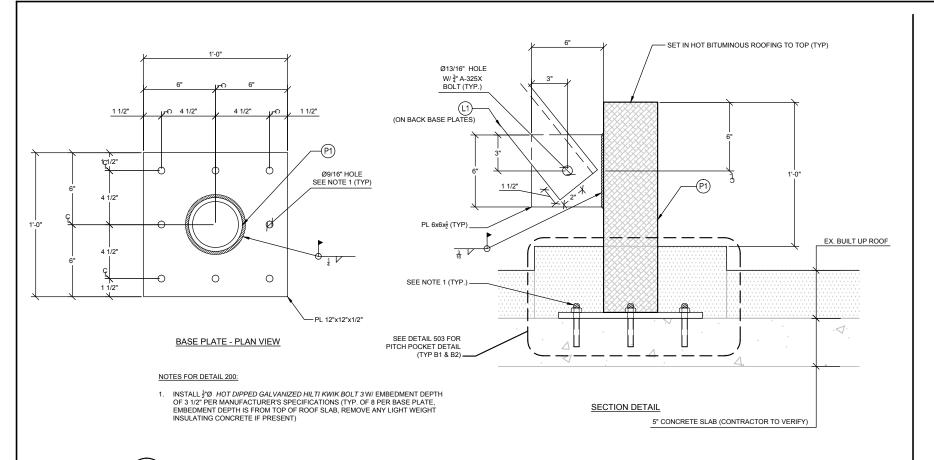


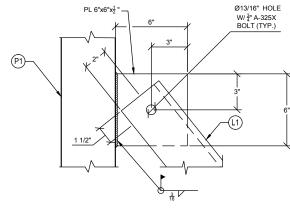


PLATE TO COLUMN WELD DETAIL

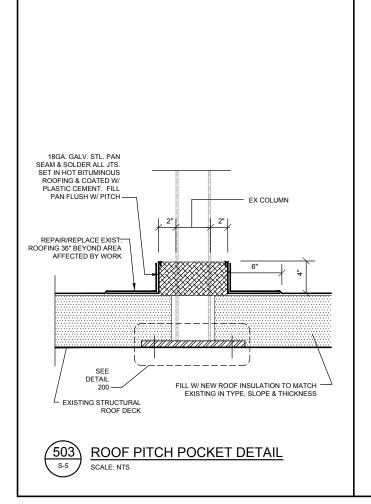SCALE: NTS



S-5

**BASEPLATE MODIFICATION DETAIL** 

#### **LEGEND**

MCNICHOLS GW(19W4) 1" x ½" GALVANIZED FINISH GRATING (INSTALL PER MANUFACTURER'S SPECIFICATIONS) \_\_\_

DIRECTION OF GRATING

EX. CONCRETE COLUMN, 7 8"X 15 8" W/ 4#5 VERTICAL REINFORCEMENT & #2 @72" O/C TIES

G1) GIRDER, W10X33

(C1) CHANNEL C10x15.3 (B1) BEAM, W10X33

(P1) 5.0X PIPE

(P2) 3.0X PIPE

A1) ANTENNA (SEE CIVIL PLANS FOR DETAILS)

HR) HAND RAIL (SEE DETAIL 307 ON S-3)

INSTALL STIFFENER (SEE DETAIL 203 ON S-2)

#### APPLICANT/OWNER:



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#### **PROJECT NAME AND LOCATION:**

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RCM JWM

#### **APPROVING AGENCY**

CITY OF KEY WEST, FLORIDA

#### **BUILDING CODE**

2010 FLORIDA BUILDING CODE

#### SHEET TITLE

ANTENNA DETAILS

#### **SHEET NUMBER**

#### **ELECTRICAL SYSTEM NOTES**

- A. THE CONTRACTOR SHALL PROVIDE ALL MATERIAL AND LABOR FOR A COMPLETE ELECTRICAL SYSTEM AS INDICATED ON THE DRAWINGS. ITEMS NOT SHOWN BUT OBVIOUSLY NECESSARY FOR A COMPLETE SYSTEM SHALL BE INCLUDED.
- B. THE CONTRACTOR SHALL OBTAIN ALL NECESSARY PERMITS, INSPECTIONS AND
- C. ALL WORK SHALL CONFORM TO THE NATIONAL ELECTRICAL CODE AND THE LOCAL BUILDING CODES. ALL COMPONENTS SHALL BE U.L. APPROVED.
- D. THE CONTRACTOR SHALL BEFORE SUBMITTING HIS BID. VISIT THE SITE OF THE PROJECT AND RECOME FAMILIAR WITH THE CONDITIONS NO ALLOWANCE WILL BE MADE FOR EXISTING CONDITIONS OR FAILURE OF THE CONTRACTOR TO OBSERVE
- E. EXACT LOCATION OF ALL EQUIPMENT SHALL BE COORDINATED WITH WIRELESS CARRIER, THE BUILDING OWNER AND OTHER TRADES.
- F. WHERE EQUIPMENT IS SPECIFIED BY MANUFACTURER AND TYPE, SUBSTITUTION SHALL ONLY BE MADE WITH THE APPROVAL OF THE ENGINEER. THE CONTRACTOR SHALL SUBMIT DETAILS OF PROPOSED MATERIALS, REASON FOR CHANGE AND CHANGE IN CONTRACT AMOUNT.

- A. THE CONTRACTOR SHALL PROVIDE ALL ELECTRICAL WIRING AND EQUIPMENT UNLESS OTHERWISE INDICATED. MAIN COMPONENTS ARE AS FOLLOWS:
- 1. PROVIDE ELECTRICAL SERVICE AS INDICATED ON THE DRAWINGS.
- 2. PROVIDE SERVICE EQUIPMENT MOUNTED AS DIRECTED BY CARRIER AND AS INDICATED ON THE DRAWINGS.

- PROVIDE TELEPHONE CONDUIT WITH PULL WIRE AND CABLE AS INDICATED ON DRAWINGS.
- 4. COORDINATE ELECTRICAL SERVICE WITH POWER CO. CONTACT REPRESENTATIVE & OBTAIN FAULT CURRENT LETTER PRIOR TO CONSTRUCTION. CONTRACTOR SHALL MAKE ADJUSTMENTS TO CIRCUIT BREAKERS TO MEET FAULT CURRENT WHEN NOT USING CURRENT LIMITING FUSES.
- 5. COORDINATE TELEPHONE SERVICE WITH THE TELEPHONE CO. CONTACT REPRESENTATIVE PRIOR TO CONSTRUCTION.
- 6. INSTALL WIRE AND CONDUIT AS INDICATED. PROVIDE CABLE SUPPORTS AS
- 7. PROVIDE GROUNDING AND LIGHTNING PROTECTION SYSTEM AS INDICATED.
- 8. RESTORE ALL AREAS TO ORIGINAL CONDITION AFTER INSTALLATION OF CONDUIT.
- 9. CONTRACTOR SHALL CLEARLY LABEL DISCONNECTS AND OTHER RELATED GEAR.
- 10. AT TIME OF PLAN PERMITTING, CONTRACTOR SHALL APPLY FOR A THIRTY (30) DAY TEMPORARY POWER PERMIT FOR TESTING PURPOSES.

- A. CONDUIT SIZES AS SHOWN ON THE DRAWINGS ARE A MINIMUM. THE CONTRACTOR MAY INCREASE AS REQUIRED FOR EASE OF PULLING.
- B. CONDUIT TYPES SHALL BE AS FOLLOWS UNLESS OTHERWISE INDICATED:
- 1. ALL ABOVE GRADE CONDUIT SHALL BE RIGID GALVANIZED STEEL.
- 2. ALL CONDUIT BELOW GRADE SHALL BE SCHEDULE 40 PVC. 3. CONCEALED CONDUIT IN WALLS OR ABOVE CEILING SHALL BE EMT.
- C. ALL EXPOSED CONDUIT SHALL BE NEATLY INSTALLED AND RUN PARALLEL OR PERPENDICULAR TO STRUCTURAL ELEMENTS. SUPPORTS AND MOUNTING HARDWARE

SHALL BE HOT DIPPED CALVANIZED STEEL. NYLON INSULATED BUSHINGS SHALL BE USED ON ALL CONDUIT TERMINATIONS.

- D. FLEX CONDUIT SHALL BE LIQUID TIGHT FLEXIBLE METALLIC CONDUIT.
- E. NO CONDUIT SHALL BE INSTALLED IN LIFE SAFETY AREAS SUCH AS STAIRWAYS.
- F. CONDUIT ROLITES ARE SCHEMATIC. FIELD VERIEY ROLITE BEFORE BID. COORDINATE ROUTE WITH WRELESS CARRIER AND BUILDING OWNER.

  G. WEATHERPROOF HUBS SHALL BE USED FOR ALL TOP AND SIDE PENETRATIONS TO ENCLOSURE LOCATED OUTDOORS.

- A. CONDUCTORS SHALL BE STRANDED COPPER TYPE THWN WITH 90 DEGREE C RISE
- 5. PULL BOXES AND JUNCTION BOXES
- A. INTERIOR ENCL. SHALL BE NEMA 1. EXTERIOR ENCL. SHALL BE NEMA 3R.

- A. PROVIDE GROUND SYSTEM AS INDICATED ON THE DRAWINGS AND AS REQUIRED BY THE NATIONAL ELECTRIC CODE AND RADIO EQUIPMENT MANUFACTURER.
- B. ALL RACEWAYS REQUIRE GROUNDING CONDUCTORS, BONDING CONDUCTORS THROUGH THE RACEWAY SYSTEM SHALL BE CONTINUOUS FROM MAIN SWITCH GROUND BUSES TO PANEL GROUND BARS, AND FROM PANEL GROUNDING BARS TO BRANCH CIRCUIT OUTLETS, MOTORS, LIGHTS, ETC. THESE GROUND CONDUCTORS ARE REQUIRED THROUGHOUT THE PROJECT REGARDLESS OF WHETHER CONDUIT RUNS SHOW GROUND CONDUCTORS ON THE DRAWINGS.
- C. COORDINATE WITH ENCLOSURE SUPPLIER TO INSTALL TELCO GROUND BARS BELOW THE TELCO BOARD. CONNECT TO MAIN GROUNDING SYSTEM.

#### **GROUNDING PROTECTION SYSTEM NOTES**

- PROVIDE "CABLE ENTRANCE GROUND BAR" (CEGB), 3"H X 6"L X 1/4"D. MOUNT AT TELCO CABINET. COORD. INSTALLATION WITH CPM.
- PROVIDE A GROUND RING BURIED A MINIMUM OF 18" BELOW GRADE. THE GROUND RING SHALL BE INSTALLED A MINIMUM OF 2'-0" AWAY FROM THE FOUNDATION UNLESS SHOWN ON DRAWING.
- 3. BOND FENCE POST TO GROUND RING USING AN EXOTHERMIC WELD. BOND FENCE GATE TO POST WITH A FLEXIBLE COPPER JUMPER STRAP MECHANICALLY OR EXOTHERMICALLY. TYPICAL FOR ALL FENCE PLANES HOLD 11/2 TO EACH FENCE PLANE TO ANY PLANES WITHIN 50'.

  13. ALL BENDS IN GROUND WIRES SHALL BE NOMINAL 12" RADIUS. TO PLANES HOLD IN GREAT SHALL BE BONDED AT EACH END. RUNS GREAT SHALL BE BONDED AT EACH END. RUNS GREAT SHALL BE BONDED TOWARDS MIDDLE OF LENGTH. COORDINATE LINE.
- 4. BOND DISCONNECT SWITCH, METER, TELEPHONE CABINET AND SERVICE CONDUITS TO
- EACH LEG OF THE WAVEGUIDE STRUCTURE SHALL BE INDIVIDUALLY BONDED TO THE BURIED GND RING. EXOTHERMICALLY WELD CONNECTIONS AT POST FOR WAVEGUIDE STRUCTURE AND BURIED GND RING. PLACE 5/8"X10' COPPERCLAD GND ROD AT 10' INTERVALS ALONG WAVEGUIDE PATH.
- 6. BOND REBAR IN CONCRETE FOR COMMUNICATION STRUCTURE AND EQUIPMENT PAD TO BURIED GROUND RING. EXOTHERMICALLY WELD A #2 TINNED SOLID COPPER CONDUCTOR TO THE REBAR AND CONNECT TO THE BURIED GROUND RING.
- 7. PROVIDE INSPECTION SLEEVE AT MAIN SERVICE GROUNDS. EXOTHERMIC CONNECTIONS.
- 8. PROVIDE BONDING CONDUCTOR(S) FROM THE BURIED GROUND RING TO THE ANTENNA CABLE BUS BAR AT POINT JUST INSIDE OF THE COMMUNICATION STRUCTURE EXIT. VERIFY EXACT LOCATION OF COPPER BUS BAR FOR PROPER CONDUCTOR LENGTH. FINAL EXOTHERMIC WELDS TO COPPER BUS BAR BY THE ANTENNA CABLE INSTALLER.
- EXOTHERMICALLY WELD BONDING CONDUCTOR TO COMMUNICATION STRUCTURE LEG AT 1'-0" ABOVE PAD AND BOND TO BURIED GROUND RING. PROVIDE A 3/4" PVC SLEEVE WITH A GRADUAL BEND IN THE CONCRETE FOUNDATION.
- 10. 5/8"X10'-0" LONG COPPER CLAD GND ROD AS SHOWN ON PLAN (NON-LINEAR). TYPICAL FOR ALL GROUND RODS SHOWN. USE STAINLESS STEEL HARDWARE

- 11. ELECTRICAL CONTRACTOR SHALL TAKE MEGGER READINGS OF GROUND. THE RESULTS
- ALL CONNECTIONS TO GROUND SYSTEM SHALL BE MADE IN LINE WITH BENDS NOMINAL 12" RADIUS IN THE DIRECTION OF CURRENT FLOW. T-CONNECTIONS WILL NOT BE
- 14. ANTENNA CABLES SHALL BE BONDED AT EACH END. RUNS GREATER THAN 150' SHALL BE BONDED TOWARDS MIDDLE OF LENGTH. COORDINATE LOCATION WITH WIRELESS CARRIER'S PROJECT MANAGER.
- 15. WHEN APPLICABLE, CONTRACTOR SHALL BOND FRAMES TO EACH OTHER AND TO GND RING VIA TWO PATHS. COORDINATE WITH WIRELESS CARRIER PROJECT MANAGER.
- CONTRACTOR CAN PROVIDE ONE OF THE FOLLOWING AS DIRECTED BY THE PROJECT MANAGER: THE SECOND OPTION IS PREFERRED.
  - A. CADWELD EACH CABINET GROUND WIRE TO GROUND RING AS SHOWN IN EQUIPMENT GROUND DETAIL.
  - E. CADWELD EACH WIRE TO A 1/4"X4"X24" MIN. COPPER BUS BAR LOCATED BEHIND RADIO CABINET. EXTEND A #2 WIRE FROM EACH END OF COPPER BUS BAR TO GROUND RING.
- 17. PROVIDED BRAIDED BONDING JUMPERS BETWEEN EACH GATE AND POST (OPTIONAL).
- 19. CONTRACTOR SHALL PROVIDE EXOTHERMIC BONDING AT ALL BURIED GROUND RING CONNECTIONS, STRUCTURAL EQUIPMENT FRAME, SERVICE RACK(S), EXISTING TOWER GROUND RINGS, AND AS INSTRUCTED BY METROPCS CPM.
- CONTRACTOR SHALL PROVIDE MECHANICAL BONDING AT ALL ANTENNA SECTOR GROUND BARS, ALL ELECTRICAL EQUIPMENT DISCONNECTS, TRANSFORMERS, J-BOXES, PANEL-BOARDS, CABINETS, AND MAIN GROUND BAR AS DIRECTED BY METROPCS CPM. ALL MECHANICAL CONNECTIONS SHALL BE PROPERLY TERMINATED W/ LUGS, NUTS & BOLTS.
- 21. CONTRACTOR SHALL COAT WITH NOX-OX ALL POINTS OF CONTACT BETWEEN DISSIMILAR METALS.

AMERICAN WIRE GAUGE

BCW BARE COPPER WIRE

RACEWAY

ABBREVIATIONS

RIGID GALVANIZED STEEL

ELECTRICAL METALLIC TUBING DRAWING

LIGHTNING PROTECTION SYSTEM

STAINLESS STEEL

CURRENT LIMITING FUSE CONST. PROJ. MANAGER

CADWELD TYPE CONNECTION

5/8" X10'-0" COPPERCLAD GRND. ROD W/INSP. SLEEVE

O 5/8" X10'-0" COPPERCLAD GRND. ROD

■ MECHANICAL TYPE CONNECTION

--- #2 TINNED SOLID BARE CU WIRE

--- UNDER GROUND TELCO CONDUIT

--- UNDER GROUND ELECTRIC CONDUIT

(CO1) CONDUIT TAG 1; REFER TO RISER M-1,3 CONDUIT TAG 1; PANEL SCHEDULE



GENERATOR RECEPTACLE

#### **APPLICANT/OWNER:**



777 YAMATO ROAD, SUITE 600 **BOCA RATON, FLORIDA 33431** 

#### PROJECT NAME AND LOCATION:

**CASA MARINA VERIZON SITE #62335 1500 REYNOLDS STREET** KEY WEST, FL 33040

#### **PROJECT ENGINEER**



ENGINEERING AND EQUIPMENT LLC 820 W. INDIANTOWN ROAD, SUITE 105 JUPITER, FLORIDA 33458 FLORIDA CA#29673

#### **ENGINEER SEAL**

RUSSELL C. MORRISON, P.E. FLORIDA P.E. #51567

#### DATE OF ISSUE

JUNE 5, 2014

#### **ISSUED FOR**

CONSTRUCTION PLANS

# SUBMITTALS REV. DATE DESCRIPTION

#### **PROJECT NUMBER** L201403-09

DRAWN BY CHECKED APPROVED KJM

# APPROVING AGENCY

CITY OF KEY WEST, FLORIDA

#### **BUILDING CODE**

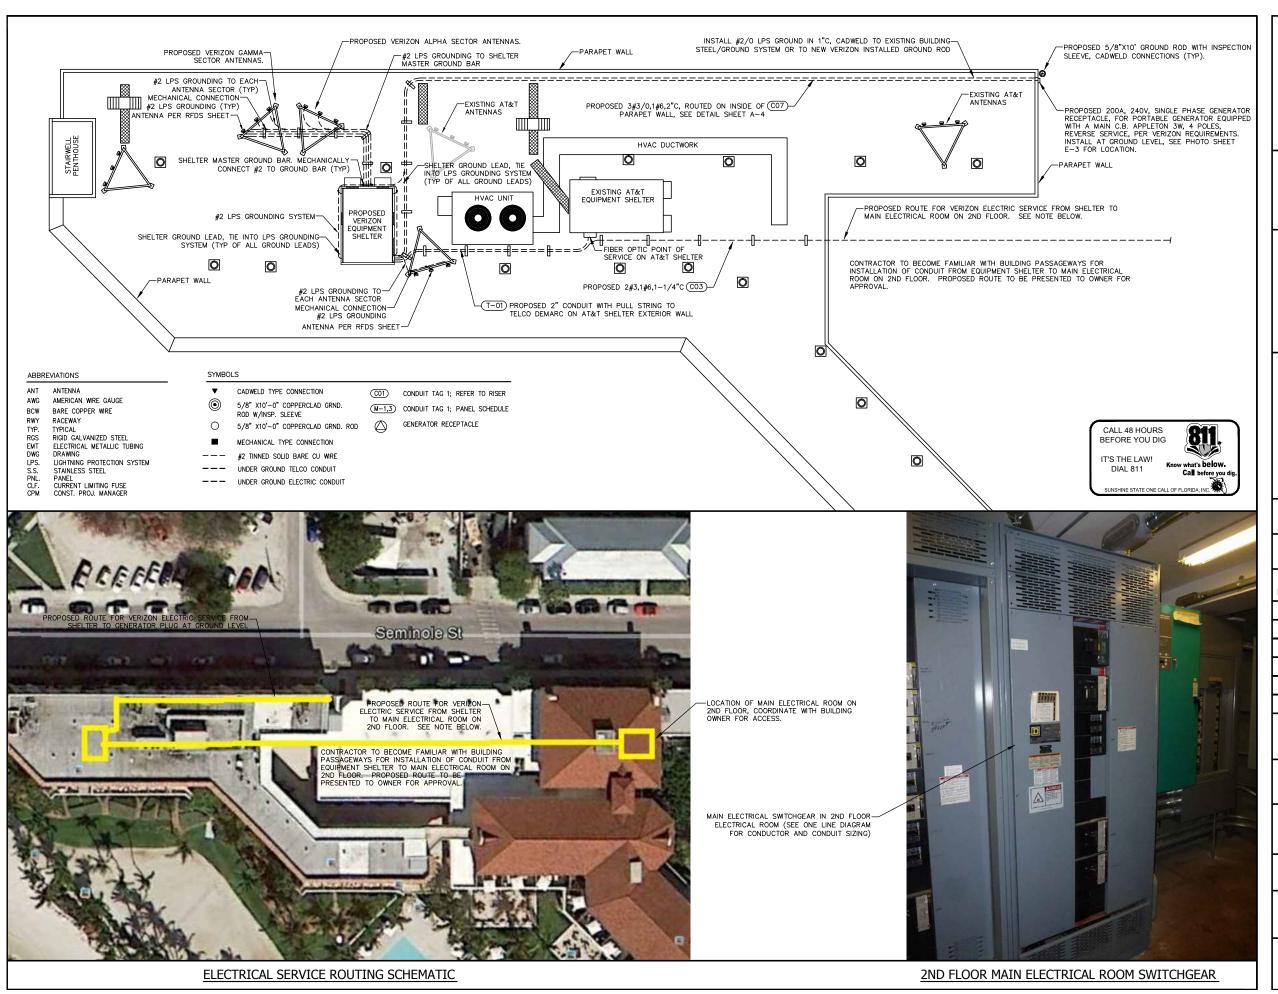
2010 FLORIDA BUILDING CODE

#### SHEET TITLE

**ELECTRICAL NOTES** 

# **SHEET NUMBER**

**ELECTRICAL SYSTEM NOTES** 



APPLICANT/OWNER:



777 YAMATO ROAD, SUITE 600 BOCA RATON, FLORIDA 33431

#### **PROJECT NAME AND LOCATION:**

CASA MARINA VERIZON SITE #62335 1500 REYNOLDS STREET KEY WEST, FL 33040

#### PROJECT ENGINEER



# **WAYPOINT**

ENGINEERING AND EQUIPMENT LLC 820 W. INDIANTOWN ROAD, SUITE 105 JUPITER, FLORIDA 33458 PHONE: 561-252-1220 FLORIDA CA#29673

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KJM

# APPROVING AGENCY CITY OF KEY WEST, FLORIDA

CITY OF KEY WEST, FLORIDA

# BUILDING CODE

2010 FLORIDA BUILDING CODE

#### SHEET TITLE

ELECTRICAL SITE AND GROUNDING PLAN

#### SHEET NUMBER

F-2

#### 240V LOAD CALCULATION

LOAD	AMPS
VERIZON WIRELESS CONNECTED LOAD	75
TOTAL	75

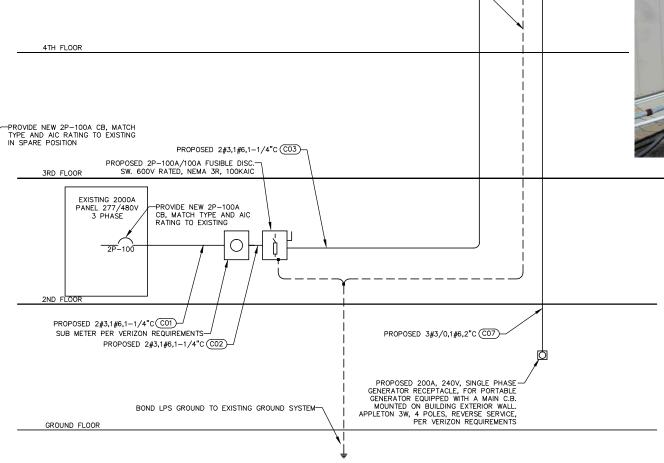
VOLTAGE PROVIDED: 240V, SINGLE PHASE, 3 WRE, AMPS PROVIDED: 200AMPS, 1C/PHASE, 3/0 CU

AT&T TELCO DEMARC ON--VERIZON ATS (SUPPLIED WITH SHELTER) PROPOSED 3#3/0,1#6,2"C CO6-AT&T SHELTER WALL PROPOSED 2P-200A/200A FUSIBLE DISC. SW., NEMA 3R, 100KAIC-(SUPPLIED WITH SHELTER) EXISTING AT&T SHELTER-PROPOSED 3#3/0,1#6,2"C CO5 —PROPOSED VERIZON EQUIPMENT SHELTER PROPOSED 50KVA, 480V: 120/240V XFMR, WITH RAINSHIELDS-PROPOSED 2#3,1#6,1-1/4"C CO4 PROPOSED 2P-100A/100A NF DISC. SW. 600V-RATED, NEMA 3R, 100KAIC -SEE VERIZON SHELTER PLANS FOR INTERNAL WIRING SCHEMATIC INTERNAL VERIZON TELCO— BACKBOARD (SUPPLIED WITH SHELTER) PROPOSED 2" CONDUIT WITH PULL STRING TO T-01)-TELCO DEMARC ON AT&T SHELTER EXTERIOR WALL ROOF LEVEL

CONTRACTOR SHALL PROVIDE A RECORDING AMPMETER FOR 30 DAYS MIN. PER NEC 220-87. CONTRACTOR TO SUBMIT TO ENGINEER/OWNER THE MAXIMUM RECORDED VALUE OF THE HIGHEST AMP LOAD. THE EXISTING MAXIMUM DEMAND SHALL BE MULTIPLIED BY 125%. THE NEW LOAD SHALL BE ADDED TO THE MAXIMUM LOAD X 125%. THIS NEW TOTAL VALUE SHALL BE LESS THAN 80% OF THE AMP RATING OF THE SERVICE CONDUCTORS. DO NOT BEGIN OTHER WORK UNTIL THESE REQUIREMENTS ARE MET.



2000A 277/480V PANEL MAIN ELECTRICAL ROOM



INSTALL #2/O LPS GROUND, CADWELD TO-EXISTING BUILDING STEEL/GROUND SYSTEM OR TO NEW VERIZON INSTALLED GROUND ROD



-AT&T TELCO DEMARC ON AT&T SHELTER WALL

ELECTRICAL AND TELCO RISER DIAGRAM

#### APPLICANT/OWNER:



777 YAMATO ROAD, SUITE 600 Boca Raton, Florida 33431

#### PROJECT NAME AND LOCATION:

CASA MARINA VERIZON SITE #62335 1500 REYNOLDS STREET KEY WEST, FL 33040

#### PROJECT ENGINEER



# WAYPOIN'

ENGINEERING AND EQUIPMENT LLC 820 W. INDIANTOWN ROAD, SUITE 105 JUPITER, FLORIDA 33458 PHONE: 561-252-1220 FLORIDA CA#29673

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# APPROVING AGENCY CITY OF KEY WEST, FLORIDA

CITY OF KEY WEST, FLORIL

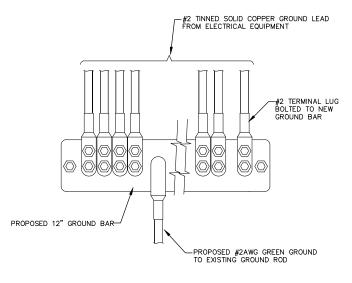
#### **BUILDING CODE** 2010 FLORIDA BUILDING CODE

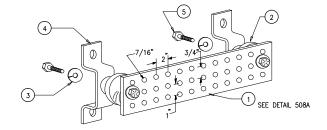
# SHEET TITLE ELECTRICAL RISER

TELCO RISER

#### SHEET NUMBER


E-3






LEGEND

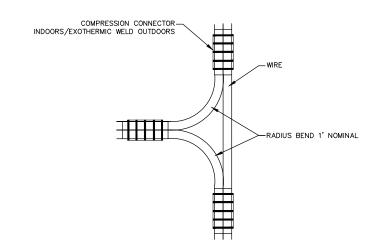- 1- COPPER GROUND BAR, 1/4"X 4"X 20", NEWTON INSTRUMENT CO. CAT. NO. B-6142 OR EQUAL. HOLE CENTERS TO MATCH NEMA DOUBLE LUG CONFIGURATION
- 2- INSULATORS, NEWTON INSTRUMENT CAT. NO. 3061-4
- 3- 5/8" LOCKWASHERS, NEWTON INSTRUMENT CO. CAT. NO. 3015-8
- 4- WALL MOUNTING BRACKET, NEWTON INSTRUMENT CO. CAT NO. A-6056 5- 5/8-11 X 1" HHCS BOLTS, NEWTON INSTRUMENT CO. CAT NO. 3012-1
- 6- INSULATORS SHALL BE ELIMINATED WHEN BONDING DIRECTLY TO TOWER/MONOPOLE STRUCTURE. CONNECTION TO TOWER/MONOPOLE STRUCTURE SHALL BE PER MANUFACTURERS RECOMMENDATIONS




#### NON-DIRECTIONAL SPLICE

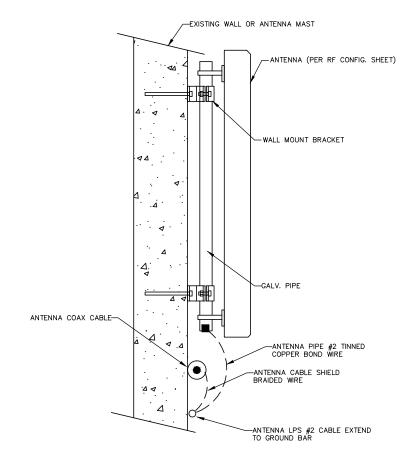**GROUND BAR DETAIL** 



**ANTENNA LPS DETAIL** 

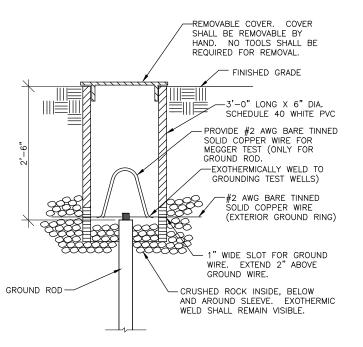

**GROUND ROD INSPECTION SLEEVE DETAIL** 

#### **ELECTRICAL DETAILS**

#### **APPLICANT/OWNER:**



777 YAMATO ROAD, SUITE 600 BOCA RATON, FLORIDA 33431

#### **PROJECT NAME AND LOCATION:**

**CASA MARINA VERIZON SITE #62335 1500 REYNOLDS STREET** KEY WEST, FL 33040

#### **PROJECT ENGINEER**



ENGINEERING AND EQUIPMENT LLC 820 W. INDIANTOWN ROAD, SUITE 105 JUPITER, FLORIDA 33458 PHONE: 561-252-1220 FLORIDA CA#29673

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RUSSELL C. MORRISON, P.E. FLORIDA P.E. #51567

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CITY OF KEY WEST, FLORIDA

#### **BUILDING CODE**

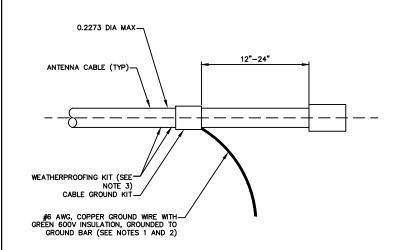
2010 FLORIDA BUILDING CODE

#### SHEET TITLE

**ELECTRICAL DETAILS** 

#### SHEET NUMBER

E-4




- 1. DO NOT INSTALL CABLE GROUND KIT AT A BEND AND ALWAYS DIRECT GROUND WIRE DOWN TO GROUND BAR
- 2. GROUND KIT WILL BE TYPE AND PART NUMBER AS SUPPLIED OR RECOMMENDED BY CABLE MANUFACTURER
- 3. WEATHER PROOFING SHALL BE TYPE AND PART NUMBER AS SUPPLIED OR RECOMMENDED BY CABLE MANUFACTURER

#### **CONNECTION OF GROUND CABLE** KIT TO ANTENNA CABLE

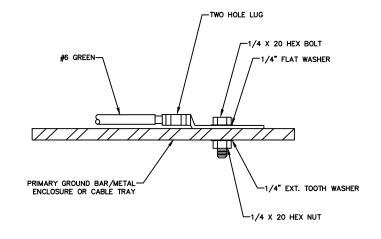
-GROUNDING CLAMP (TYP)

1/8" MIN, 1/4" MAX



- 1. CHOOSE BOLT LENGTH TO ALLOW FOR A MINIMUM OF 2 EXPOSED THREADS
- 2. BURNISH MOUNTING AREA TO REMOVE PAINT OR SCALING IN AREA FOR LUG TO BE MOUNTED
- 3. APPLY ANTI OXIDANT COMPOUND TO MATING SURFACE OF LUG AND WIPE CLEAN EXCESS COMPOUND
- 4. USE SOLID COPPER WIRE AND TWO HOLE LUG FOR ALL EXTERIOR GROUNDING APPLICATIONS

#### **GROUNDING CONNECTION DETAIL**

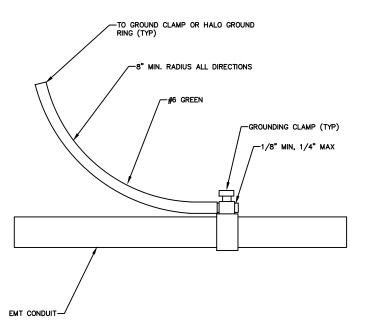


**CONDUIT BOND DETAIL** 

-COUPLING

#6 GREEN-

EMT CONDUIT

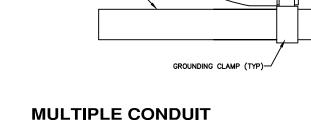**CONDUIT BOND DETAIL** 




# PIPE SUPPORT DETAIL

CONDUIT (SIZE SPECIFIED)

-CABLE (AS SPECIFIED)

-3/8" FULL THREADED ROD

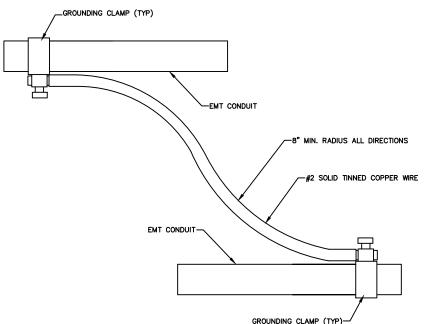PIPE SUPPORT FOR PIPE SIZE SPECIFIED



**GROUNDING DETAIL** 





777 YAMATO ROAD, SUITE 600 BOCA RATON, FLORIDA 33431

#### PROJECT NAME AND LOCATION:

CASA MARINA **VERIZON SITE #62335 1500 REYNOLDS STREET** KEY WEST, FL 33040

#### **PROJECT ENGINEER**



ENGINEERING AND FOLIPMENT LLC 820 W. INDIANTOWN ROAD, SUITE 105 JUPITER, FLORIDA 33458 PHONE: 561-252-1220 FLORIDA CA#29673

#### **ENGINEER SEAL**

RUSSELL C. MORRISON, P.E. FLORIDA P.E. #51567

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L201403-09

# DRAWN BY CHECKED APPROVED

#### **APPROVING AGENCY**

CITY OF KEY WEST, FLORIDA

#### **BUILDING CODE**

2010 FLORIDA BUILDING CODE

#### SHEET TITLE

**ELECTRICAL DETAILS** 

#### **SHEET NUMBER**

E-5





APPLICANT/OWNER:



777 YAMATO ROAD, SUITE 600 BOCA RATON, FLORIDA 33431

#### PROJECT NAME AND LOCATION:

**CASA MARINA** VERIZON SITE #62335 **1500 REYNOLDS STREET** KEY WEST, FL 33040

PROJECT ENGINEER



ENGINEERING AND EQUIPMENT LLC 820 W. INDIANTOWN ROAD, SUITE 105 JUPITER, FLORIDA 33458 PHONE: 561-252-1220 FLORIDA CA#29673

**ENGINEER SEAL** 

RUSSELL C. MORRISON, P.E. FLORIDA P.E. #51567

# DATE OF ISSUE

AUGUST 15, 2014

#### ISSUED FOR

ZONING DOCUMENTS

SUBMITTALS						
REV.	DATE	DESCRIPTION				

#### **PROJECT NUMBER**

L201306-04

DRAWN BY CHECKED APPROVED

#### **APPROVING AGENCY** CITY OF KEY WEST, FLORIDA

#### **BUILDING CODE**

2010 FLORIDA BUILDING CODE


# SHEET TITLE

PHOTO SIMULATION **EXHIBIT** 

#### SHEET NUMBER

A-2C

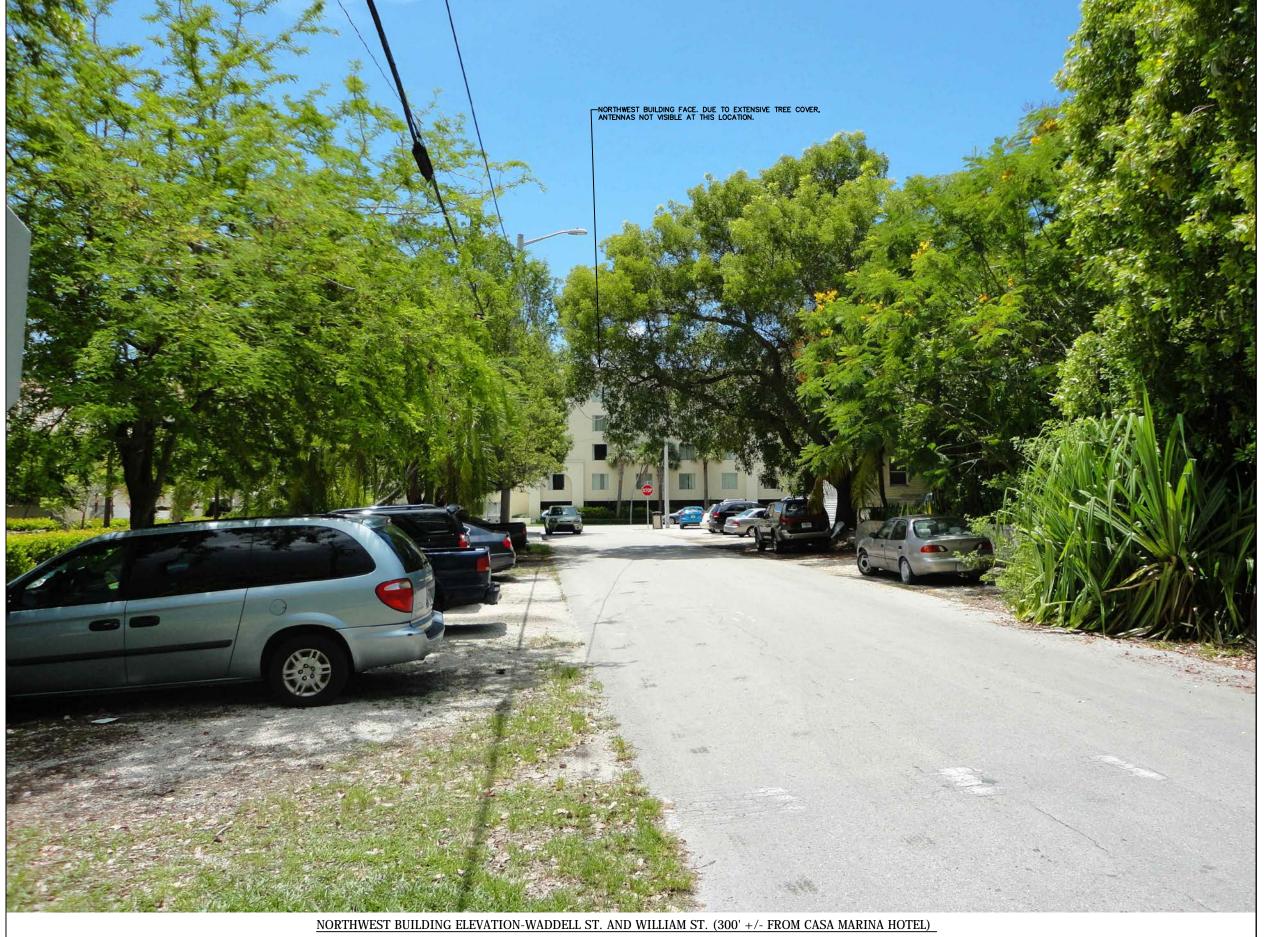PHOTO SIMULATION-CASA MARINA-1500 REYNOLDS STREET, KEY WEST, FLORIDA



APPLICANT/OWNER:



777 YAMATO ROAD, SUITE 600 Boca Raton, Florida 33431

#### PROJECT NAME AND LOCATION:

CASA MARINA VERIZON SITE #62335 1500 REYNOLDS STREET KEY WEST, FL 33040

PROJECT ENGINEER



# WAYPOIN

ENGINEERING AND EQUIPMENT LLC 820 W. INDIANTOWN ROAD, SUITE 105 JUPITER, FLORIDA 33458 PHONE: 561-252-1220 FLORIDA CA#29673

**ENGINEER SEAL** 

RUSSELL C. MORRISON, P.E. FLORIDA P.E. #51567

# DATE OF ISSUE

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#### ISSUED FOR

ZONING DOCUMENTS

_	SUBMITTALS							
REV.	DATE	DESCRIPTION						

#### PROJECT NUMBER

L201306-04

#### DRAWN BY CHECKED APPROVED

CMO

RCM

APPROVING AGENCY
CITY OF KEY WEST, FLORIDA

#### **BUILDING CODE**

2010 FLORIDA BUILDING CODE

#### SHEET TITLE

PHOTO SIMULATION EXHIBIT

#### SHEET NUMBER

A-2D

PHOTO SIMULATION-CASA MARINA-1500 REYNOLDS STREET, KEY WEST, FLORIDA

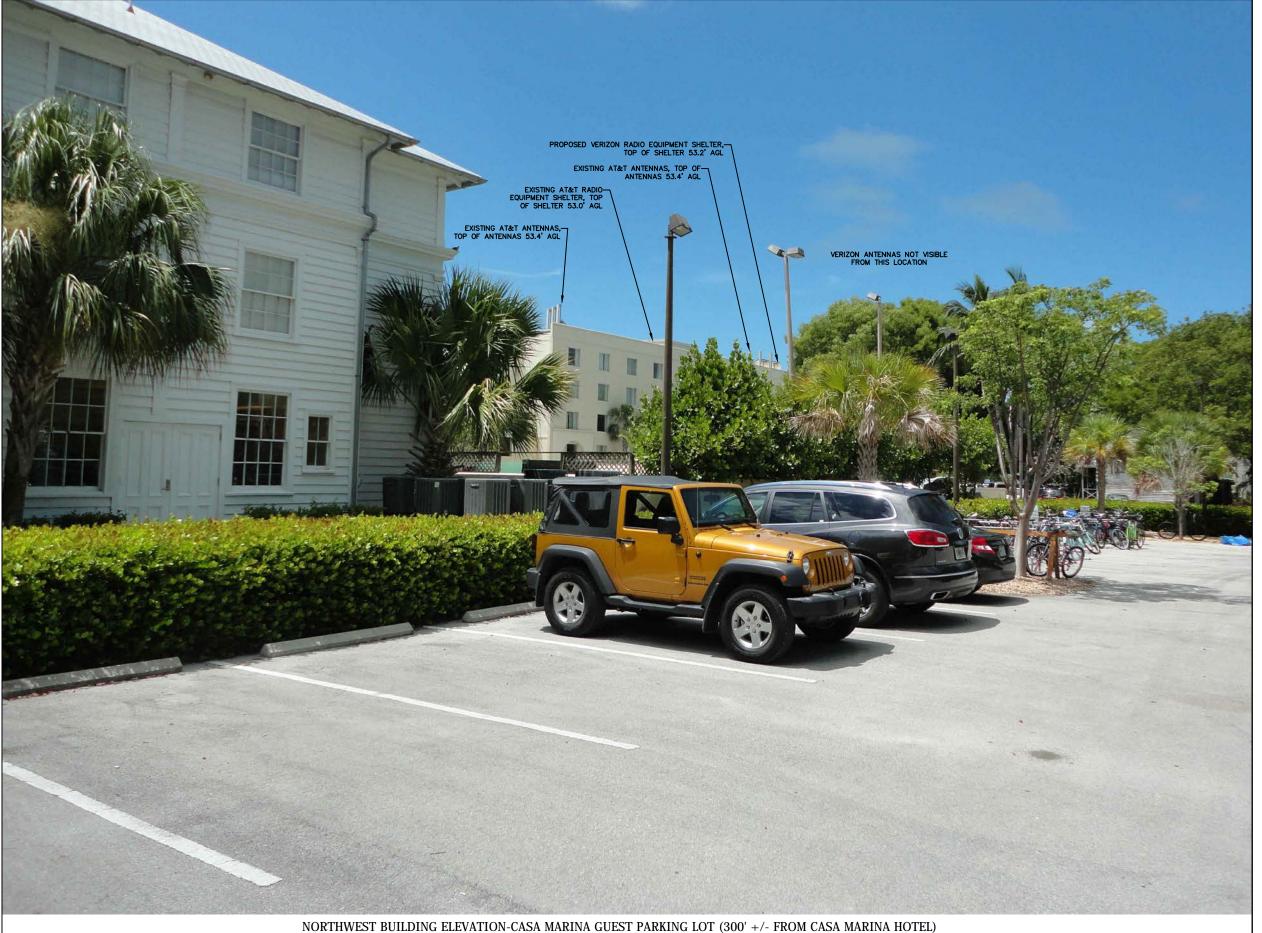


PHOTO SIMULATION-CASA MARINA-1500 REYNOLDS STREET, KEY WEST, FLORIDA

#### APPLICANT/OWNER:



777 YAMATO ROAD, SUITE 600 Boca Raton, Florida 33431

#### **PROJECT NAME AND LOCATION:**

CASA MARINA VERIZON SITE #62335 1500 REYNOLDS STREET KEY WEST, FL 33040

#### PROJECT ENGINEER



# WAYPOINT

ENGINEERING AND EQUIPMENT LLC 820 W. INDIANTOWN ROAD, SUITE 105 JUPITER, FLORIDA 33458 PHONE: 561-252-1220 FLORIDA CA#29673

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CMO

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APPROVING AGENCY
CITY OF KEY WEST, FLORIDA

#### BUILDING CODE

2010 FLORIDA BUILDING CODE

#### SHEET TITLE

PHOTO SIMULATION EXHIBIT

#### SHEET NUMBER

A-2E



NORTHEAST AND NORTHWEST BUILDING ELEVATION-SEMINOLE ST. AND REYNOLDS ST. (400' +/- FROM CASA MARINA HOTEL)

PHOTO SIMULATION-CASA MARINA-1500 REYNOLDS STREET, KEY WEST, FLORIDA

#### APPLICANT/OWNER:



777 YAMATO ROAD, SUITE 600 BOCA RATON, FLORIDA 33431

#### PROJECT NAME AND LOCATION:

CASA MARINA VERIZON SITE #62335 1500 REYNOLDS STREET KEY WEST, FL 33040

#### PROJECT ENGINEER



# WAYPOINT

ENGINEERING AND EQUIPMENT LLC 820 W. INDIANTOWN ROAD, SUITE 105 JUPITER, FLORIDA 33458 PHONE: 561-252-1220 FLORIDA CA#29673

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			_			

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# APPROVING AGENCY CITY OF KEY WEST, FLORIDA

,

# BUILDING CODE

2010 FLORIDA BUILDING CODE

# SHEET TITLE

PHOTO SIMULATION EXHIBIT

#### SHEET NUMBER

A-2F



NORTHWEST BUILDING ELEVATION-ALBERTA ST. AND WASHINGTON ST. (600' +/- FROM CASA MARINA HOTEL)
PHOTO SIMULATION-CASA MARINA-1500 REYNOLDS STREET, KEY WEST, FLORIDA

#### APPLICANT/OWNER:



777 YAMATO ROAD, SUITE 600 BOCA RATON, FLORIDA 33431

#### PROJECT NAME AND LOCATION:

CASA MARINA VERIZON SITE #62335 1500 REYNOLDS STREET KEY WEST, FL 33040

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CMO RCM

# APPROVING AGENCY CITY OF KEY WEST, FLORIDA

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# BUILDING CODE

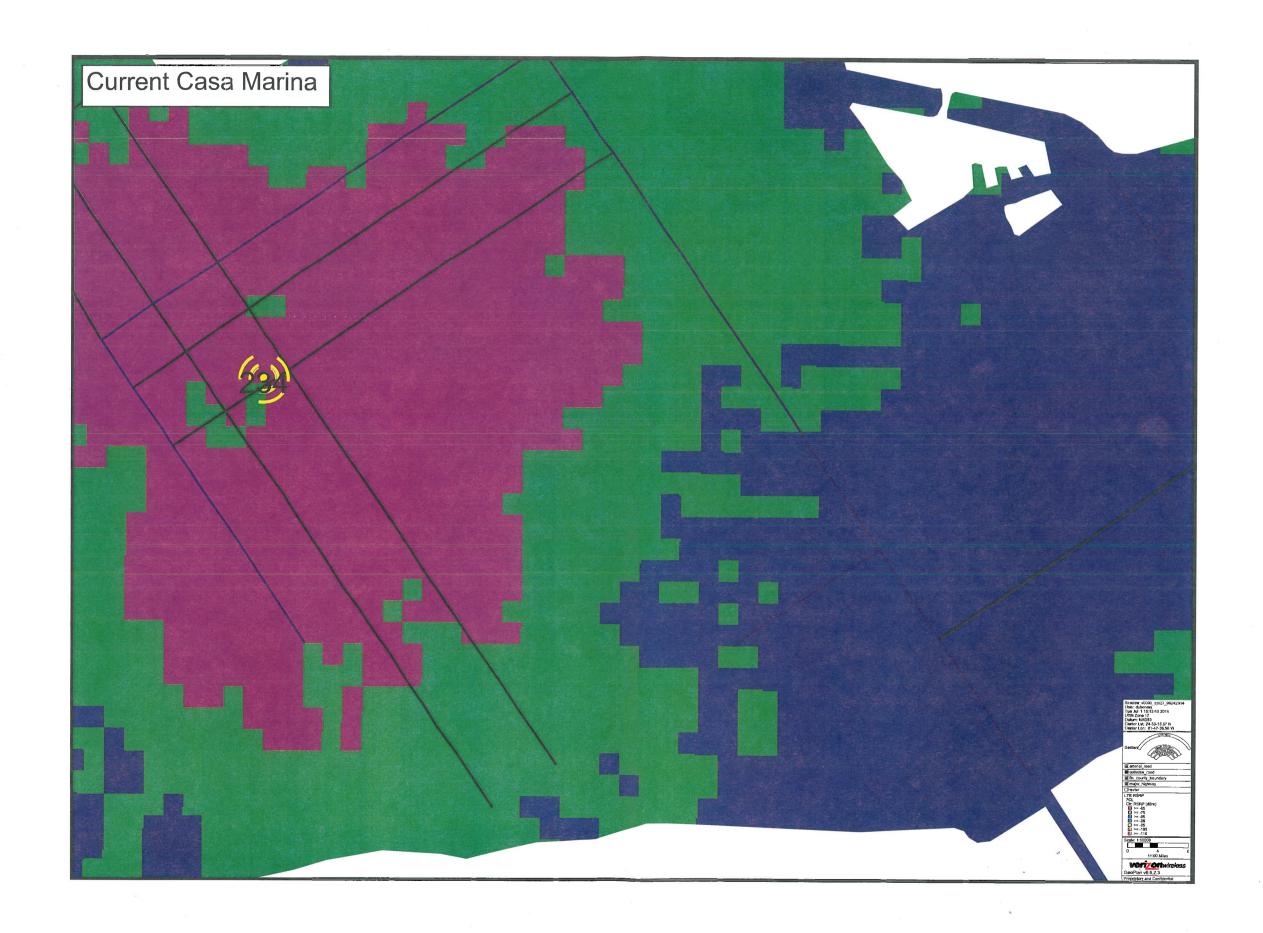
2010 FLORIDA BUILDING CODE

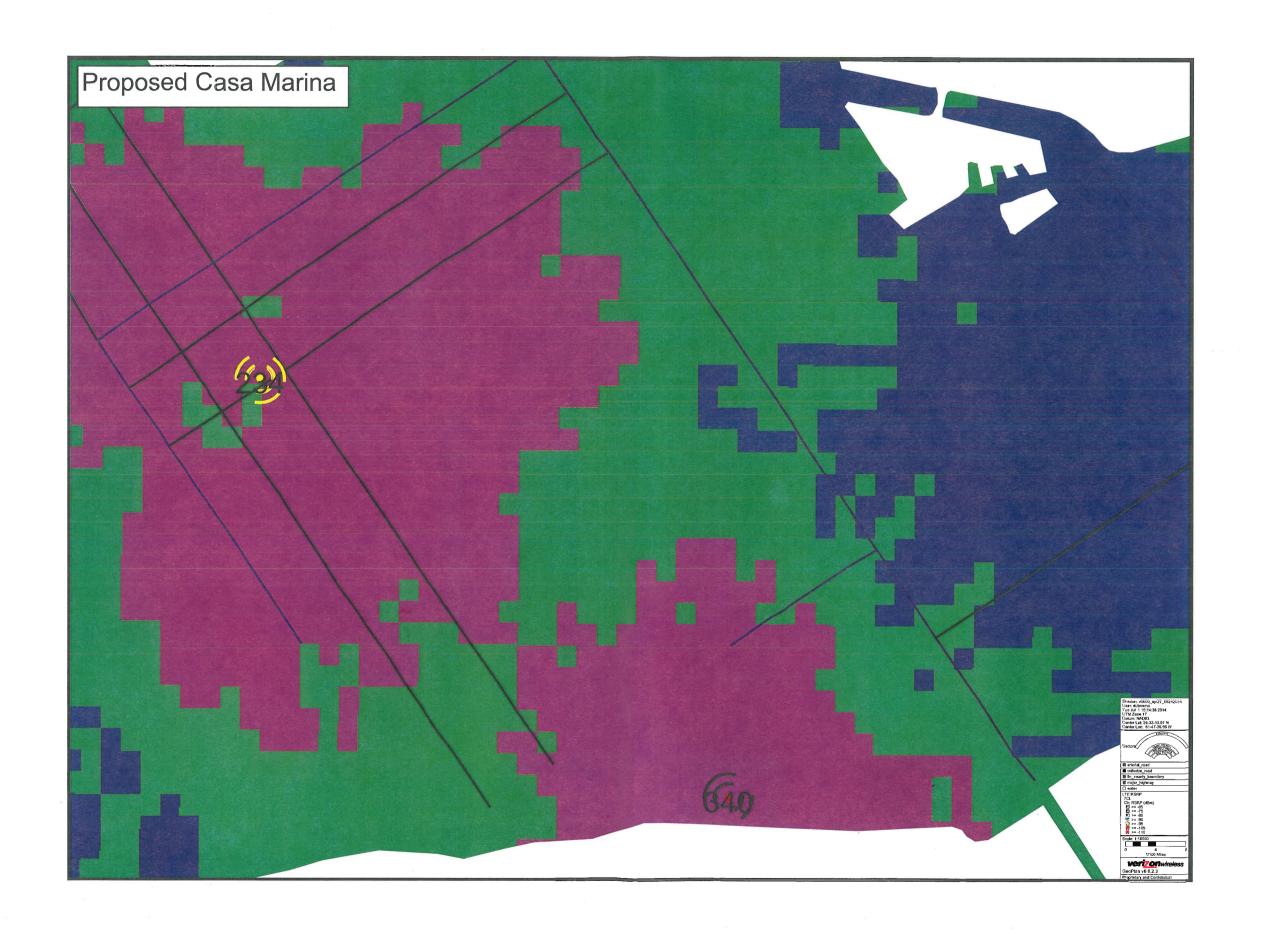
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PHOTO SIMULATION EXHIBIT

#### SHEET NUMBER

A-2G









# **AXP19-60** Xpol, 60° H-Beams


1710-2170 MHz

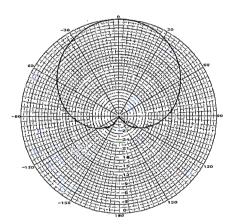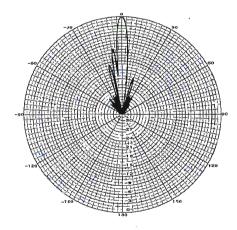Electrical Specifications		Mechanical Specifications	Link to Mechanical Drawing
Frequency	1710-2170 MHz	Input Connector (female)	Back 7/16 DIN or w/bot. opt.
Polarization	Slant +/- 45	Antenna Dimensions (LxWxD)	69.1 x 6.7 x 4.1 in. (1755 x 170 x 104mm)
Gain @ 1710 MHz	19.0 dBi	Antenna Dimensions with Opt-"ip"	69.1 x 6.7 x 4.5 in. (1755 x 170 x 114mm)
Gain @ 1920 MHz	19.3 dBi	*Antenna Weight	15.0 lbs
Gain @ 2170 MHz	19.6 dBi	Bracket Weight	13.2 lbs
Horizontal Beam (3dB Points)	60°	RF Distribution	Printed Microstrip Substrate
Vertical Beam (3dB Points)	5°	Radome	Ultra High-Strength Luran
Elect. Downtilt Range, 2º Increments	0-6°	Weatherability	UV Stabilized, ASTM D1925
VSWR / Return Loss	<1.40:1 / 15.6 dB	Radome Water Absorption	ASTM D570, 0.45%
VSWR / Return Loss w/ip	<1.50:1 / 14.0 dB	Environmental	MIL-STD-810E
Front-to-Back at Horizon	>30 dB	Wind Survival	150 mph
Upper Side Lobe Suppression	<-18 dB	Front Wind Load @100mph	105 lbf
Impedance	50 Ohms	Equivalent Flat Plate @100mph	2.13 sq-ft. (c=2)
Power Input Per Connector	250 CW at 1900 MHz	Mounting Brackets	Fits 3.5 Inch Max. O.D. Pipe
Isolation	< -28 dB	Mechanical Downtilt Range	0-12°·
Intermodulation (2x20W)	typ -150 dBc	Clamps/Bolts	Galvanized Steel/Stainless Steel





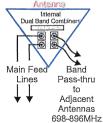**Available with Integrated Diplexers** and back mounted connectors, bottom mounted connectors are not available with Integrated Diplexers



Integrated Pass-Thru Diplexers will work with TMA's

Recommended Connector Coupling Torque 7/16 DIN: 220-265 lbf-in (25-30 N-m)

#### Ordering Information & Options

AXP19-60-X

Published 120512

Subject to alteration.

"-x" is a placeholder for the built-in fixed electrical downtilt in degrees, set to 0, 2, 4 or 6

www.cssantenna.com

AXP19-60-xip AXP19-60-x-bot "ip" option includes pass-thu integrated diplexer(s) which pass DC to the diplexer port(s)

for bottom mounted connectors, add "-bot" (otherwise antenna comes standard with back mounted connectors)



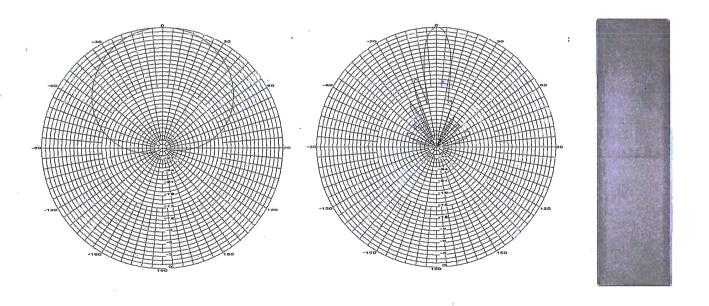


# X7-665 Xpol, 65° H-Beam

698-800 MHz

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				elsin tirridi.		de discourse	

Electrical Specifications		Mechanical Specifications	Link to Mechanical Drawing
Frequency	698-800 MHz	Input Connector (female)	Back 7/16 DIN or w/bot. opt.
Polarization	Slant +/- 45	Antenna Dimensions (LxWxD)	72.0 x 12.5 x 7.1 in. (1829 x 318 x 180mm
Gain @ 698 MHz	15.3 dBi	*Antenna Weight	30.0 lbs
Gain @ 752 MHz	15.6 dBi	Bracket Weight	13.2 lbs
Gain @ 782 MHz	15.8 dBi	Lightning Protection	Direct Ground
Horizontal Beam (3dB Points)	65°	RF Distribution	Printed Microstrip Substrate
Vertical Beam (3dB Points)	10°	Radome	Ultra High-Strength Luran
Elect. Downtilt Range, 2° Increments	0-10°	Weatherability	UV Stabilized, ASTM D1925
VSWR / Return Loss	<1.40:1 / 15.6 dB	Radome Water Absorption	ASTM D570, 0.45%
Front-to-Back at Horizon	>30 dB	Environmental	MIL-STD-810E
Upper Side Lobe Suppression	<-18 dB	Wind Survival	150 mph
Impedance	50 Ohms	Front Wind Load @100mph	177.4 lbf
Power Input Per Connector	500 CW at 800 MHz	Equivalent Flat Plate @100mph	3.6 sq-ft. (c=2)
Isolation	<-28 dB	Mounting Brackets	Fits 3.5 Inch Max. O.D. Pipe
Intermodulation (2x20W)	<-150 dBc	Mechanical Downtilt Range	0-12°
		Clamps/Bolts	Galvanized Steel/Stainless Steel



Recommended Connector Coupling Torque 7/16 DIN: 220-265 lbf-in (25-30 N-m)

#### Ordering Information & Options

X7-665-X X7-665-x-bot "-x" is a placeholder for the built-in fixed electrical downtilt in degrees, set to 0, 2, 4, 6, 8 or 10

for bottom mounted connectors, add "-bot" (otherwise antenna comes standard with back mounted connectors)





www.cssantenna.com

<sup>\*</sup>Antenna Weight may vary slightly with options.

<sup>\*</sup>Antenna Weight may vary slightly with options.

# **Property Appraiser Record Card**



Key West (305) 292-3420 Marathon (305) 289-2550 Plantation Key (305) 852-7130

# **Property Record Card -**

Website tested on IE8, IE9, & Firefox. Requires Adobe Flash 10.3 or higher

Maps are now launching the new map application version.

Alternate Key: 8735677 Parcel ID: 00037160-000100

#### **Ownership Details**

Mailing Address:

CASA MARINA OWNER LLC PO BOX 437 BROADWAY, NJ 08808-0437

#### **Property Details**

PC Code: 39 - HOTELS, MOTELS

Millage Group: 10KW

Affordable No
Housing:
SectionTownship: 05-68-2

**Township-** 05-68-25

Range:

**Property** 1500 REYNOLDS ST KEY WEST **Location:** 811 SEMINOLE ST KEY WEST

Legal KW KW INVESTMENT CO SUB PB1-69 SQRS 1 THRU 5 & PT SQR 6 & SQR 7 TR 17 G6-103 G37-65/67 G70-508/9 OR175-Description: 144/45 OR214-88/89 OR274-337/38 OR332-35 OR387-997/99 OR388-826/28 OR399-599/600 OR427-61/62 OR534-1098 OR660-

860/887 OR695-8/9OR1033-627/632 OR1033-633/648 OR1033-649/664 OR1350-357/368(LEASE) OR1350-385/91-C OR1359-745/774(LEASE) OR1436-592/597OR1436-598/608 OR1437-275/278Q/C OR1624-743/763(LEASE) OR1624-764/779(LEASE) OR1437-275/278Q/C OR1624-743/763(LEASE) OR1624-764/779(LEASE) OR1624-764/

OR1701-931/932Q/C OR2115-141/147 OR2326-1954/1959(REST) OR2347-648/666(II LEASE) OR2414-19/25(REST)

# Click Map Image to open interactive viewer S7\_T688\_R29E S8\_T688\_R25E

#### **Land Details**

Land Use Code	Frontage	Depth	Land Area
100W - COMMERCIAL WATERFRON	0	0	290,110.00 SF
100D - COMMERCIAL DRY	0	0	83,000.00 SF

# **Building Summary**

Number of Buildings: 7 Number of Commercial Buildings: 7 Total Living Area: 183188

Year Built: 1901

#### **Building 1 Details**

Building TypeCondition GQuality Grade 450Effective Age 20Perimeter 918Depreciation % 23Year Built 1901Special Arch 0Grnd Floor Area 11,610

Functional Obs 0 Economic Obs 0

Inclusions:

 Roof Type
 Roof Cover
 Foundation

 Heat 1
 Heat 2
 Bedrooms 0

 Heat Src 1
 Heat Src 2

**Extra Features:** 

 2 Fix Bath
 0
 Vacuum
 0

 3 Fix Bath
 0
 Garbage Disposal
 0

 4 Fix Bath
 0
 Compactor
 0

 5 Fix Bath
 0
 Security
 0

 6 Fix Bath
 0
 Intercom
 0

 7 Fix Bath
 0
 Fireplaces
 0

 Extra Fix
 9
 Dishwasher
 0



#### Sections:

	Nbr	Type	Ext Wall	# Stories	Year Built	Attic A/C	Basement %	Finished Basement %	Area
	1	FLA		1	1986				3,870
П									-

2	FLA	1	1986	3,870	
3	FLA	1	1986	3,870	

#### Interior Finish:

Section Nbr	Interior Finish Nbr	Туре	Area %	Sprinkler	A/C
	15708	WAREHOUSE/MARINA A	100	N	Ν
	15709	WAREHOUSE/MARINA A	100	N	N
	15710	WAREHOUSE/MARINA A	100	N	N

#### **Exterior Wall:**

Interior Finish Nbr	Туре	Area %
5411	MIN WOOD SIDING	100

# **Building 2 Details**

Building Type Effective Age 18 Year Built 1916 Functional Obs 0 Condition G Perimeter 1,213 Special Arch 0 Economic Obs 0 Quality Grade 450 Depreciation % 23 Grnd Floor Area 92,058

Inclusions:

Roof Type Heat 1 Heat Src 1 Roof Cover Heat 2 Heat Src 2 Foundation Bedrooms 0

**Extra Features:** 

2 Fix Bath 0 3 Fix Bath 0 4 Fix Bath 0 5 Fix Bath 0 6 Fix Bath 0 7 Fix Bath 0 Extra Fix 0 
 Vacuum
 0

 Garbage Disposal
 0

 Compactor
 0

 Security
 0

 Intercom
 0

 Fireplaces
 0

 Dishwasher
 0

No sketch available to display

Sections:

Nbr	Type	Ext Wall	# Stories	Year Built	Attic A/C	Basement %	Finished Basement %	Area
1	FLA		1	1915				92,058
2	CPF		1	1915				405
3	OPF		1	1915				7,084

#### Interior Finish:

Section Nbr	Interior Finish Nbr	Туре	Area %	Sprinkler	A/C
15711		HOTELS/MOTEL A	100	Υ	Υ
	15712	CPF	100	N	N
	15713	OPF	100	N	N

#### **Exterior Wall:**

Interior Finish Nbr	Туре	Area %
5412	REIN CONCRETE	100

# **Building 3 Details**

Building TypeCondition GQuality Grade 450Effective Age 18Perimeter 760Depreciation % 23Year Built 1979Special Arch 0Grnd Floor Area 13,704Functional Obs 0Economic Obs 0

Inclusions:

 Roof Type
 Roof Cover
 Foundation

 Heat 1
 Heat 2
 Bedrooms 0

 Heat Src 1
 Heat Src 2

Extra Features:

 2 Fix Bath
 0
 Vacuum
 0

 3 Fix Bath
 0
 Garbage Disposal
 0

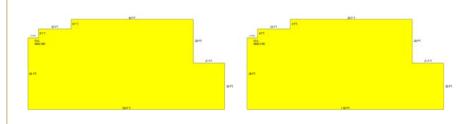
 4 Fix Bath
 0
 Compactor
 0

 5 Fix Bath
 0
 Security
 0

 6 Fix Bath
 0
 Intercom
 0

 7 Fix Bath
 0
 Fireplaces
 0

 Extra Fix
 0
 Dishwasher
 0



#### Sections:

Nbr	Туре	Ext Wall	# Stories	Year Built	Attic A/C	Basement %	Finished Basement %	Area
1	FLA		1	1978				6,852
2	FLA		1	1978				6,852

#### Interior Finish:

Section Nbr	Interior Finish Nbr	Туре	Area %	Sprinkler	A/C
	15714	HOTELS/MOTEL A	100	Υ	Υ
	15715	HOTELS/MOTEL A	100	Υ	Υ

#### **Exterior Wall:**

Interior Finish Nbr	Туре	Area %
5413	C.B.S.	100

# **Building 4 Details**

Building Type	Condition G	Quality Grade 450
Effective Age 18	Perimeter 1,045	Depreciation % 23
Year Built 1979	Special Arch 0	Grnd Floor Area 52,446
Functional Obs 0	Economic Obs 0	

Inclusions:

Foundation	Roof Cover	Roof Type
Bedrooms 0	Heat 2	Heat 1
	Heat Src 2	Heat Src 1

Extra Features:

2 Fix Bath	0	Vacuum	0
3 Fix Bath	160	Garbage Disposal	0
4 Fix Bath	0	Compactor	0
5 Fix Bath	0	Security	0
6 Fix Bath	0	Intercom	0
7 Fix Bath	0	Fireplaces	0
Extra Fix	0	Dishwasher	0

# No sketch available to display

#### Sections:

Nbr	Туре	Ext Wall	# Stories	Year Built	Attic	A/C	Basement %	Finished Basement %	Area
1	SBU		1	1978					5,495
2	SBF		1	1978					5,863
3	FLA		1	1978					1,232
4	OUF		1	1978					30,006
5	EPB		1	1978					1,800
6	FLA		1	1978					51,214
7	PTO		1	1978					13,433

#### Interior Finish:

Section Nbr	Interior Finish Nbr	Туре	Area %	Sprinkler	A/C
	15716	SBU	100	N	N
	15717	SBF	100	N	N
	15718	OFF BLDG 1 STY-A	100	Υ	Υ
	15719	OUF	100	N	N
	15720	EPB	100	N	Υ
	15721	HOTELS/MOTEL A	100	Υ	Υ
	15722	PTO	100	N	N

#### **Exterior Wall:**

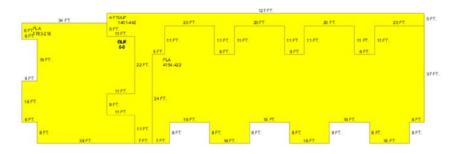
Interior Finish Nbr	Туре	Area %
5414	C.B.S.	100

# **Building 5 Details**

Building Type Effective Age 18 Year Built 1986 Condition E. Perimeter 638
Special Arch 0

Quality Grade 450 Depreciation % 23 Grnd Floor Area 6,972

Functional Obs 0			Economic Obs 0		
	Inclusions:				
	Roof Type		Roof Cover	Foundation	
	Heat 1		Heat 2	Bedrooms 0	
	Heat Src 1		Heat Src 2		
	Extra Features:				
	2 Fix Bath	0		Vacuum	0
	3 Fix Bath	0		Garbage Disposal	0
	4 Fix Bath	0		Compactor	0
	5 Fix Bath	0		Security	0
	6 Fix Bath	0		Intercom	0
	7 Fix Bath	0		Fireplaces	0
	Extra Fix	252		Dishwasher	0



#### Sections:

Nbr	Туре	Ext Wall	# Stories	Year Built	Attic	A/C	Basement %	Finished Basement %	Area
1	FLA		3	1986					1,783
2	OUF		1	1985					1,401
3	FLA		1	1985					4,154
4	FLA		1	1986					1,035
5	OUF		1	1986					2,760
6	OUF		1	1986					2,802

#### Interior Finish:

Section Nbr	Interior Finish Nbr	Туре	Area %	Sprinkler	A/C
	15723	HOTELS/MOTEL A	100	Υ	Υ
	15724	OUF	100	N	N
	15725	HOTELS/MOTEL A	100	Υ	Υ
	15726	HOTELS/MOTEL A	100	Υ	Υ
	15727	OUF	100	N	N
	15728	OUF	100	N	N

#### **Exterior Wall:**

Interior Finish Nbr	Туре	Area %
5415	CUSTOM	100

# **Building 6 Details**

Building Type Condition G Quality Grade 450
Effective Age 18 Perimeter 592 Depreciation % 23
Year Built 1986 Special Arch 0 Grnd Floor Area 5,822
Functional Obs 0 Economic Obs 0

Inclusions:

 Roof Type
 Roof Cover
 Foundation

 Heat 1
 Heat 2
 Bedrooms 0

 Heat Src 1
 Heat Src 2

Extra Features:

 2 Fix Bath
 0
 Vacuum
 0

 3 Fix Bath
 0
 Garbage Disposal
 0

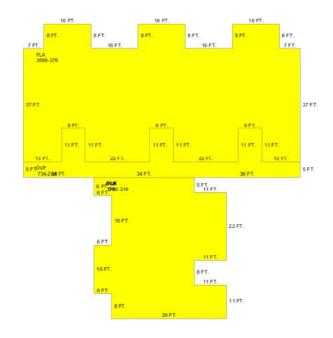
 4 Fix Bath
 0
 Compactor
 0

 5 Fix Bath
 0
 Security
 0

 6 Fix Bath
 0
 Intercom
 0

 7 Fix Bath
 0
 Fireplaces
 0

 Extra Fix
 0
 Dishwasher
 0



#### Sections:

Nbr	Type	Ext Wall	# Stories	Year Built	Attic A/C	Basement %	Finished Basement %	Area
1	FLA		3	1986				1,783
2	FLA		3	1986				3,598
3	OUF		1	1986				734
4	OUF		1	1986				1,104
5	OUF		1	1986				1,468
6	FLA		1	1986				441

#### Interior Finish:

Section Nbr	Interior Finish Nbr	Туре	Area %	Sprinkler	A/C

15729	HOTELS/MOTEL A	100	Υ	Y
15730	HOTELS/MOTEL A	100	Υ	Υ
15731	OUF	100	N	N
15732	OUF	100	N	N
15733	OUF	100	N	N
15734	HOTELS/MOTEL A	100	Υ	Υ

#### **Exterior Wall:**

Interior Finish Nbr	Type	Area %
5416	CUSTOM	100

# **Building 7 Details**

Building TypeCondition GQuality Grade 450Effective Age 18Perimeter 100Depreciation % 23Year Built 1979Special Arch 0Grnd Floor Area 576Functional Obs 0Economic Obs 0

Inclusions:

 Roof Type
 Roof Cover
 Foundation

 Heat 1
 Heat 2
 Bedrooms 0

 Heat Src 1
 Heat Src 2

**Extra Features:** 

 2 Fix Bath
 0
 Vacuum
 0

 3 Fix Bath
 0
 Garbage Disposal
 0

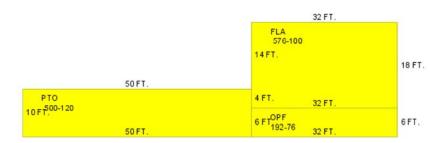
 4 Fix Bath
 0
 Compactor
 0

 5 Fix Bath
 0
 Security
 0

 6 Fix Bath
 0
 Intercom
 0

 7 Fix Bath
 0
 Fireplaces
 0

 Extra Fix
 0
 Dishwasher
 0



#### Sections:

1 <u>FLA</u> 1 1978 5	N	lbr	Туре	Ext Wall	# Stories	Year Built	Attic A/C	Basement %	Finished Basement %	Area
		1	FLA		1	1978				576

2	OPF	1	1978	192	
3	PTO	1	1978	500	

#### Interior Finish:

Section Nbr	Interior Finish Nbr	Туре	Area %	Sprinkler	A/C
	15735	1 STY STORE-A	100	Υ	Υ
	15736	OPF	100	N	N
	15737	PTO	100	N	N

#### **Exterior Wall:**

ı	Interior Finish Nbr	Туре	Area %
	5417	C.B.S.	100

# **Misc Improvement Details**

Nbr	Туре	# Units	Length	Width	Year Built	Roll Year	Grade	Life
0	PO5:COMM POOL	2,500 SF	0	0	2007	2014	3	50
1	DK4:WOOD DOCKS	3,840 SF	240	16	2000	2001	5	40
2	DK3:CONCRETE DOCK	2,338 SF	167	14	1979	1980	5	60
3	DK4:WOOD DOCKS	1,650 SF	150	11	2000	2001	5	40
4	TK2:TIKI	509 SF	0	0	1979	1980	4	40
5	AP2:ASPHALT PAVING	49,200 SF	0	0	1979	1980	2	25
6	RW2:RETAINING WALL	720 SF	180	4	1979	1980	3	50
7	PT2:BRICK PATIO	2,762 SF	0	0	1979	1980	5	50
8	PT2:BRICK PATIO	13,662 SF	0	0	1979	1980	2	50
9	AP2:ASPHALT PAVING	19,311 SF	0	0	1979	1980	2	25
10	PT3:PATIO	962 SF	0	0	1985	1986	2	50
11	PT3:PATIO	440 SF	0	0	1969	1970	2	50
12	RW2:RETAINING WALL	136 SF	68	2	1969	1970	4	50
13	AP2:ASPHALT PAVING	34,240 SF	0	0	1985	1986	2	25
14	PO5:COMM POOL	2,500 SF	0	0	2007	2014	3	50
15	HT2:HOT TUB	1 UT	0	0	1979	1980	5	50
16	CL2:CH LINK FENCE	256 SF	0	0	1993	1994	3	30
18	WD2:WOOD DECK	3,900 SF	0	0	1995	1996	2	40
19	CL2:CH LINK FENCE	360 SF	60	6	1989	1990	1	30
20	PT3:PATIO	765 SF	51	15	2000	2001	2	50
21	DK4:WOOD DOCKS	676 SF	26	26	2000	2001	5	40
23	TK2:TIKI	94 SF	0	0	2000	2001	5	40
24	FN2:FENCES	988 SF	247	4	2001	2002	4	30
25	FN2:FENCES	122 SF	0	0	2001	2002	2	30
26	BL2:BOAT LIFT	1 UT	0	0	2003	2004	2	20
27	WD2:WOOD DECK	200 SF	20	10	2003	2004	2	40

# **Appraiser Notes**

2003-01-10 (241) 314 HOTEL ROOMS

DR-219 ATTACHED TO OR2115-141/147 STATES THE SALES PRICE IS \$107,500,000, BUT THE DOCUMENTARY STAMPS ON DEED CALCULATE THE SALES PRICE TO \$104,316,200 TPP 8538421 - WYNDHAM MARRIOTTCASA MARINA TPP 8695128 - THE MASSAGE STUDIO INC TPP 8930010 - HEARTLAND CASH NETWORK LLC FOR ATM @ CASA MARINA

TPP 8538421 - WYNDHAM MARRIOTTCASA MARINA TPP 8695128 - THE MASSAGE STUDIO INC TPP 8930010 - HEARTLAND CASH NETWORK LLC FOR ATM @ CASA MARINA

# **Building Permits**

Bldg	Number	Date Issued	Date Completed	Amount	Description	Notes
21	09-4523	07/06/2009	07/06/2009	0	Commercial	ISSUED C/O
	10 3531	11/18/2010		15,000	Commercial	INSTALLATION OF 200 AMP SERVICE, DATA AND GROUNDING ON ROOF TOP FOR ANTENNAS AND ASSOCIATED EQUIPMENT
	10-3530	11/18/2010		30,000	Commercial	INSTALL WIRELESS TELECOMMUNICATION FACILITY ON EXISTING ROOF TOP.
	10-2776	08/24/2010		6,000	Commercial	PICK UP AND RELAY BRICK PAVER DRIVEWAY APPROXIMATELY 3000SF NO NEW IMPERVIOUS AREAS WILL BE ADDED.
	10-1232	04/20/2010		11,000	Commercial	ERECT REPLACEMENT OF TWO 3.5 TON CHILLER UNITS FOR HALLWAYS, MAIN BUILDING. UNIT REPLACEMENT OF IDENTICAL SIZE AND DESIGN, NO DUCT. RECONNECT TO EXISTING PIPING. UNITS LOCATED INSIDE BUILDING ABOVE LOBBY.
	10-1081	05/13/2010		2,500	Commercial	AFTER THE FACT: REPLACE 1000 WATT POLE LIGHTS WITH 400 WATT LIGHTS. NEW LIGHTING ON EXISTING POLE. NEW LIGHTS TO MATCH EXISTING. SHIELDS TO BE INSTALLED AS NEEDED. LIGHT POST AND FIXTURES TO MATCH.
	10-0584	02/25/2010		8,000	Commercial	INSTALL WIRELESS CELLULAR PHONE SYSTEM WITH INSIDE ANTENNAE PROVIDING SIGNAL.
	10-1042	04/10/2010		26,936	Commercial	CONSTRUCT ROADWAY ENTRANCE 360SF PAVE PREPARED SURFACE 13,500SF WITH HOT ASPHALT, STRIPE 124 PARKING SPACES, 13 COMPACT SPACES AND 5 HANDICAP SPACES AS PER CITY AND ADA SPECS, SUPPLY AND INSTALL 60 CONCRETE CAR STOPS
	06-4050	07/06/2009	07/06/2009	0	Commercial	RENOVATED STRUCTURE (20 DEED RESTRICTED EFFICIENCY UNITS) INCLUDING PLUMBING ELECTRIC, MECHANICAL AND ROOFING.
	05-1104	04/11/2005		30,000	Commercial	REHABILITATION OF EXISTING WOOD ROOF FRAMING IN THE SPORTS HUT
	05-3219	08/02/2005		700	Commercial	REPLACE 30SF OF EXISTING DECKING
	05-3348	08/14/2005		11,000	Commercial	ALL TEMPORARY CONSTRUCTION FENCES MUST BE SECURED IF KEY WEST IF PLACED UNDER A HURRICANE WATCH OR WARNING. REPAIR OF FENCING AROUND TENNIS COURTS (200LF/6' H)
	05-3347	08/17/2005		60,250	Commercial	REPAIR/REPLACE CHAINLINK FENCE FOOTING ON TEH EAST SIDE (100LF). REPAIR BLOCK WALL ON THE WEST SIDE 180SF. REPAIR DOCK AND SWIMMING PIER.
	05-4328	10/12/2005		0	Commercial	REVISION TO EXISTING PERMIT (05-3348) REPLACE 100LF OF DAMAGES CHAIN LINK FENCE WITH ALUMINUM PICKET FENCE.
	05-2583	11/18/2005		2,400	Commercial	INSTALL TEMPORARY POWER FOR SIX SLEEPER TRAILER.
	05-5739	12/16/2005		29,988	Commercial	HURRICANE REPAIRS: RELEVEL THE FRONT OF THE DECK AND REPLACE THE BOARDS ON IT. BUILD THE HANDRAILS BACK AT THE END OF THE PIER. 12' REPAIR THE HANDRAIL AT THE FRONT OF THE PIER. 9' MATERIAL IS ACQ WOOD TREATMENT. REPAIR MISSING BOARDS.
	05-5740	12/16/2005		70,850	Commercial	HURRICANE REPAIRS TO PIER
	06-0143	01/12/2006		10,000	Commercial	HURRICANE REPAIRS TO FENCEES
	06-0531	01/30/2006		1,000	Commercial	DEMO OF DRYWALL, WING WALLS TUB AND TRIM
	06-1228	04/12/2006		33,000	Commercial	HURRICANE DAMAGE: REPAIRS TO A/C SYSTEMS.
	06-2336	04/17/2006		11,600	Commercial	REPLACE/INSTALL NEW 110LF OF 3 & 4 FT OF WOOD PICKET FENCING AROUND MANAGERS OFFICE.
	06/2582	04/25/2006		1,000	Commercial	EXTEND PERMIT FOR TEMPOARARY TRAILER THAT SITS ON CASA MARINA/ REACH PROPERTY
	06-2897	06/15/2006		0	<u> </u>	
	06-5024	08/30/2006		20,000	Commercial	CARPET, FURNITURE, DRYWALL, DOORS AND RAILING DEMOLITION.
	06-5031	08/30/2006		400,000	Commercial	

						REPLACE WATER CLOSETS, LAVATORIES, SHOWER AND SHOWER VALVES 981 AND 321 WATER LINES.
	06-5962	10/30/2006		6,000	Commercial	RELOCATION OF EXISTING FIRE SPRINKLER HEADS
	07-1522	03/29/2007		54,740	Commercial	INSTALL 1600SF NEW ROOFING
	07-1557	04/02/2007		197,000	Commercial	DEMO OF POOL AREA 5500SF
	07-1899			310,000	Commercial	NEW RETAINING WALLS, POOL AREA CONCRETE, ALL CONCRETE HARD SCAPES, INCLUDING FILL PLACEMENT
	07-2034	04/24/2007		95,000	Commercial	REFLECTING FOUNTAIN
	07-2519	05/30/2007		280,000	Commercial	CONSTRUCT NEW COMMERCIAL POOL
	07-3376 07/06/2007 160,000		160,000	Commercial	ADD NEW PAVILLION ONTO EXISTING KITCHEN STRUCTURE OF 6X6 POST V-GROOVE CEILING WITH CEDAR SHAKE ROOF. NEW CONCRETE FLOOR AT SUN SUN BAR AND KITCHEN REPAIR ROOF AT SUN SUN BAR.	
	07-1636	04/09/2007		0	Commercial	TEMPORARY CONSTRUCTION TRAILERS
	07-4413	10/10/2007		80,000	Commercial	INSTALL NEW CABINTRY FOR NEW LOBBY BAR TO INCLUDE PAINT AND INTERIOR FINISHES.
	07-3942	08/08/2007		100,000	Commercial	DEMO ALL SIDEWALKS AND FRONT ENTRY INSTALL NEW HEADER CURBS AT SIDEWALK.
	07-4402	10/11/2007		9,500	Commercial	ISNTALLATION OF CONDUITS, PULL BOXES FOR LOW VOLTAGE WIRING, BRANCH CIRCUITS, WIRING DEVICES AND CONNECTION AS INDICATED ON PLANS.
	10-			0		
	07-5128	11/28/2007		1,000	Commercial	REPLACE EXISTING GAS LINE TO OUTDOOR KITCHEN, REPLACE MAINFOLD IN OUTDOOR KITCHEN, HOOK APPLIANCES.
	07-5200	12/19/2007		27,000	Commercial	REMOVE EXISTING 4 K TANK AND INSTALL ONE NEW 2 K FIREGARD TANK ON EXISTING CONCRETE REQ CONNECT TO EXISTING PIPING.
	07-5496	12/21/2007		15,000	Commercial	SEAL-COAT FRONT MAIN PARKING LOT AND SUITE BUILDING PARKING LOT; STRIPE BACK PARKING LOT TO PLAN SPECIFICATIONS AND TO EXISTING STANDARDS (MAIN PARKING AND SUITE PARKING ONLY). ADA/HANDICAP SPACES TO BE INCLUDED PER PLANS. AND AUXILIERY LOT.
	08-0658	03/19/2008		95,000	Commercial	COMMERICAL POOL RENOVATION.
	08-0499	02/26/2008		15,000	Commercial	REPLACE EXISTING 1250 GAL GREASE TRAP
	08-4582	02/02/2009		3,500	Commercial	ADD/RELOCATE FIRE SPRINKLER HEADS
	08-4583	02/02/2009		3,500	Commercial	ADD/RELOCATE FIRE SPRINKLER HEADS.
	07-0276	02/20/2007		40,000	Commercial	ADA ROOMS ONLY: APPLY NEW DRYWALL, PAINT AND FINISH INSTALLATION OF NEW VANITIES. INSTALLATION OF NEW FURNITURE.
	07-0716	02/14/2007		587,000	Commercial	REPLACE CHILLED WATER FAN COILS IN GUEST ROOMS (195 ROOMS)
	06-6802	02/02/2007		8,000	Commercial	REPLACE 5 WINDOWS AND 2 DOORS, ALL NEW GLASS IS LAMINATED IMPACT ROOM #402.
	07-0498	02/01/2007		30,178	Commercial	REMOVE AND ROOF ON BUILDING 7,8,9,10. INSTALLING SARNAFIL G-410 ENERGY SMART ROOFING MEMBRANE
	06-3951	01/16/2007		355,955	Commercial	
1	01-3978	12/14/2001	09/18/2002	22,000	Commercial	AWNING
2	02-0322	04/11/2002	09/18/2002	50,000	Commercial	SIDEWALK & DUCT
3	02-0635	04/22/2002	09/18/2002	99,800	Commercial	ANTENNAS
4	03-1400	04/21/2003	01/01/2004	61,000	Commercial	NEW ELECTRIC
5	02-1549	06/14/2002	09/18/2003	2,125	Commercial	INSTALLED NEW AWNING
6	03-3169	09/12/2003	09/18/2003	5,500	Commercial	REPLACED LIGHT FIXTURES
7	03-3425	09/25/2003	10/02/2003	1,800	Commercial	INSTALLED NEW CEILING WOR
8	03-2912	09/24/2003	10/02/2003	25,900	Commercial	INSTALLED 15 PITCH PANS
9	03-2406	09/26/2003	10/02/2003	20,350	Commercial	REPLACED PARTS A/C
10	03-2285	10/01/2003	10/08/2003	16,230	Commercial	INSTALLED NEW DECK 200SF
11	03-3806	11/03/2004	11/10/2003	21,000	Commercial	REPAIRED DECKING
12	03-3721	10/31/2003	11/08/2003	7,500	Commercial	REPAIRED ROOF DECK
13	04-2422	07/21/2004	12/17/2004	27,000	Commercial	REPLACE HALLWAY DOORS

14	05-3349	08/14/2005	12/11/2005	19,000	Commercial	REPAIR EXTERIOR LIGHTING IN COMMON AREAS,ALSO FANS .
15	06-6161	11/21/2006	04/15/2007	4,000	Commercial	DEMO 4469 SF OF WOOD FLOORING IN BAR AND RESTAURANT AREA
16	06-6162	11/27/2006	04/15/2007	88,000	Commercial	DEMO 14,500 SF OF INTERIOR PUBLIC SPACE.THIS WILL INCLUDE BUILD BACK OF MENTIONED WORK
17	06-3951	01/16/2007	04/15/2007	355,955	Commercial	REMOVE OLD ROOF. REPLACE.5 WOOD FIBER OVER ISO SET IN HOT ASPHALT
18	07-0280	03/20/2007	04/15/2007	22,000	Commercial	REPLACE PLUMBING AT FLAGLER
19	07-4803	10/22/2007	11/22/2007	2,000	Commercial	INSTALL IRRIGATION SYSTEM
20	07-4822	10/24/2007	11/22/2007	7,500	Commercial	COVER DUCT FIRST FLOOR DRYWALL & METAL STUDS

# **Parcel Value History**

Certified Roll Values.

#### View Taxes for this Parcel.

Roll Year	Total Bldg Value	Total Misc Improvement Value	Total Land Value	Total Just (Market) Value	Total Assessed Value	School Exempt Value	School Taxable Value
2014	27,550,765	656,655	18,220,567	65,621,679	30,934,707	0	65,621,679
2013	27,550,765	435,867	17,359,656	44,324,443	28,122,461	0	44,324,443
2012	28,949,152	446,565	17,359,656	25,565,874	25,565,874	0	25,565,874
2011	28,949,152	454,505	18,986,124	33,331,182	26,220,827	0	33,331,182
2010	30,372,154	465,125	14,397,600	23,837,116	23,837,116	0	23,837,116
2009	30,372,154	478,775	20,659,724	23,181,570	23,181,570	0	23,181,570
2008	30,388,565	493,423	34,432,873	60,000,000	60,000,000	0	60,000,000
2007	25,926,075	497,417	34,432,873	69,316,439	69,316,439	0	69,316,439
2006	25,926,075	335,472	44,563,750	74,743,668	74,743,668	0	74,743,668
2005	26,229,701	343,222	21,556,600	45,887,445	45,887,445	0	45,887,445
2004	26,814,915	505,548	21,556,600	45,887,445	45,887,445	0	45,887,445
2003	26,814,915	514,362	19,316,380	53,082,953	53,082,953	0	53,082,953
2002	26,814,915	528,119	19,316,380	53,082,953	53,082,953	0	53,082,953
2001	32,146,185	531,828	13,521,466	53,082,953	53,082,953	0	53,082,953
2000	32,051,273	161,846	11,026,169	47,461,104	47,461,104	0	47,461,104
1999	34,776,245	167,609	11,026,169	44,949,658	44,949,658	0	44,949,658
1998	23,184,164	172,915	11,026,169	44,949,658	44,949,658	0	44,949,658
1997	23,547,698	178,888	10,503,815	42,351,368	42,351,368	0	42,351,368
1996	0	168,380	10,503,815	10,672,195	10,672,195	0	10,672,195
1995	0	173,890	10,503,815	10,677,705	10,677,705	0	10,677,705
1994	0	180,785	10,503,815	10,684,600	10,684,600	0	10,684,600
1993	0	189,061	10,503,815	10,692,876	10,692,876	0	10,692,876
1992	0	197,041	10,503,815	10,700,856	10,700,856	0	10,700,856
1991	0	205,530	10,503,815	10,709,345	10,709,345	0	10,709,345
1990	0	213,299	9,350,374	9,563,673	9,563,673	0	9,563,673
1989	0	221,786	9,285,080	9,506,866	9,506,866	0	9,506,866
1988	0	156,967	8,762,726	8,919,693	8,919,693	0	8,919,693

# **Parcel Sales History**

NOTE: Sales do not generally show up in our computer system until about two to three months after the date of sale. If a recent sale does not show up in this list, please allow more time for the sale record to be processed. Thank you for your patience and understanding.

Sale Date	Official Records Book/Page	Price	Instrument	Qualification
5/10/2005	2115 / 141	104,316,200	WD	Q
12/1/1996	1436 / 0592	54,346,000	WD	<u></u>
11/1/1987	1033 / 640	9,500,000	WD	<u>M</u>

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Monroe County Monroe County Property Appraiser Scott P. Russell, CFA P.O. Box 1176 Key West, FL 33041-1176