

Historic Architectural Review Commission Staff Report for Item 15

To: Chairman Bryan Green and Historic Architectural Review

Commission Members

From: Enid Torregrosa, MSHP

Historic Preservation Planner

Meeting Date: July 28, 2015

Applicant: William Shepler, Architect

Application Number: H15-01-1021

Address: #803-805 Olivia Street

Description of Work:

Revisions to previously approved plans for a new two and a half story frame structure.

Site Facts:

The site where the structure is planned to be built has been vacant since 2005. In July 12, 2005, the Commission approved the demolition of a non-contributing structure that was located in the site and the construction of a two-story wood frame single-family residence. The surrounding houses are two story and two and a half-story frame structures.

In April 24, 2014, the Commission approved a two and a half story frame structure for the site. After the approval, the owners had decided to make some changes that triggered side and rear back yard setbacks, which were approved by the Planning Board on July 16, 2015.

Guidelines Cited in Review:

• Additions/ alterations and new construction (pages 36-38 a), specifically guidelines for new construction 1 through 7 of pages 38-38a).

Staff Analysis

The Certificate of Appropriateness proposes the construction of a two and a half story wood frame structure on a vacant lot. The structure will house a garage for a boat and cars on the first floor and a single-family unit on the upper stories. The changes from the previous approved plans include the following:

- 1. Enclosure of the east side staircase,
- 2. A new exposed staircase with a deck located on the back of the new structure,
- 3. Increase of the width of the east side dormer,
- 4. Change of location of some doors and windows,
- 5. Increase of the depth of the building, making it closer to the front property line.

The plan proposes the use of fiber cement siding, aluminum impact windows with 2 over 2 configuration, and v-crimp roofing system.

Consistency with Cited Guidelines

The proposed changes are minimal to the previous approved plans. Staff opines that the previous design with the open staircase on the side was more appropriate, the new enclosed staircase creates an asymmetrical main facade. In spite of, the new building will not dominate or overpower the main house on the site nor the adjacent structure.

APPLICATION

COMBINATION APPLICATION: FLOODPLAIN, CONSTRUCTION APPLICATION FEE NON-REFUNDABLE



City of Key West

3140 FLAGLER AVENUE KEY WEST, FLORIDA 33040 Phone: 305.809.3956

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HARC PERMIT NUM		=	RMIT NUMBER 7 45BY:	INITIAL & DATE	
FLOODPLAIN PERMI	T			REVISION #	
FLOOD ZONE PAN	NEL#	ELEV. L. FL.	SUBSTANTIAL YES	IMPROVEMENT NO	%

251.			I YES L	
ADDRESS OF PROPOSED PROJECT:	803-805 Olivia St	., Key West, FL	33040	# OF UNITS 2
RE#OR ALTERNATE KEY:				
NAME ON DEED:	Bruce & Sharon N	/lineroff	PHONE NUMBER 908-91	7-1711
OWNER'S MAILING ADDRESS:	803 Olivia St., Key	/ West, FL 33040	EMAIL bmineroff@ac	ol.com
CONTRACTOR COMPANY NAME:	TB	Ò	PHONE NUMBER	
CONTRACTOR'S CONTACT PERSON:			EMAIL	
ARCHITECT / ENGINEER'S NAME:	William Shepler A	rchitect	PHONE NUMBER 305-89	0-6191
ARCHITECT / ENGINEER'S ADDRESS:	201 Front Street		EMAIL will@wshepler.	com
	Suite 203, Key West FL,			
HARC: PROJECT LOCATED IN HISTORIC	DISTRICT OR IS CONTRIB	UTING: XYESNO (SI	EE PART C FOR HARC APP	LICATION.)
CONTRACT PRICE FOR PROJECT OR ES	STIMATED TOTAL FOR MAT	"L., LABOR & PROFI <mark>T:</mark>		
FLORIDA STATUTE 837.06: WHOEVER KNOWINGL PERFORMANCE OF HIS OR HER OFFICIAL DUTY S				
PROJECT TYPE: CHANGE OF USE / DEMOLITION		ON SIGNAGE	REMODEL NITHIN FLOOD ZONE AFTER-THE-FACT	
DETAILED PROJECT DESCRIPTION INCL	UDING QUANTITIES, SQUA	RE FOOTAGE ETC., New	2 1/2 Story Residential I	Building utilizing
existing building at first floor as	storage, new residence	dial unit above with rea	ar deck as per submit	tted drawings.
I'VE OBTAINED ALL NECESSARY & PROVATS FROWNER PRINT NAME:		CIES AND OTHER PARTIES AS AP QUALIFIER PRINT NAME:	PLICABLE TO COMPLETE THE D	ESCRIBED PROJECT:
OWNER SIGNATURE:	¥	QUALIFIER SIGNATURE:		
Notary Signature as to owner *** *** *** *** ** ** ** ** **	건 N TO AND SCRIBED BEFORE ME	Notary Signature as to qualifier. Date: STATE OF FLORIDA; CQUNTY THISDAY OF	WE MONROEFSWORN TO AND	Drawer: 1 no: 2/153 SCRIBED BEFORE ME IS-Now
F PERMITS-NEW \$305. Time: 11:51	20 20	VA VI	number: SA/NASIERC	\$50.00 3054876 \$100.00
Personally known or produced.	as identification	Personally known or produced		as Identification

PART B: SUPPLEMENTARY PROJECT DETAILS TO AVOID DELAYS / CALL-BACKS PROPERTY STRUCTURES AFFECTED BY PROJECT: MAIN STRUCTURE ACCESSORY STRUCTURE SITE ACCESSORY STRUCTURES: GARAGE / CARPORT DECK FENCE OUTBUILDING / SHED FENCE STRUCTURES: 4 FT. 6 FT. SOLID 6 FT. / TOP 2 FT. 50% OPEN POOLS: INGROUND ABOVE GROUND SPA / HOT TUB PRIVATE PUBLIC PUBLIC POOLS REQUIRE BD. OF HEALTH LICENSE APPLICATION AT TIME OF CITY APPLICATION. PUBLIC POOLS REQUIRE BD. OF HEALTH LICENSE PRIOR TO RECEIVING THE CITY CERTIFICATE OF OCCUPANCY. NEW ROOF-OVER TEAR-OFF REPAIR AWNING 5 V METAL ASPLT. SHGLS. METAL SHGLS. BLT, UP TPO OTHER FLORIDA ACCESSIBILITY CODE: 20% OF PROJECT FUNDS INVESTED IN ACCESSIBILITY FEATURES. # OF SINGLE FACE # OF DOUBLE FACE REPLACE SKIN ONLY BOULEVARD ZONE SIGNAGE: POLE WALL PROJECTING AWNING HANGING WINDOW SQ. FT. OF EACH SIGN FACE: SUBCONTRACTORS / SPECIALTY CONTRACTORS SUPPLEMENTARY INFORMATION: MECHANICAL: DUCTWORK COMMERCIAL EXH. HOOD INTAKE / EXH. FANS LIPG TANKS A / C: COMPLETE SYSTEM AIR HANDLER CONDENSER MINI-SPLIT ELECTRICAL: LIGHTING RECEPTACLES HOOK-UP EQUIPMENT LOW VOLTAGE SERVICE: OVERHEAD UNDERGROUND 1 PHASE 3 PHASE AMPS PLUMBING: ONE SEWER LATERAL PER BLDG. INGROUND GREASE INTCPTRS. LPG TANKS RESTROOMS: MEN'S WOMEN'S UNISEX ACCESSIBLE PART C: HARC APPLICATION FOR A CERTIFICATE OF APPROPRIATENESS PAINTING SINGLE FAMILY: \$10 STAFF APPROVAL: \$50 COMMISSION REVIEW \$100 V PLEASE ATTACH APPROPRIATE VARIANCES / RESOLUTIONS FROM HARC, PLANNING BOARD OR TREE COMMISSION. ATTENTION: NO BUILDING PERMITS WILL BE ISSUED PRIOR TO HARC APPROVAL PLEASE SEND ELECTRONIC SUBMISSIONS TO: harc@cityofkeywest-fl.gov INDICATE TYPE OF CERTIFICATE. OF APPROPRIATENESS: GENERAL DEMOLITION SIGN PAINTING OTHER ADDITIONAL INFORMATION: PROJECT SPECIFICATIONS: PLEASE PROVIDE PHOTOS OF EXISTING CONDITIONS, PLANS, PRODUCT SAMPLES, TECHNICAL DATA ARCHITECTURAL FEATURES TO BE ALTERED: ORIGINAL MATERIAL: PROPOSED MATERIAL:


DEMOLITION: PLEASE FILL OUT THE HARC APPENDIX FOR PROPOSED DEMOLITION.

DEMOLITION OF HISTORIC STRUCTURES IS NOT ENCOURAGED BY THE HISTORIC ARCHITECTURAL REVIEW COMMISSION.


SIGNAGE: (SEE PART B) BUSINESS SIGN BRAND SIGN OTHER:

BUSINESS LICENSE # IF FAÇADE MOUNTED, SQ. FT. OF FAÇADE

<u> </u>		SIGN SPECIFICATION	•	
SIGN COPY:		PROPOSED MATERIALS:		IGNS WITH ILLUMINATION:
				A-1.74
				YPE OF LTG.:
			L	TG. LINEAL FTG.:
MAX. HGT. OF FONTS:			C	OLOR AND TOTAL LUMENS:
IF USING LIGHT FIXTU	RES PLEASE INDICATE HOW MANY:	INCLUDE SPEC. SHEE	WITH LOCATIONS AND	COLORS.
OFFICIAL USE ON	IV: HAF	C STAFF OR COMMISSION	DEVIEW	
APPROVED		DEFERRED FOR FUTURE CO		TABLED FOR ADD'L. INFO.
HARC MEETING DATE:		IHARC MEETING DATE:		ARC MEETING DATE:
		TISKS WELL THO DATE.		AND MEETING ON I.
REASONS OR CONDITI	IONS:			
STAFF REVIEW COMMI	ENTS:			
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MARU PLANNER SIGNA	ATURE AND DATE:	TAKU CHA	IRPERSON SIGNATURE	und date:
PART D:	STATE OF FLORID	A OFFICIAL NOTIFI	CATIONS AND	WADNINGS
				RESULT IN YOUR PAYING TWICE FOR ORDER AND A COPY POSTED ON THE JOB SITE
		,		RNEY BEFORE RECORDING A NOTICE.
				CTION APPLIED FOR IN THIS APPLICATION,
				VI TO DEMOLISH / REMOVE ASBESTOS.
				ADDITIONAL RESTRICTIONS APPLICABLE TO THIS
PROPERTY THAT MAY	BE FOUND IN THE PUBLIC RECORDS	OF MONROE COUNTY AND THER	F MAY BE ADDITIONAL P	ERMIT'S REQUIRED FROM OTHER GOVERNMENT
	UADUCT ATHORITY, FLORIDA DEP OF			
	RES LEAD PAINT ABATEMENT PER TH			
The second secon	Y PLANS EXAMINER OR CHIEF BUILD	THE PARTY OF THE P		CBO OR PL. EXAM. APPROVAL:
HARC FEES:	BLDG. FEES:	FIRE MARSHAL FEE:	IMPACT FEES:	
				DATE:
				DATE.
l _e constant				

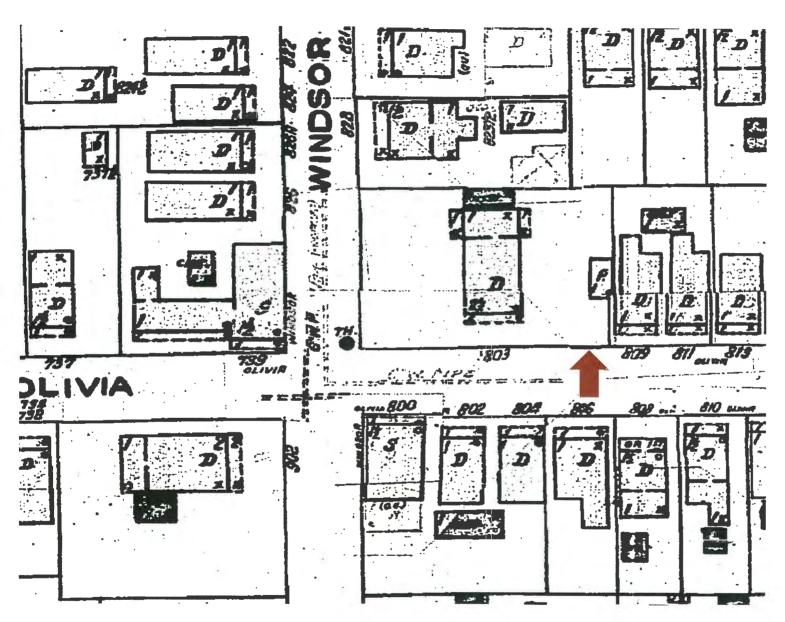

#805 Olivia Street Sanborn map 1948

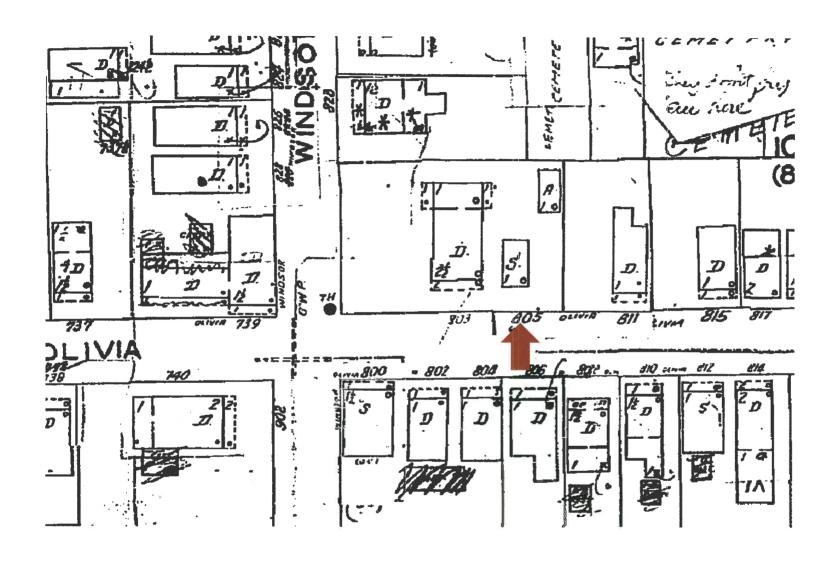

#805 Olivia Street Sanborn map 1962

PROJECT PHOTOS



#803-805 Olivia Street Property Appraisers office. Building to the right side is the structure in question for this application. Monroe County Library



805 Olivia Street



803 Olivia Street



811 Olivia Street - Adjacent Property



Adjacent to 811 Olivia Street



804 Olivia Street



Corner of Olivia Street and Windsor Lane - Across from 803 Olivia



Corner of Olivia Street and Windsor Lane - Across from Olivia Market



View of 803 Olivia from Windsor Lane



View of Olivia Street Looking East




View of Olivia Street Looking West

LEGEND

- Found 2" Iron Pipe (Fence Post) (M/R) Measured & Record
- Set 3/4" Iron Pipe w/cap (6298) Found 1/2" Iron Rod (2863)
- Found Nail & Disc (Norby)
- Set Nail & Disc (6298)
- Record

- C.B.S. Concrete Block Structure
- Right of Way
- Chain Link Fence
- Centerline
- Wood Utility Pole
- Concrete Utility Pole

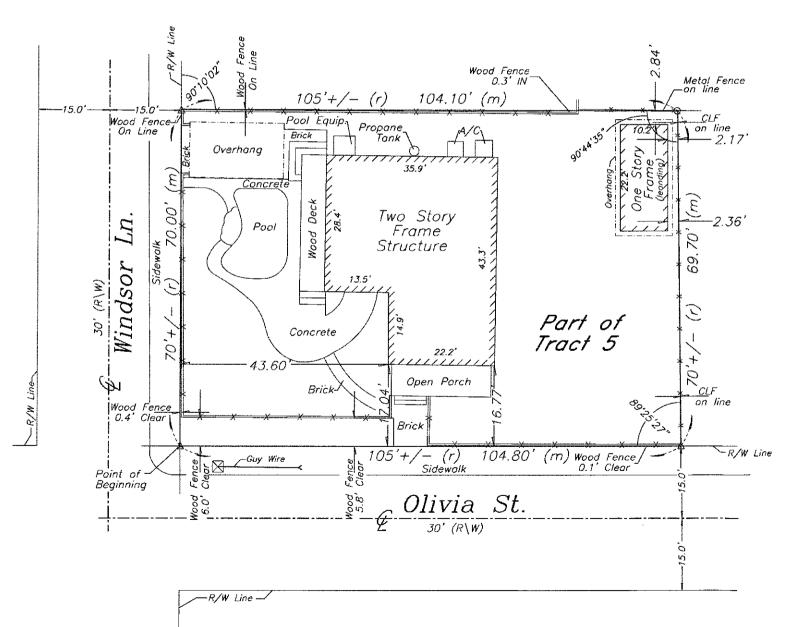

NOTES:

1. The legal description shown hereon was furnished by the client or their agent.

Boundary Survey Map Part of Tract 5

Island of Key West, Florida

- 2. Underground foundations and utilities were not located.
- 3. All angles are 90° (Measured & Record) unless otherwise noted.
- 4. Street address: 803-805 Olivia Street, Key West, FL.
- 5. This survey is not valid without the signature and the original raised seal of a Florida licensed surveyor and mapper.
- 6. Lands shown hereon were not abstracted for rights-of-way, easements, ownership, or other instruments of record.
- 7. North Arrow is assumed and based on the legal description.
- 8. Date of field work: December 21, 2010.
- 9. Ownership of fences is undeterminable, unless otherwise noted.

BOUNDARY SURVEY OF: On the Island of Key West and is known as part of Tract 5 according to William A. Whitehead's map delineated in February A. D. 1829, described by metes and bounds as follows: COMMENCING at the Northerly corner of the intersection of Olivia Street and Windsor Lane and running thence along Olivia Street in a Northeasterly direction 105 feet, more or less, to the existing fence line; thence at right angles in a Northwesterly direction 70 feet, more or less, to the existing fence line; thence at right angles in a Southwesterly direction 105 feet, more or less, to Windsor Lane; thence at right angles in a Southeasterly direction 70 feet, more or less, to the Place of Beginning.

BOUNDARY SURVEY FOR: Bruce Mineroff & Sharon Mineroff; Centennial Bank:


The Closing Department;

Westcor Land Title Insurance Company;

n O'Flynn, PSM Florida Reg. #6298

December 22, 2010

THIS SURVEY IS NOT *ASSIGNABLE*

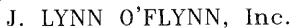





Professional Surveyor & Mapper PSM #6298

3430 Duck Ave., Key West, FL 33040 (305) 296-7422 FAX (305) 296-2244


PREVIOUSLY APPROVED DESIGN

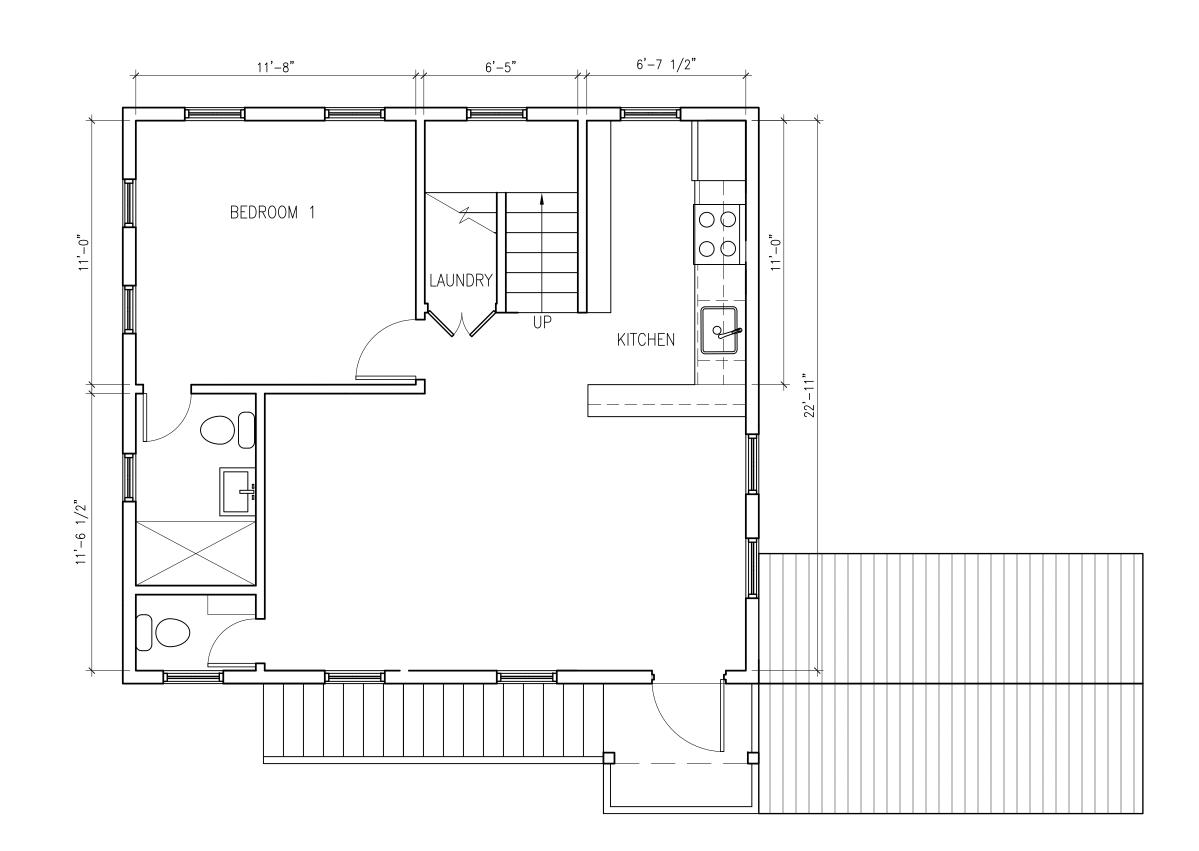




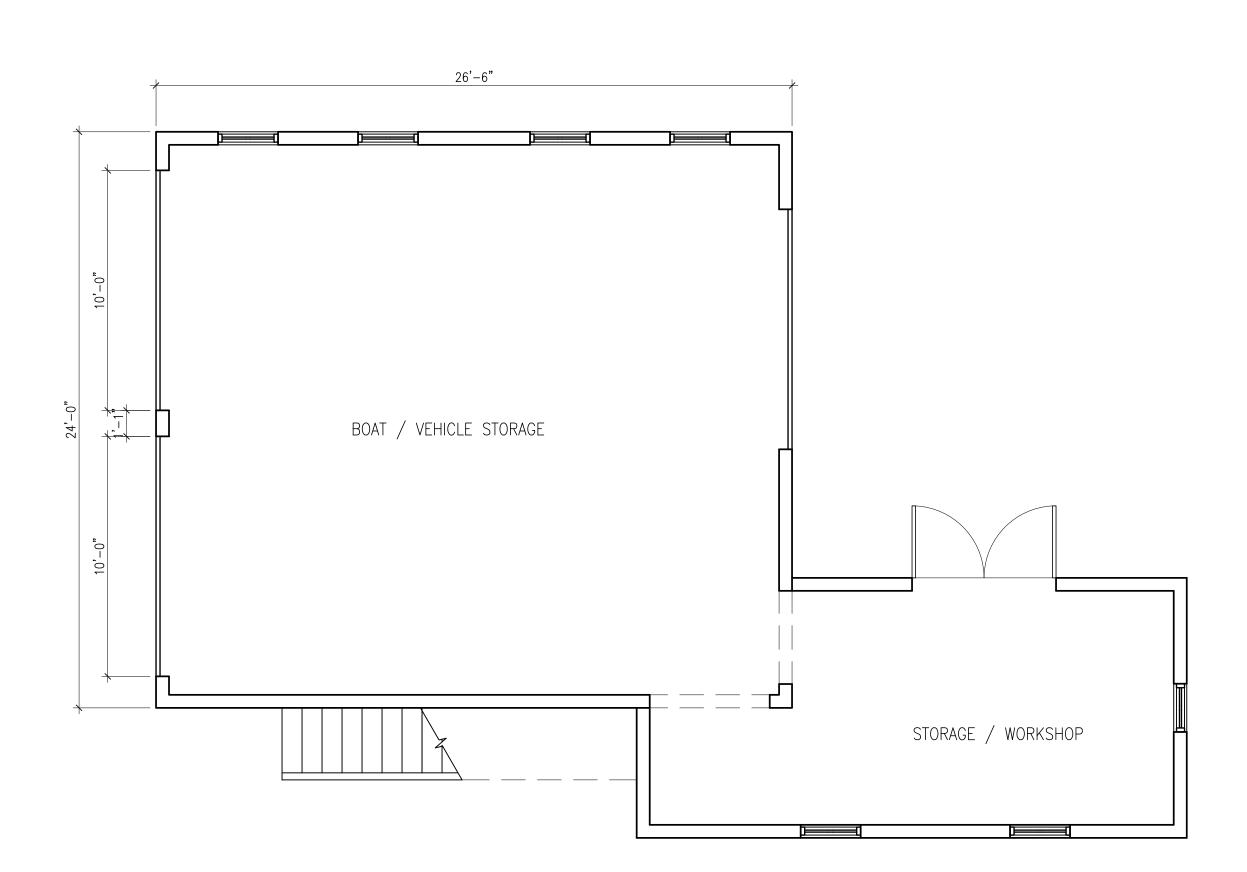




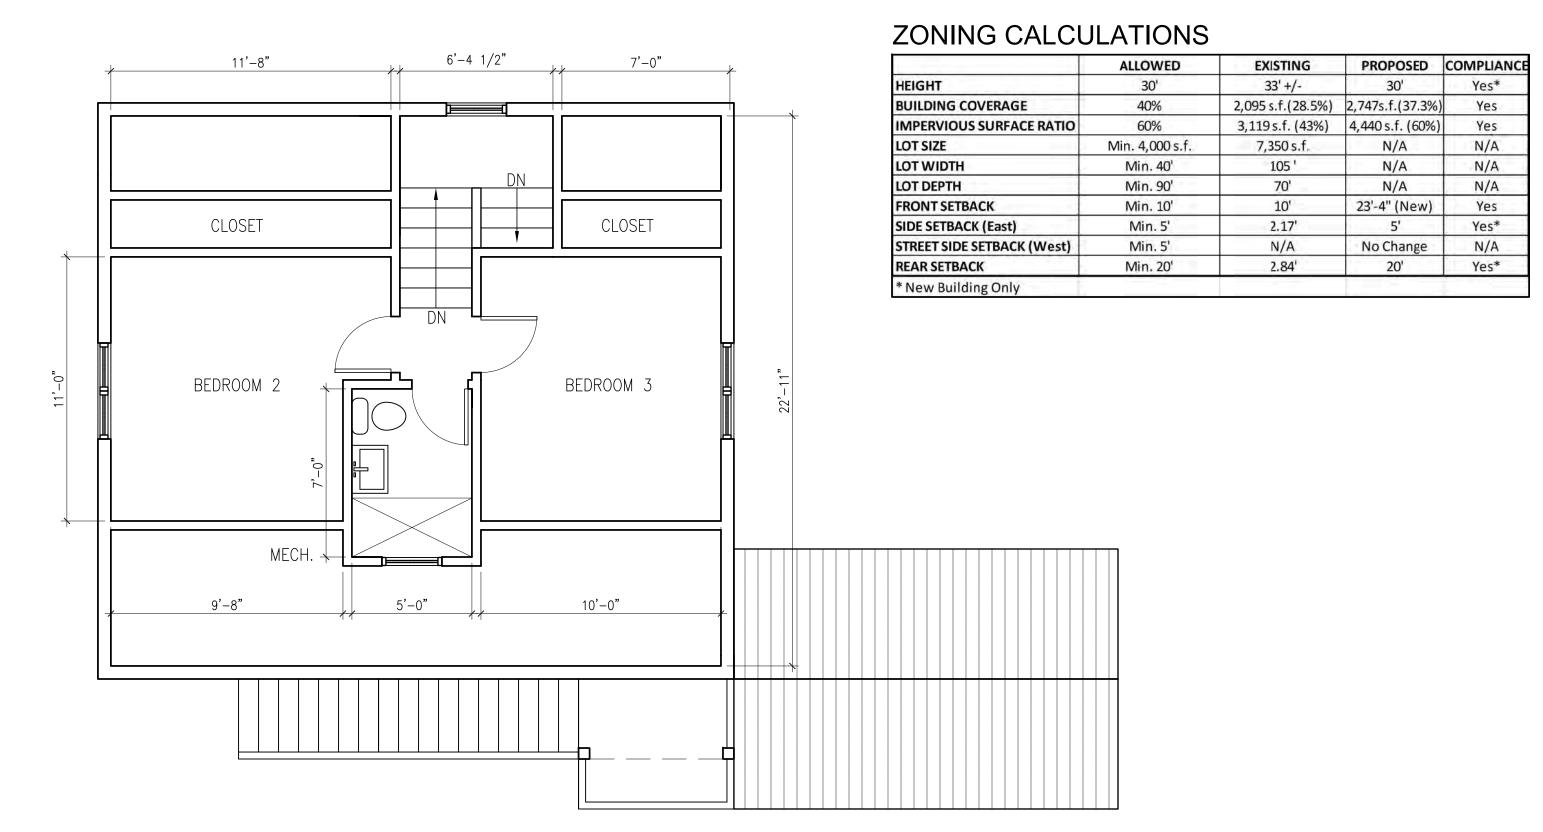



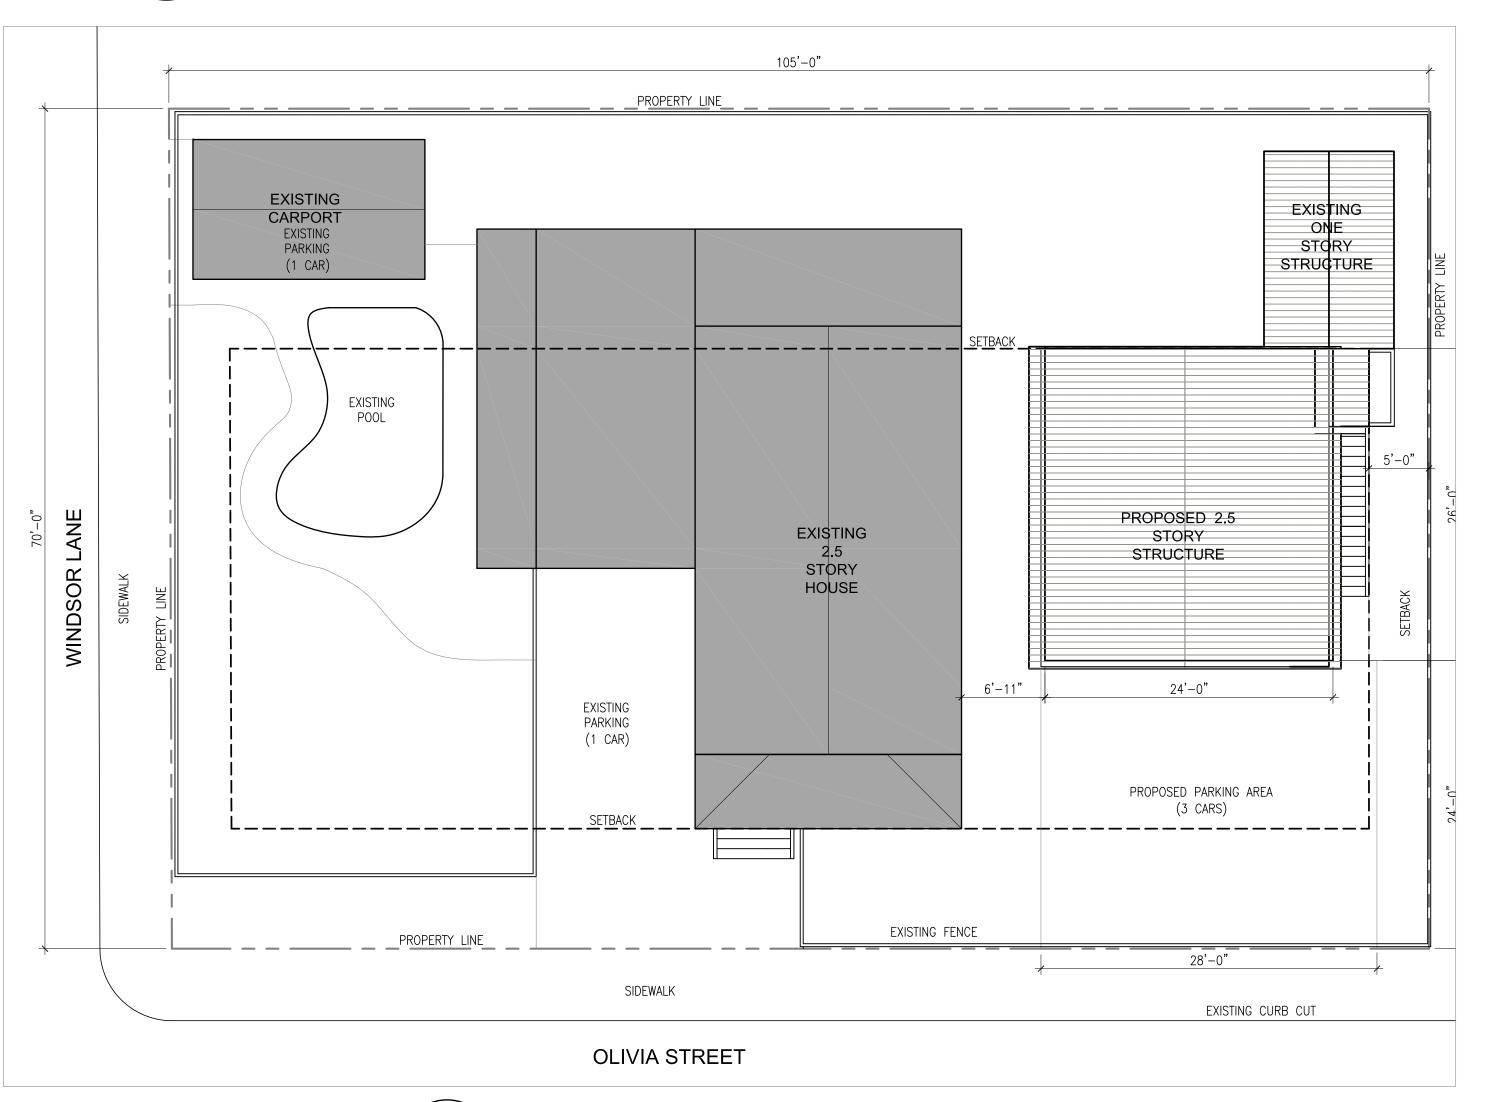

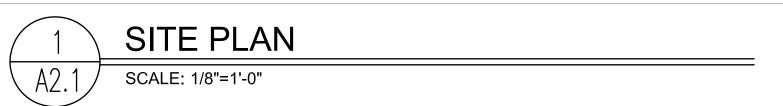

william shepler

Tel: 305-890-6191

Email: info@wshepler.com

513 Fleming St, Suite 14
Key West, FL 33040

Seal:

Consultants:

Submissions / Revisions:

H.A.R.C. SUBMISSION - 2014.4.1

OLIVIA STREET
KEY WEST, FL
RESIDENTIAL PROJECT

Drawing Size | Project #: 13022

NEW


805

SITE / FLOOR PLANS

SCALE: 1/4" = 1'-0"
Sheet Number:

Sheet Number:


Date: - MARCH 30, 2014
©2014 by William Shepler Architect

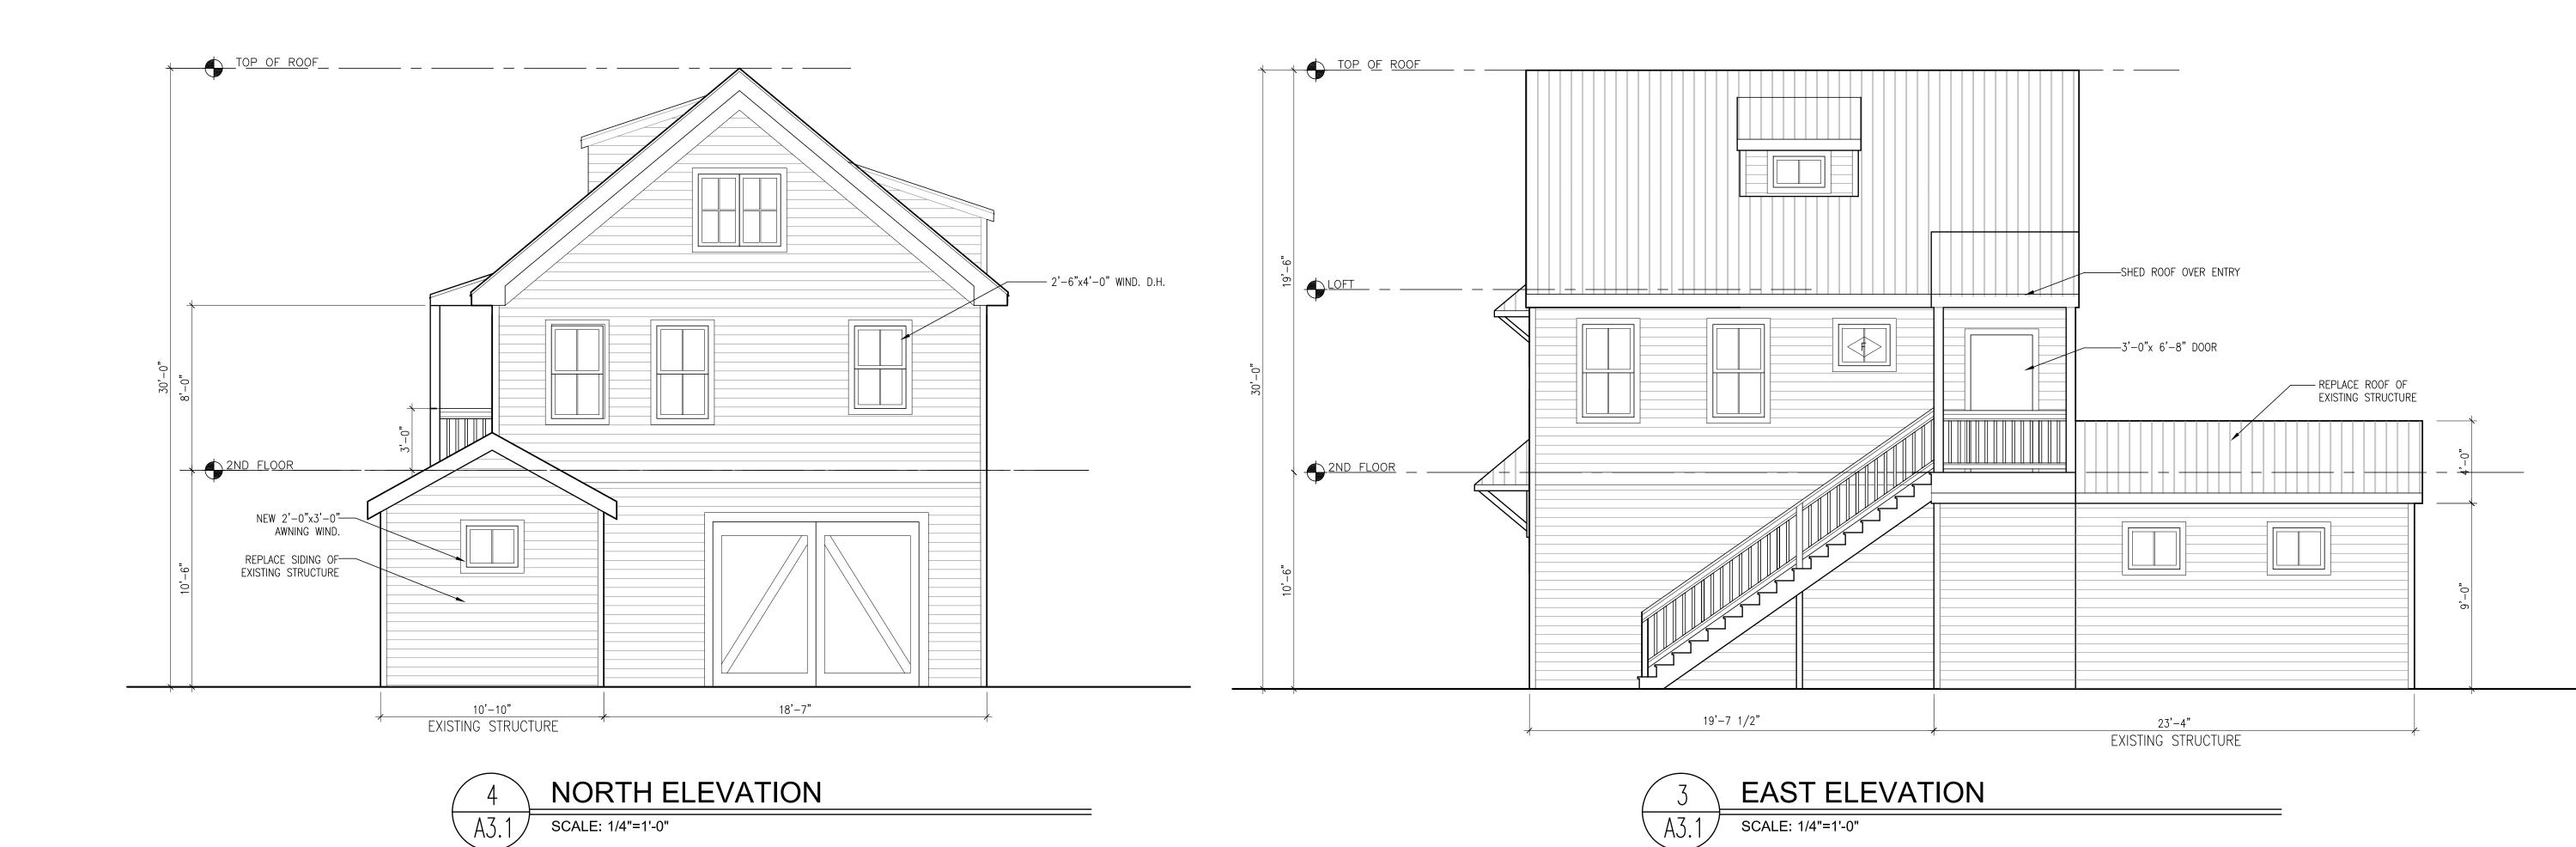



WEST ELEVATION

SCALE: 1/4"=1'-0"

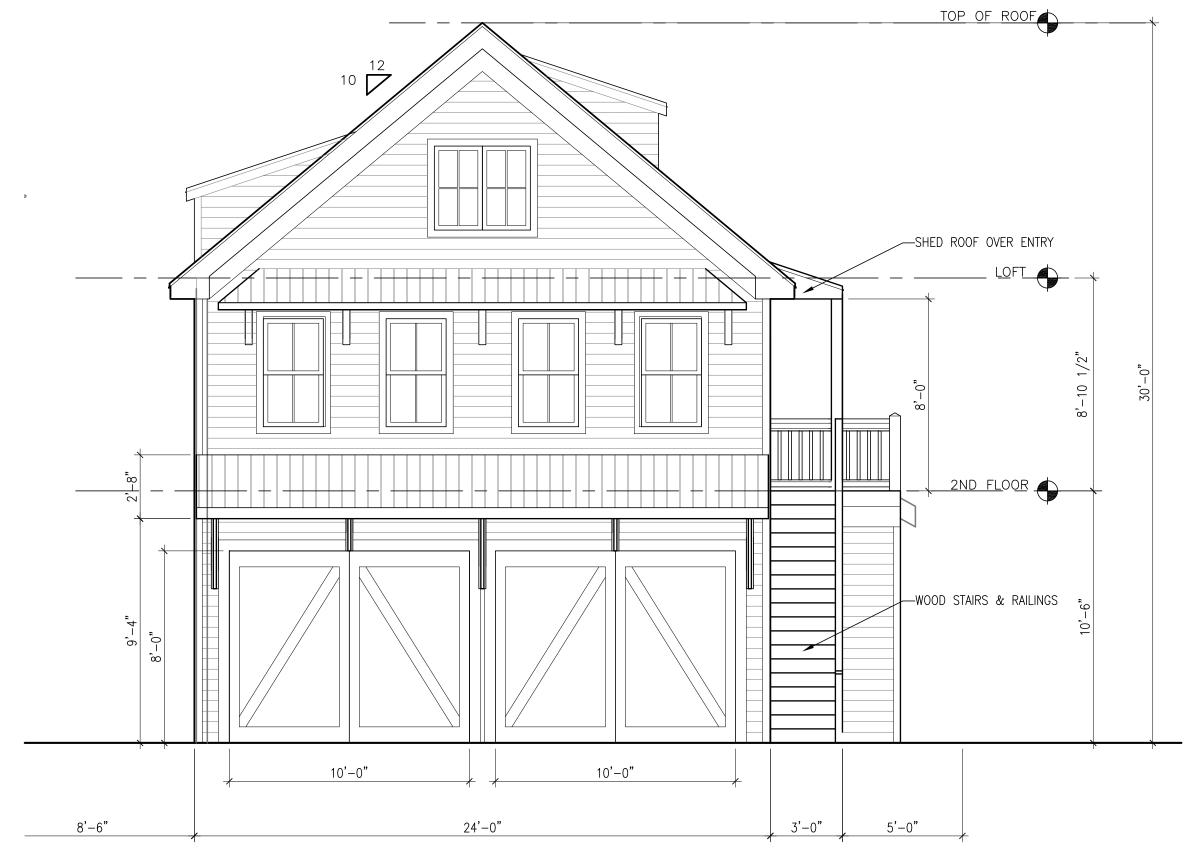



Drawing Size Project #:
24x36 Project #:
13022
Title:

ELEVATIONS

SCALE: 1/4" = 1'-0"
Sheet Number:
A-3.1

Date: - MARCH 30, 2014

©2014 by William Shepler Architect

PROJECT

STREET

william shepler

Tel: 305-890-6191

Consultants:

Submissions / Revisions: <u>H.A.R.C. SUBMISSION - 2014.4.1</u>

Email: info@wshepler.com

513 Fleming St, Suite 14 Key West, FL 33040



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CONTEXTUAL ELEVATION

SCALE: 1/8"=1'-0"

WS william shepler

513 Fleming St., Sulte 14 Key West, FL 33040

Tel: 305.890.6191 Email: Info@wshepler.com

805 OLIVIA STREET KEY WEST, FL

NEW RESIDENTIAL PROJECT

Drawing Size | Project #: 11X17 | 13-022

Title

CONTEXTUAL ELEVATION

Scale:


Sheet Number



Date: MARCH 31, 2014



Impact Resistant Windows & Doors

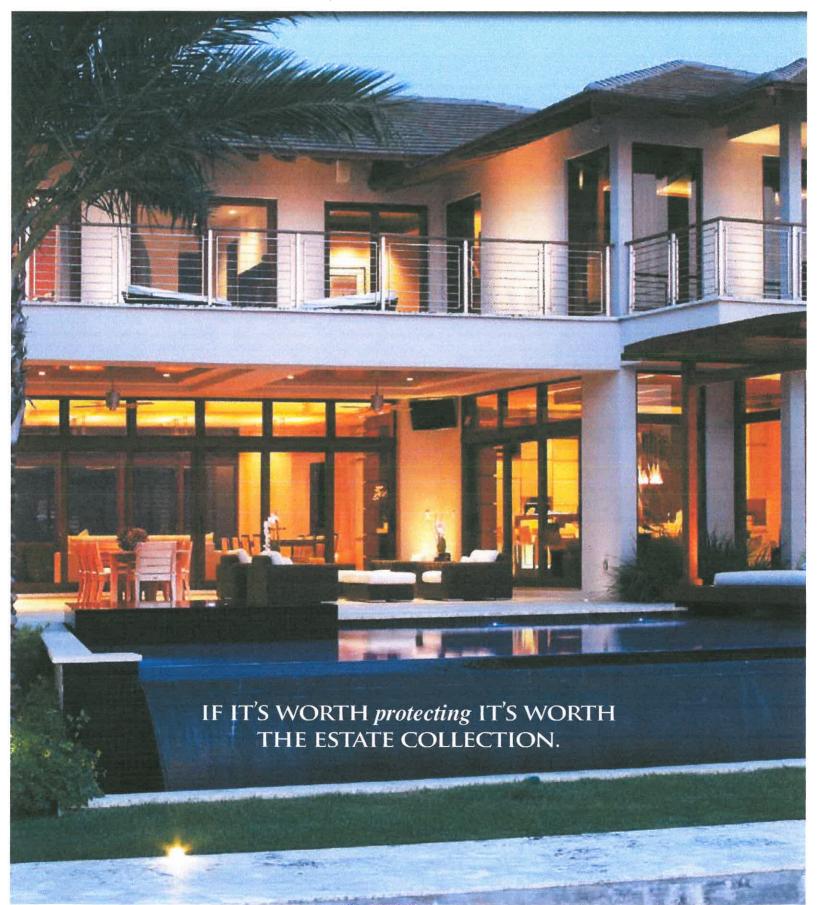

EERING makes IS CRYSTAL CLEAR

DISTINCTIVE MUNTIN/GRID DETAILS



ESTATE Theirs Our highly contoured Some competitors offer muntin provides a basic, less contoured



muntins that lack real style.

ATTRACTIVE GLAZING BEAD TRIM



fashionable look.

ESTATE Designed to look is also available.




Theirs Only available in square.

like wood. Square

THICKER ALUMINUM FRAME



Strength starts with an aluminum extrusion. At .090 ours is 45% thicker.

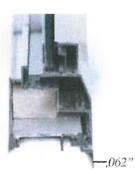

Theirs Standard aluminum thickness is just .062".





Building code/agency requirements

Exposure B	Door width up to	Wind speeds/Design pressures MPH ¹ /MPH ² /PSF design pressure	Impact resistant	Glass av Standard	ailable Impact
	9'	90 -165 mph ¹ / <mark>115 - 215 mph²</mark> (+12.80/-14.80) - (+45.30/-51.20)	No	LP3	No
300 Series Doors available up to 8' tall	10′	90 -160 mph ¹ /115 - 205 mph ² (+12.80/-14.80) - (+41.00/-46.30)	No	LP3	No
	16′	90 - 160 mph ¹ / <mark>115 - 205 mph²</mark> (+12.40/-13.80) - (+39.20/-43.70)	No	LP ³	No
	18′	110 - 140 mph ¹ /1 <mark>40 - 180 mph²</mark> (+18.50/-20.70) - (+30.00/-33.50)	No	LP3	No

- 1 Above wind speeds based on ASCE 7-05 are applicable for enclosed structures with an importance factor of 1.0, mean roof height of 30°, and assume a maximum of 2° of the door is located within the end zone of a structure. The above wind speeds listed as a guide only. Wind speed is only one of many factors that determine the design pressure on a structure. The design and location of the structure can have a great effect on the loads placed on the garage door. Consult a registered architect or structural engineer to determine what design pressure is appropriate for your application.
- ² Above wind speeds based on ASCE 7-10 Category II structure with a mean roof height of 30' and a maximum of 2' of the door is located within the end zone of a structure. The above wind speeds listed as a guide only. Wind speed is only one of many factors that determine the design pressure on a structure. The design and location of the structure can have a great effect on the loads placed on the garage door. Consult a registered architect or structural engineer to determine what design pressure is appropriate for your application.
- Options available on select models.
- W ind load drawings available upon request.

Carriage House Collection




Polyurethane insulation Provides thermal efficiency with an R-value* of 10.



Bulb seal
Protects against the elements.



Embossed wood grain texture
Adds beauty, sophistication and durability.

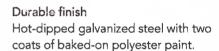

*Overhead Door Corporation uses a calculated door section R-value for our insulated doors.




Carriage House Collection

Design, thermal performance and durability

The look of wood carriage style swing doors with varied design options, thermal performance and the durability of steel to protect against the elements of extreme weather conditions.


Panel style

Three-section styling on 7' high doors (shown below) gives a custom design look. Our 8' high doors have four-section styling. Models are available with or without windows and with square or arched tops. Square tops are shown.

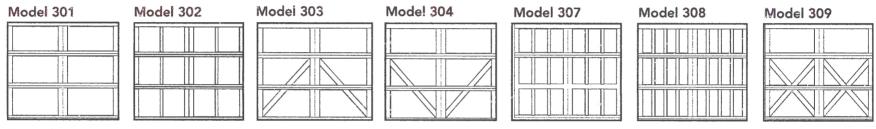

Finishes

Actual door colors may vary slightly from brochure photos due to fluctuations in staining or the printing process.

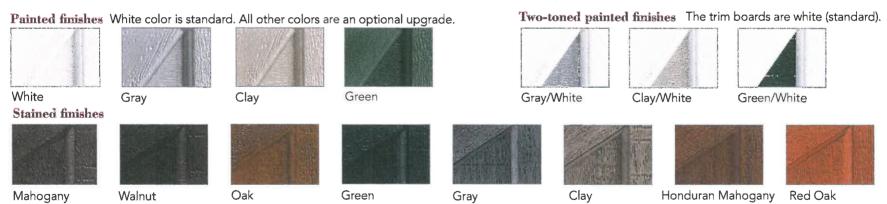

Window style

Arched windows are also available. See brochure for full line of window options.

Contact your Overhead Door Distributor to determine window availability and your local building official for code requirements. Insulated windows available.







8 Window Square

16 Window Square



24 Window Square



32 Window Square

Decorative hardware For specific hardware details please see page 26.

1 Windows for single car doors.2 Windows for double car doors.

1 Plain Window Square 6 Window Square

2 Plain Window Square 12 Window Square







REVISED DESIGN

DRAINAGE CALCS

REQUIRED INFORMATION: TOTAL LOT AREA =

7,350 S.F. INCREASED IMPERVIOUS AREA= 715 S.F.

% IMPERVIOUS = 715 / 7,350 = .097%

SWALE VOLUME REQUIRED:

FOR A HOME WITH 40% OR GREATER IMPERVIOUS COVERAGE LOT AREA * 0.104 * % IMPERVIOUS = SWALE VOLUME

7350 * 0.104 * .097 = 74.1 C.F.


SWALE PROVIDED: SWALE A = (6' X 36' X 0.5')=

81 C.F.

SWALE SIZE IS APPROX. 7% LARGER TO ALLOW FOR LANDSCAPING

ZONING CALCULATIONS


	ALLOWED	EXISTING	PROPOSED	COMPLIANCE
HEIGHT	30'	30'	30'	Yes
BUILDING COVERAGE	40%	2,095 s.f.(28.5%)	2,940 s.f.(40%)	Yes
MPERVIOUS SURFACE RATIO	60%	3,119 s.f. (43%)	4,262 s.f. (57.9%)	Yes
OT SIZE	Min. 4,000 s.f.	7,350 s.f.	N/A	N/A
OT WIDTH	Min. 40'	105 '	N/A	N/A
OT DEPTH	Min. 90'	70'	N/A	N/A
RONT SETBACK	Min. 10'	10'	15'-6" (New)	Yes
SIDE SETBACK (East)Exist. Shed	Min. 10' -6"	2.17'	No Change	N/A
SIDE SETBACK (East) New Construction	Min. 10' -6"	N/A	5'	No
STREET SIDE SETBACK (West)	Min. 10' -6"	N/A	No Change	N/A
REAR SETBACK - Exist. Shed	Min. 20'	2.84'	No Change	N/A
REAR SETBACK - New Construction	Min. 20'	N/A	20'	Yes
OPEN SPACE	35% Min.	5,249 s.f. (72%)	4,410 s.f. (60%)	Yes

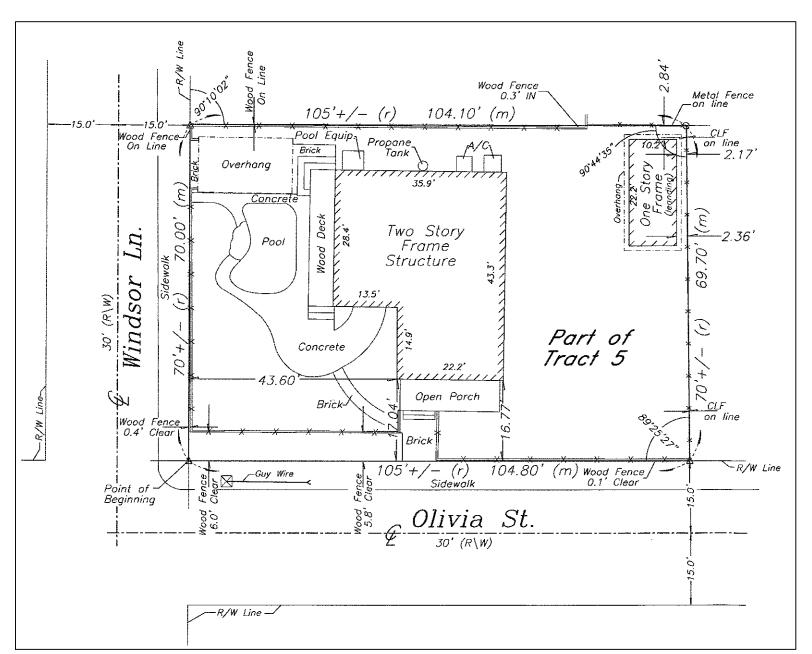



COPY OF SURVEY

SCALE: AS NOTED

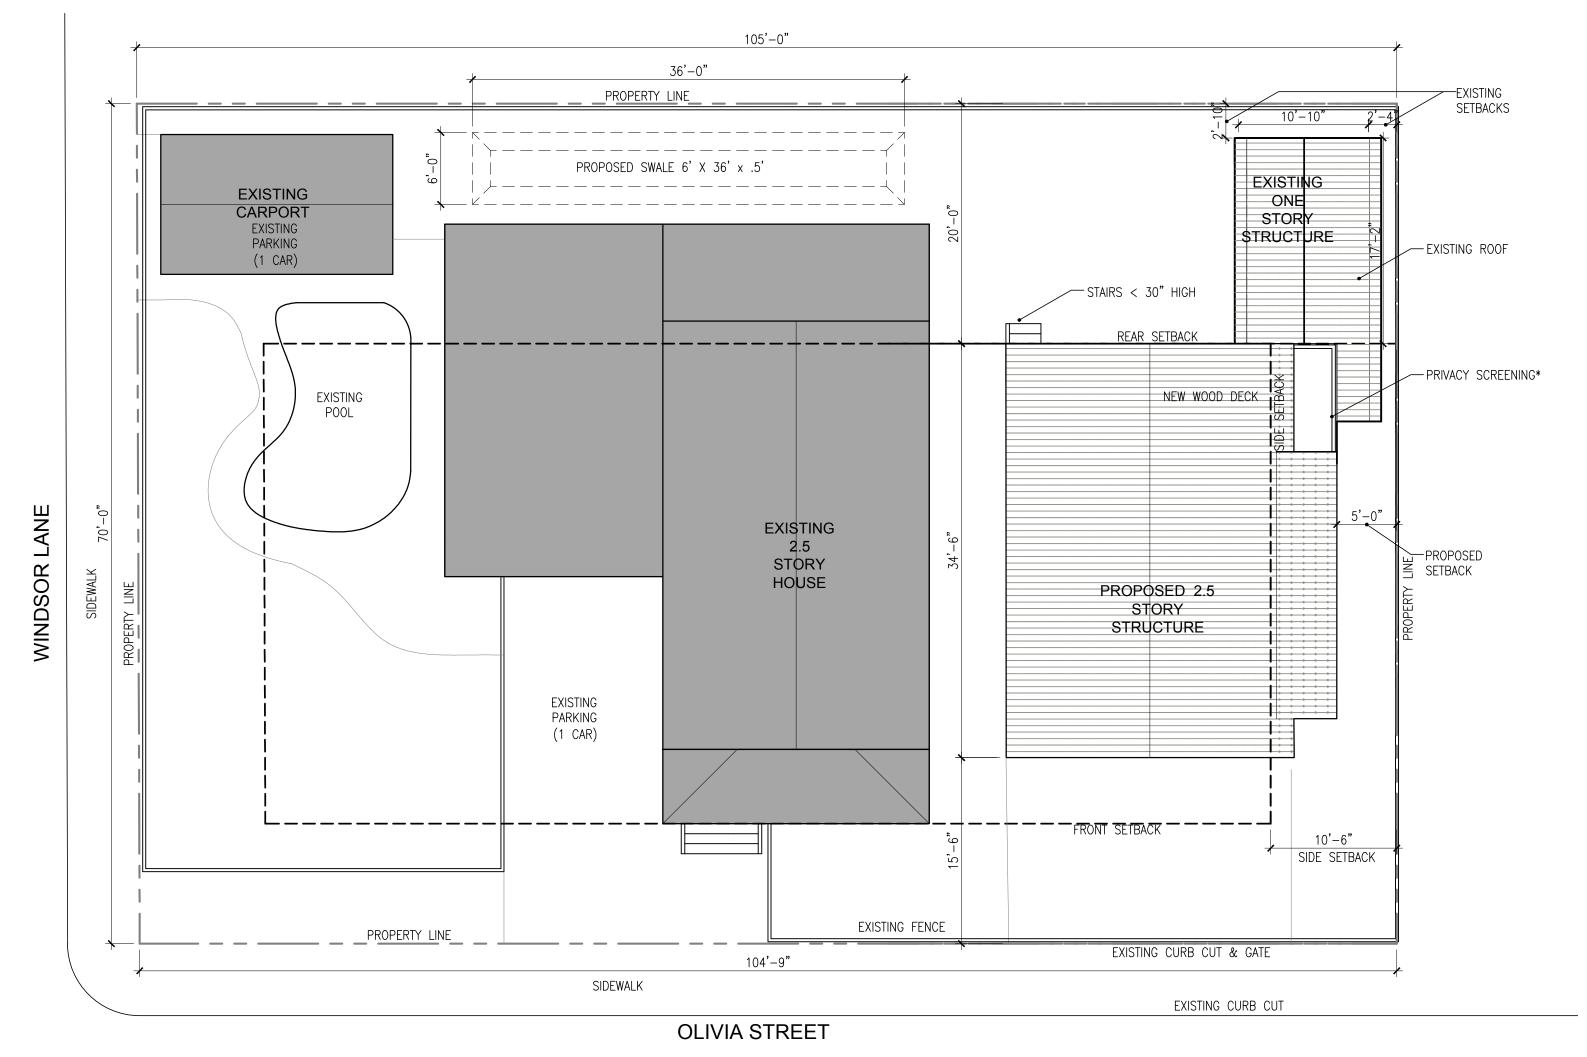

TREES NEAR AND WITHIN THE PROJECT AREA (INCLUDING CANOPY IN THE ADJACENT PROPERTY) WILL BE PROTECTED DURING CONSTRUCTION. TREES LOCATED WITHIN THE WORK AREA THAT MAY NEED TO BE REMOVED OR TRIMMED, MAY REQUIRE PERMITS FROM THE TREE COMMISSION. IF A ROOT THE URBAN FORESTRY MANAGER BEFORE COMMENCING ANY WORK THAT WILL RESULT IN SEVERING THE ROOT / ROOTS.

PROPOSED SITE PLAN

SCALE: 1/8"=1'-0"





william shepler Tel: 305-890-6191

Consultants:

Submissions / Revisions: H.A.R.C. SUBMISSION 1 - 2014.4.1

PLANNING SUBMISSION - 2014.12.18

PLANNING REV. 1 - 2015.02.04 PLANNING REV. 2 - 2015.03.04 PLANNING REV. 3 - 2015.5.1


Email: info@wshepler.com

PLANNING REV. 4 - 2015.5.27 H.A.R.C. SUBMISSION 2 - 2015.6.25 H.A.R.C. REVISION 1 - 2015.7.7

805

Drawing Size | Project #: 13022


SITE PLANS / CALCS / SURVEY

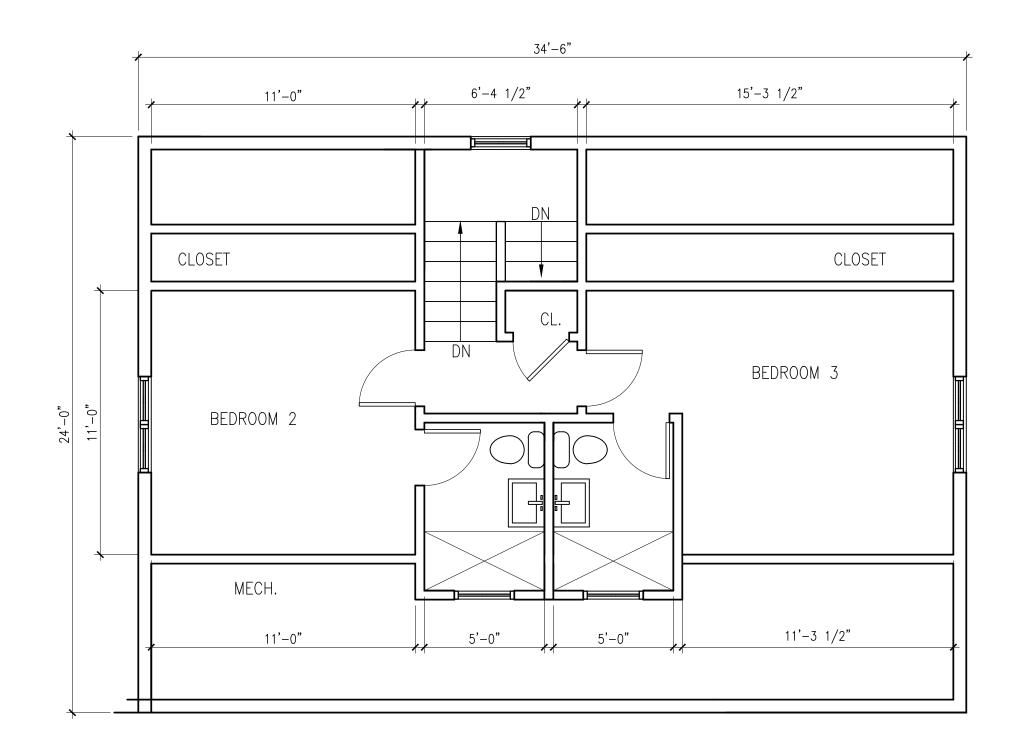




LOFT PLAN

SCALE: 1/4"=1'-0"

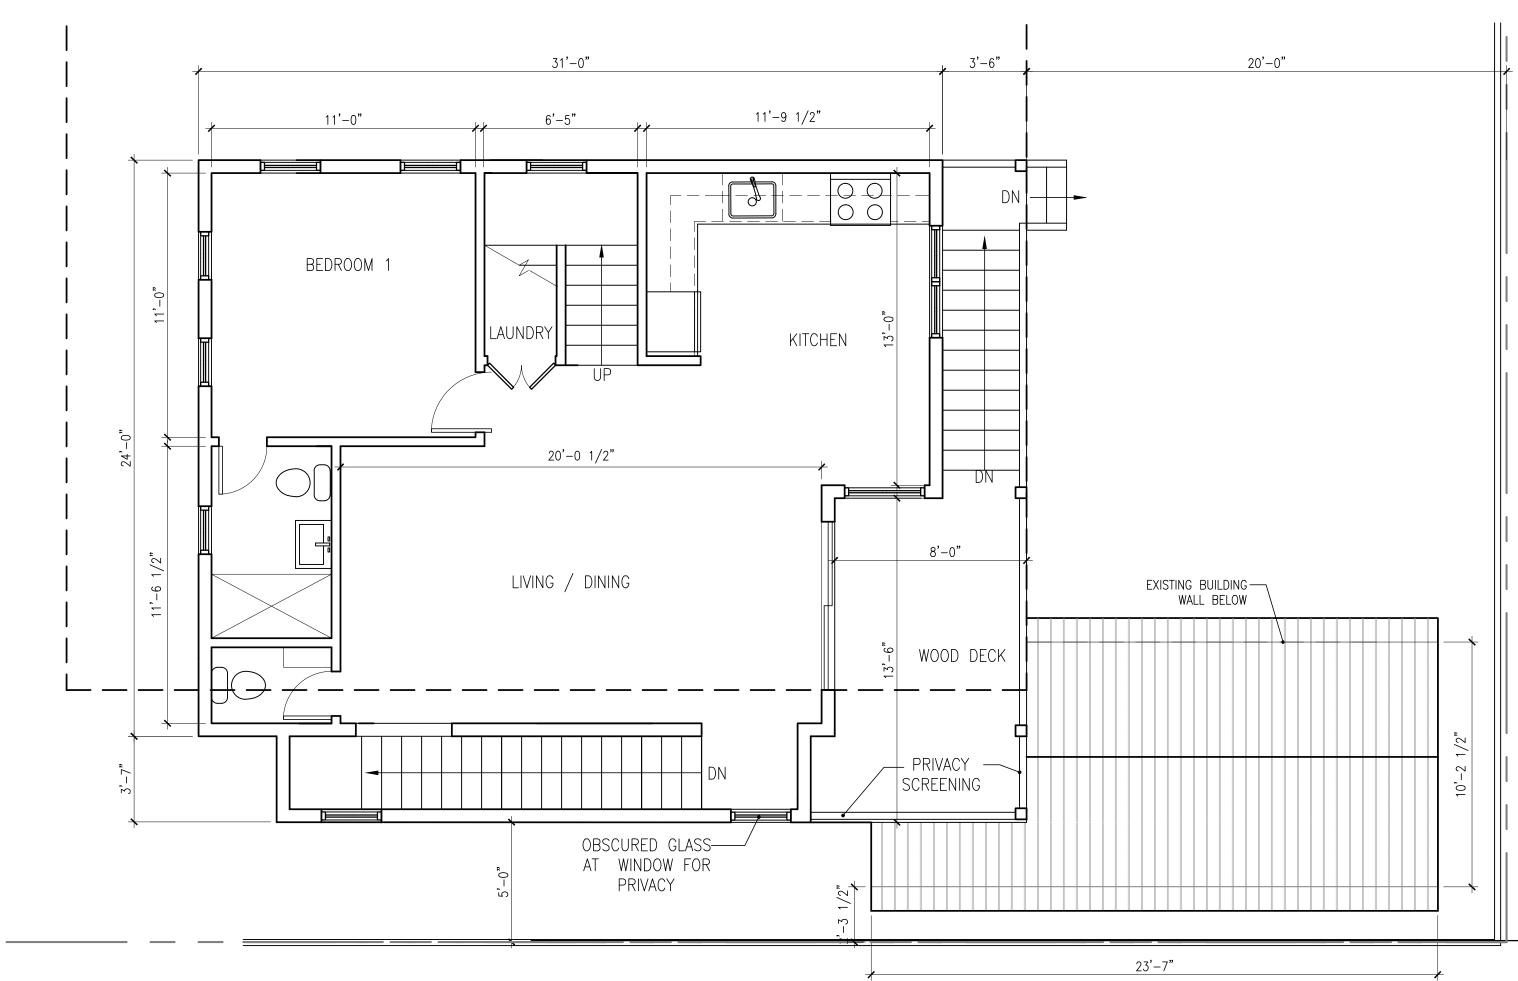



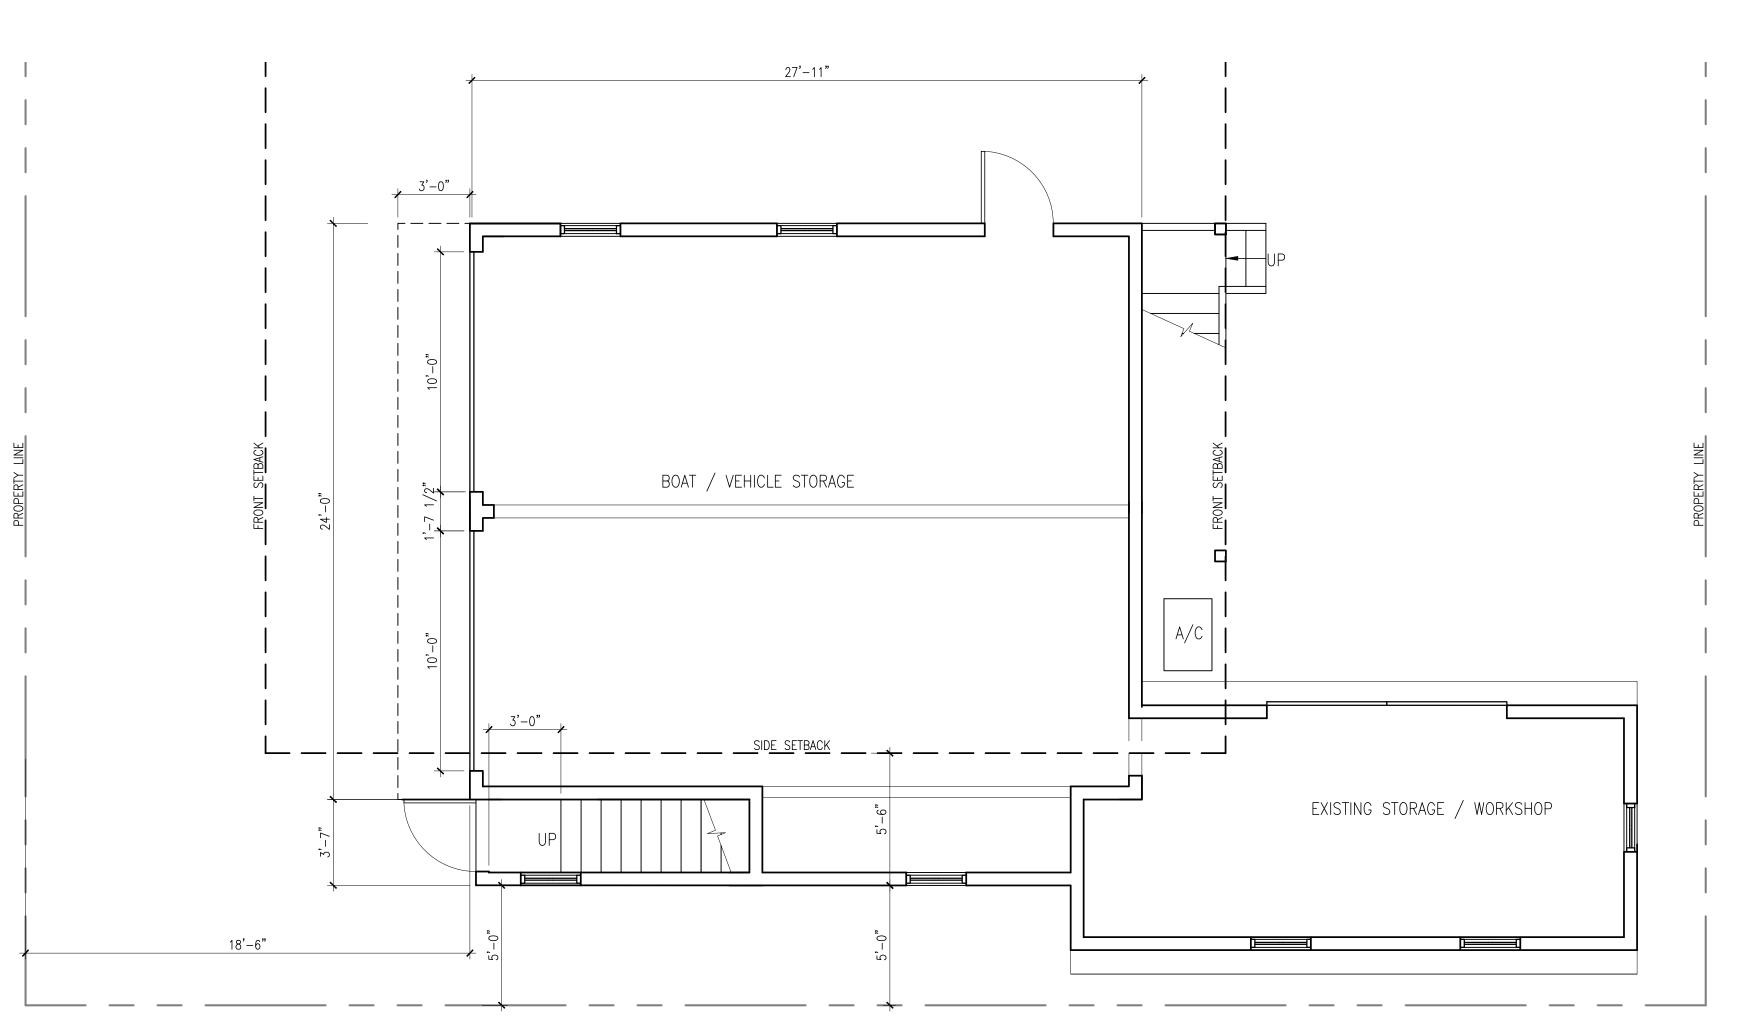



william shepler

Tel: 305-890-6191
Email: info@wshepler.com

Seal:

Consultants:

Submissions / Revisions:

H.A.R.C. SUBMISSION 1 - 2014.4.1

PLANNING SUBMISSION - 2014.12.18

PLANNING REV. 1 - 2015.02.04

PLANNING REV. 2 - 2015.03.04

PLANNING REV. 3 - 2015.5.1

PLANNING REV. 4 - 2015.5.27

H.A.R.C. SUBMISSION 2 - 2015.6.25

JLIVIA SIKEEI EY WEST, FL ESIDENTIAL PROJECT

Drawing Size | Project #: 13022

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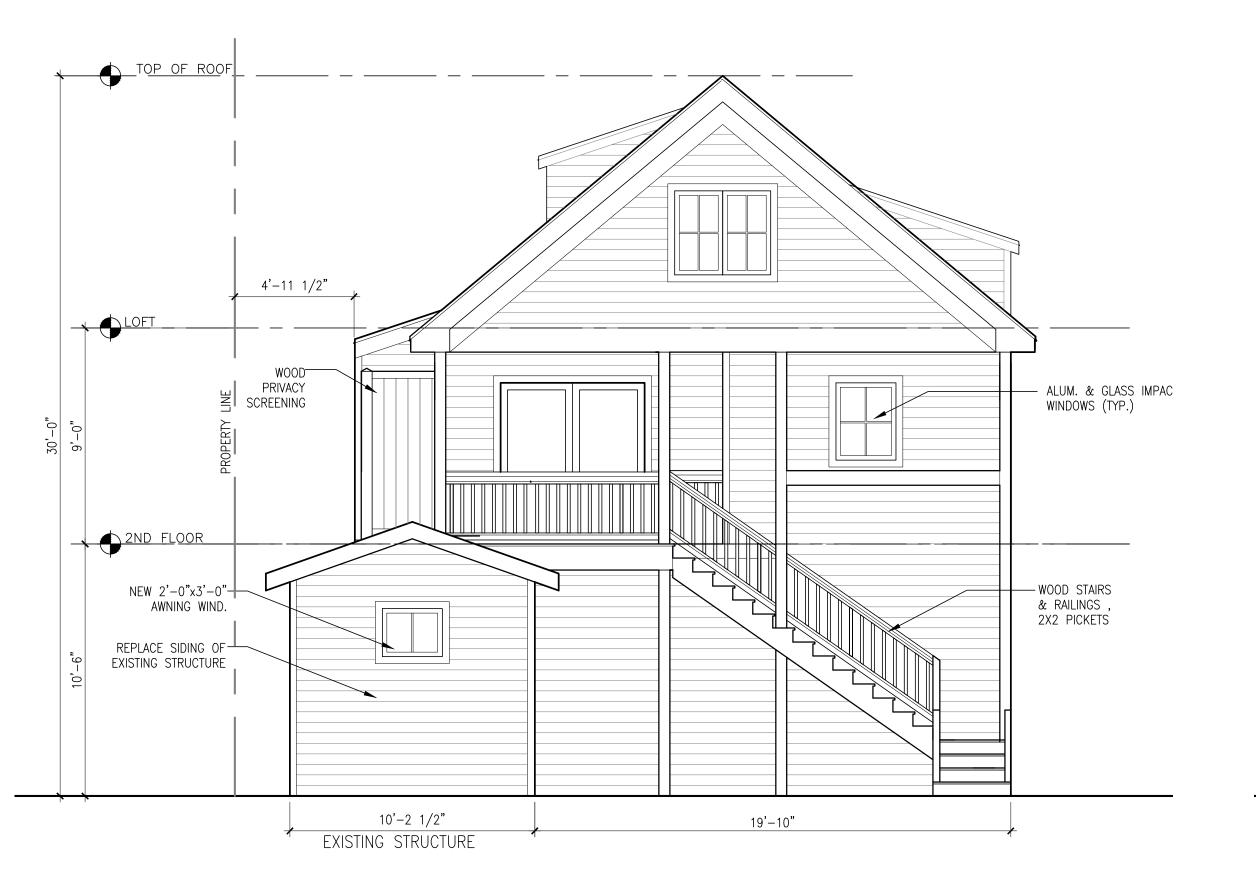
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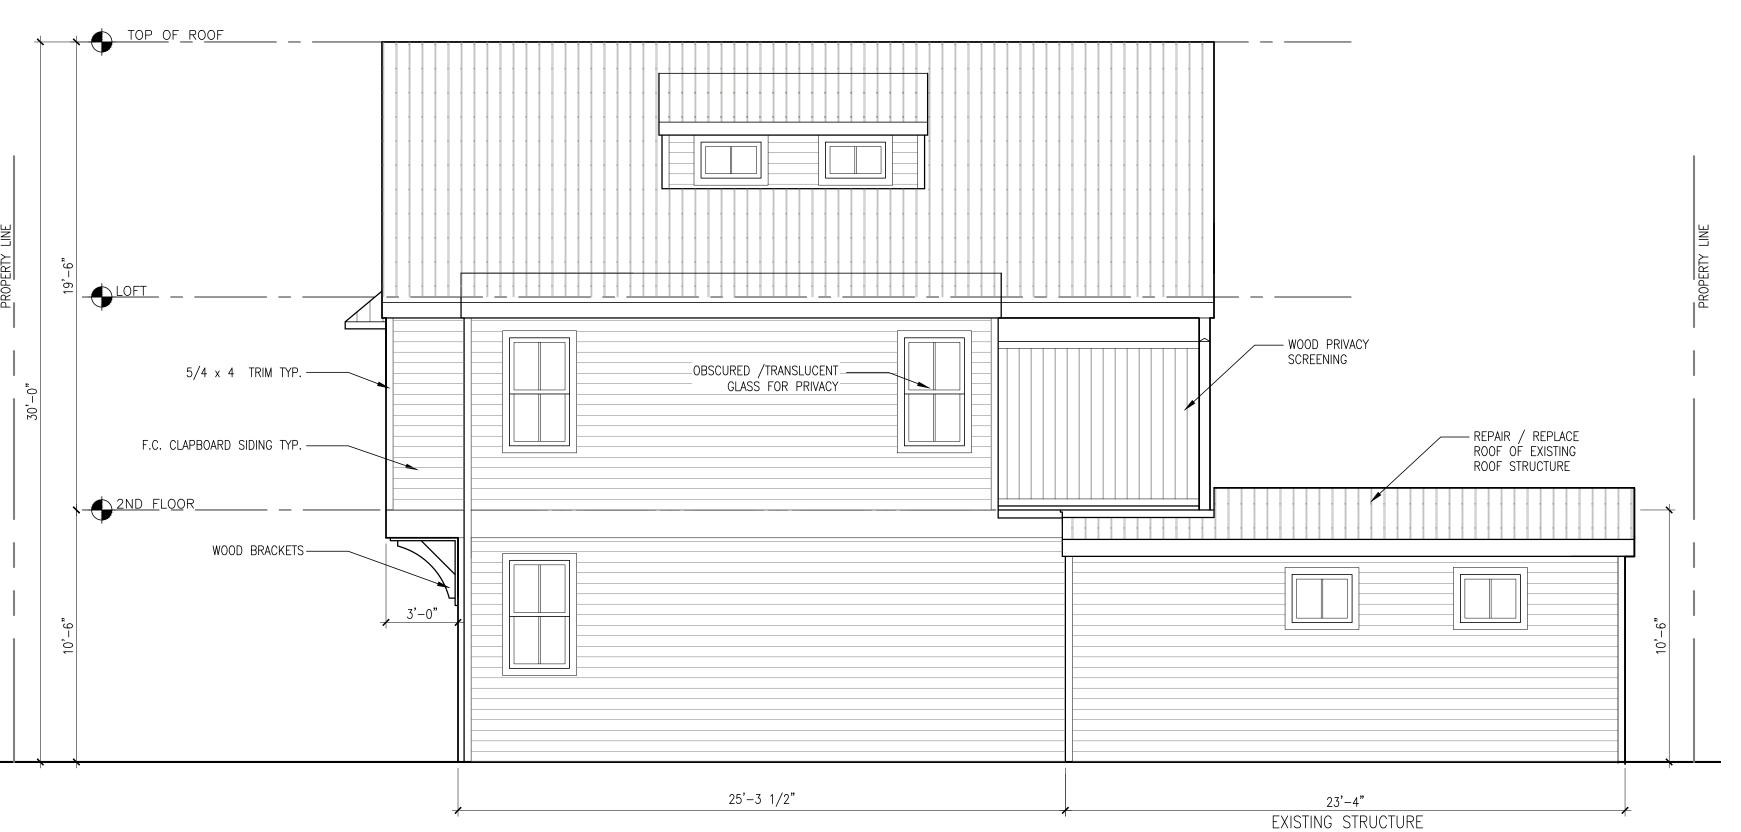
FLOOR PLANS

SCALE: 1/4" = 1'-0"
Sheet Number:

A-2.1

Date: - JUNE 25, 2015
©2015 by William Shepler Architect






4 NORTH ELEVATION
A3.1 SCALE: 1/4"=1'-0"

3 EAST ELEVATION
A3.1 SCALE: 1/4"=1'-0"



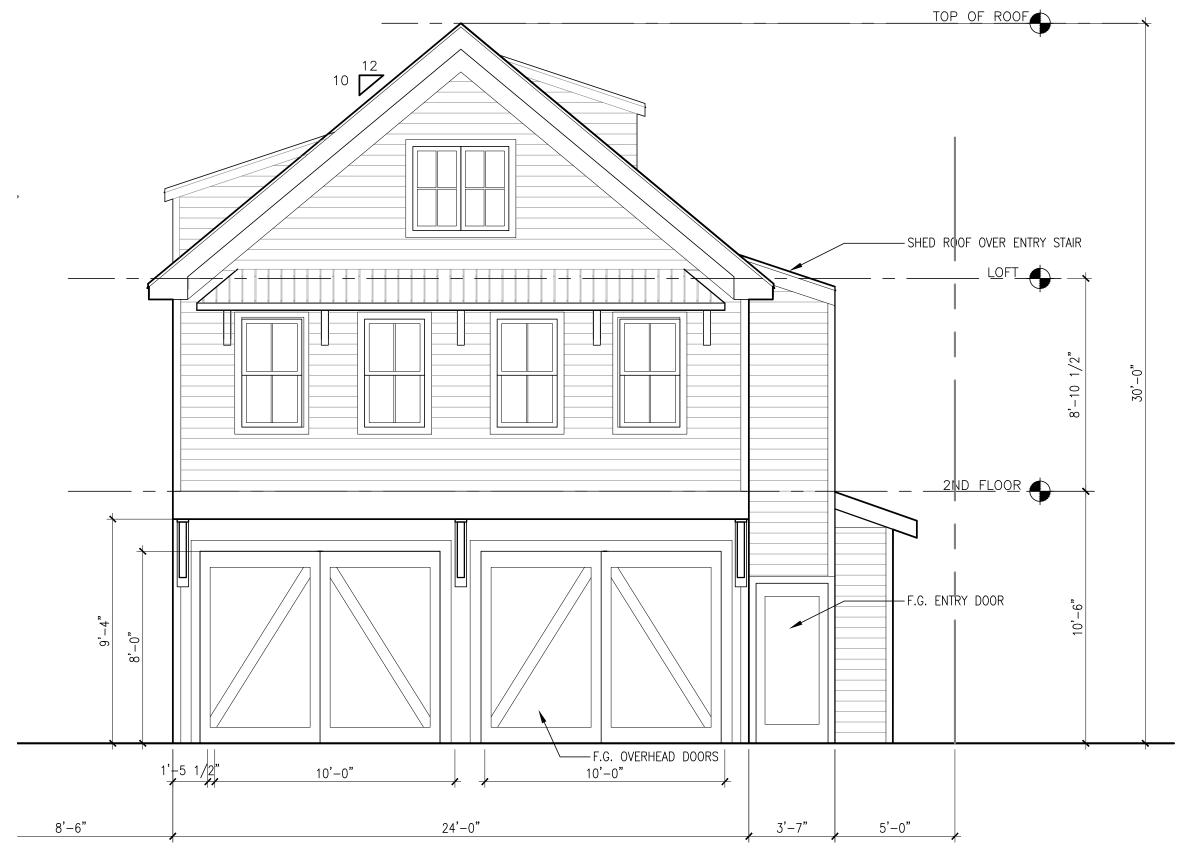

WEST ELEVATION

A3.1 SCALE: 1/4"=1'-0"



william shepler

Tel: 305-890-6191

Email: info@wshepler.com

Seal:

Consultants:

Submissions / Revisions:

H.A.R.C. SUBMISSION 1 - 2014.4.1

PLANNING SUBMISSION - 2014.12.18

PLANNING REV. 1 - 2015.02.04

PLANNING REV. 2 - 2015.03.04

PLANNING REV. 3 - 2015.5.1

PLANNING REV. 4 - 2015.5.27

H.A.R.C. SUBMISSION 2 - 2015.6.25

805 OLIVIA STREET
KEY WEST, FL
NEW RESIDENTIAL PROJECT

Drawing Size | Project #: 13022

PROPOSED ELEVATIONS

SCALE: 1/4" = 1'-0"

Sheet Number:

Date: - JUNE 25, 2015


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Impact Resistant Windows & Doors



EVERYWHERE QUALITY, BEAUTY and STRENGTH MATTER



Tests have proven that many of our products withstand winds of nearly 300 MPH. CGI windows and doors exude quality without compromise. As the premier manufacturer of impact resistant windows and doors, our products offer superior strength, energy efficiency and beauty. Every detail reflects our commitment to exceptional quality, from our strong commercial-grade aluminum frames to impact resistant glass

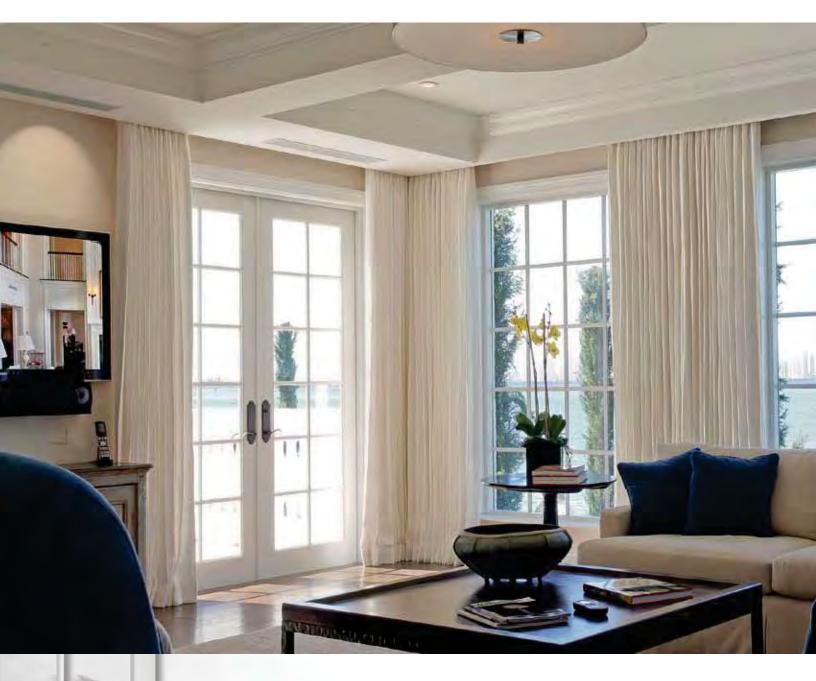



options and finest hardware components.

The best choice for hurricane prone coastal regions, the CGI Estate Collection exceeds the Miami-Dade county and Florida building codes, considered some of the most rigorous in the industry and assures best-in-class performance against

high winds and violent storms. Found in many of the most prestigious residential homes, office buildings and resorts, including the historic Breakers Hotel in Palm Beach, Florida, CGI windows and doors are everywhere quality, beauty and strength matter.

LARGER STAINLESS STEEL FASTENERS

THE DIFFERENCE SUPERIOR ENGIN



ESTATE

We use #10-1 ¼ inch stainless steel fasteners in each window frame corner. Bigger, longer screws means more frame strength, greater longevity and better hurricane resistance.



Theirs

Others use #8-1-inch galvanized screws in each corner.

OVER 100% HIGHER DESIGN PRESSURES



ESTATE

The higher the max design pressure the more resistant to hurricane strength winds. Our design pressure max is +110/-195.

Theirs

Max design pressure is only +70/-90.

THICKER LAMINATED GLASS



ESTATE

Most Estate products use thicker glass.



Theirs

Typically use thinner glass.



EERING makes IS CRYSTAL CLEAR

DISTINCTIVE MUNTIN/GRID DETAILS



ESTATE Our highly contoured muntin provides a

fashionable look.



Theirs Some competitors offer basic, less contoured muntins that lack real style.

ATTRACTIVE GLAZING BEAD TRIM



Ogee



Theirs Only available in

square.

ESTATE

Designed to look like wood. Square is also available.

THICKER ALUMINUM FRAME



ESTATE

Strength starts with an aluminum extrusion. At .090 ours is 45% thicker.



Theirs Standard aluminum thickness is just .062".



The Historic Architectural Review Commission will hold a public hearing at 5:30 p.m., July 28, 2015 at Old City Hall, 510 Greene Street, Key West, Florida. The purpose of the hearing will be to consider a request for:

REVISIONS TO PREVIOUSLY APPROVED PLANS FOR A NEW TWO AND A HALF-STORY FRAME STRUCTURE.

FOR-#803-805 OLIVIA STREET

Applicant- William Shepler, Architect

Application # H15-01-1021

If you wish to see the application or have any questions, you may visit the Planning Department during regular office hours at 3140 Flagler Avenue, call 305-809-3973 or visit our website at www.cityofkeywest-fl.gov

THIS NOTICE CAN NOT BE REMOVED FROM THE SITE UNTIL HARC FINAL DETERMINATION

PROPERTY APPRAISER INFORMATION

» Tax Collector

Monroe County Cities

- » City of Key West
- » City of Marathon
- » City of Key Colony Beach
- » City of Layton
- » Islamorada, Village of Islands

First Time Home Buyer (IRS)

- » Cancellation of Debt Flyer (English)
- » Cancellation of Debt Flyer (Spanish)
- » 1st Time Homebuyers Fact Sheet
- » 1st Time Homebuyers Basic Information
- » 1st Time Homebuyers Scenarios
- » 1st Time Homebuyers O& A's

IRS Links

- » Make Work Pay Credit
- » Energy Conservation Credit

Other Links

- » FL Dept Rev Property Tax Oversight
- » Census Info

Property Record Card -

Maps are now launching the new map application version.

Return to Search Results | Modify Search | New Search | Send Email to MCPA Regarding this Parcel | Estimate Taxes on this Parcel

Previous Record Alternate Key: 1020621 Parcel ID: 00019930-000000 Next Record

Ownership Details

Mailing Address: MINEROFF BRUCE S AND SHARON 20 MOLLY PITCHER DR MANALAPAN, NJ 07726-8937

Property Details

Property Search -- Monroe County Property Appraiser

PC Code: 01 - SINGLE FAMILY

Millage Group: 10KW Affordable Housing: No

Section-Township-

Range:

06-68-25

Property Location:

803 OLIVIA ST KEY WEST 805 OLIVIA ST KEY WEST

Legal Description:

KW PT OF TR 5 G28-454/455 OR775-787 OR1531-2082/84 OR1581-1964/65 OR2023-

645/46T/C OR2498-2029/31

Click Map Image to open interactive viewer





Land Details

Land Use Code	Frontage	Depth	Land Area
010D - RESIDENTIAL DRY	105	70	7,350.00 SF

Building Summary

Number of Buildings: 1
Number of Commercial Buildings: 0
Total Living Area: 2272
Year Built: 1938

Building 1 Details

Building Type	R1	Condition	G	Quality Grade	600
Effective Age	10	Perimeter	288	Depreciation %	8
Year Built	1938	Special Arch	0	Grnd Floor Area	2,272
	0	E : 01			

Functional Obs 0 Economic Obs 0

Inclusions: R1 includes 1 3-fixture bath and 1 kitchen.


Roof Type GABLE/HIP Roof Cover METAL Foundation WD CONC PADS Heat 1 NONE Heat 2 NONE Bedrooms 3

Heat Src 1 NONE Heat Src 2 NONE

Extra Features

Extra Features:			
2 Fix Bath	2	Vacuum	0
3 Fix Bath	2	Garbage Disposal	0
4 Fix Bath	0	Compactor	0
5 Fix Bath	0	Security	0
6 Fix Bath	0	Intercom	0
7 Fix Bath	0	Fireplaces	0

Extra Fix 0 Dishwasher 0

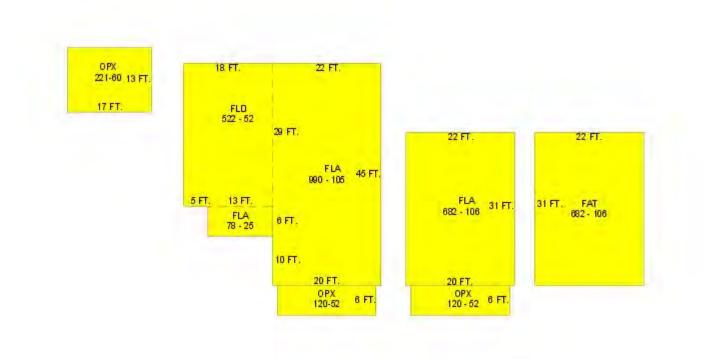

Sections:

Nbr	Type	Ext Wall	# Stories	Year Built	Attic A	A/C	Basement %	Finished Basement %	Area
0	OPX		1	2012					221
0	FAT		1	1938					682
0	FLA	12:ABOVE AVERAGE WOOD	1	2012		Y			78
1	FLA	12:ABOVE AVERAGE WOOD	1	1938	N	Y	0.00	0.00	990
2	OPX		1	1938			0.00	0.00	120
3	FLA	12:ABOVE AVERAGE WOOD	1	1938	N	Y	0.00	0.00	682
4	OPX		1	1938			0.00	0.00	120
7	FLD	12:ABOVE AVERAGE WOOD	1	2005	N	Y			522

Misc Improvement Details

Nbr	Type	# Units	Length	Width	Year Built	Roll Year	Grade	Life
0	PT3:PATIO	264 SF	24	11	2012	2013	2	50

2	FN2:FENCES	480 SF	6	80	2001	2002	2	30
3	FN2:FENCES	408 SF	4	102	2012	2013	2	30
4	PT2:BRICK PATIO	54 SF	9	6	2005	2006	4	50
5	PT2:BRICK PATIO	48 SF	16	3	2005	2006	4	50
6	WF2:WATER FEATURE	1 UT	0	0	2005	2006	1	20
9	PO3:RES POOL GNIT	201 SF	0	0	2005	2007	5	40
10	UB2:UTILITY BLDG	297 SF	27	11	1940	1941	3	50
11	PT3:PATIO	738 SF	0	0	2005	2006	2	50

Appraiser Notes

2007-02-26 - LISTED FOR \$2,275,000. VAULTED CEILINGS & DADE COUNTY PINE JEN
2006-12-19 - LISTED FOR \$2.5 MIL. 3/3 W/ POOL. 2 ROGO UNITS JEN
2004-08-10 ASKING \$1,850,000 THREE 1 BR/1BA UNITS IN MAIN HOUSE W/GUEST COTTAGE OR
CONVERT O A SFR.7,300 SF CORNER PROPERTY, FROM THE KW CITIZEN-SKI
2007-11-01 SALES FLYER \$1,995,000 2 ROGO'S 3/3.DKRAUSE
TPP AK-8582404.

Building Permits

Bldg	Nu	mber		Date Issued	ŀ	Co	Date omple	e eted	Amount	Description	Notes
	11-	2752 (08	8/16/20					29,000		ENCLOSED EXISTING DECK AREA 175sf ROOF WINDOWS BATH
	11-	2910	08	8/16/20)11	. 03	/15/2	012	10,300		TO CONSTRUCT A BATH INDOORS IN EXISTING BLDG NEW TILE, DOORS, PARTITIONS
	11-	1415 (08	3/30/20)11	. 03	/15/2	012	25,000		ADD STARI TO ATTIC, ADD 1.5 BATH IN ATTIC, REPLACE CENTRAL AC ON 2ND FLR WITH SPLIT SYSTEM, ADD SPLIT SYSTEM IN ATTIC, FINISH 288sf PINE FLOORING, 400sf FINISH WALLS, 720sf INSULATION
1	12-	0338 (08	8/28/20)12	2 03	/15/2	012	12,980	Residential	REPLACE EXISTING SWINGING DRIVEWAY GATES WITH SINGLE SLIDING GATE
	11-	3658	10	/25/20)11	03	/15/2	012	4,600		NEW CURB CUT CONCRETE DRIVEWAY 11X24
	11-	4526	12	2/14/20)11	03	/15/2	012	9,500		SCRAPE AND PAINT 2 STORY HOUSE. INSTALL NEW FRONT DOOR, REPLACE 20 PCS OF SIDING,
	11-	3961	10	/27/20)11	03	/15/2	012	6,500		INSTALL 2 BATHROOMS,2 LAVS,2 TOILETS
	11-	4110	01	/09/20)11	03	/15/2	012	1,950		R&R EXISTING DUCT WORK
1	00	-214	02	2/07/20	000	10	/22/2	001	1,200	Residential	FENCE
1	00	-966 (04	-/25/20	000	10	/22/2	001	3,000	Residential	FENCE AND PORCH REPAIRS
1	01/	/3605 (05	5/03/20	002	2 1 1	/26/2	002	5,000	Residential	PAINT EXTERIOR
1	04-	2545	07	7/30/20)04	11	/16/2	005	28,000	Residential	GNT POOL, ELEC, DECK
1	05-	0061	01	/31/20)05	5 1 1	/16/2	005	135,500	Residential	REMODEL INTERIOR EXISTING BUILDING
1	05-	0624	03	3/05/20)05	5 11	/16/2	005	144,500	Residential	CONVERT R-2 TO R-1 BUILD NEW ADDITION & CARPORT
1	05-	0922	03	3/23/20	05	5 11	/16/2	005	10,000	Residential	REPLACE 12 SQS OF V-CRIMP ROOFING
1	05-	1053	04	/05/20	05	5 11	/16/2	005	26,000	Residential	DEMO EXISTING POOL FOR NEW LOCATION
1	05-	2270	06	5/08/20	05	5 11	/16/2	005	1,000	Residential	HOOK UP SWIMMING POOL PUMP

1	05-3647 08/25/2005 11/16/2005	9,000	Residential	INSTALL TWO A/C SYSTEMS
1	05-3643 09/16/2005 11/16/2005	1,800	Residential	INSTALL 4 SQUARES V-CRIMP ROOFING
1	05-3886 09/23/2005 11/16/2005	2,000	Residential	DEMO EXISTING SINGLE STORY STRUCTURE
1	05-5354 12/06/2005 12/31/2006	2,000	Residential	BUIILD PICKET FENCE ALONG FRONT
1	05-4464 01/04/2006 12/31/2006	2,200	Residential	RED TAG - INSTALL BRICK PAVERS

Parcel Value History

Certified Roll Values.

View Taxes for this Parcel.

Roll Year	Total Bldg Value	Total Misc Improvement Value	Total Land Value	Total Just (Market) Value	Total Assessed Value	School Exempt Value	School Taxable Value
2014	330,638	28,690	568,348	927,676	856,084	0	927,676
2013	295,078	27,021	489,933	812,032	778,259	0	812,032
2012	298,217	27,809	381,483	707,509	707,509	0	707,509
2011	298,217	28,737	362,093	689,047	689,047	0	689,047
2010	327,946	30,654	443,957	802,557	802,557	0	802,557
2009	364,135	31,636	674,815	1,070,586	1,070,586	0	1,070,586
2008	334,444	32,410	978,282	1,345,136	1,345,136	0	1,345,136
2007	540,571	28,474	886,788	1,455,833	1,455,833	0	1,455,833
2006	479,401	8,536	668,610	1,156,547	1,156,547	0	1,156,547
2005	548,618	6,234	537,540	1,092,392	1,092,392	0	1,092,392
2004	327,059	7,935	442,680	777,674	777,674	0	777,674
2003	314,946	8,131	221,340	544,417	544,417	0	544,417
2002	307,248	8,285	148,614	464,147	464,147	0	464,147
2001	283,041	3,721	148,614	435,376	435,376	0	435,376
2000	241,635	6,753	107,508	355,895	355,895	0	355,895
1999	205,130	5,594	107,508	318,231	318,231	0	318,231
1998	197,160	2,378	107,508	307,046	307,046	0	307,046
1997	187,302	2,316	94,860	284,478	284,478	0	284,478
1996	116,684	1,538	94,860	213,081	213,081	0	213,081
1995	116,684	962	94,860	212,506	212,506	0	212,506
1994	104,352	893	94,860	200,105	200,105	0	200,105
1993	112,848	839	94,860	208,547	208,547	0	208,547
1992	133,734	849	94,860	229,443	229,443	0	229,443
1991	133,734	859	94,860	229,453	229,453	0	229,453
1990	104,904	789	74,307	180,000	180,000	0	180,000
1989	106,476	798	72,726	180,000	180,000	0	180,000
1988	70,381	807	63,240	134,428	134,428	0	134,428
1987	63,447	816	34,150	98,413	98,413	0	98,413
1986	63,750	824	34,150	98,724	98,724	0	98,724
1985	62,089	833	22,766	85,688	85,688	0	85,688
1984	58,652	842	22,766	82,260	82,260	0	82,260
1983	58,652	851	22,766	82,269	82,269	0	82,269

1982 59,607 859 20,363 80,829 80,829 0 80,829

Parcel Sales History

NOTE: Sales do not generally show up in our computer system until about two to three months after the date of sale. If a recent sale does not show up in this list, please allow more time for the sale record to be processed. Thank you for your patience and understanding.

Sale Date	Official Records Book/Page	Price	Instrument	Qualification
12/29/2010	2498 / 2029	760,000	WD	02
6/30/2004	2023 / 0645	1,150,000	WD	Q
6/14/1999	1581 / 1964	390,000	WD	Q
8/10/1998	1531 / 2082	325,000	WD	Q
11/1/1978	775 / 787	85,000	00	Q

This page has been visited 121,226 times.

Monroe County Property Appraiser Scott P. Russell, CFA P.O. Box 1176 Key West, FL 33041-1176