RESIDENTIAL NEW CONSTRUCTION

3900 SOUTH ROOSEVELT BOULEVARD, KEY WEST, FLORIDA 33040

DEVELOPMENT AGREEMENT APPLICATION

FEBRUARY 16, 2016 (Revised Date: April 15, 2016)

PROJECT TEAM

OWNER / DEVELOPER:

Ocean Walk Key West Owner, LLC 119 Washington Ave., Suite 505 Miami Beach, Florida 33033

ARCHITECT:

K2M Design, Inc. 1001 Whitehead Street, Suite 101 Key West, Florida 33040 305.292.7722 Scott C. Maloney, R.A. Phill Badalamenti, R.A.

ENGINEER:

K2M Design, Inc. 1001 Whitehead Street, Suite 101 Key West, Florida 33040 305.292.7722 Steven Grasley, P.E.

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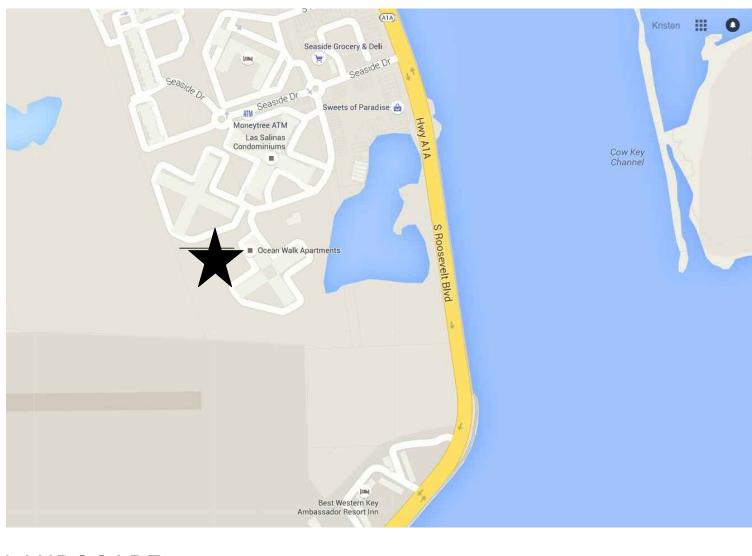
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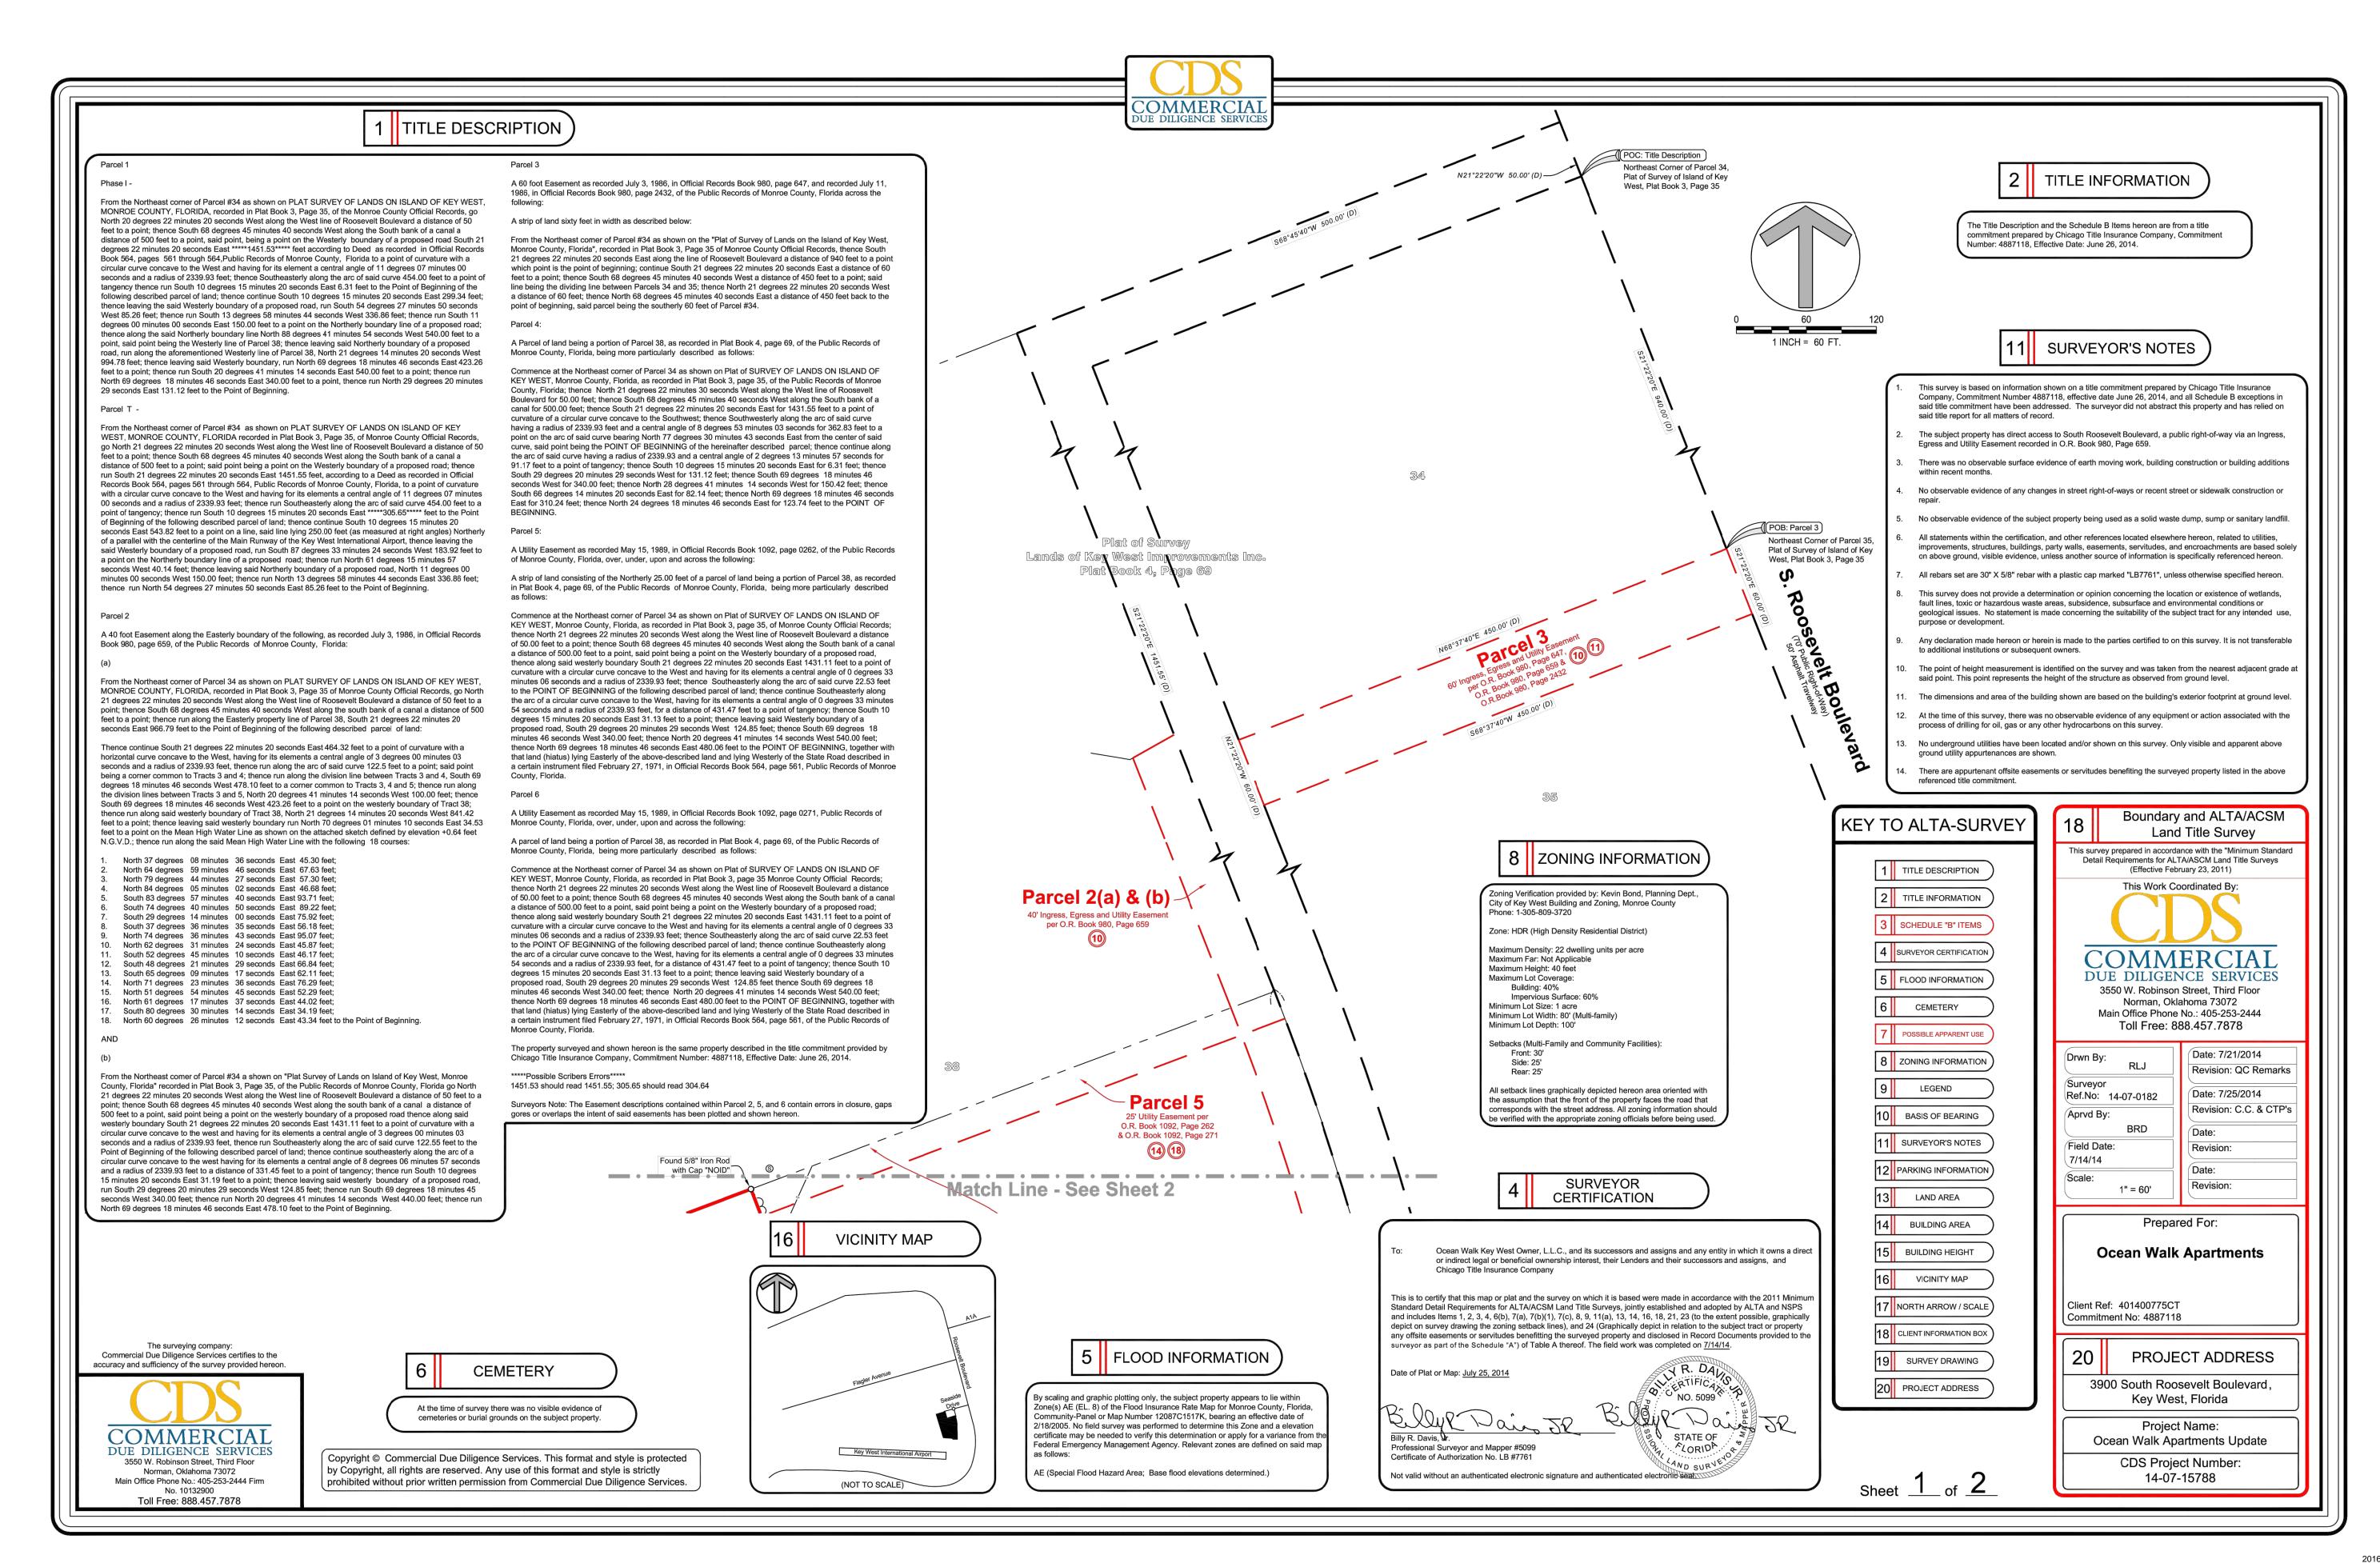
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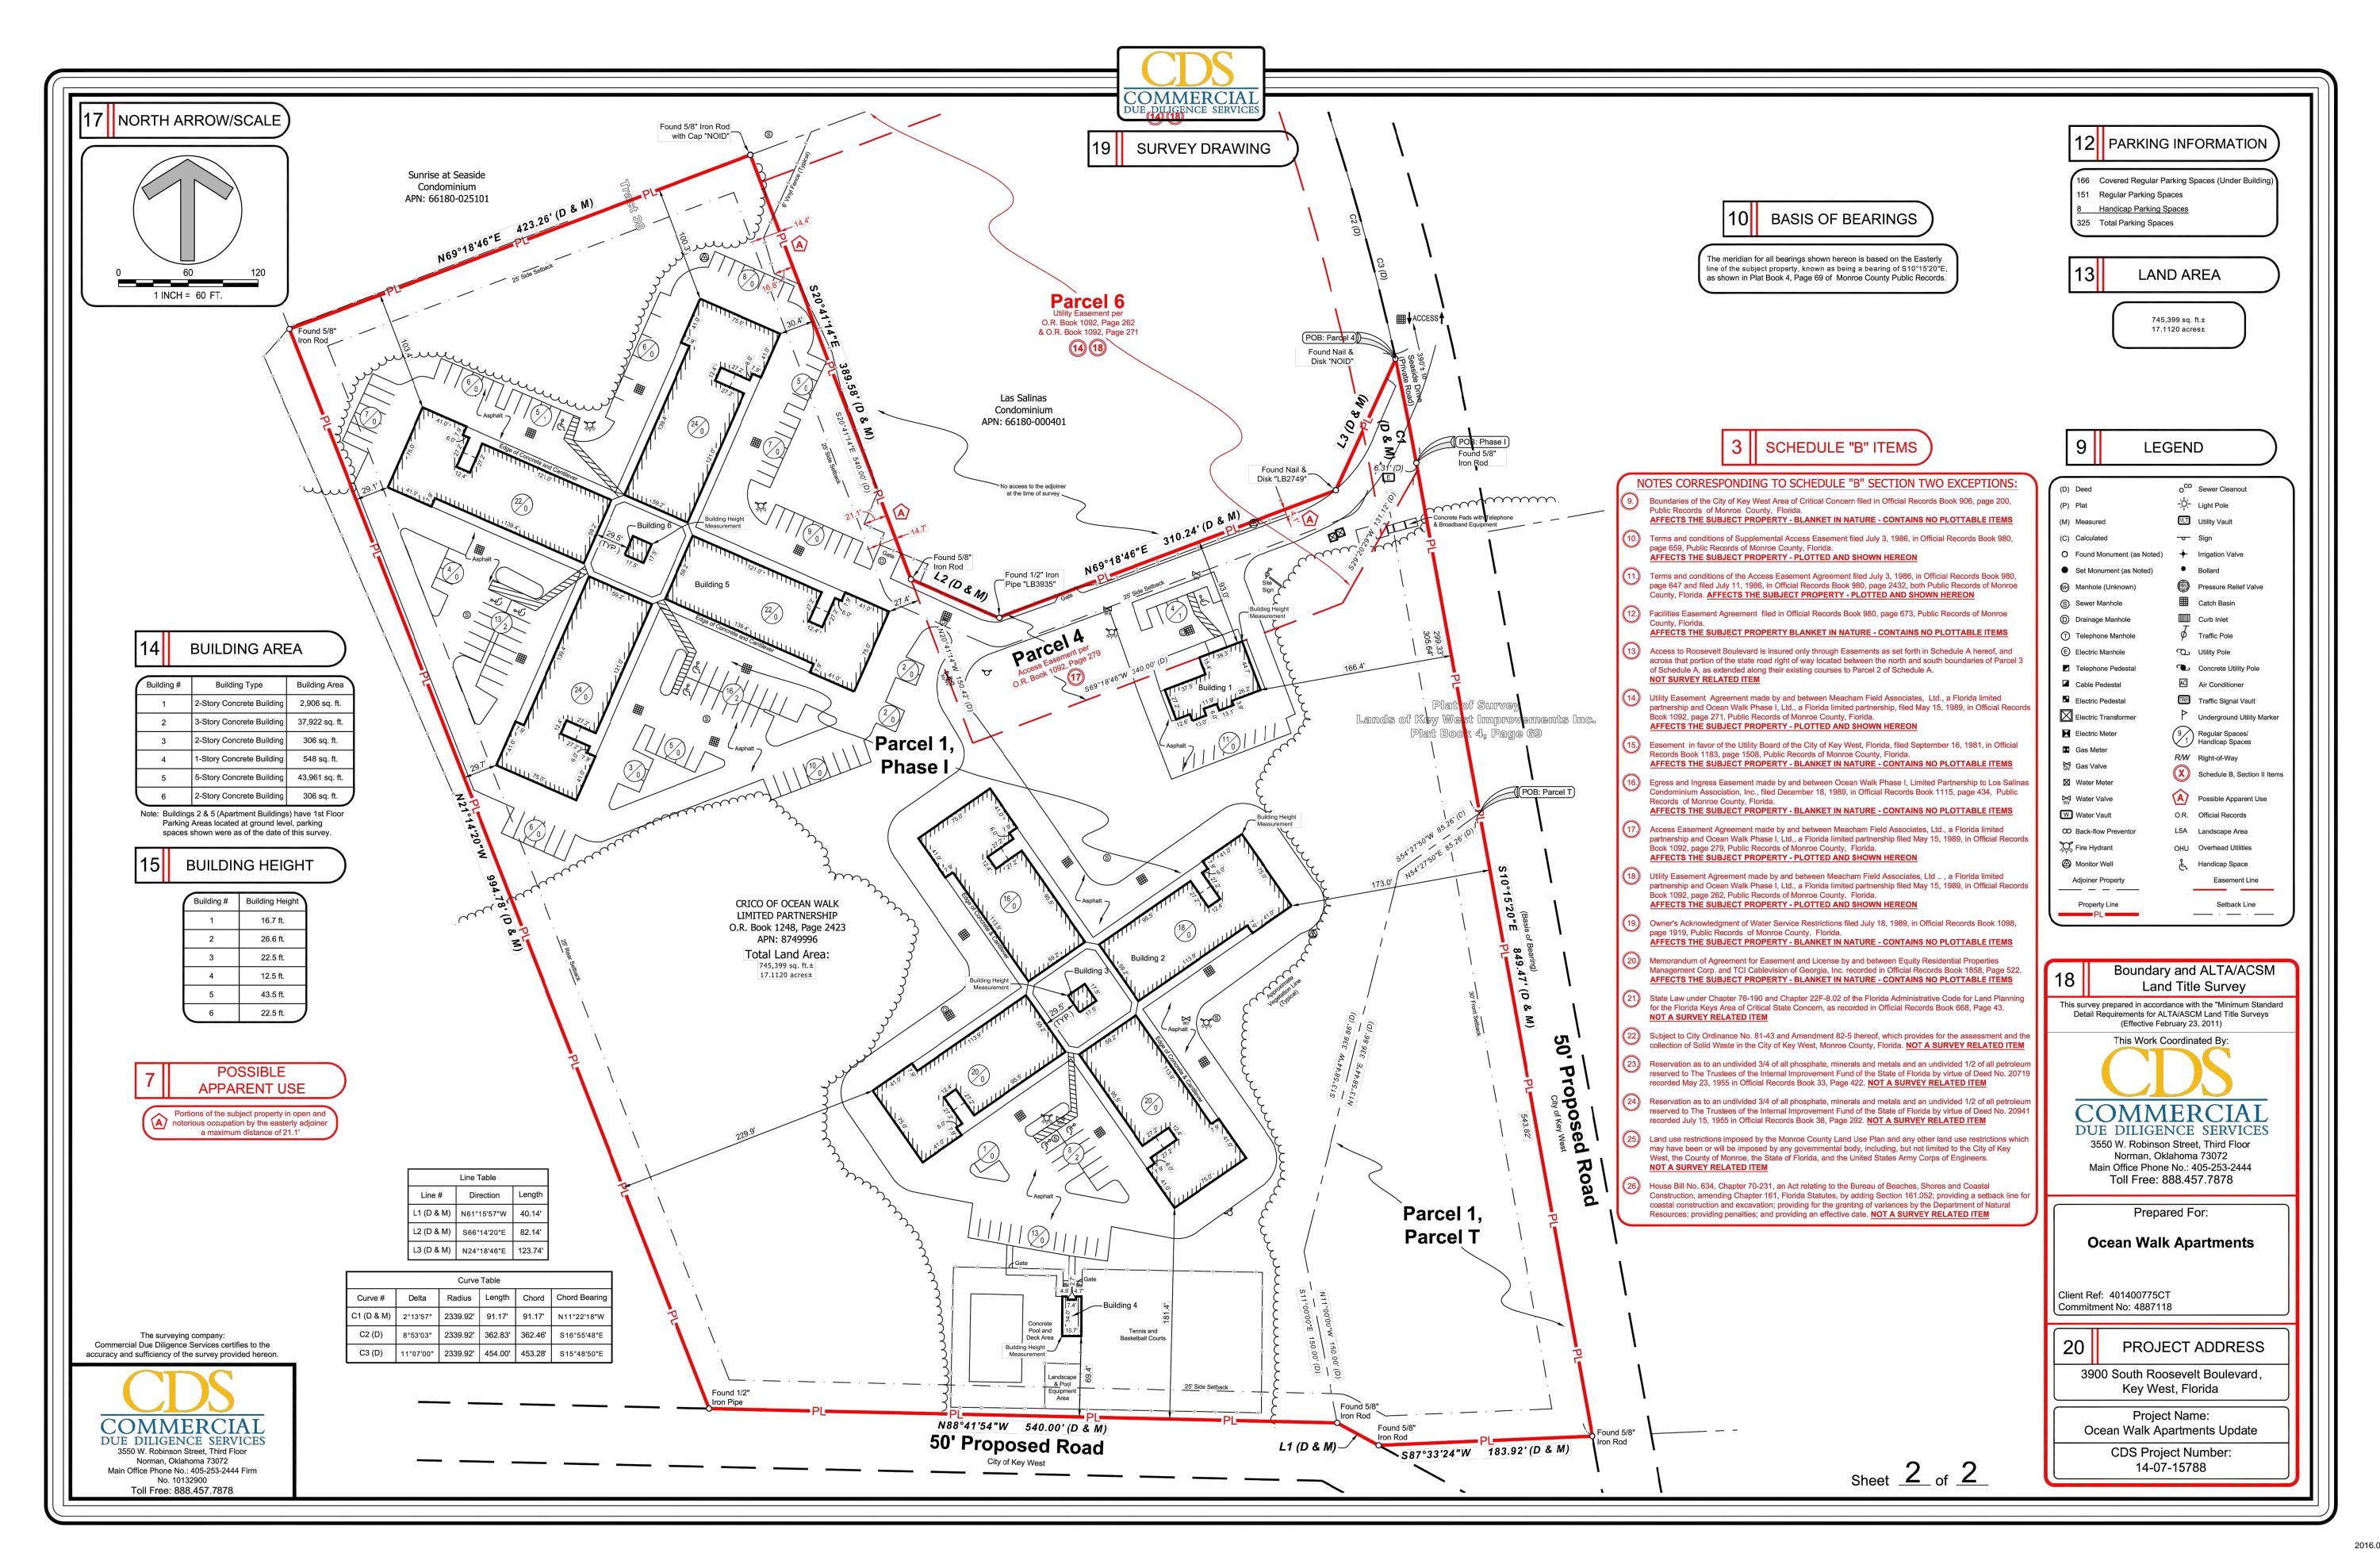
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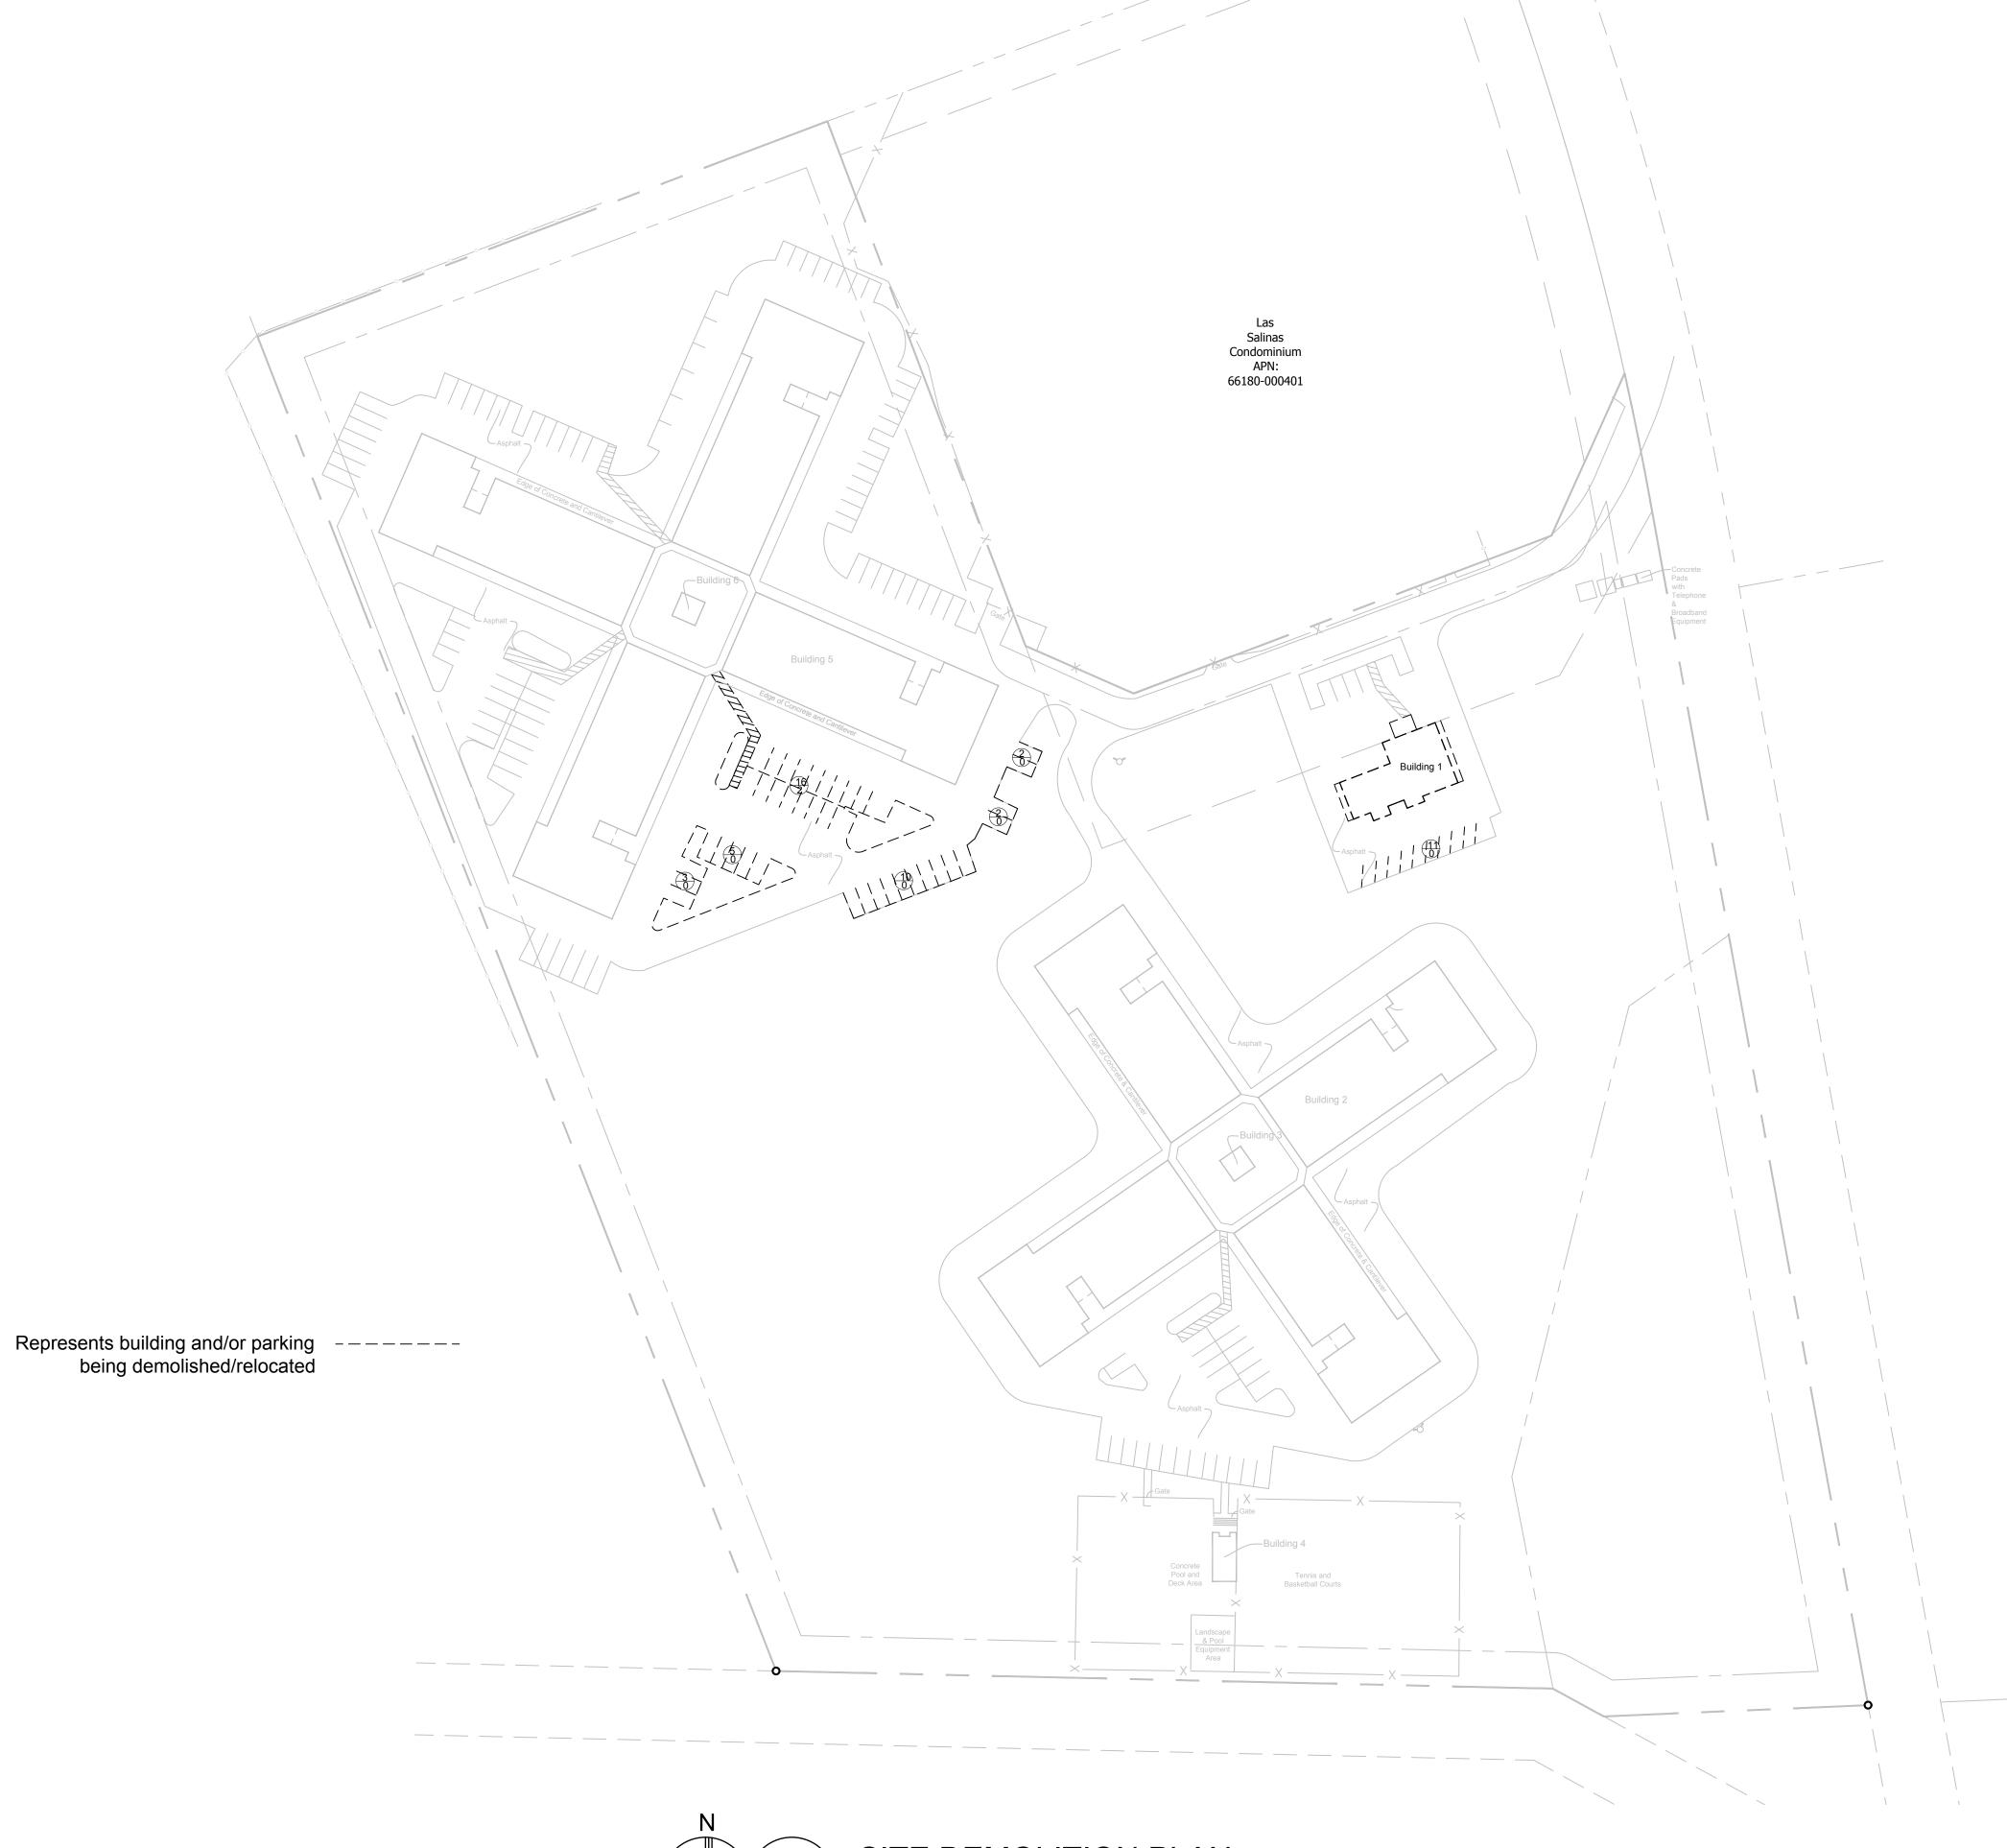






SITE DEMOLITION DATA

Buildings	<u>Demolished</u>		
Building 1			
	Building Area	2,906 sf	(per existing condition survey)
	Building height	16.7 sf	(per existing condition survey)
Demolish	ed Parking Spaces		
	Regular Spaces Demolished	49	
	ADA Spaces Demolished	2	

Note: The parking spaces being removed is being relocated and compensated for in the new layout



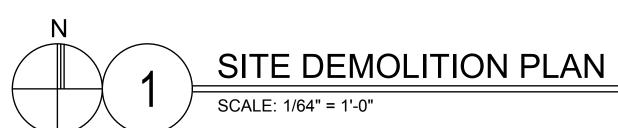

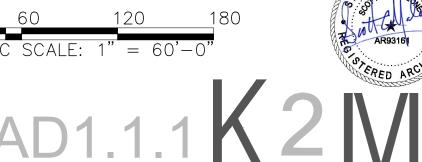

	SITE DATA TA	BLE			
	Ocean Walk- 3900 S. Roc	sevelt Blvd.			
GENERAL					
	CODE REQUIREMENT	EXISTING (*A)	PROPOSED	VARIANCE REQUESTED	
ZONING	·	High Density Residential District (HDR)			
FLOOD ZONE		ZONE AE EL 8			
SIZE OF SITE	43,560.00 SF (1.00 ACRE) MIN	745,312.00 SF (17.11 ACRES)	745,312.00 SF (17.11 ACRES)	NONE	
MINIMUM LOT WIDTH	80'-0"	634'-8"	634'-8"	NONE	
MINIMUM LOT DEPTH	100'-0"	691'-0"	691'-0"	NONE	
IMPERVIOUS SURFACE	60% MAX	44.5% (332,171 SQ FT)	49.8% (371,238 SQ FT)	NONE	
OPEN SPACE LANDSCAPING	35% MIN	56% (417,630 SQ FT)	50.1% (386,584 SQ FT)	NONE	
				40 UNITS AWARDED DURING YEAR 2 BPAS. ADDITIONAL 40 UNITS WILL B SUBMITTED FOR YEAR 4 BPAS	
DENSITY	22 DU PER ACRE	296 UNITS (17.30 PER ACRE)	376 UNITS (21.97 PER ACRE)	APPLICATION	

SETBACK 1: FRONT	30'-0"	166'-3.5"	140'-10"	NONE
ETBACK 2: SIDE	25'-0"	30'-5"	30'-5"	NONE
ETBACK 3: STREET SIDE	25'-0"	92'-11"	92'-11"	NONE
SETBACK 4: REAR	25'-0"	29'-2"	29'-2"	NONE

<u>HEIGHTS</u>					
		CODE REQUIREMENT	EXISTING (*A)	PROPOSED	VARIANCE REQUESTED
HEIGHT OF EXISTING BUILDINGS					
	BUILDING 1	40'-0"	16.7 FT	TO BE DEMOLISHED	
	BUILDING 2	40'-0"	26.6 FT	N/A	NONE
	BUILDING 3	40'-0"	22.5 FT	N/A	NONE
	BUILDING 4	40'-0"	12.5 FT	N/A	NONE
	BUILDING 5	40'-0"	43.5 FT	N/A	NONE
	BUILDING 6	40'-0"	22.5 FT	N/A	NONE
EIGHTS OF PROPOSED BUILDINGS (MEASUR	ED FROM CROWN OF ROAD. CROWN OF ROAD MEA	ASURED TO BE 3'-0" BASED ON AVERAGE OF SPOT ELEVATIONS 1	OWARDS THE CENTER OF THE ROAD)		
	DUIL DING A	40' 0"	NI/A	40' 0"	NONE

			PROPOSED DEMOLITION	
	CODE REQUIREMENT	EXISTING (*A)		VARIANCE REQUESTED
BUILDING 1		2,906 SQ. FT	2,906 SQ. FT	
BUILDING 2		37,922 SQ.FT		
BUILDING 3		306 SQ. FT		
BUILDING 4		548 SQ. FT		
BUILDING 5		43,961 SQ. FT		
BUILDING 6		306 SQ. FT		
TOTAL	40% MAX	11.5 % (85,949 SQ FT)		NONE

<u>OSED</u>	CODE REQUIREMENT	PROPOSED	VARIANCE REQUESTED
BUILDING A		15,261.1 SQ FT	
BUILDING B		18,361.5 SQ FT	
TOTAL	40% MAX	4.5 % (33,622.6 SQ FT)	NONE

PARKING DATA TABLE

Existing Parking	Demolished	Proposed
317	49	48
8	2	3
0	0	0
0	0	0


Ratio (Car Parking/Unit) = 325/296 = 1.09 New Buildings (A & B)

	Proposed
Auto	100
H-Cap	1
Bike	167
Scooter	0

TOTAL PROPOSED PARKING

	Code Required	Proposed
	796 (780 standard +	426 (416 standard
Auto	16 ADA)	+ 10 ADA)
Bike	137	173
Scooter	0	0

Ratio (Car Parking/Unit) = 426/376 = 1.13 along with additional 138 bike parking spots.

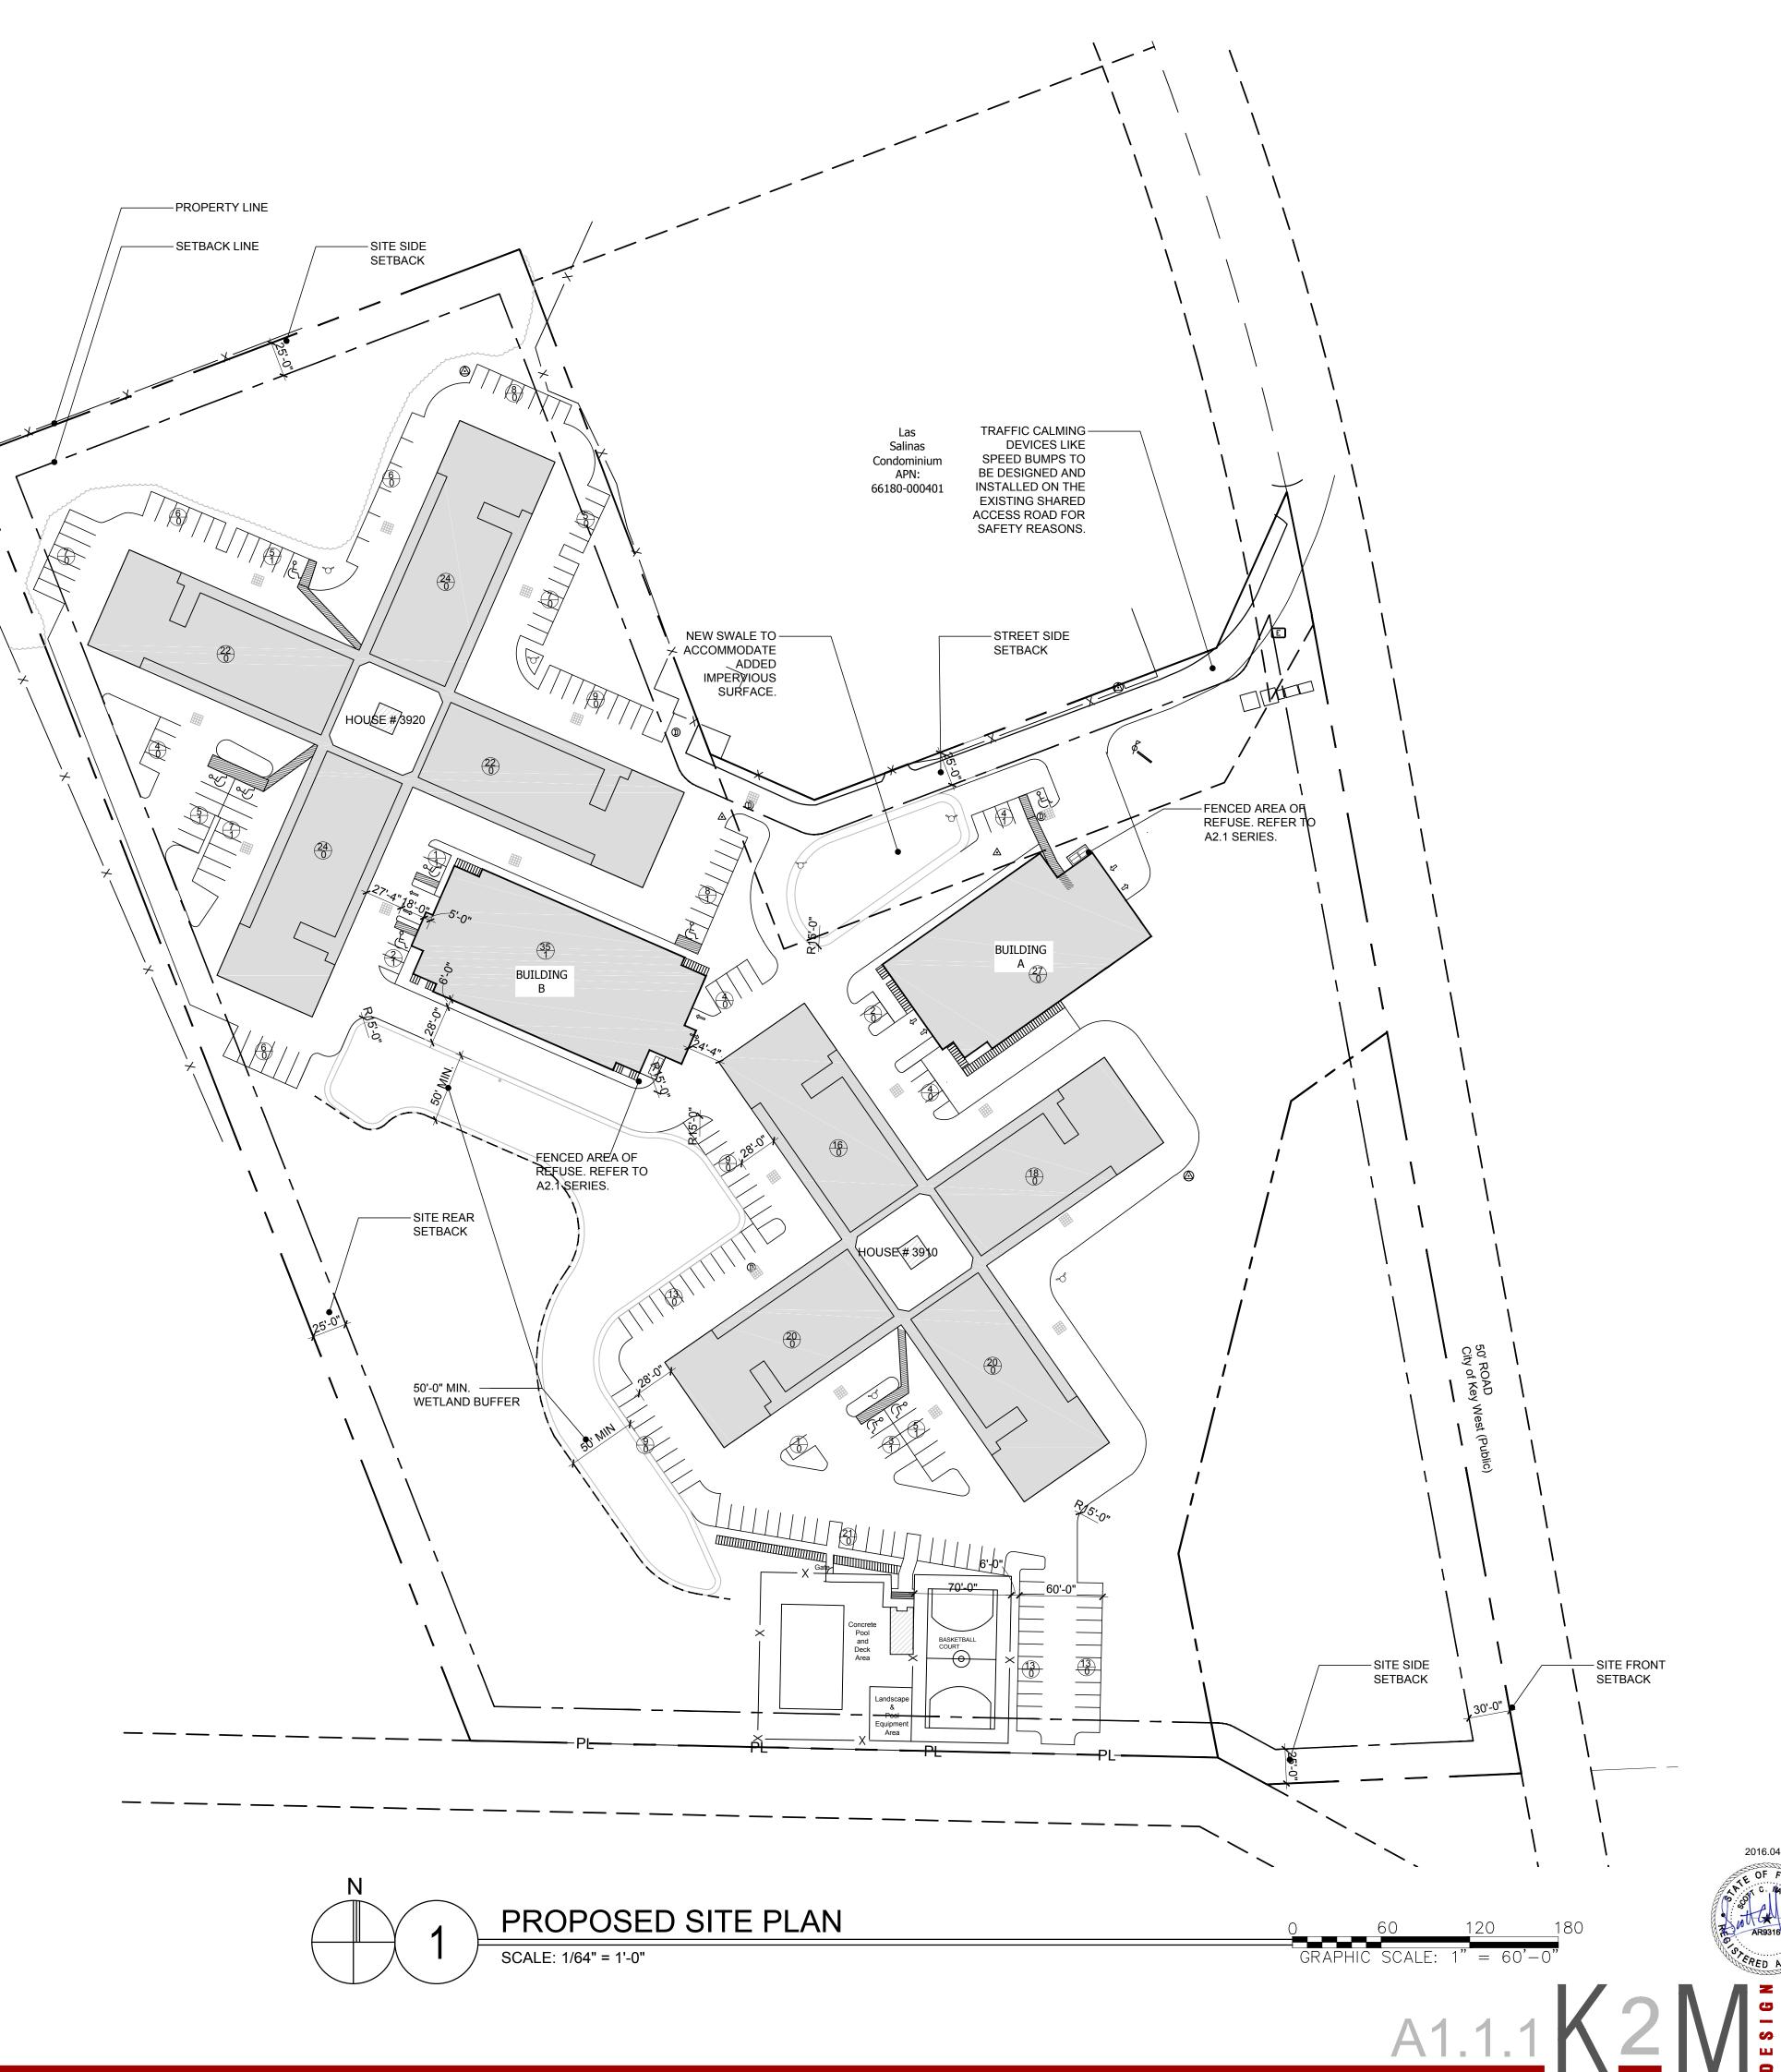

FIRE PROTECTION SYSTEM REQUIREMENTS

Section 903: Automatic Sprinkler Systems

- 903.2.1 Group A An automatic sprinkler system shall be provided throughout buildings and portions thereof used as Group A occupancies.
- 903.2.11.5 Commercial Cooking Operations An automatic sprinkler system shall be installed in commercial kitchen exhaust hood and duct system where an automatic sprinkler system is used to comply with Section 904.
- 903.3.1.1 NFPA 13 Sprinkler System Where the provisions of this code require that a building or portion thereof be equipped throughout with an automatic sprinkler system in accordance with this section, sprinklers shall be installed throughout in accordance with NFPA 13 except as provided in
- 903.4 Sprinkler System Monitoring and Alarms All valves controlling the water supply for automatic sprinkler systems, pumps, tanks, water levels and temperatures, critical air pressures and waterflow switches on all sprinkler systems shall be electrically supervised by a listed fire alarm control unit.

Contractor shall submit sprinkler shop drawings compliant with all local, state, and federal regulations.

LIFE SAFETY - GENERAL NOTES:

- FINAL LOCATION OF FIRE EXTINGUISHERS TO BE COORDINATED WITH FIRE MARSHAL.
- CONTRACTOR TO PROVIDE FIRE ALARM SHOP DRAWINGS FOR COMPLIANT SYSTEM. CONTRACTOR TO PROVIDE FIRE PROTECTION SHOP DRAWINGS FOR COMPLIANT SYSTEM.

LIFE SAFETY - CODE REFERENCES:

Chapter 10: Means of Egress

Section 1004: Occupant Load

- Max floor area per occupant: Refer to Occupancy Zone Legend
- Every room or space as an assembly occupant load shall have the number posted The outdoor area occupant load shall be assigned by the building official

Section 1005: Egress Width

- .3 inches per occupant stairs XX occupants / X stairs = XX" per stair
- .2 inches per occupant for other components

- Stairway width shall be per 1005 but not less than 44 inches. • A flight of stairs shall not have a vertical rise greater than 12 feet between floors or
- Exits shall be marked with readily visible sign from any direction of egress travel. Sign
- placement shall be such that no point in an exit corridor or passageway is more than 100 feet from the nearest visible sign. Signs are not required in rooms or areas that only require one exit.

Section 1014: Exit Access • Common path of egress travel shall not exceed 100 feet for B occupancy with sprinklers

- Common path of egress travel for A occupancies shall comply with 1028.8. • Common path of egress travel for S-2 shall not be limited.

Section 1015: Exit and Exit Access Doorways Two exits shall be provided where:

Occupant load exceeds 49 for A and B occupancies and 29 for S occupancies.

 Common path of egress travel exceeds 1014. O Where required by 1015.3, 1015.4, 1015.5, 1015.6, or 1015.6.1.

Section 1016: Exit Access Travel Distance Travel distances shall not exceed values in Table 1016.1:

OCCUPANCY	SPRINKLED
Α	250 FEET
В	300 FEET
S-1	400 FEET

Means of egress stairs required by 410.5.3 and 1015.6.1 are not required to be enclosed.

Section 1026: Exterior Exit Ramps and Stairways

- For occupancies in other than Group I-2, exterior exit stairways shall be permitted as an element of a required means of egress for buildings not exceeding four stories above grade plane of having occupied floors more than 75 feet above lowest level of fire department
- Stairs shall not be less than 50 percent open on one side and arranged to restrict the
- accumulation of smoke. • Exterior stairs shall be separated from the interior of the building as required by 1022.1.

Section 1027: Exit Discharge

Exits shall discharge directly to the exterior of the building.

LIFE SAFETY - FINISH RATINGS:

Chapter 8: Interior Finishes

Section 803: Wall and Ceiling Finishes

■ Class A: Flame spread 0-25; smoke developed 0-450.

• Class B: Flame spread 26-75; smoke developed 0-450. • Class C: Flame spread 76-200; smoke developed 0-450.

OCCUPANCY	EXITS - SPRINKLED	CORRIDOORS - SPRINKLED	ROOMS - SPRINKLED
R-2	В	В	С
A-3	В	В	С
В	В	С	С
S	С	С	С

Section 804: Interior Floor Finish

- Class I materials: 0.45 watts/cm2 or greater
- Class II materials: 0.22 watts/cm2 or greater • Where sprinkled per 903.3.1.1, Class II materials are permitted anywhere Class I materials

LIFE SAFETY PLAN LEGEND:

		IV LLOLIVD.
*	SPRINKLER	WALL OR CEILING MOUNTED BY SEPARATE SUB-CONTRACTOR
\triangle	HORN / STROBE	WALL MOUNTED FIRE ALARM COMBINATION AUDIBLE/ VISUAL SIGNALING NIT. HORN/FLASHING "FIRE" LIGHT MIN. 75CD. MOUNTED AT 80" AF.F.
-\$- \$>	SMOKE DETECTOR EXIT SIGN	CEILING MOUNTED SMOKE / CARBON DIOXIDE DETECTOR. WIRED AND CIRCUITED. INTERIOR RECESSED EDGE LIT LED EXIT SIGN. DIRECTION AS SHOWN ON PLAN. WIRED & CIRCUITE
∞ -	EXIT SIGN	TO UPS SYSTEM. BASIS OF DESIGN: CURVA-CRV-HT-LR-1/2-M-AL
FE-1	FIRE EXTINGUISHER	INTERIOR MULTI-PURPOSE CLASS K CHEMICAL FIRE EXTINGUISHER, INSTALLED ON WALL BRACKET. LOCATE 48" A.F.F TO TOP OF EXTINGUISHER. REFEF TO SPECIFICATIONS.
FE-2	FIRE EXTINGUISHER	INTERIOR MULTI-PURPOSE CLASS A, B, AND C CHEMICAL FIRE EXTINGUISHER, INSTALLED ION WAL BRACKET. LOCATE 48" AFF TO TOP OF EXTINGUISHER. REFER TO SPECIFICATIONS.
— – –		EXIT ACCESS TRAVEL DISTANCES (FBC 1016)
	SHAFT ENCLOSURE (FBC 708)	1 HOUR FIRE BARRIER.

OCCUPANCY LEGEND:

OCCOI ANCI	LLGLIND.
A-3	ASSEMBLY - FITNESS 50/SF GROSS GAMING 11/SF GROSS
B-1	BUSINESS AREA - 100 GROSS
A-2	APARTMENT RESIDENTIAL - 200 GROSS
S-1	GARAGE -300 SF GROSS GENERAL STORAGE -300 SF

LIFE SAFETY - OCCUPANCY CALCULATIONS

BUILDING A GROUND FLOOR

- S-1 / GARAGE 10738 SF /300 = 36 OCCUPANCY
- A-3 / FITNESS 2983 SF / 50 = 60 OCCUPANCY A-3 / GAME ROOM 986 SF / 11 = 90 OCCUPANCY

FIRST FLOOR

R-2 / RESIDENTIAL APARTMENT 11085 SF / 200 = 56 OCCUPANCY

S-1 / STORAGE 217 SF / 300 = 1 OCCUPANCY B-1/ ADMINISTRATIVE 1209 SF / 100 = 12 OCCUPANCY

R-2 / RESIDENTIAL APARTMENT 12204 SF / 200 = 61 OCCUPANCY

R-2 / RESIDENTIAL APARTMENT 12204 SF / 200 = 61 OCCUPANCY

TOTAL BUILDING A OCCUPANCY GROUND FLOOR 14707 SF = 186 PERSONS 12511 SF = 69 PERSONS FIRST FLOOR

> 12204 SF = 61 PERSONS 12204 SF = 61 PERSONS

50200 SF = 377 PERSONS

17766 SF = 60 PERSONS

THIRD FLOOR **BUILDING TOTAL OCCUPANCY:** BUILDING B

GROUND FLOOR S-1 / GARAGE 14131 SF /300 = 48 OCCUPANCY

SECOND FLOOR

S-1/ STORAGE 3635 SF / 300 = 12 OCCUPANCY

R-2 / RESIDENTIAL APARTMENT 15268 SF / 200 = 76 OCCUPANCY

R-2 / RESIDENTIAL APARTMENT 15268 SF / 200 = 76 OCCUPANCY THIRD FLOOR R-2 / RESIDENTIAL APARTMENT 15268 SF / 200 = 76 OCCUPANCY


TOTAL BUILDING B OCCUPANCY **GROUND FLOOR** FIRST FLOOR

15268 SF = 76 PERSONS 15268 SF = 76 PERSONS SECOND FLOOR 15268 SF = 76 PERSONS THIRD FLOOR **BUILDING TOTAL OCCUPANCY:** 63570 SF = 288 PERSONS

LIFE SAFETY LEGENDS AND NOTES SCALE: NONE

OCEAN WALK APARTMENTS

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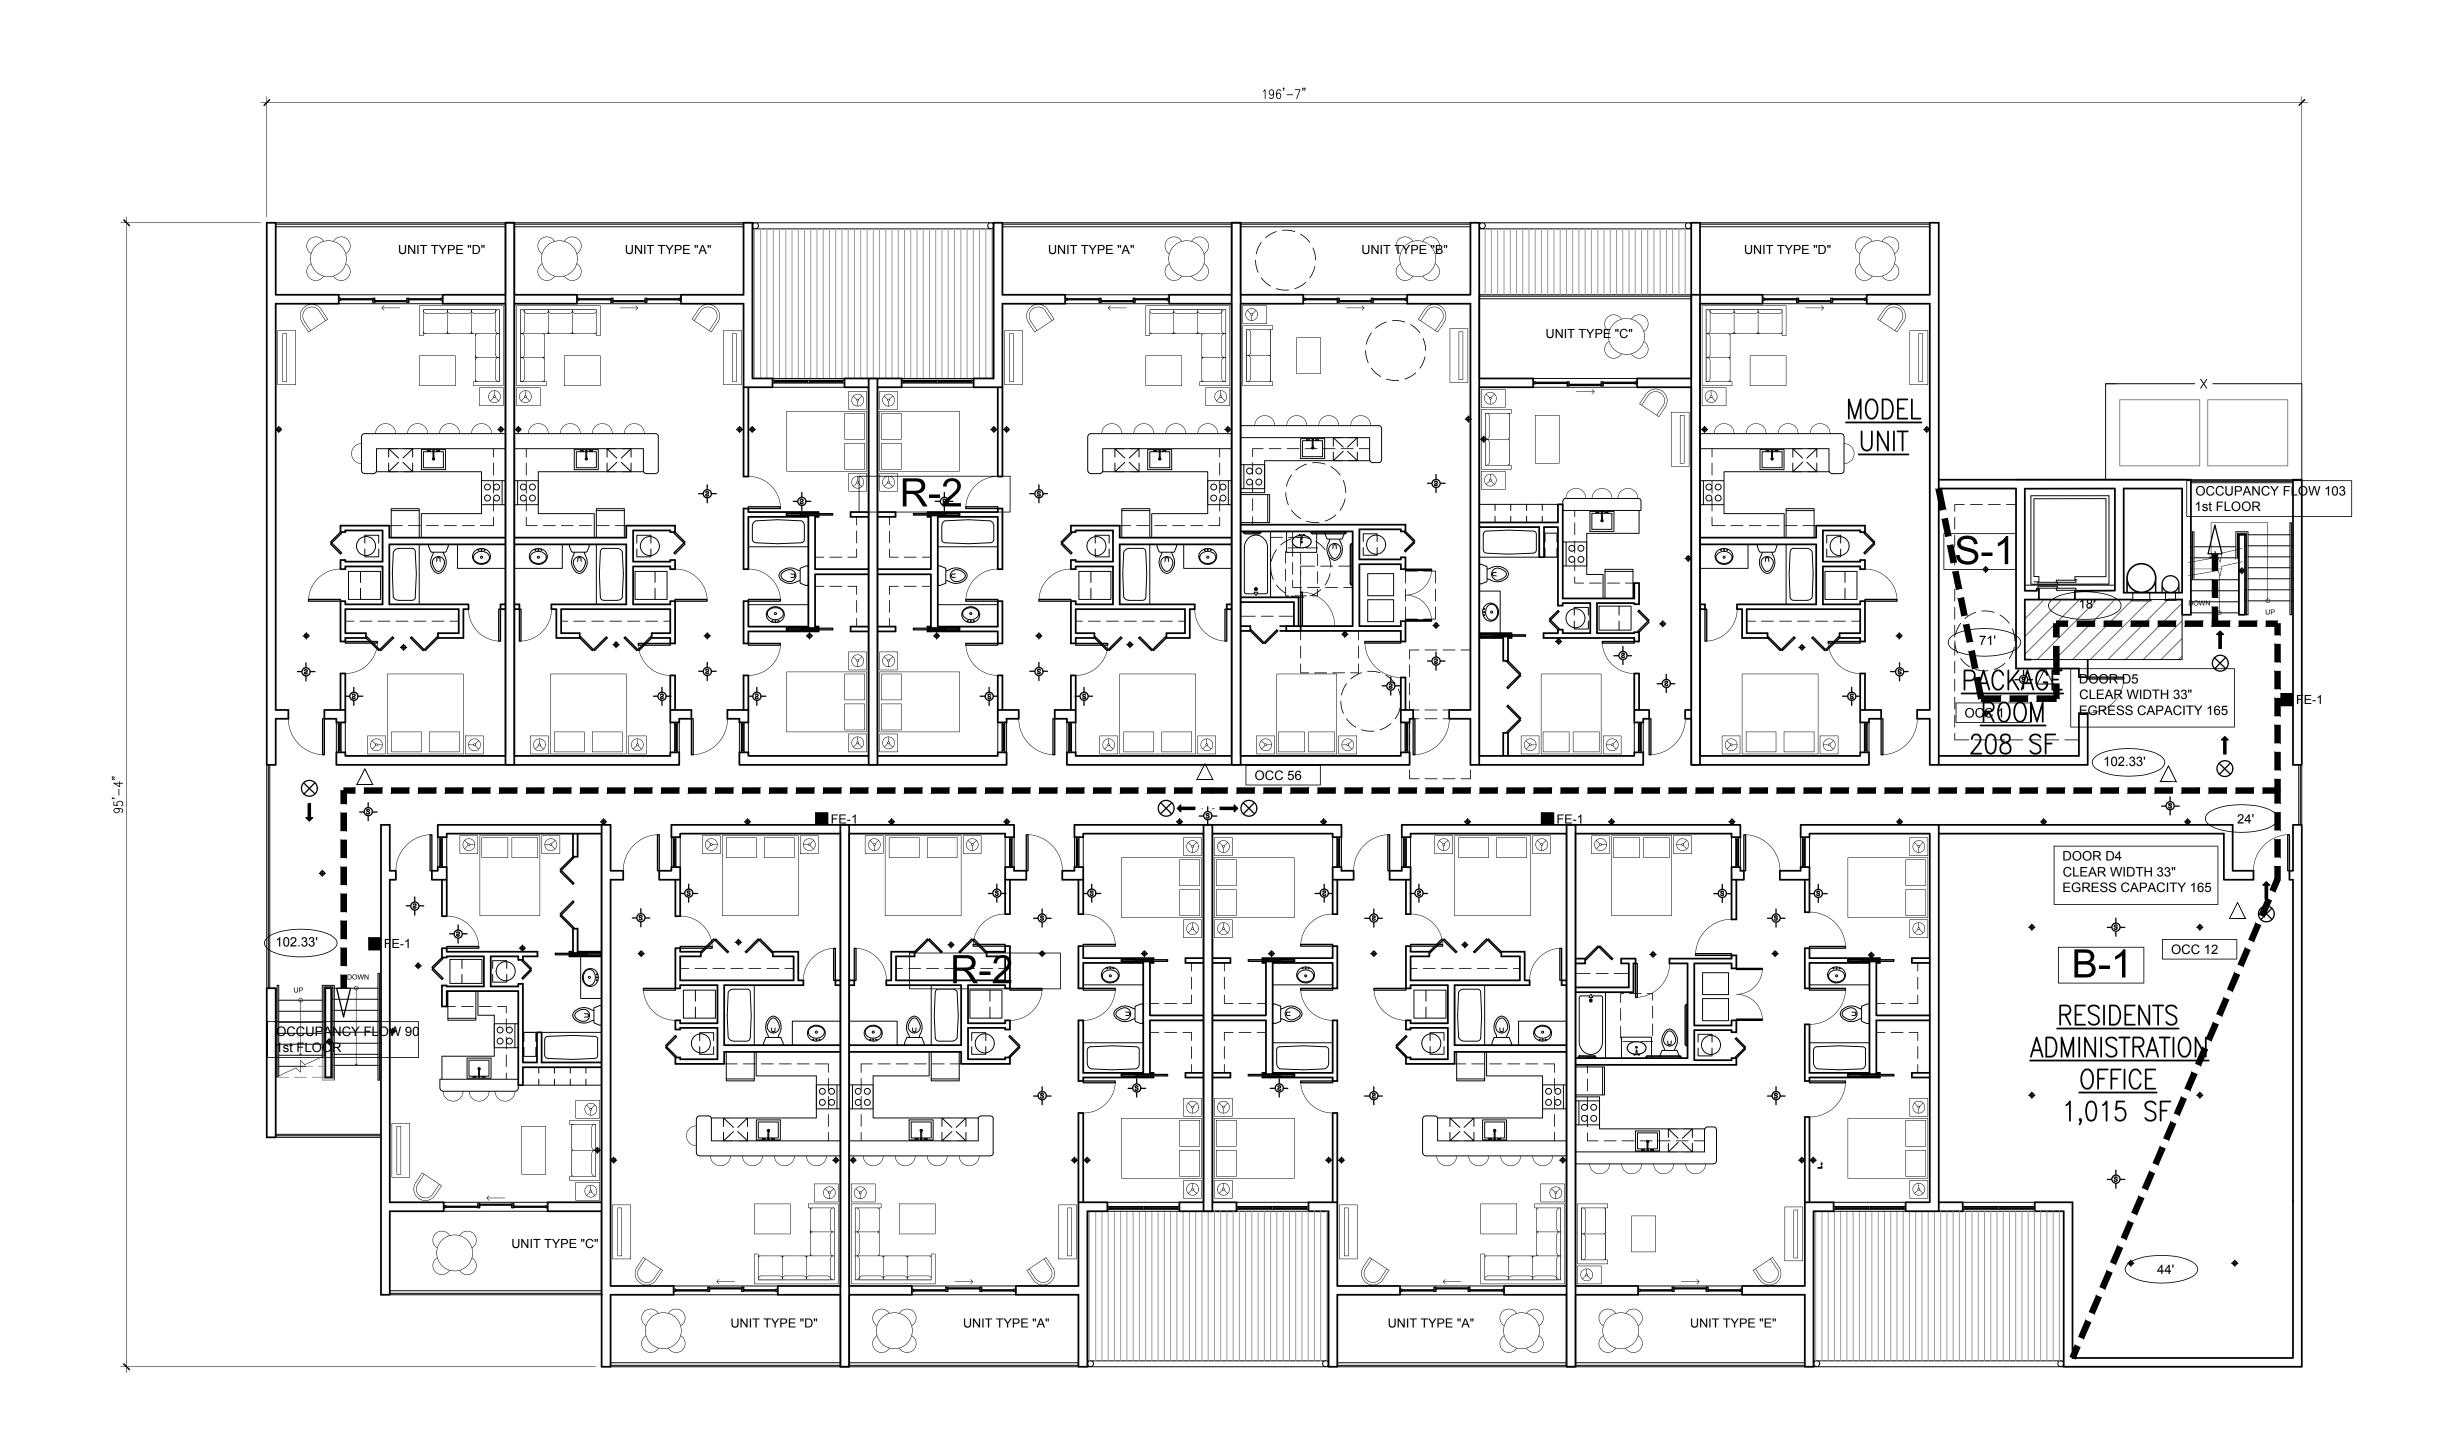


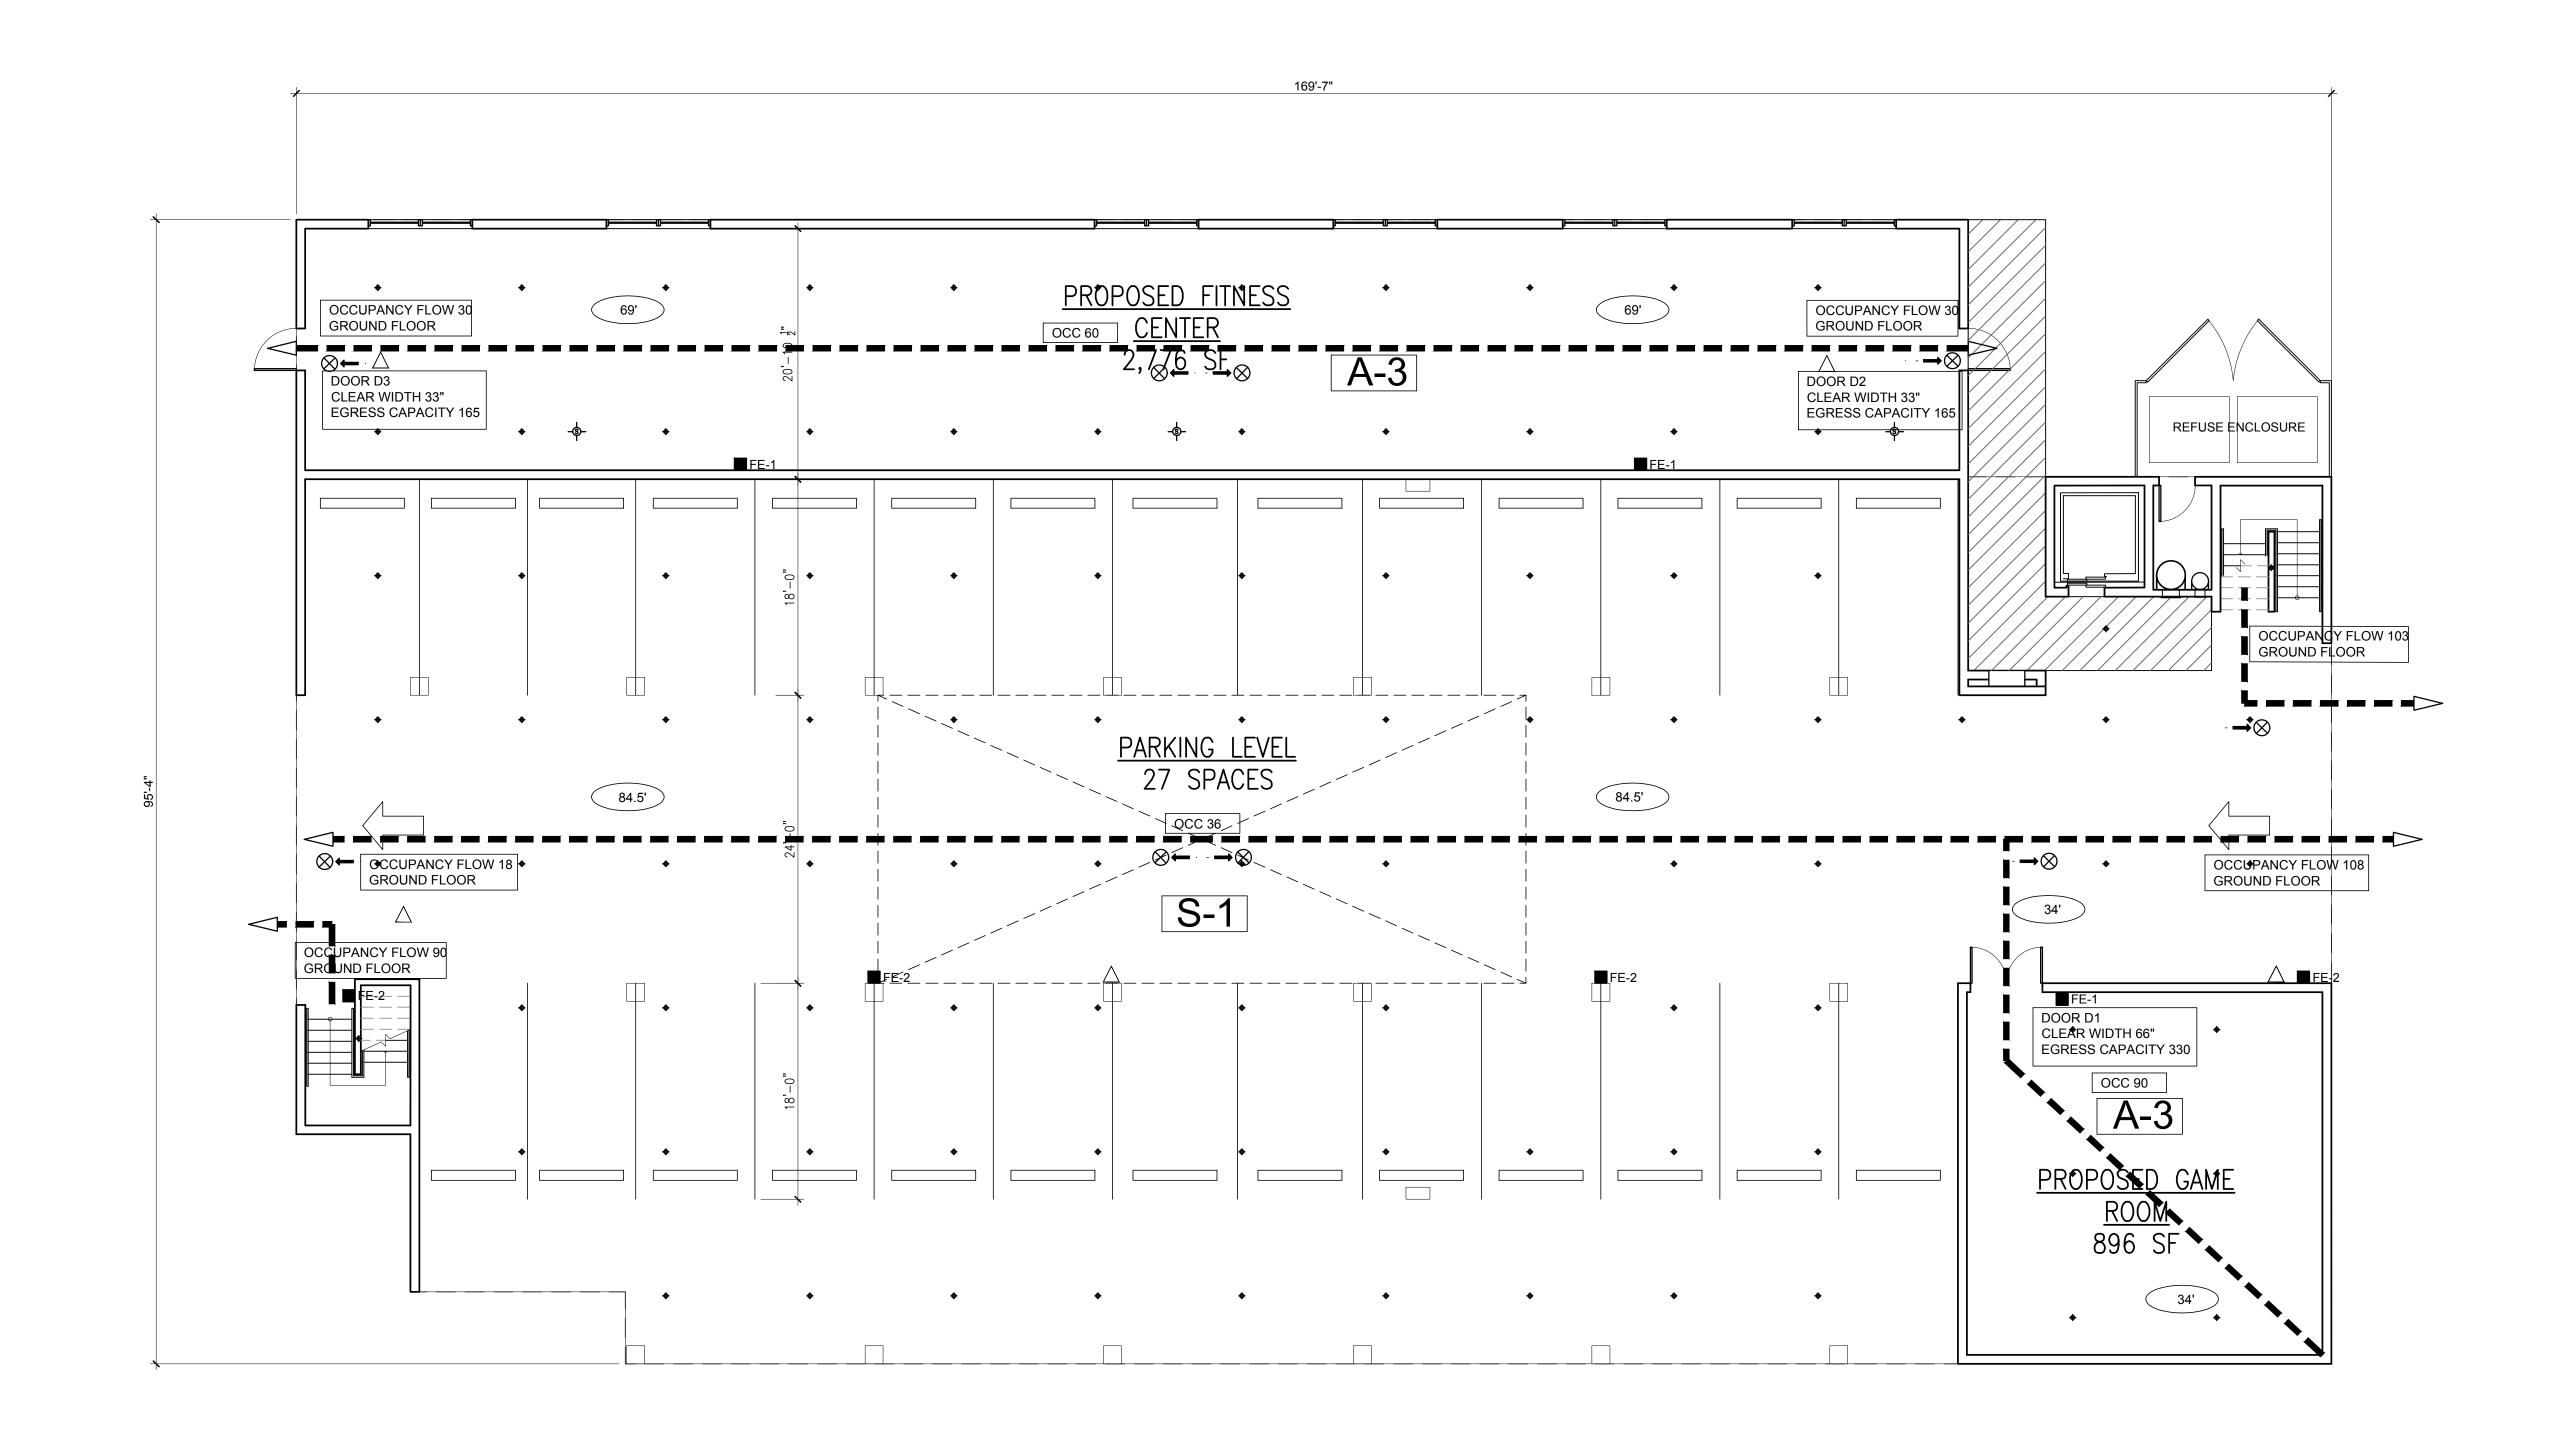

BUILDING "A" GROUND FLOOR LIFE SAFETY PLAN - PARKING LEVEL
















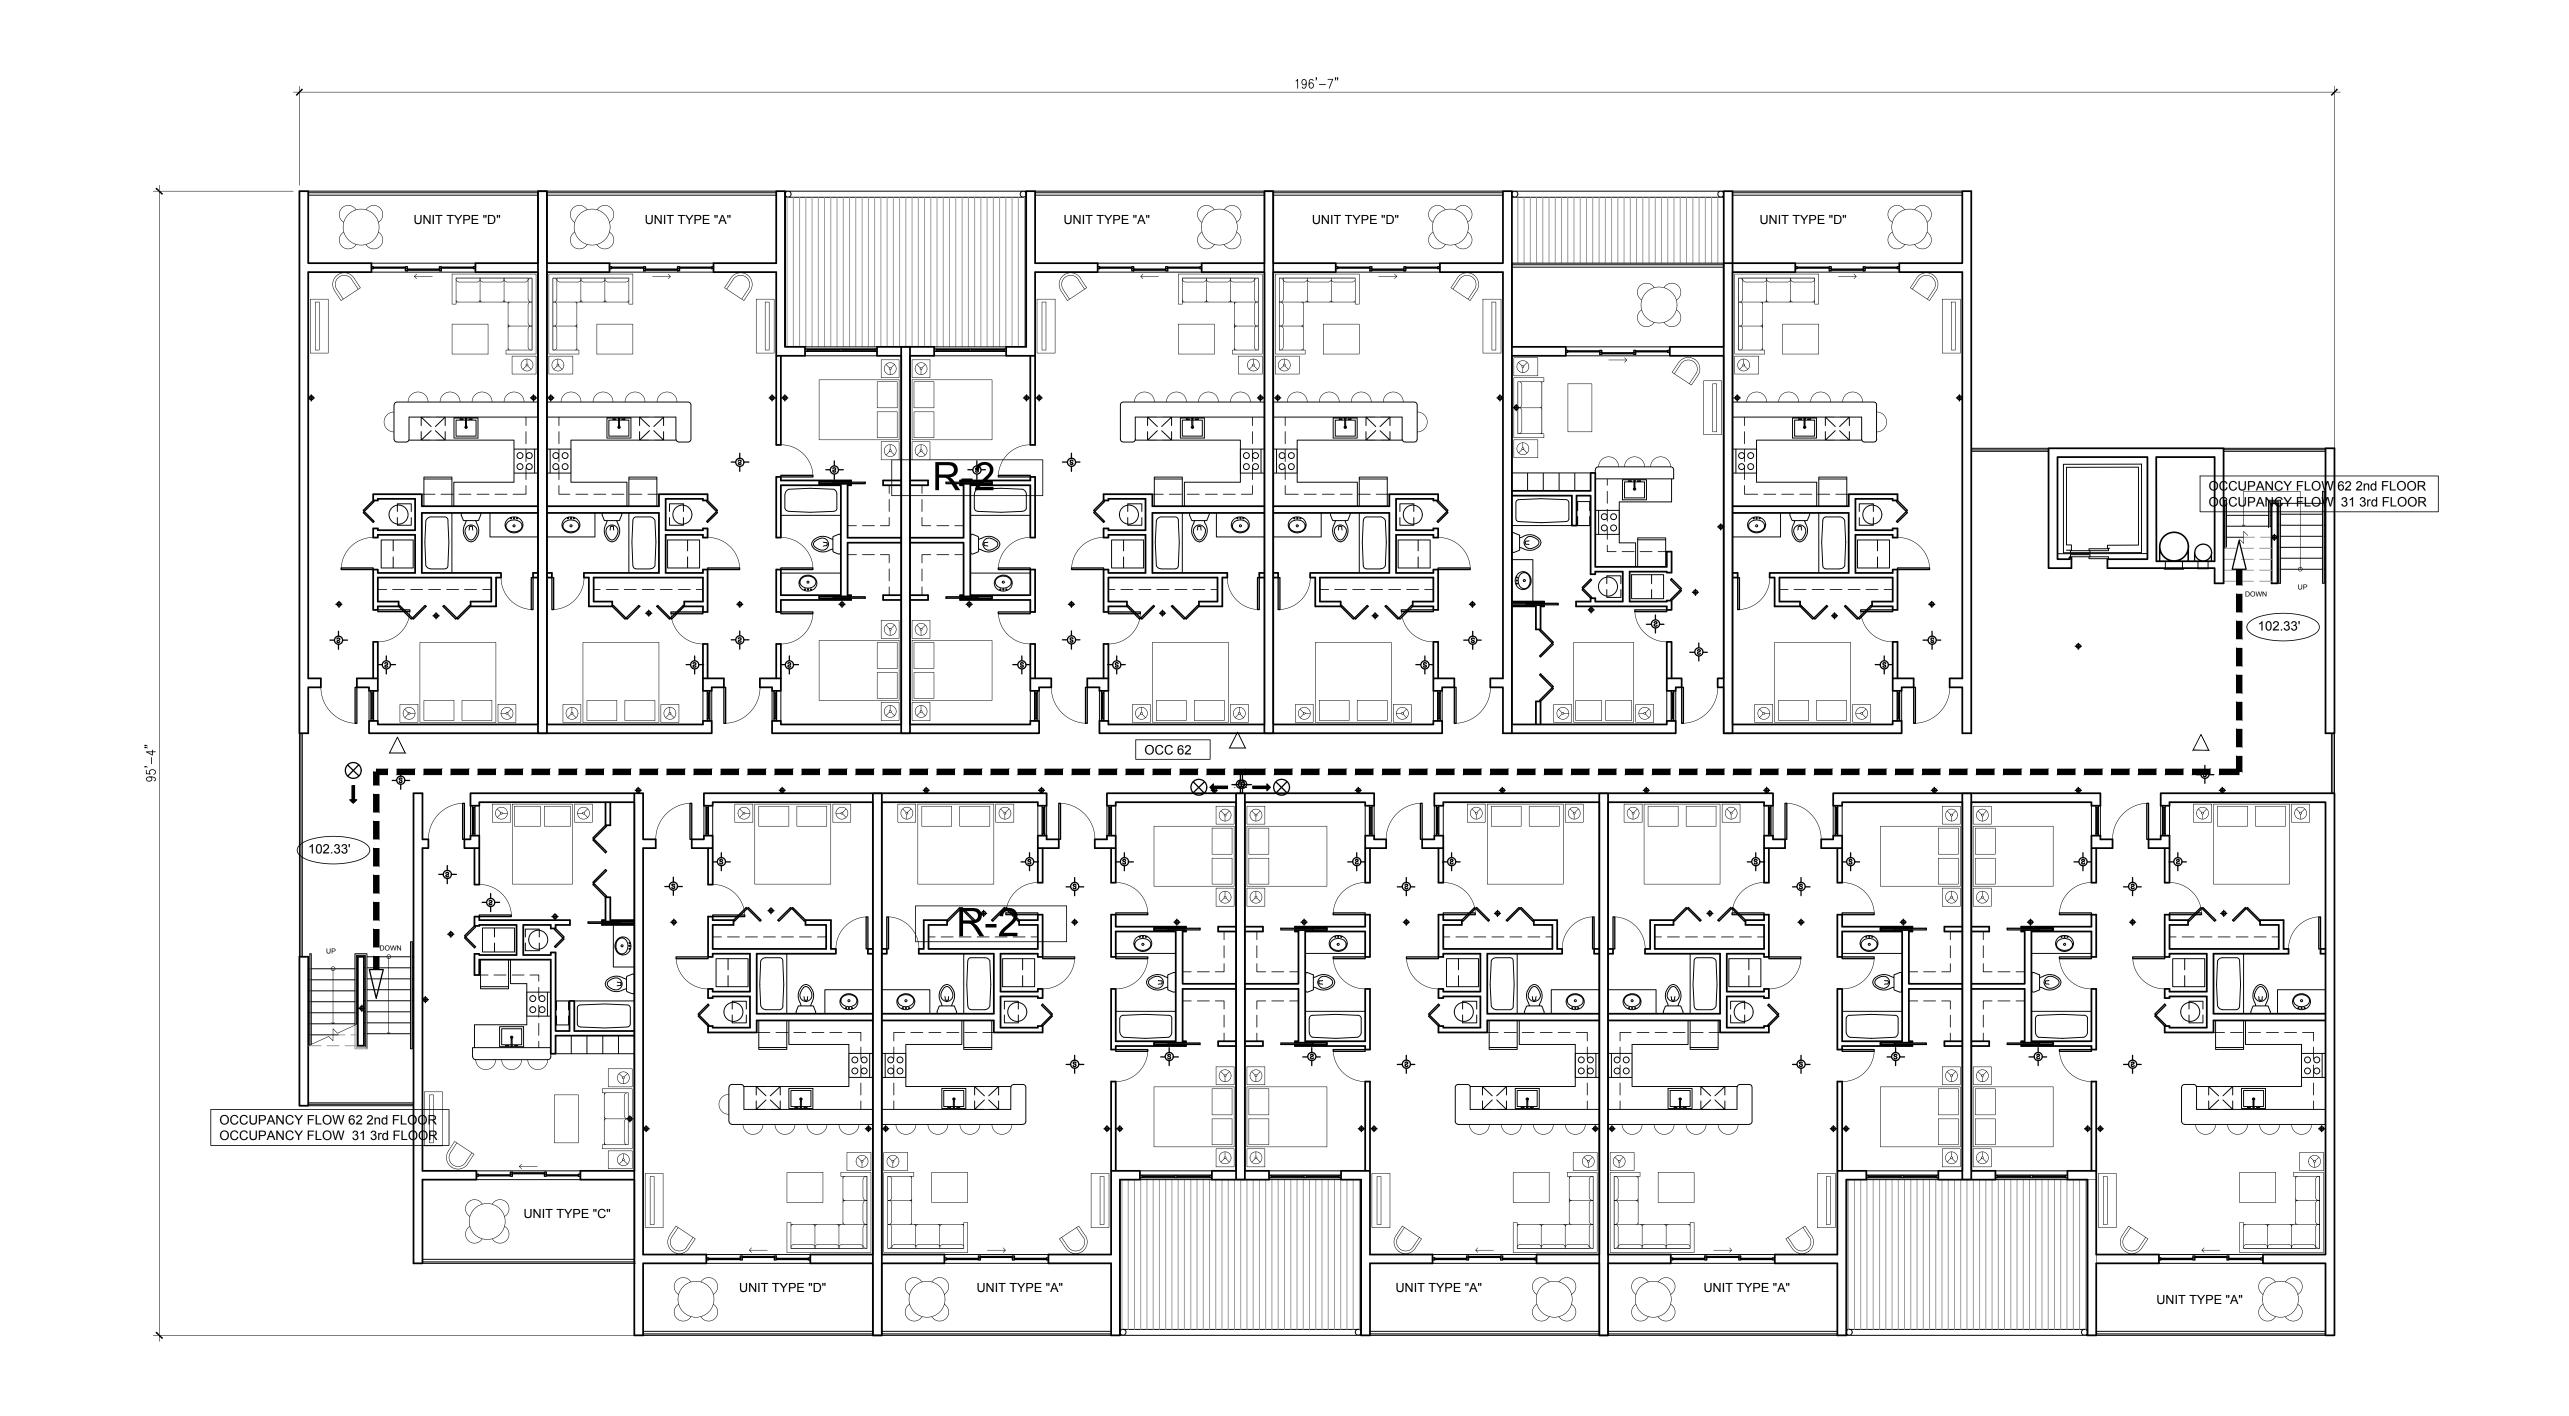





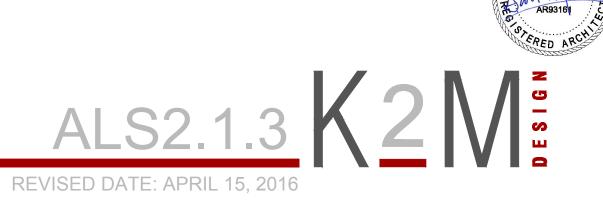

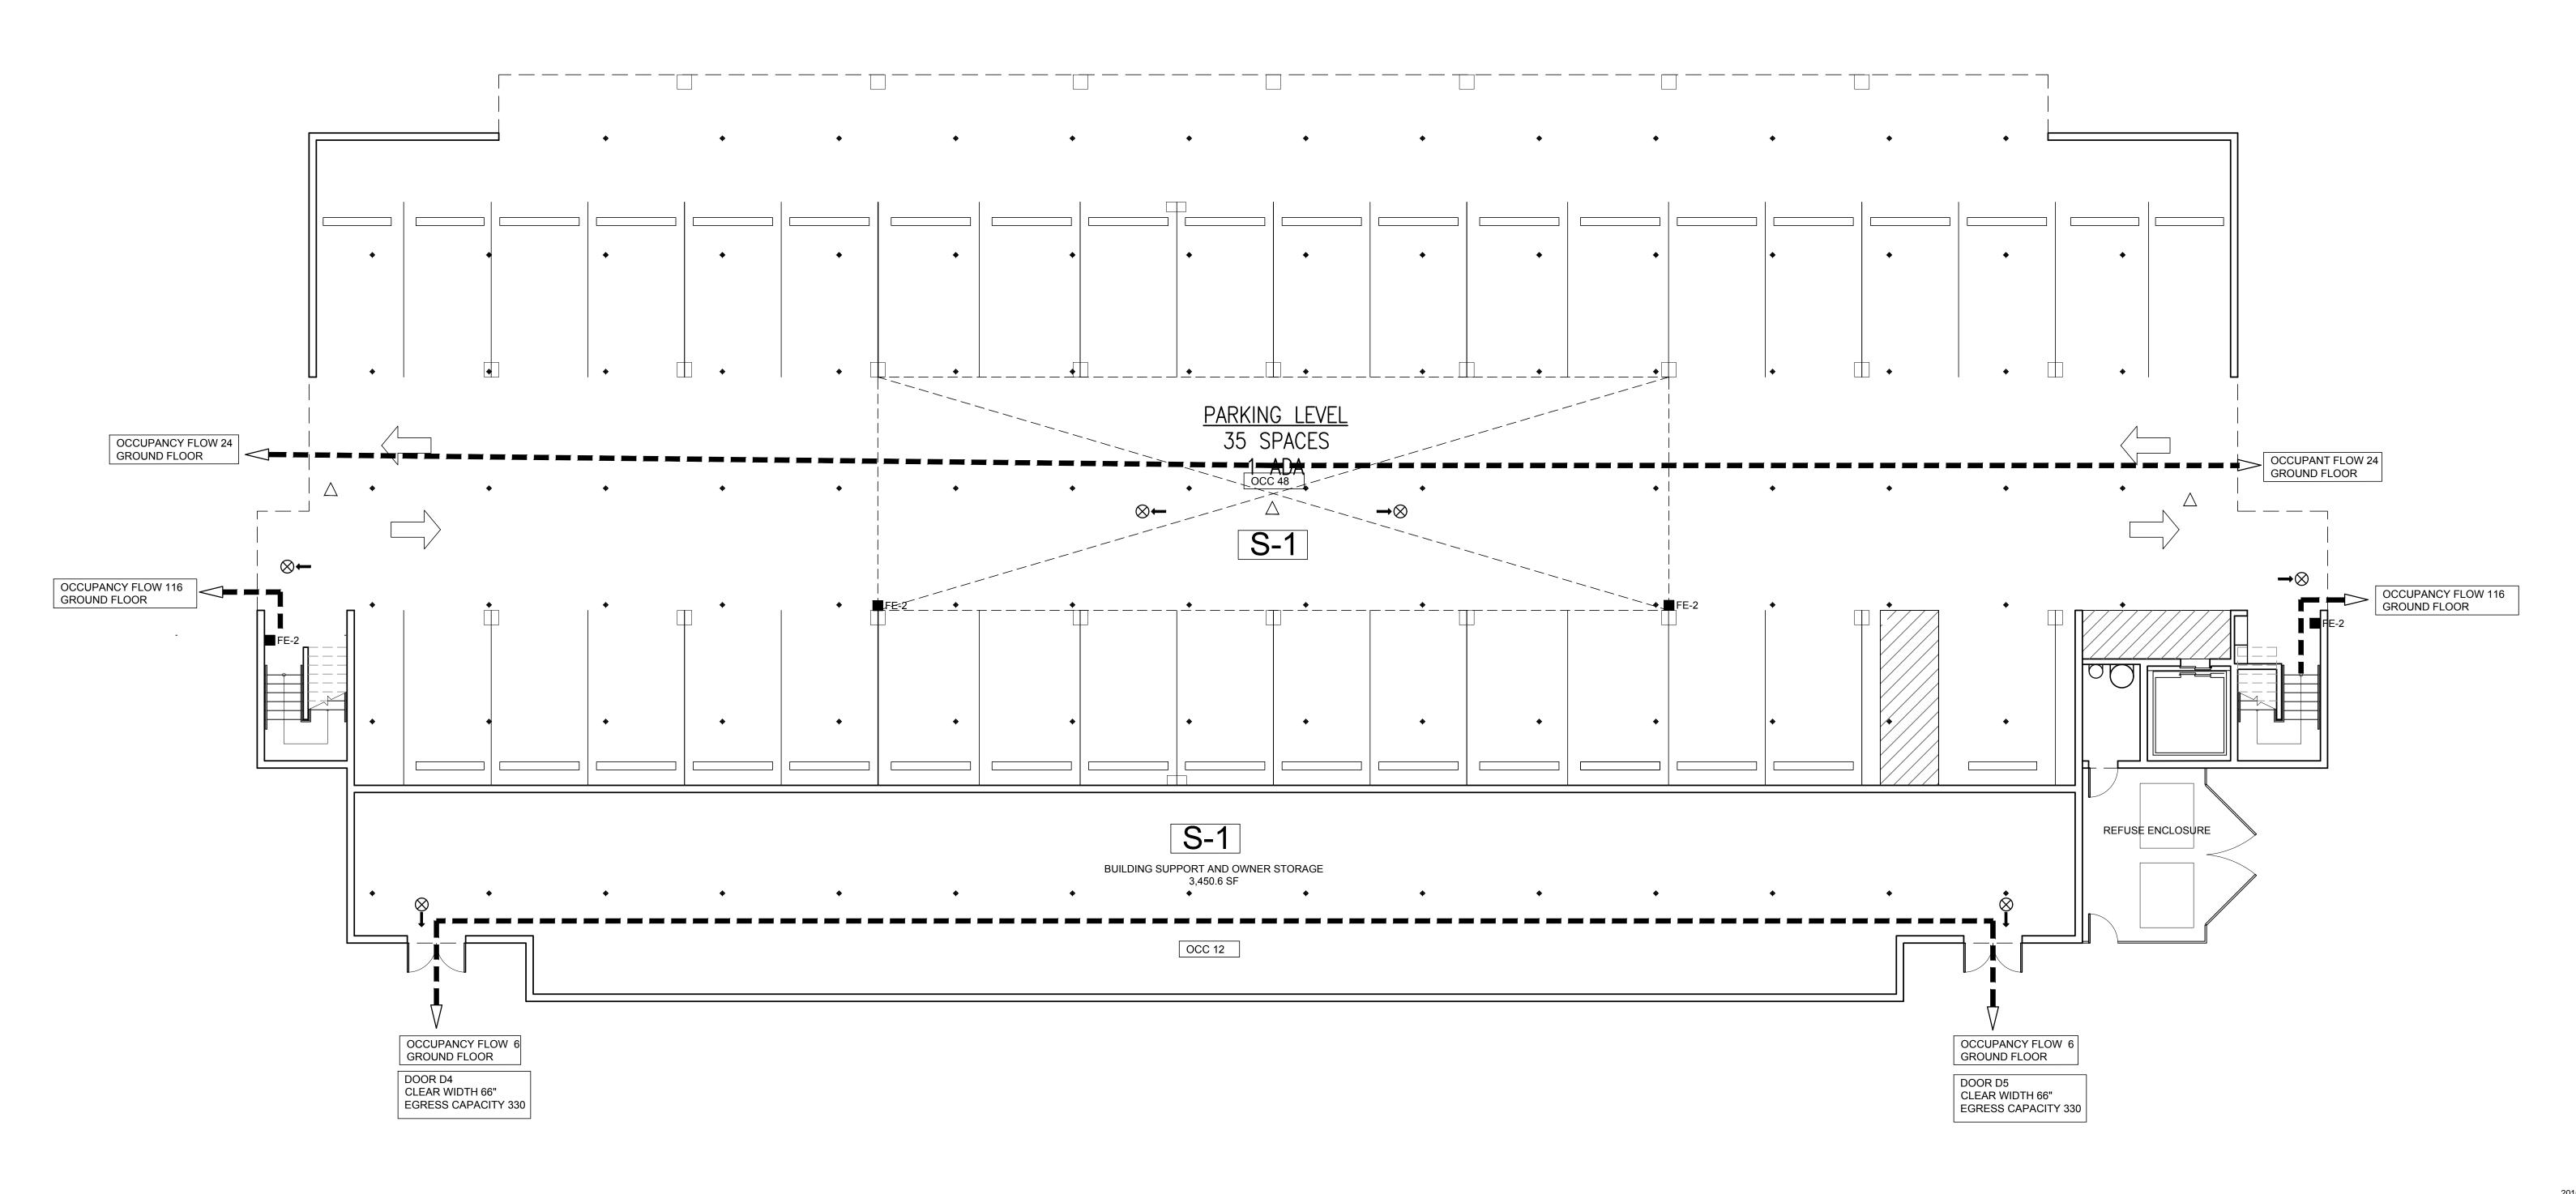




BUILDING "B" GROUND FLOOR LIFE SAFETY PLAN - PARKING LEVEL






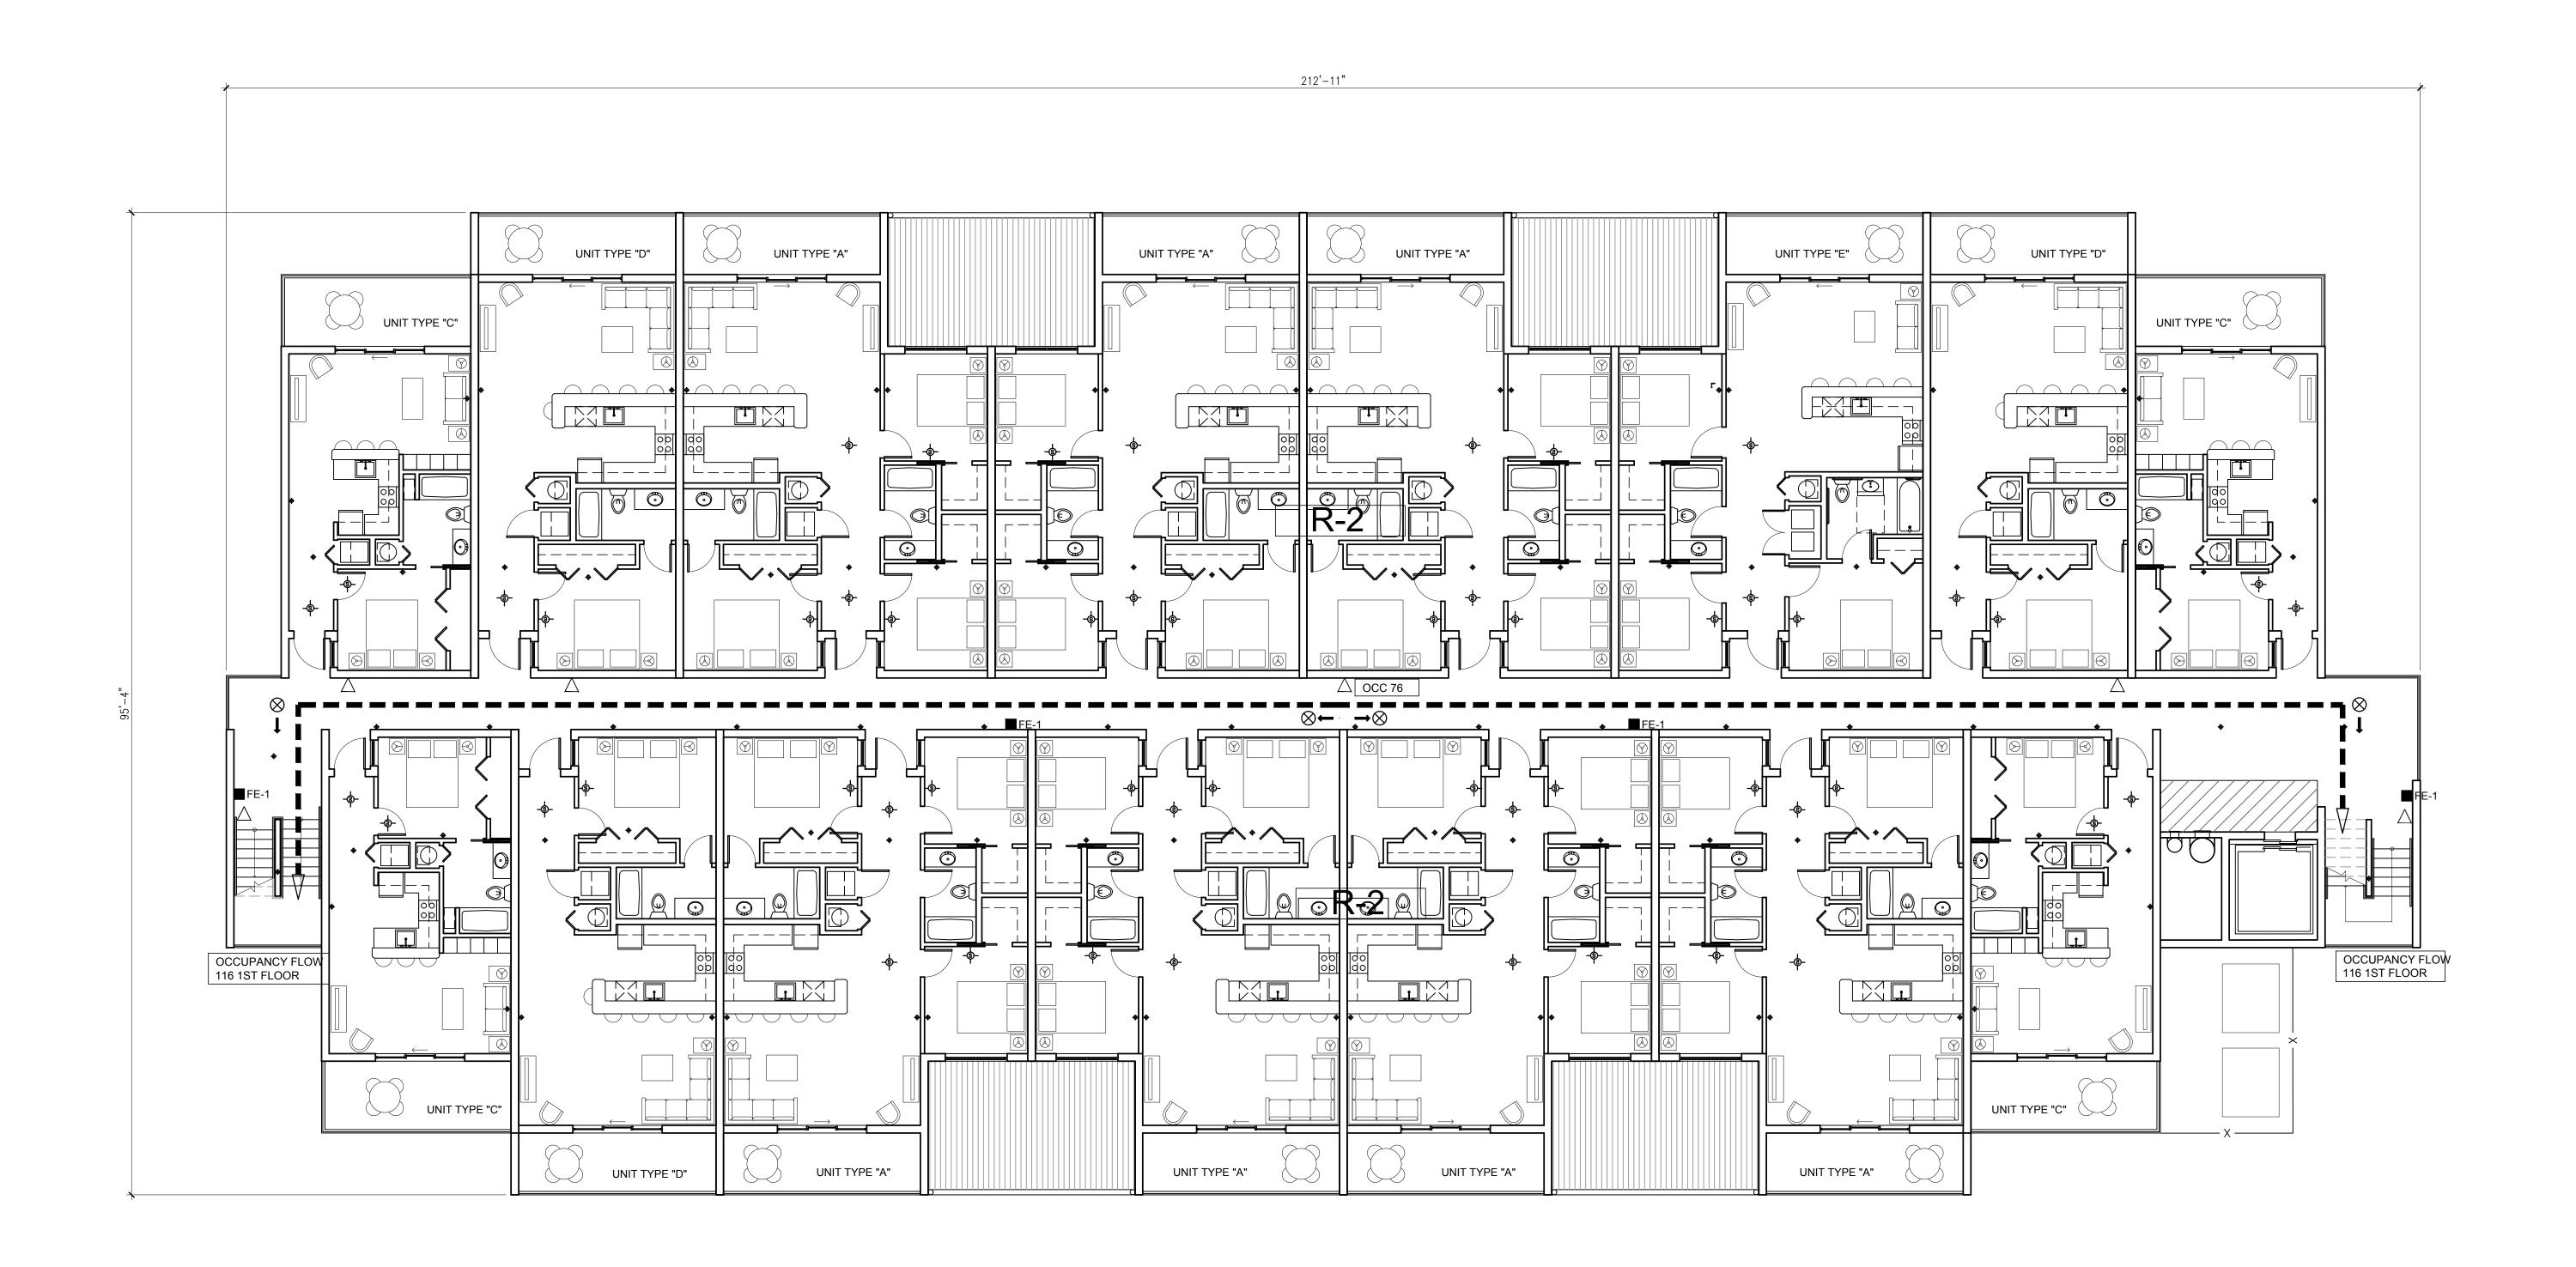








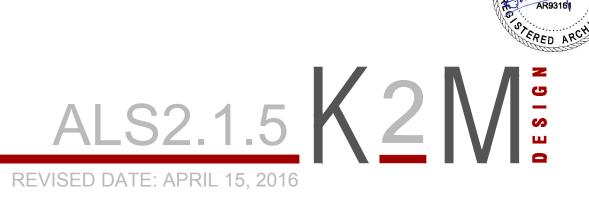

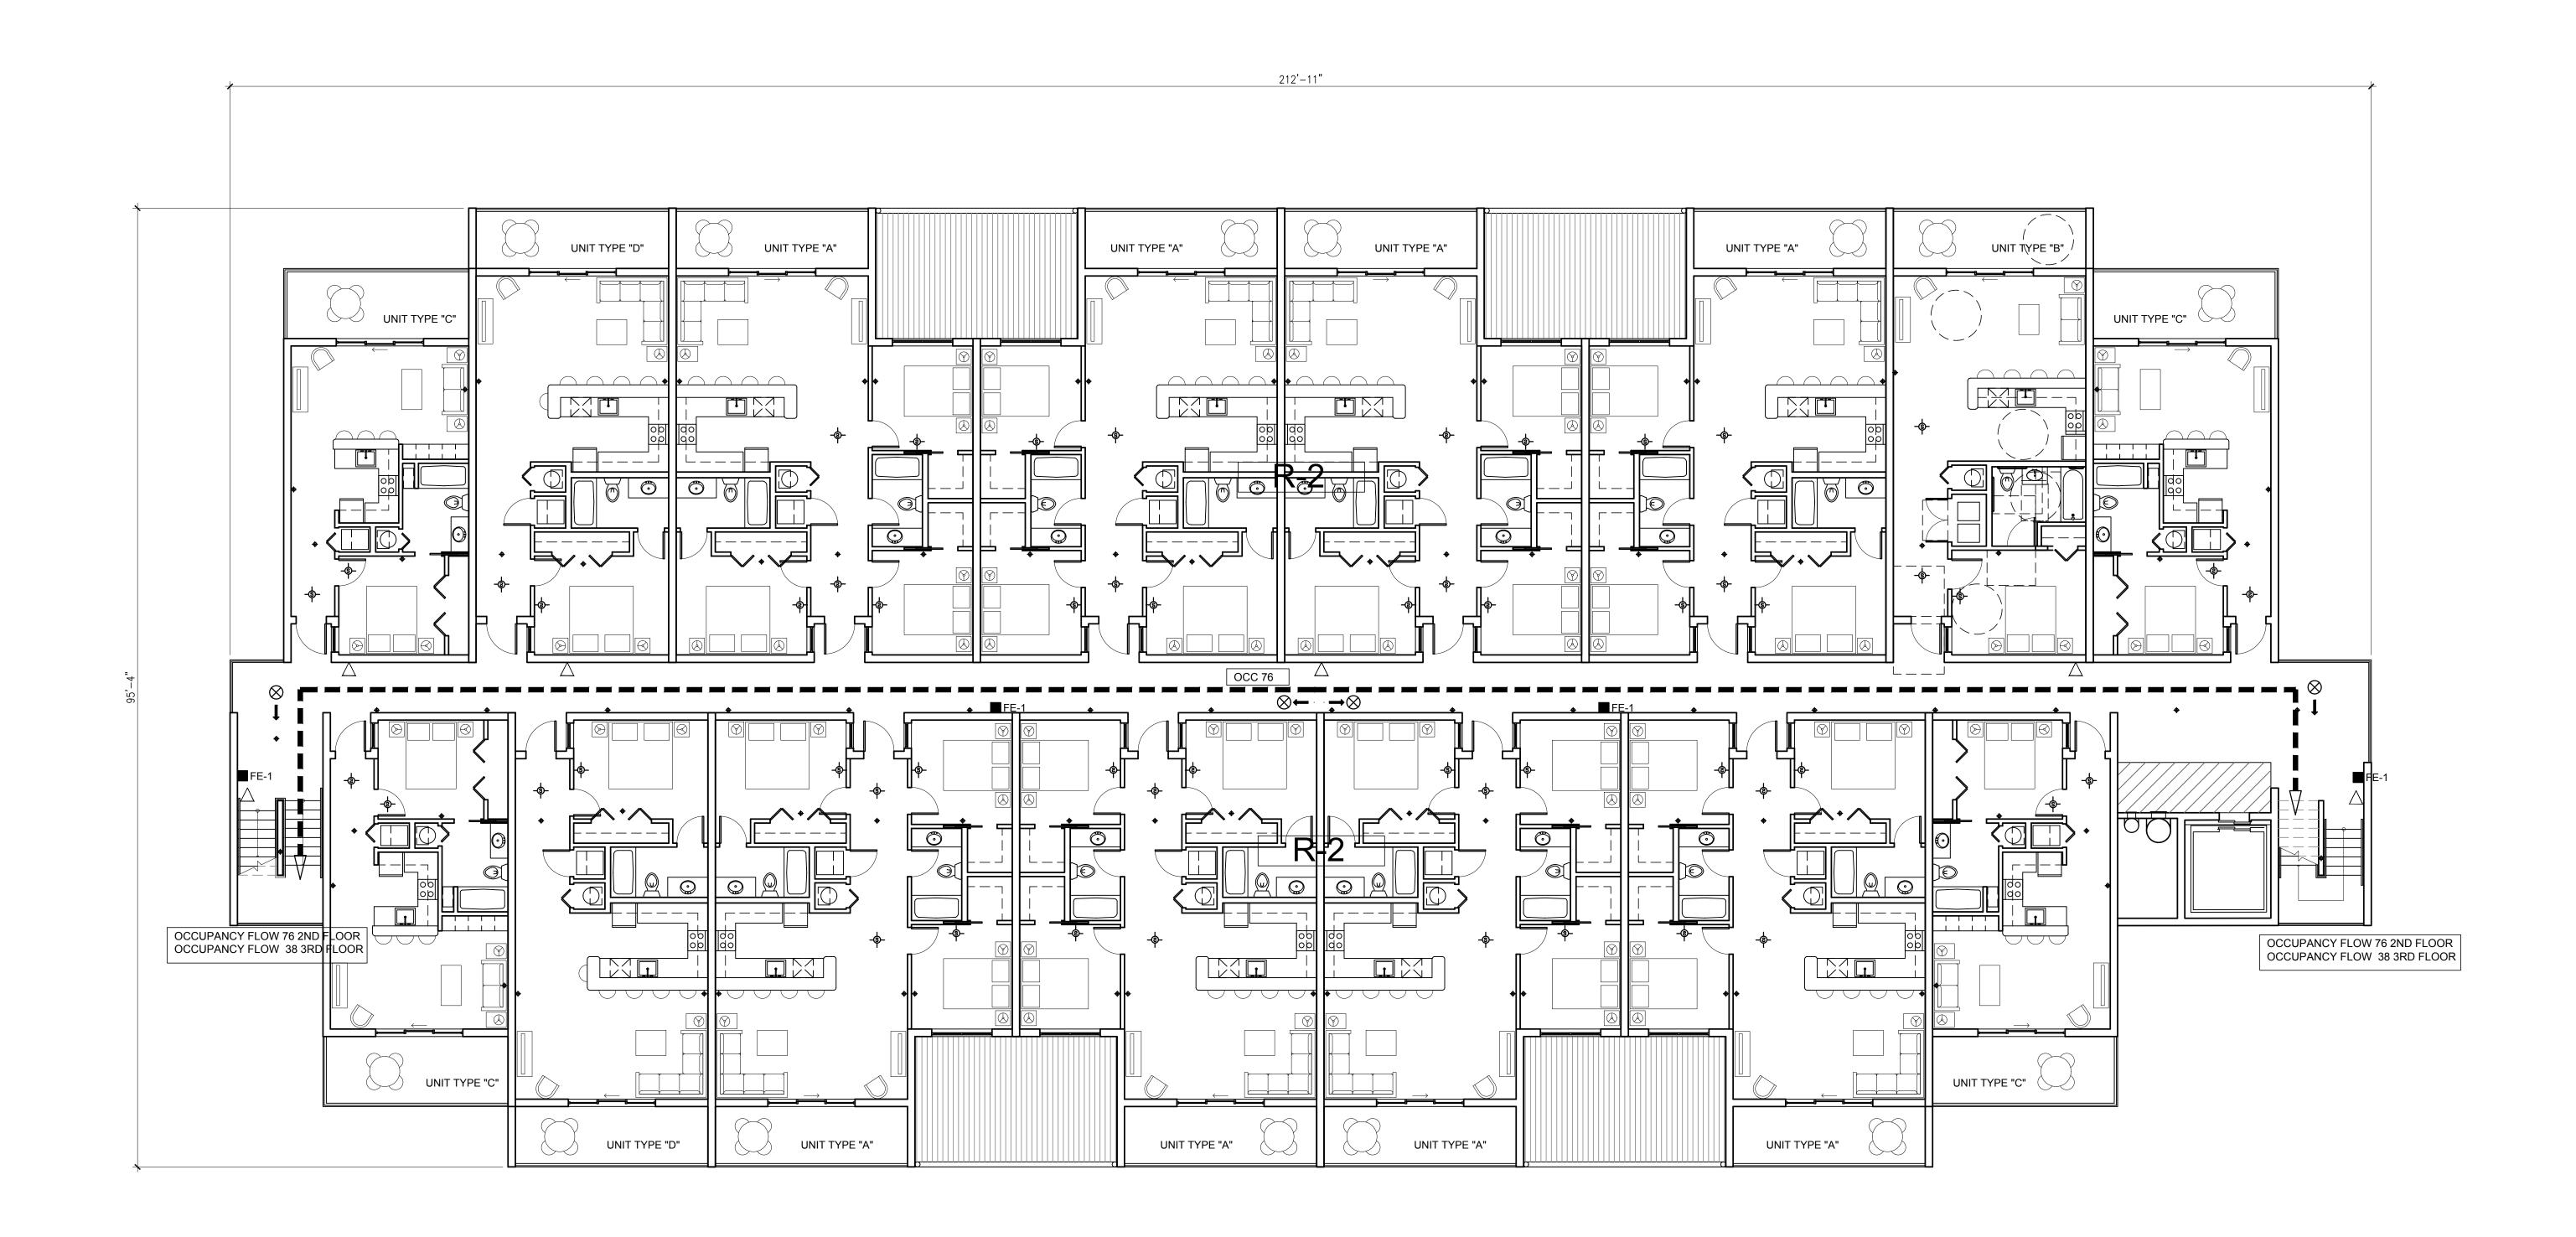





BUILDING "B" SECOND AND THIRD FLOOR LIFE SAFETY PLAN





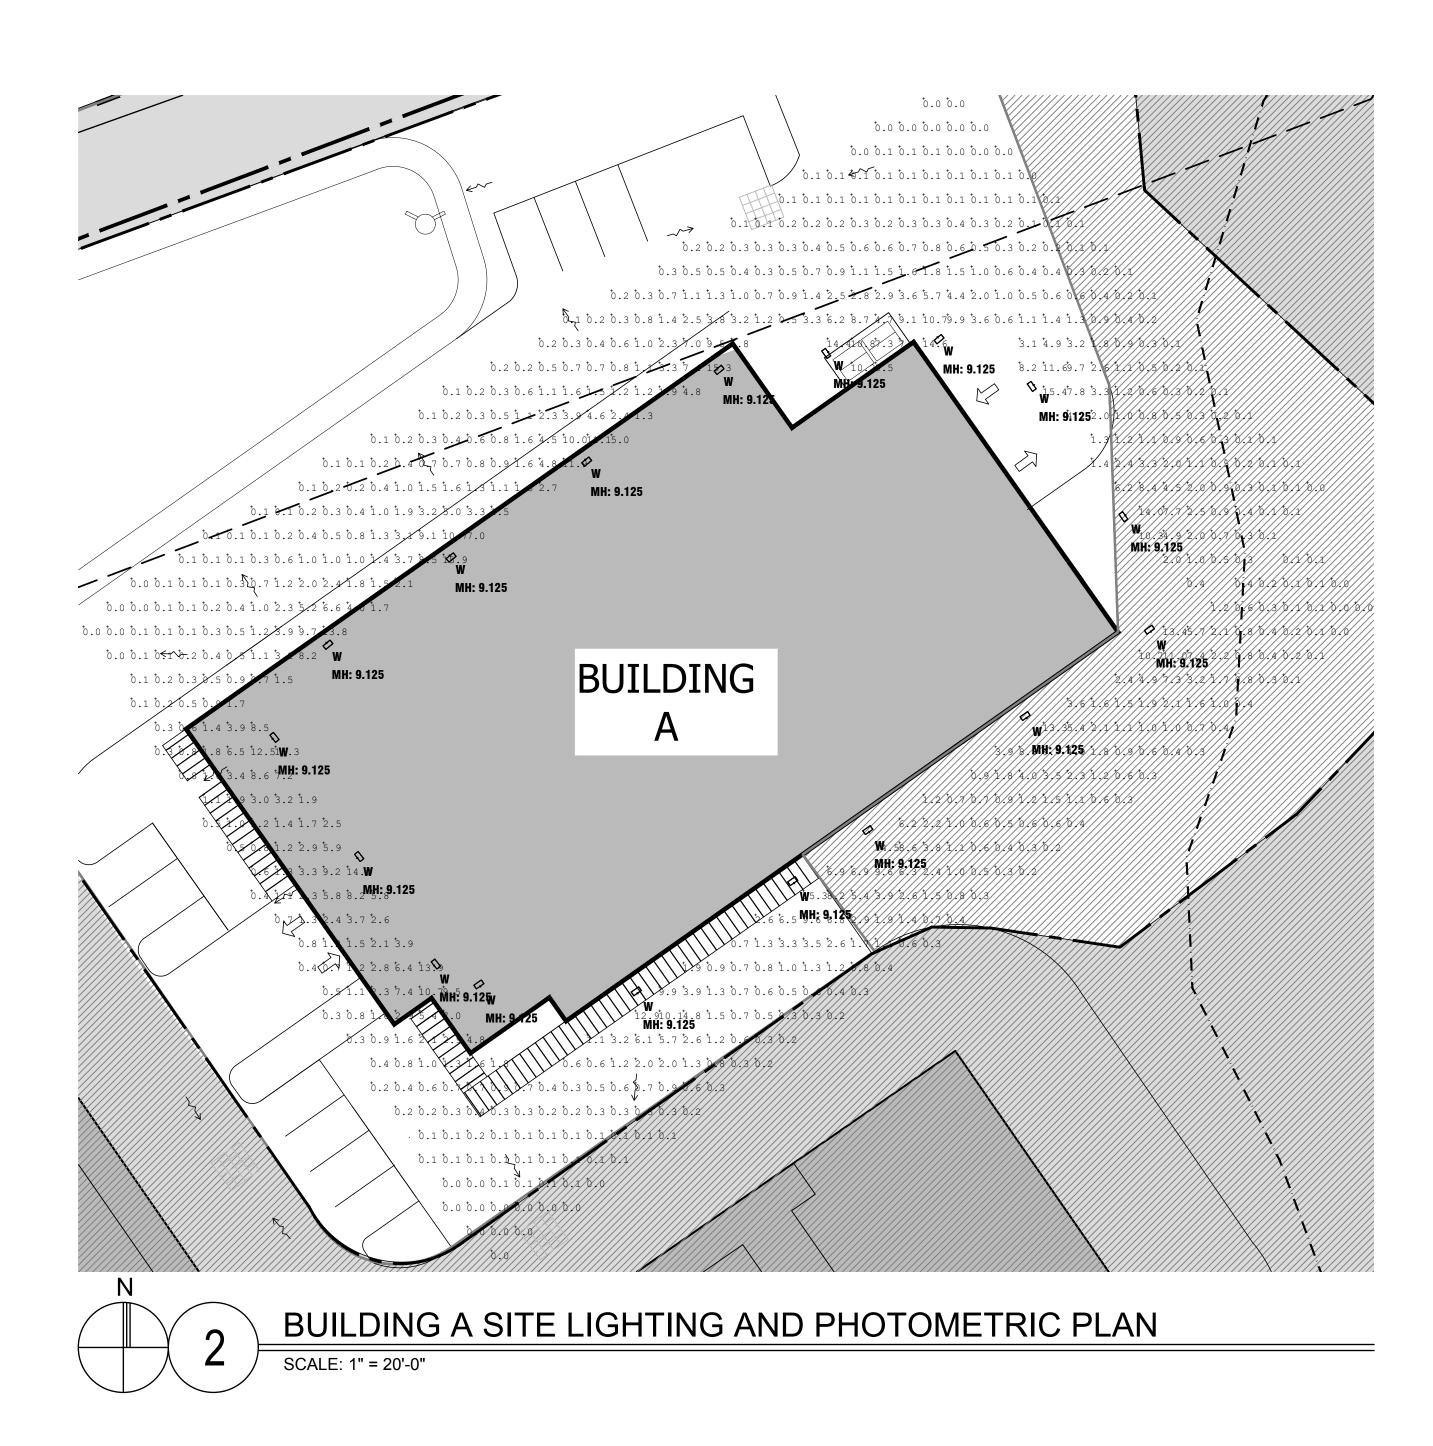

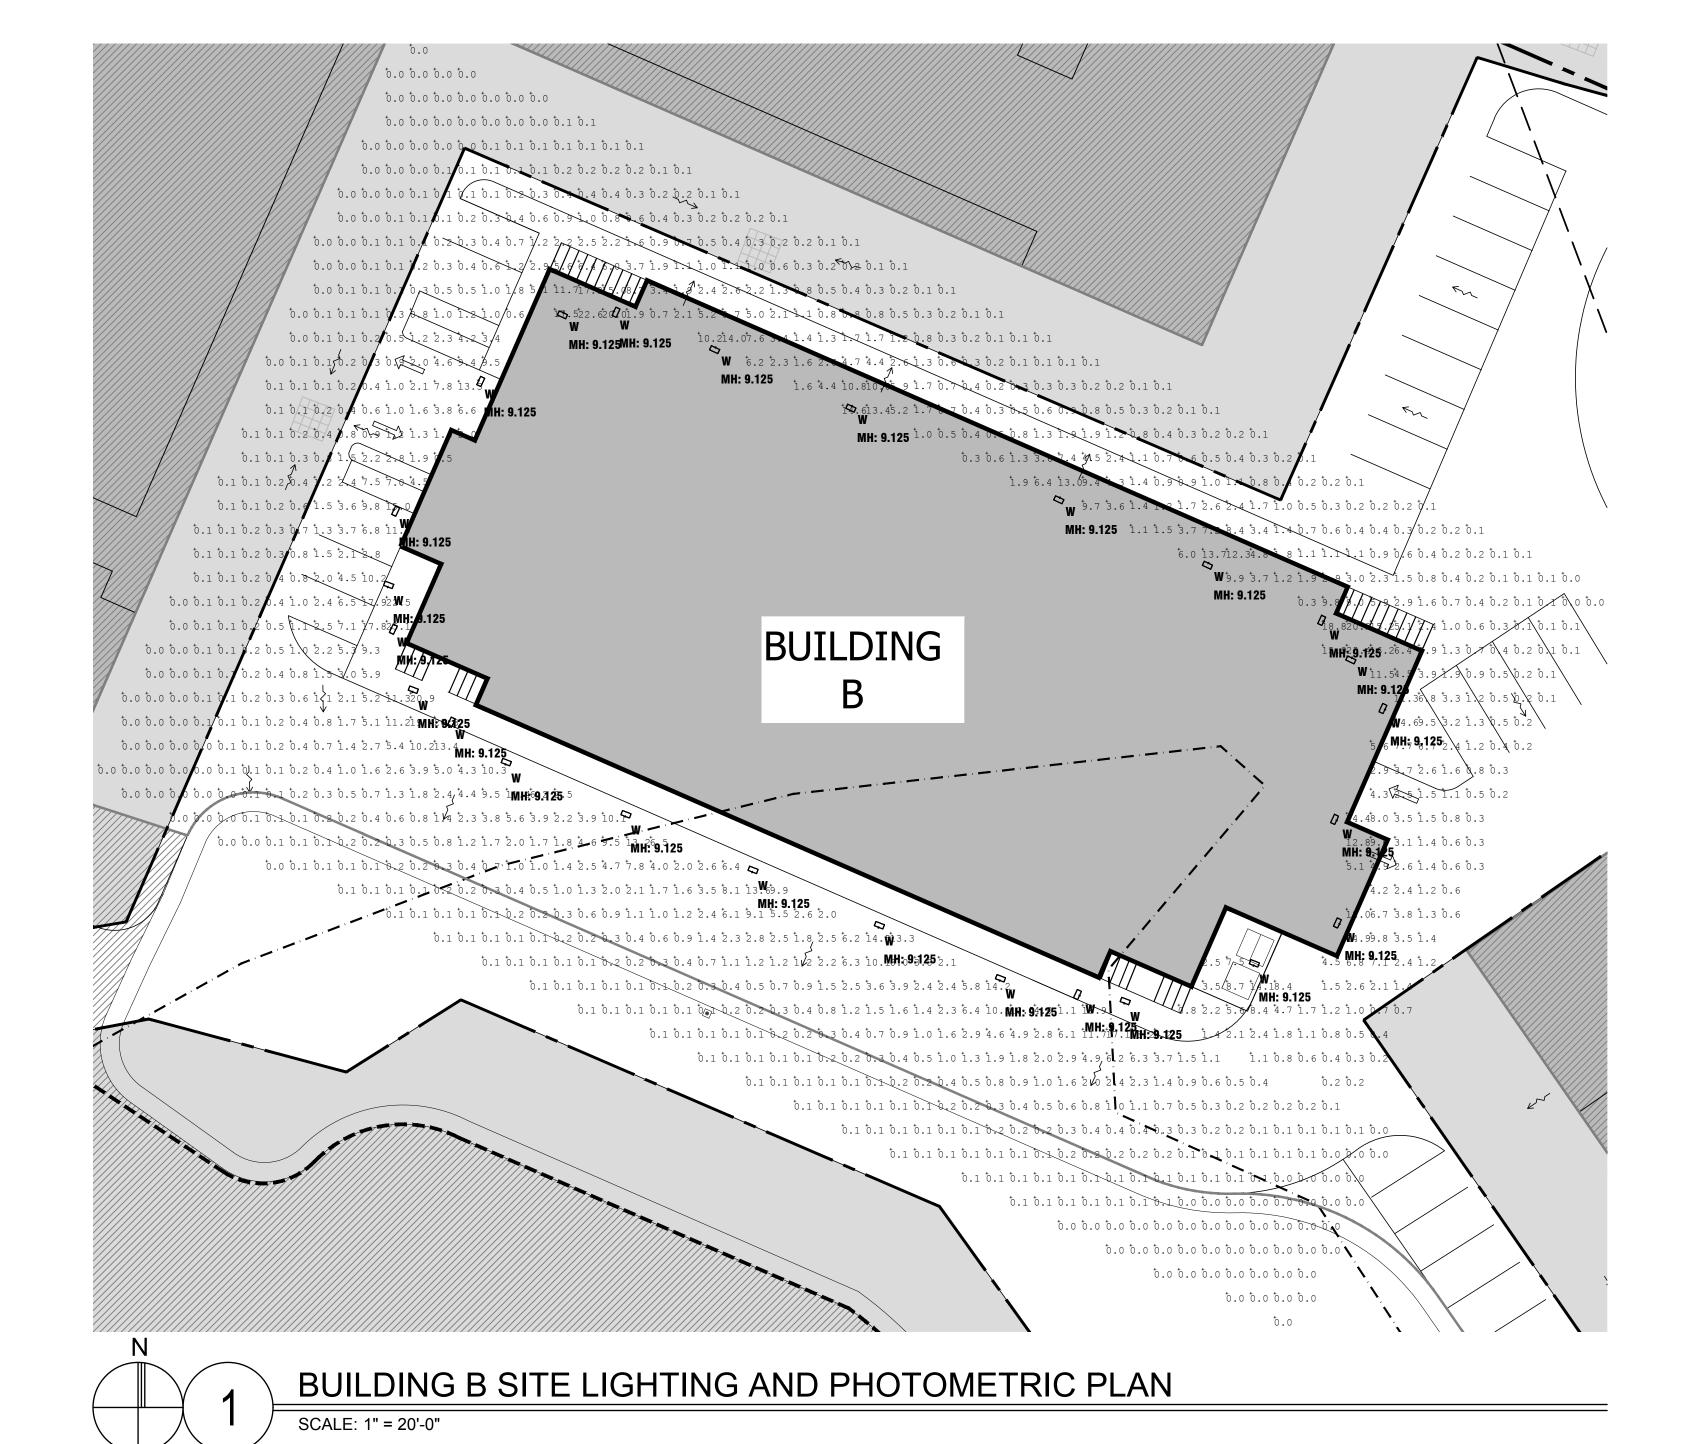

Calculation Summary Project: OCEAN WALK APTS - BLDGS A & B - EXTERIOR - REV1


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BLDG A EXTERIOR


BLDG B EXTERIOR

Project: OCEAN WALK APTS - BLDGS 1 & B - EXTERIOR - REV1 --- JAN - 12 - 2016 LUMINOSO SWPK2-65W 0.900 0.900 1.000 0.810 59.5



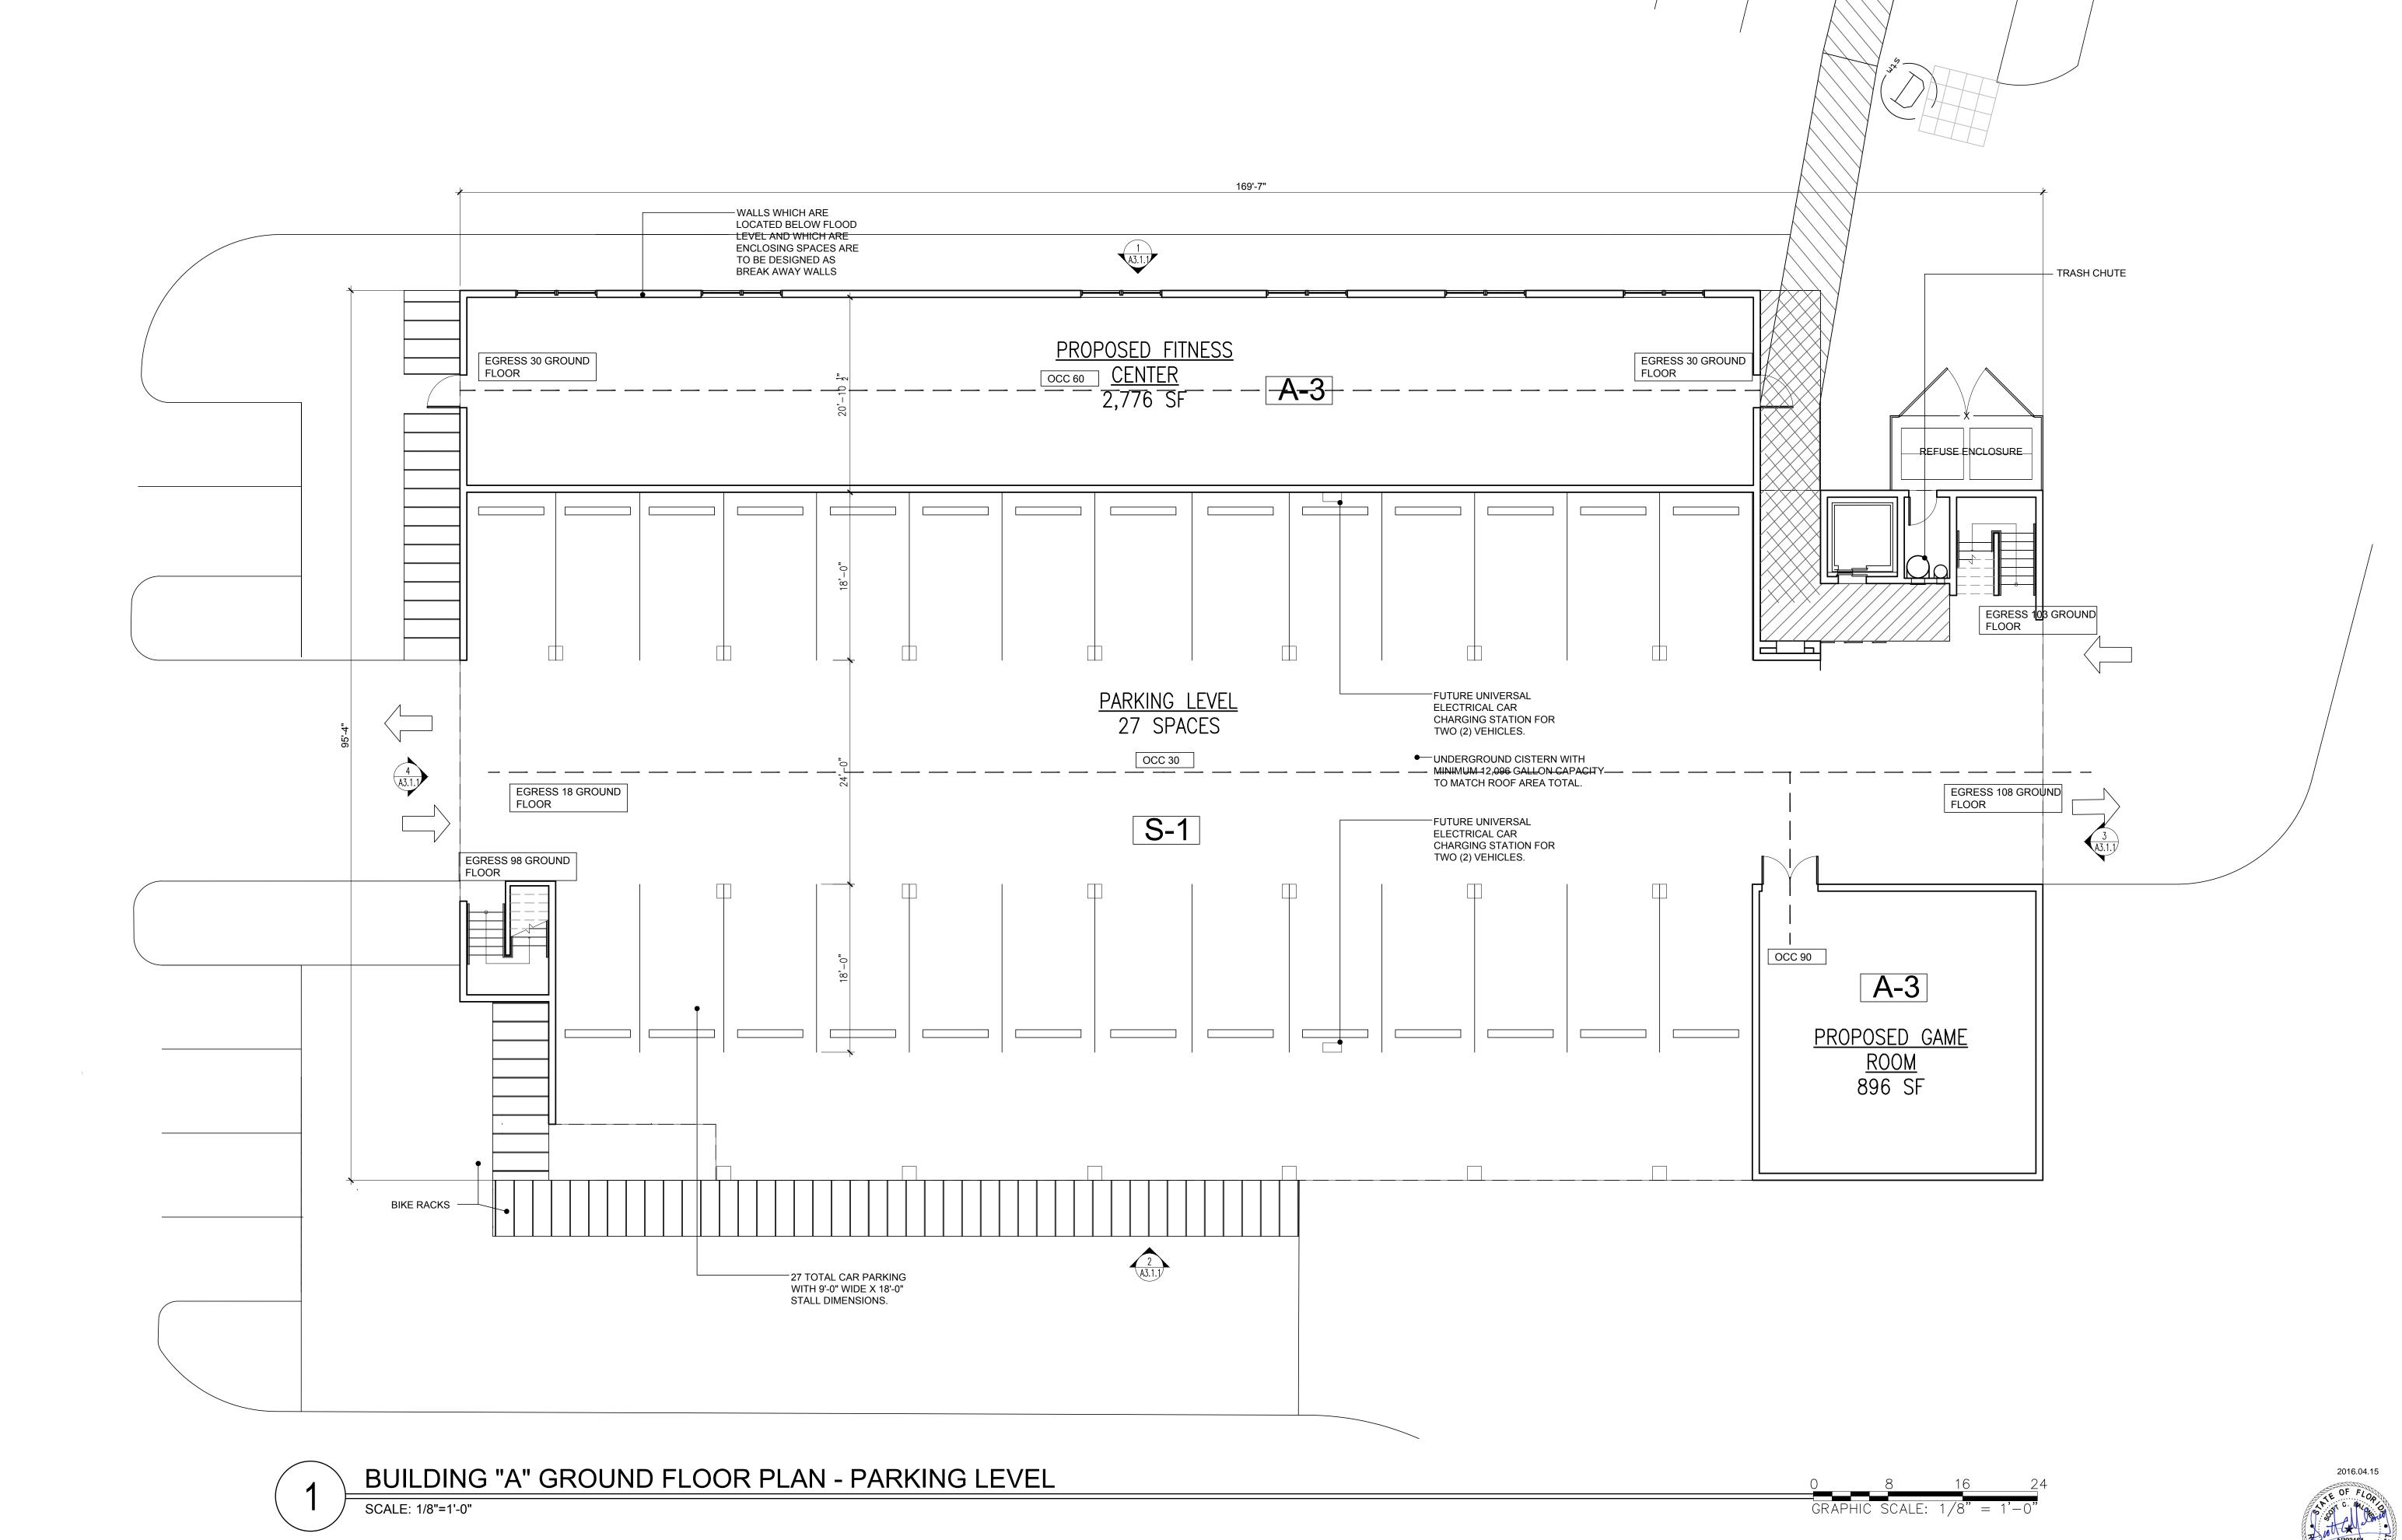


В	BUILDING "A" UNIT KEY					
TYPE	QUANTITY	DESCRIPTION	SQUARE FOORTAGE			
Α	16	3 BEDROOM 2 BATH UNIT	1,015 SF			
В	1	ADA 1 BEDROOM 1 BATH UNIT	699 SF			
С	6	1 BEDROOM 1 BATH UNIT	524 SF			
D	11	1 BEDROOM 1 BATH UNIT	699 SF			
Е	1	ADA 3 BEDROOM 2 BATH UNIT	1,015 SF			
TOTAL	35 UNITS	3				

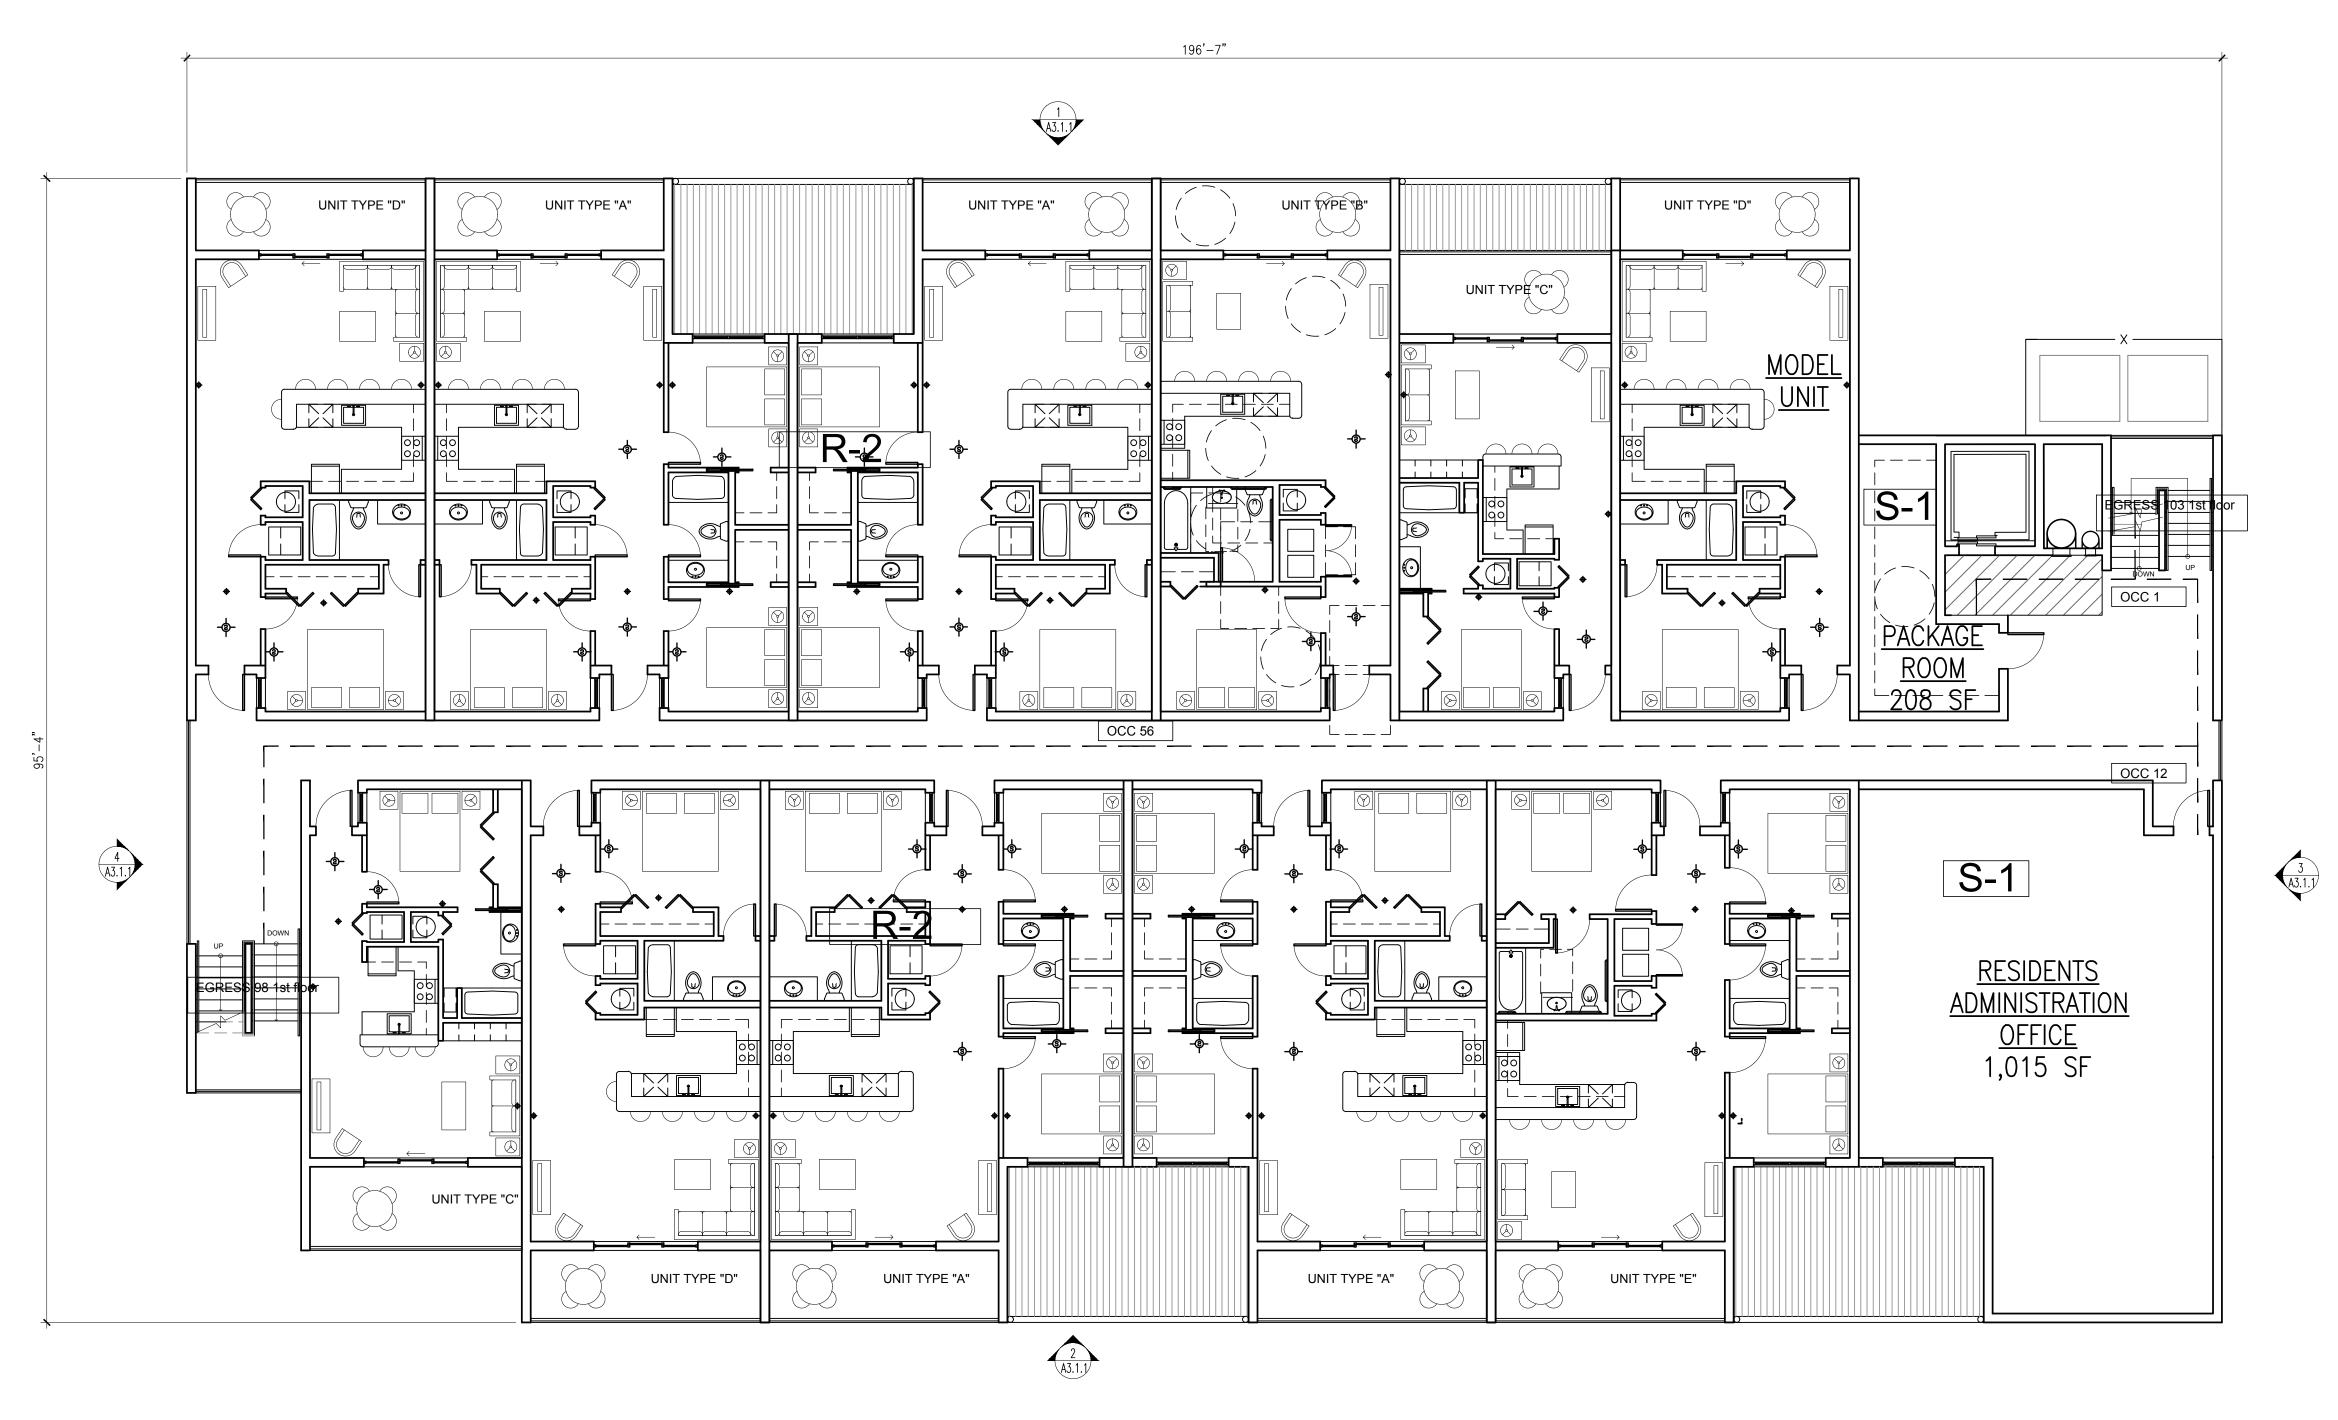






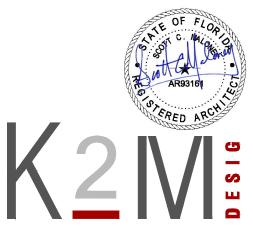


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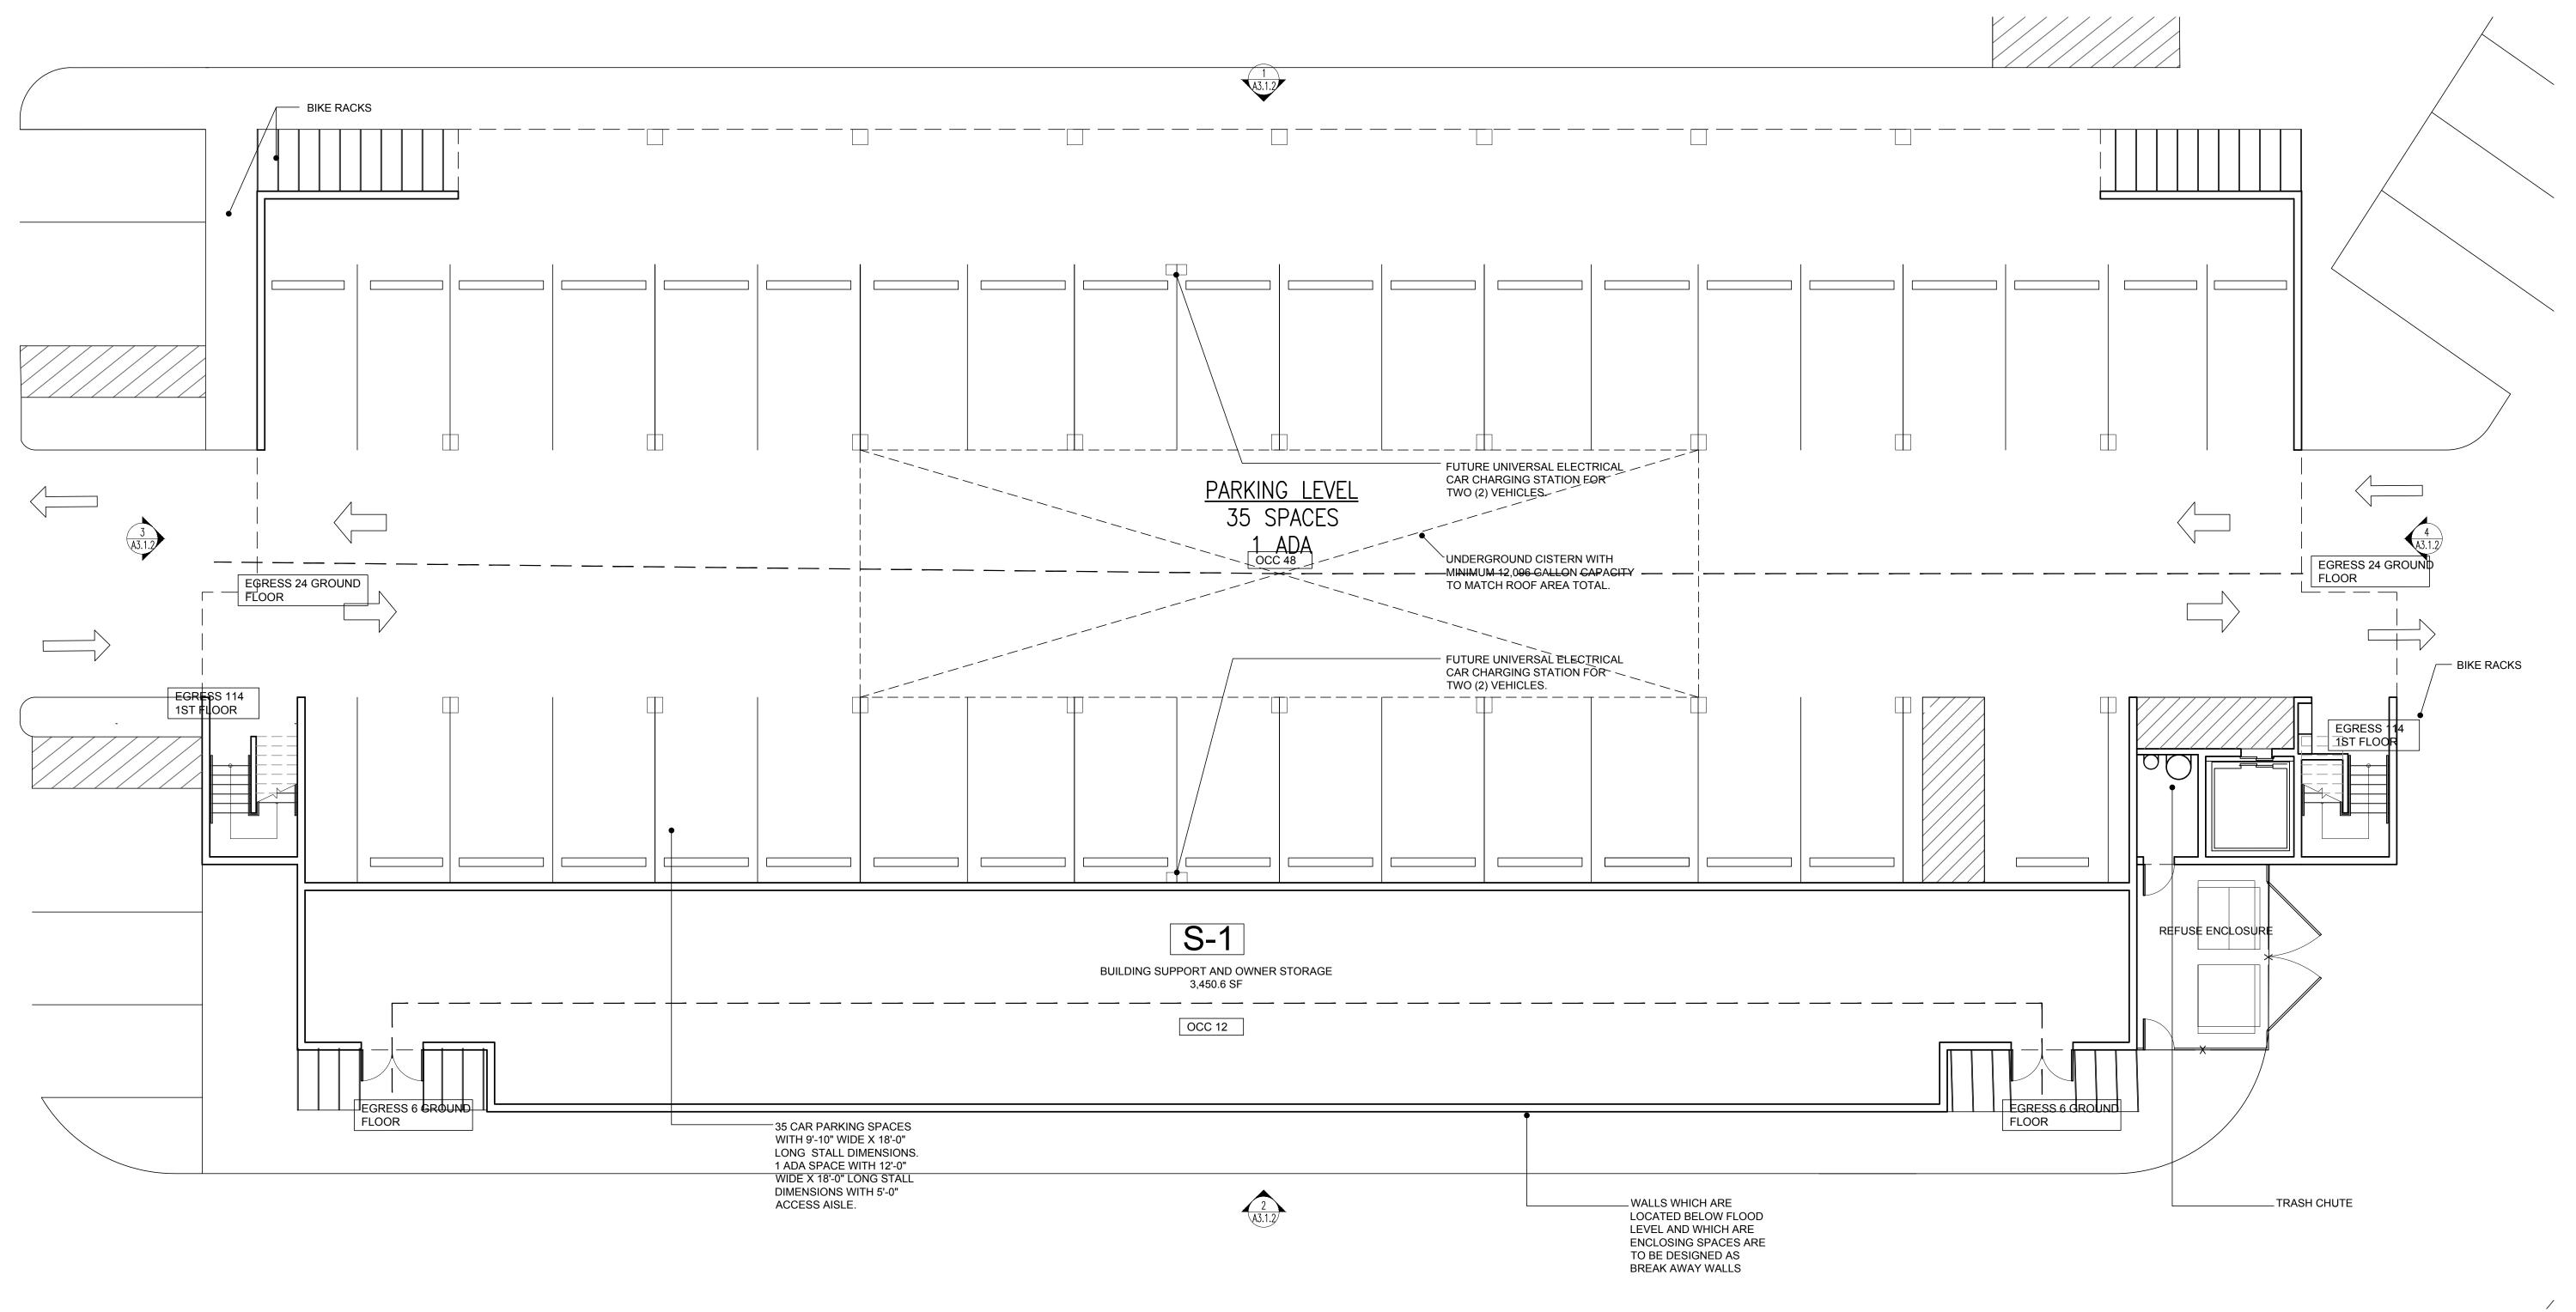


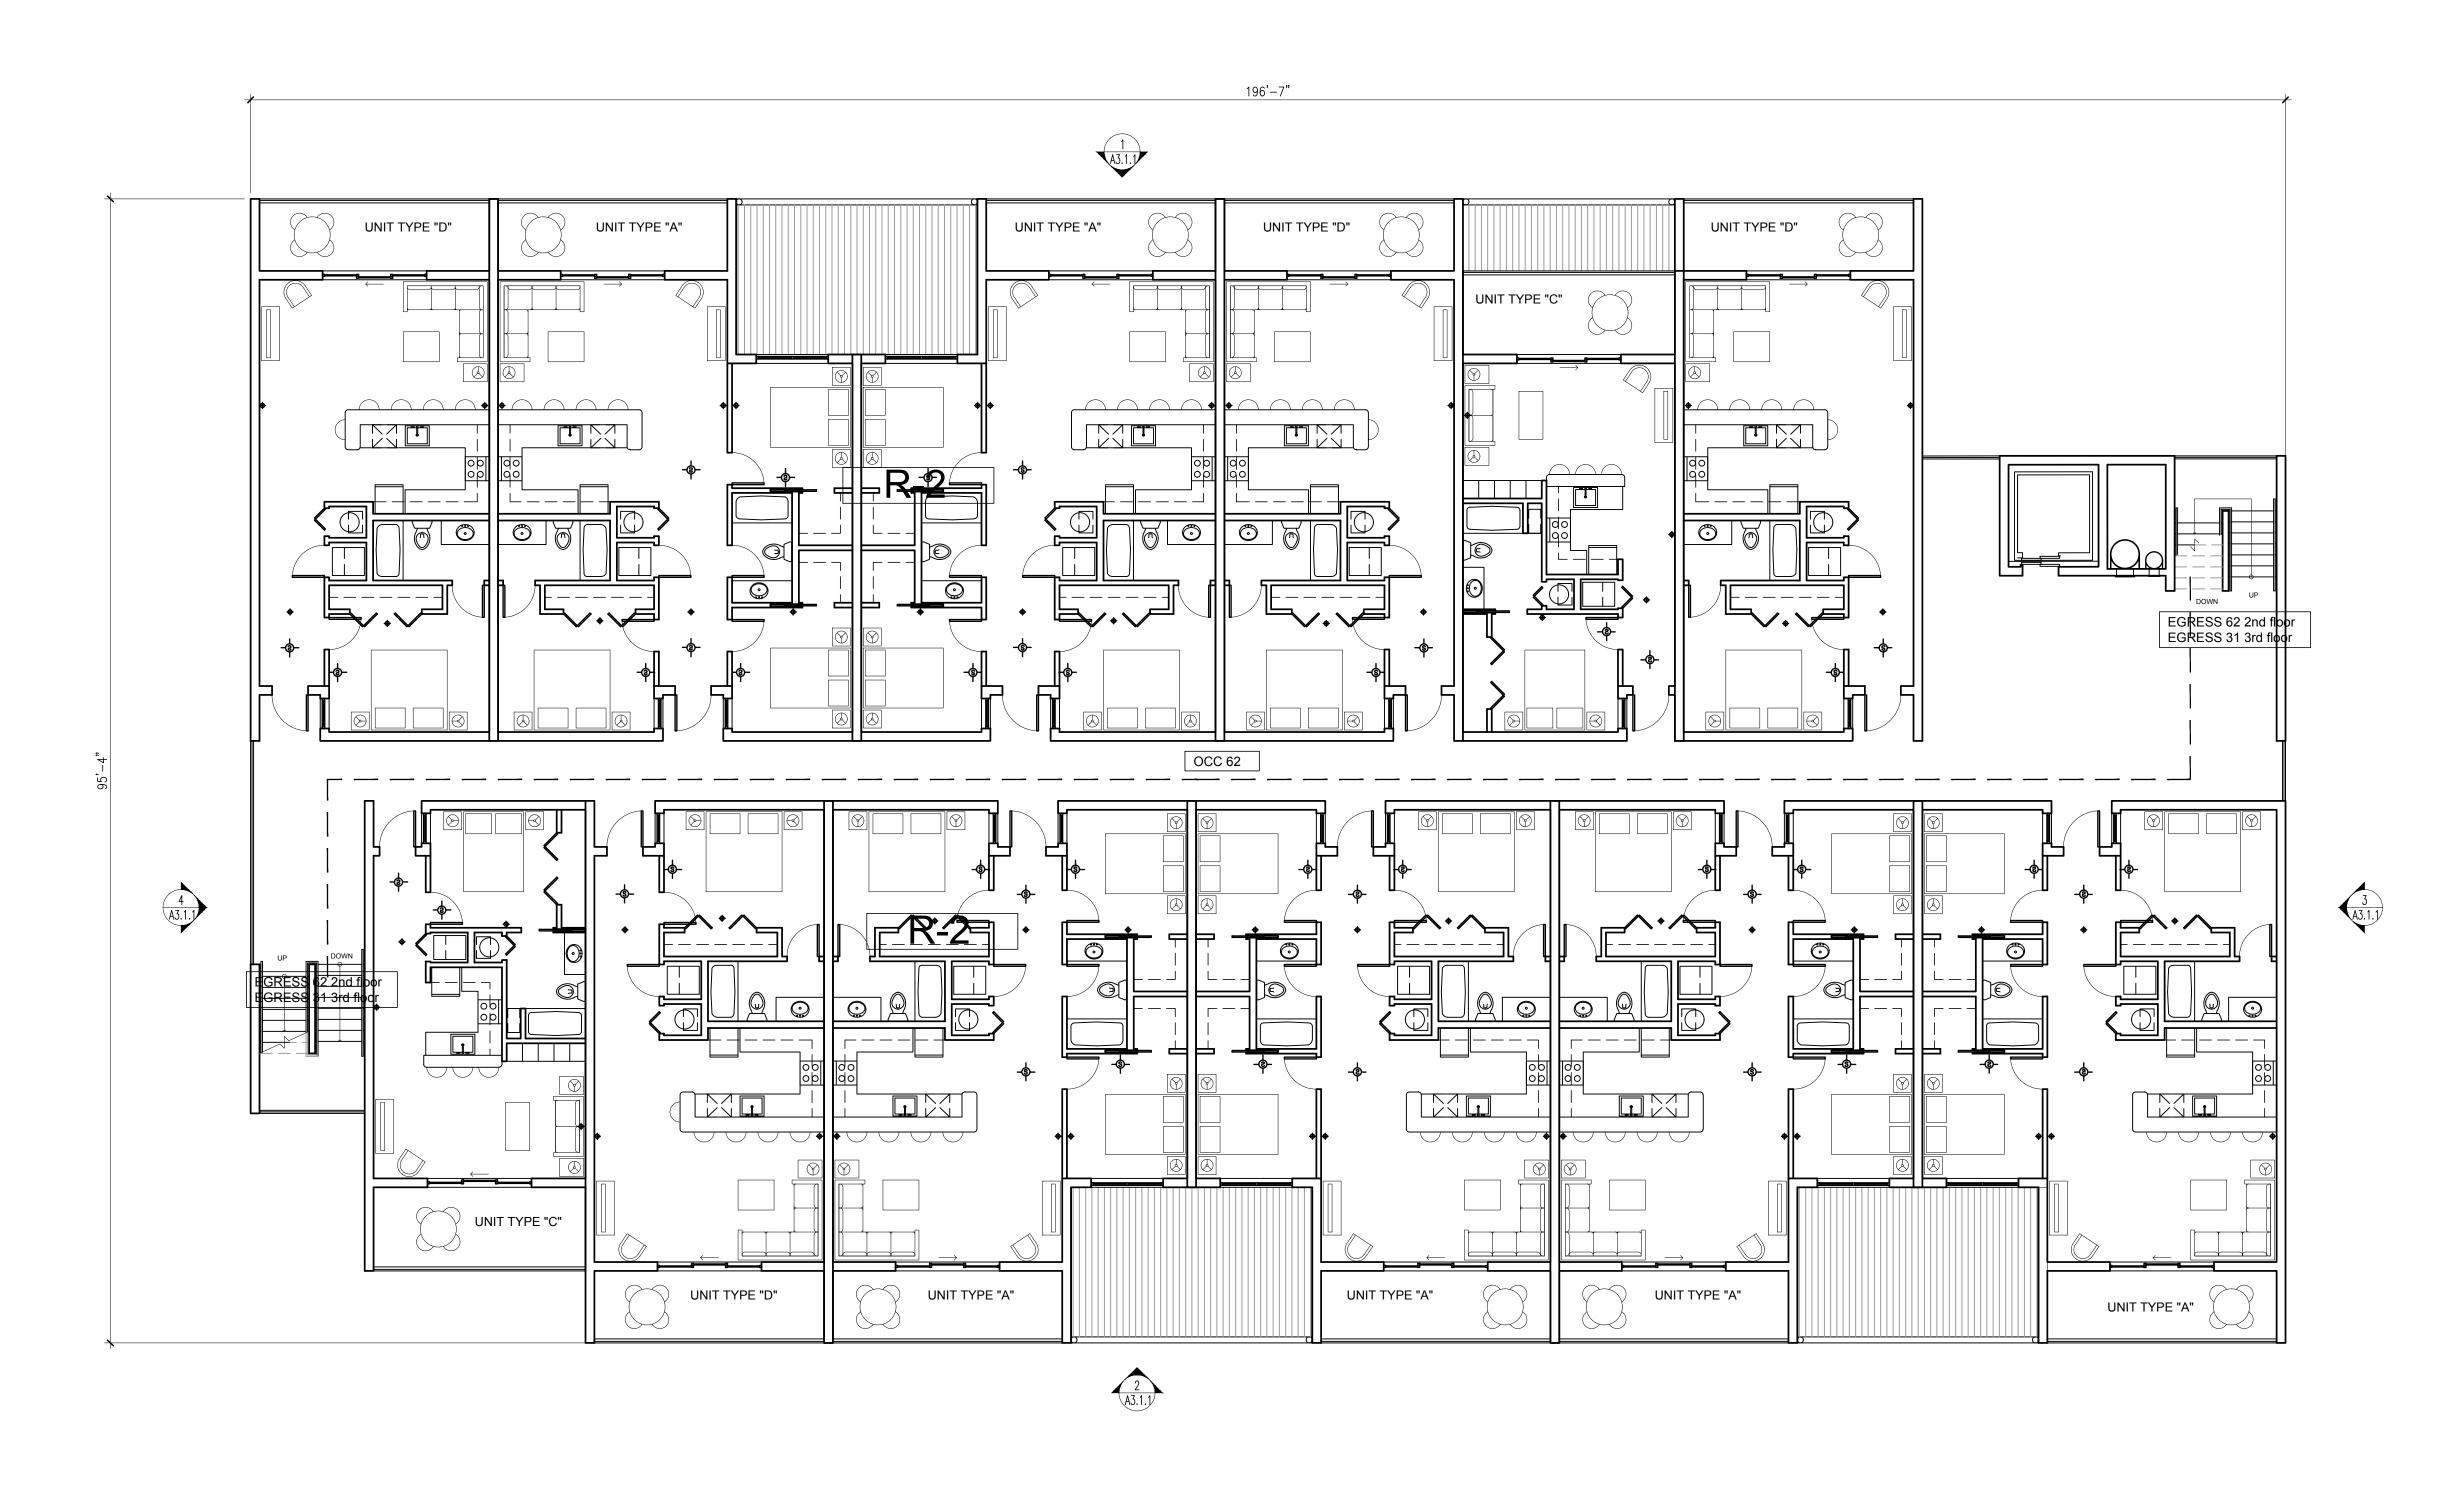


BUILDING "A" SECOND AND THIRD FLOOR PLANS






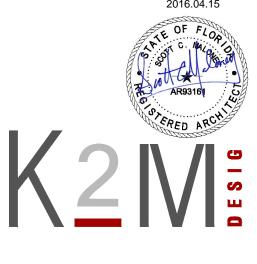



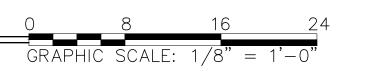

BUILDING "B" UNIT KEY					
TYPE	QUANTITY	DESCRIPTION	SQUARE FOORTAGE		
Α	23	3 BEDROOM 2 BATH UNIT	1,015 SF		
В	2	ADA 1 BEDROOM 1 BATH UNIT	699 SF		
С	12	1 BEDROOM 1 BATH UNIT	524 SF		
D	7	1 BEDROOM 1 BATH UNIT	699 SF		
Е	1	ADA 3 BEDROOM 2 BATH UNIT	1,015 SF		
TOTAL	45 UNITS	3			

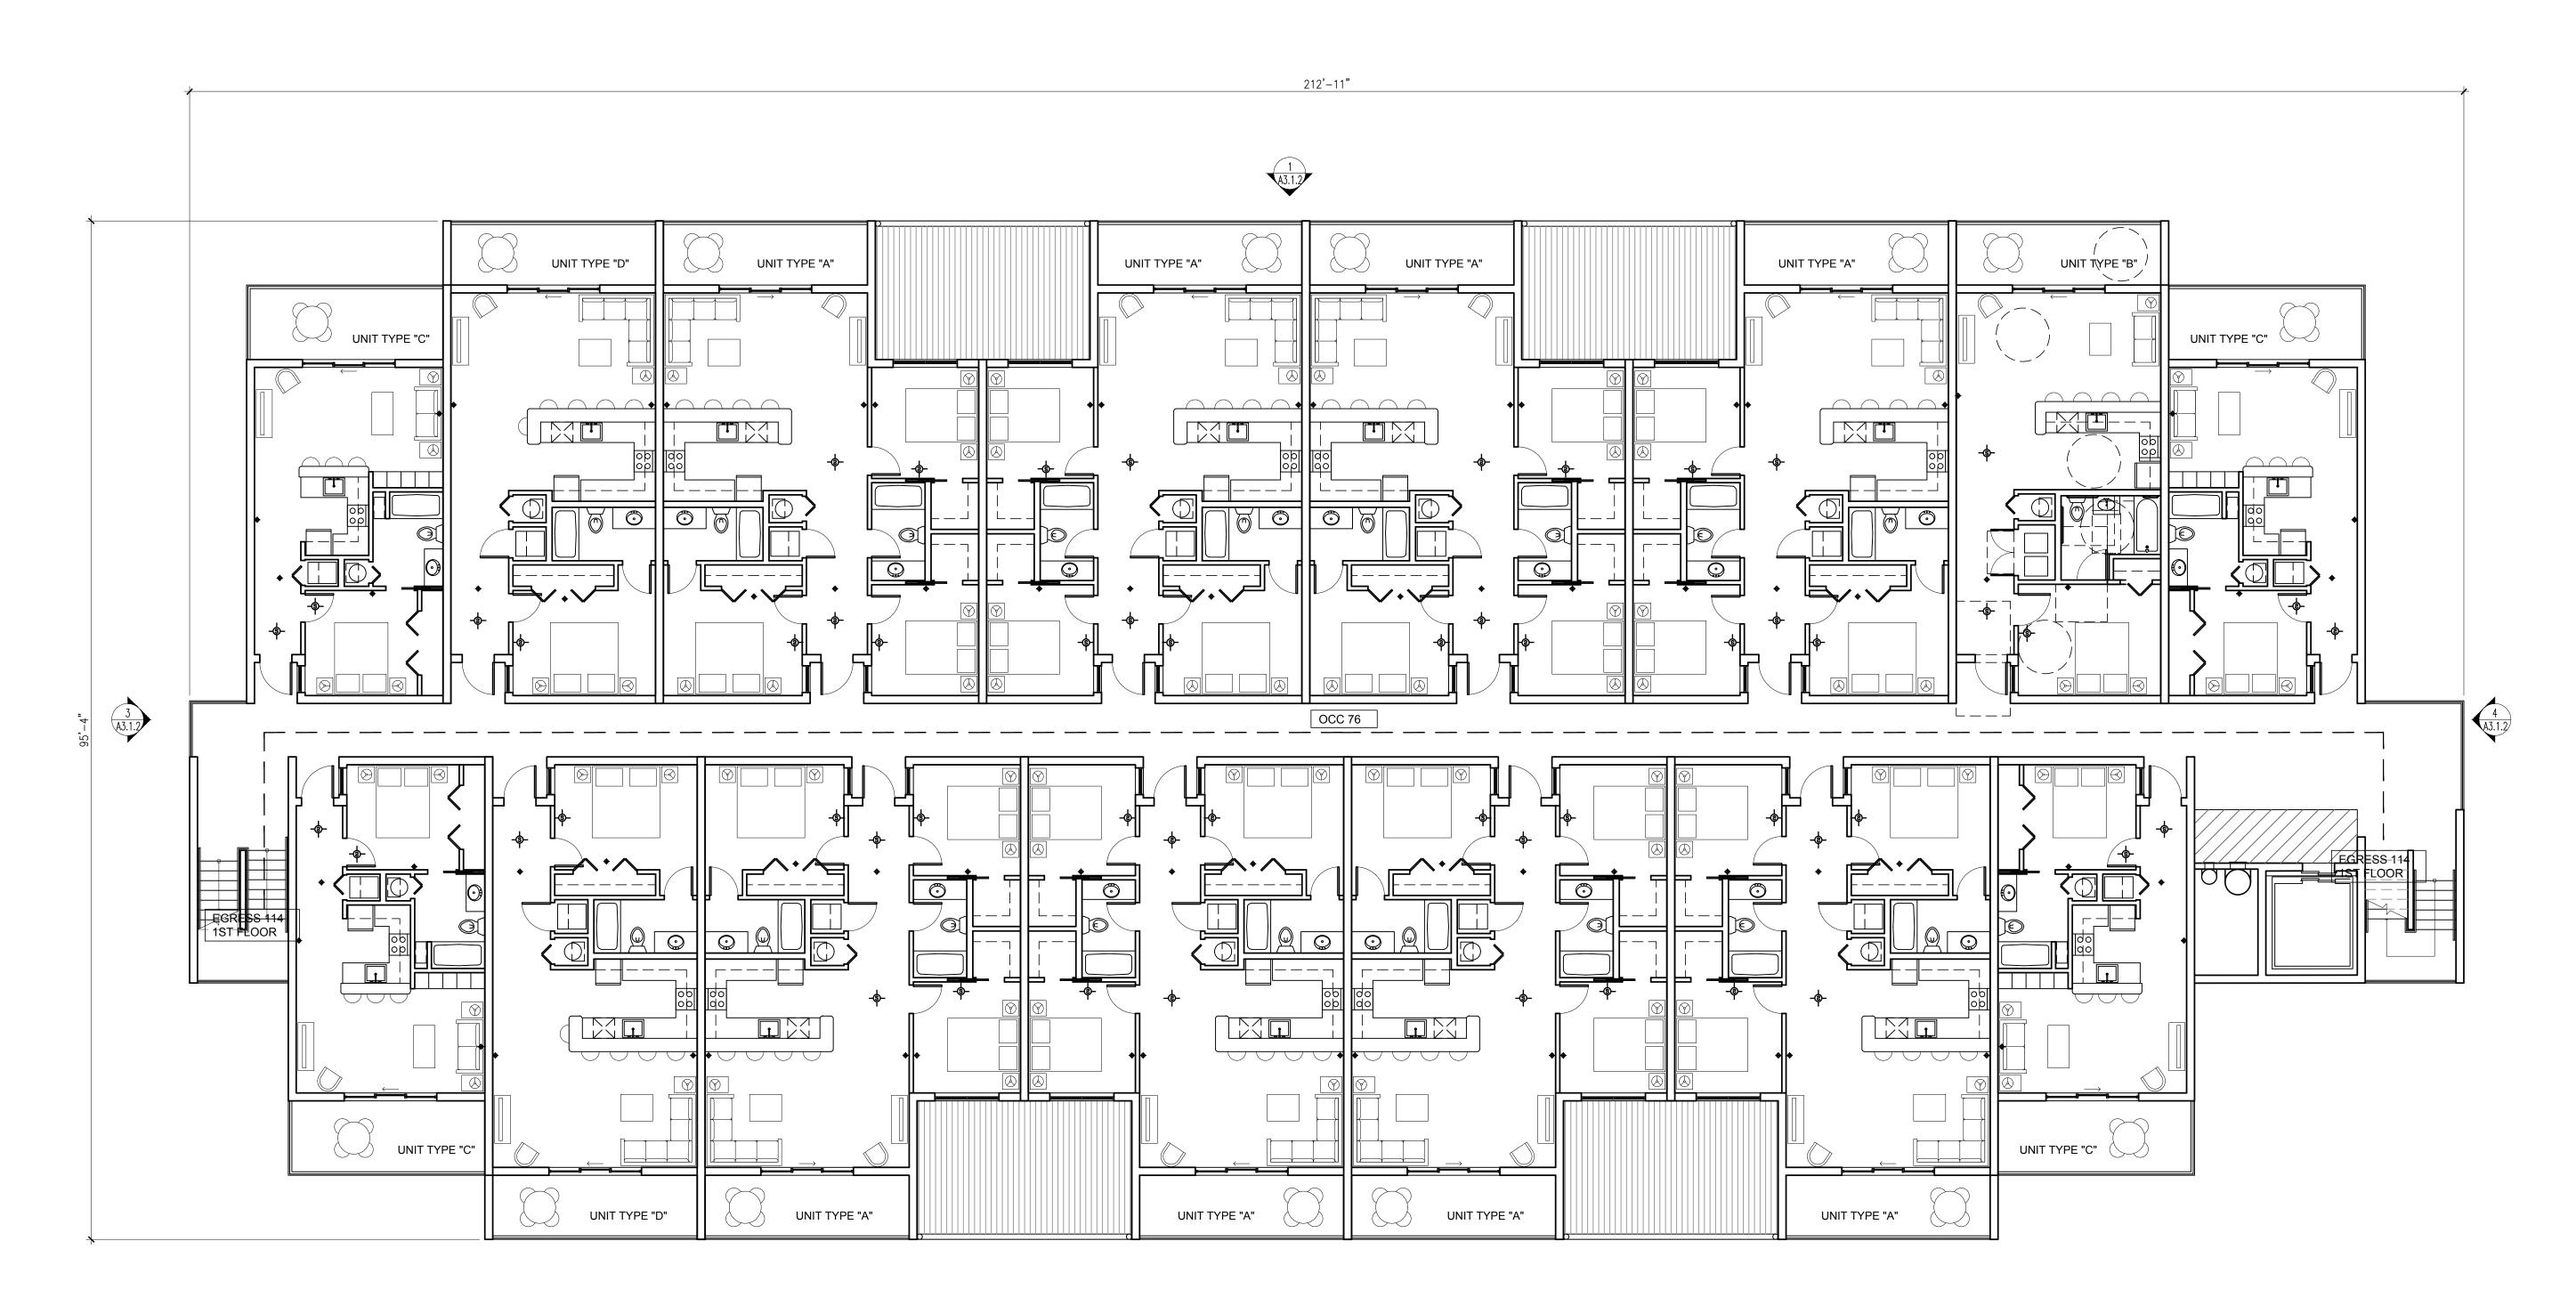








В	BUILDING "B" UNIT KEY				
TYPE	QUANTITY	DESCRIPTION	SQUARE FOORTAGE		
Α	23	3 BEDROOM 2 BATH UNIT	1,015 SF		
В	2	ADA 1 BEDROOM 1 BATH UNIT	699 SF		
С	12	1 BEDROOM 1 BATH UNIT	524 SF		
D	7	1 BEDROOM 1 BATH UNIT	699 SF		
Е	1	ADA 3 BEDROOM 2 BATH UNIT	1,015 SF		
TOTAL	45 UNITS	3			

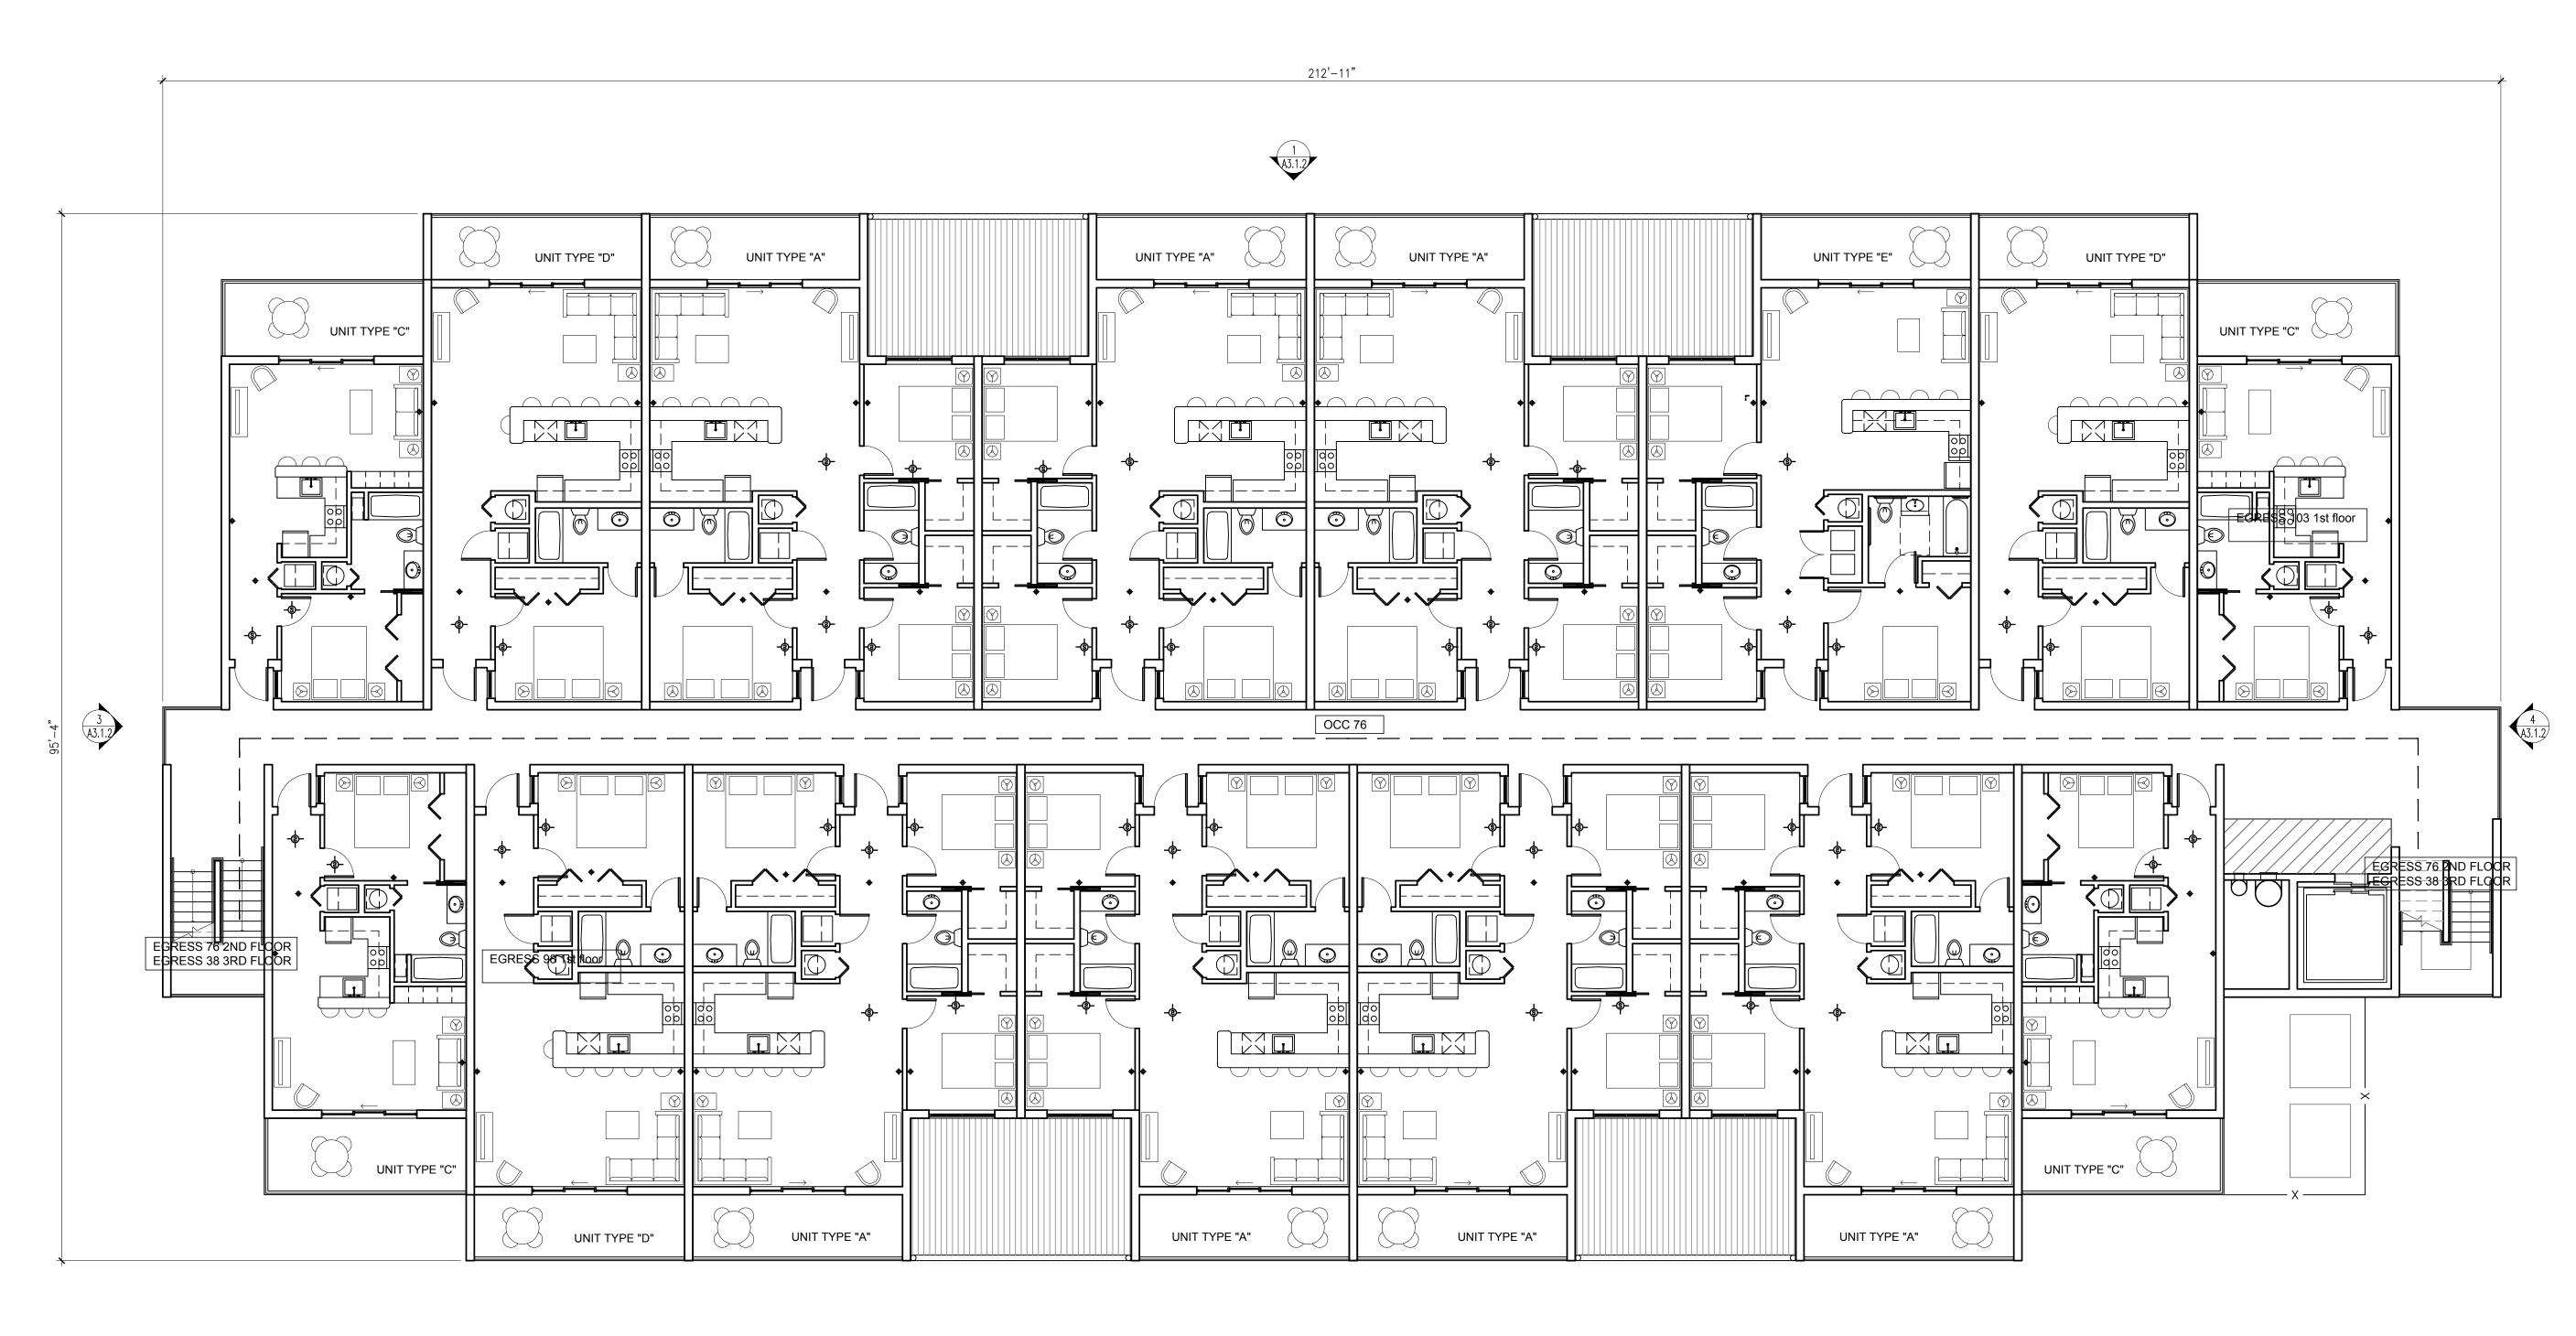








BUILDING "B" SECOND AND THIRD FLOOR PLANS





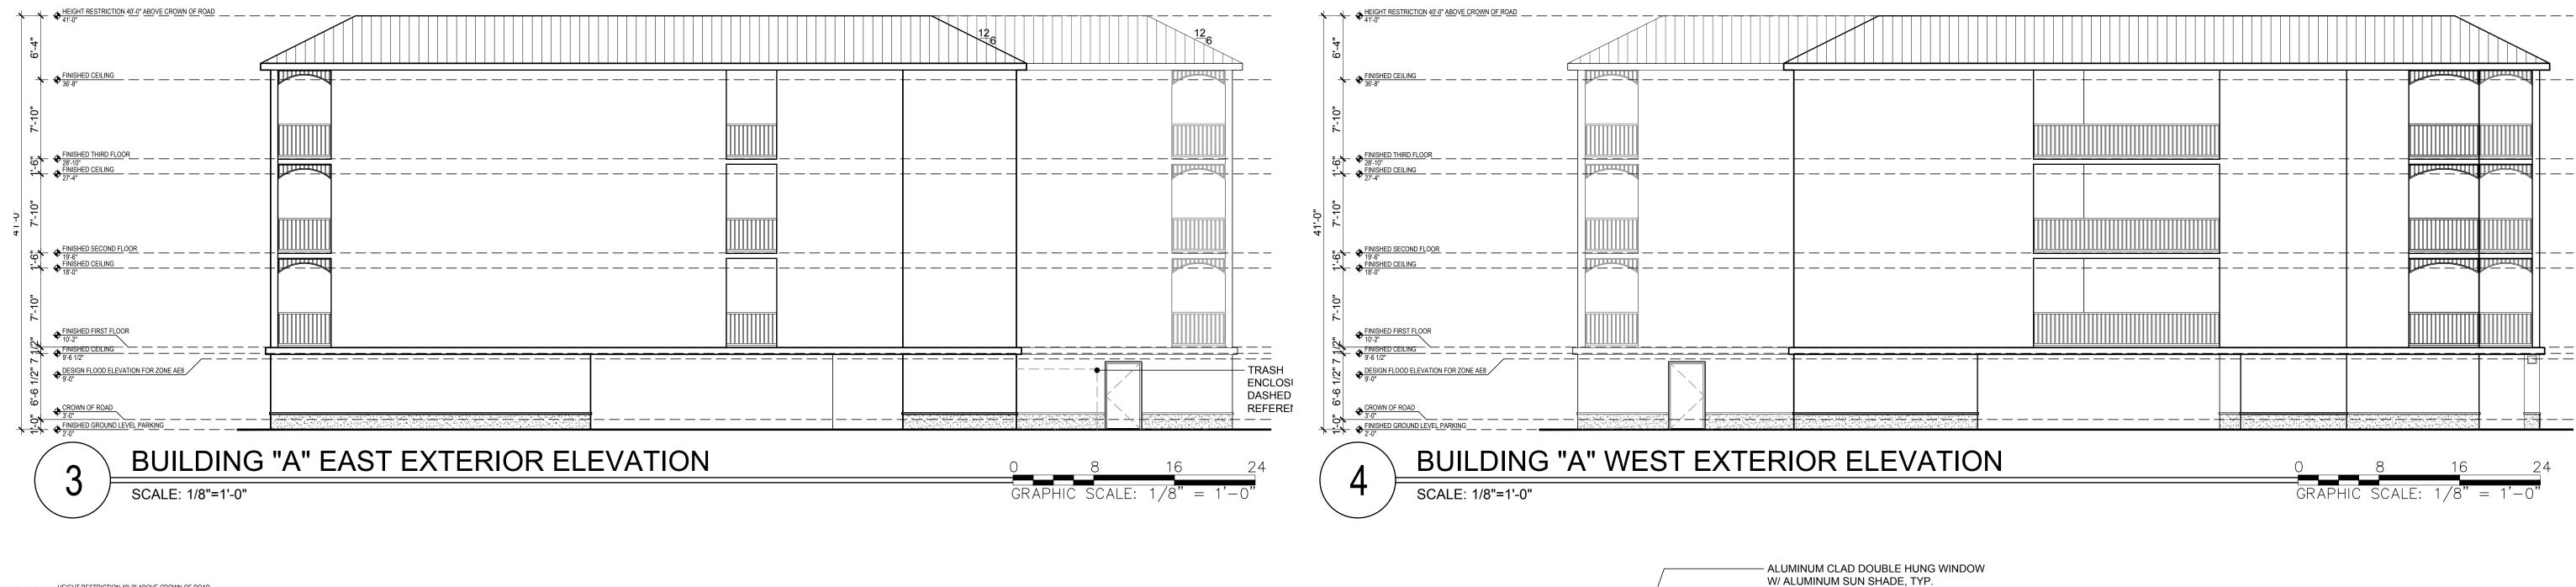


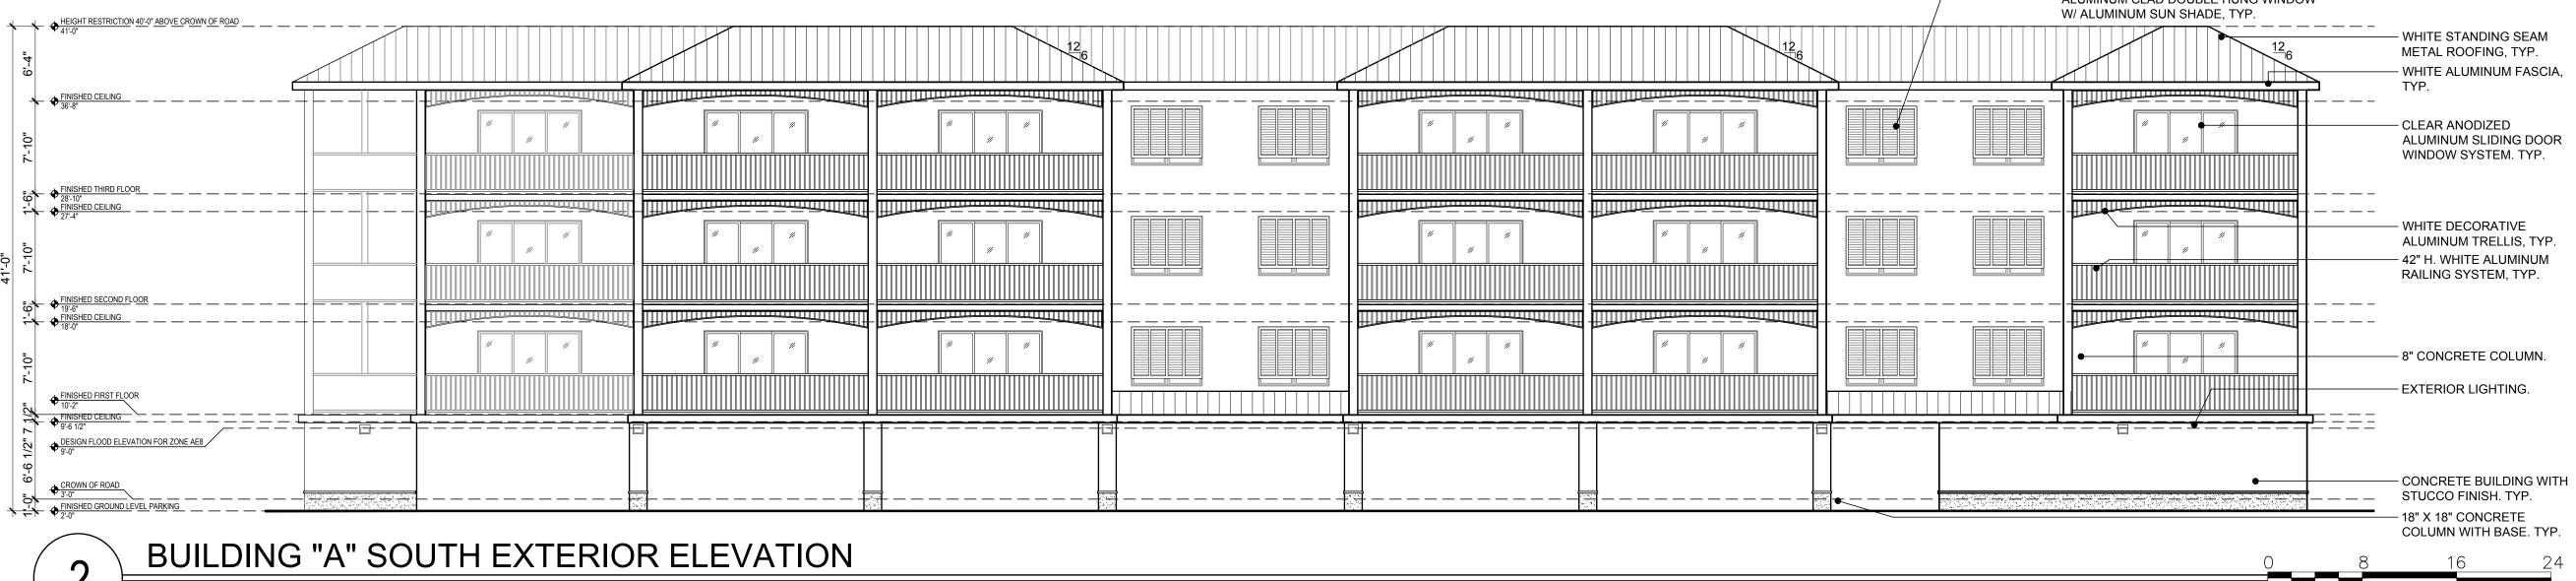


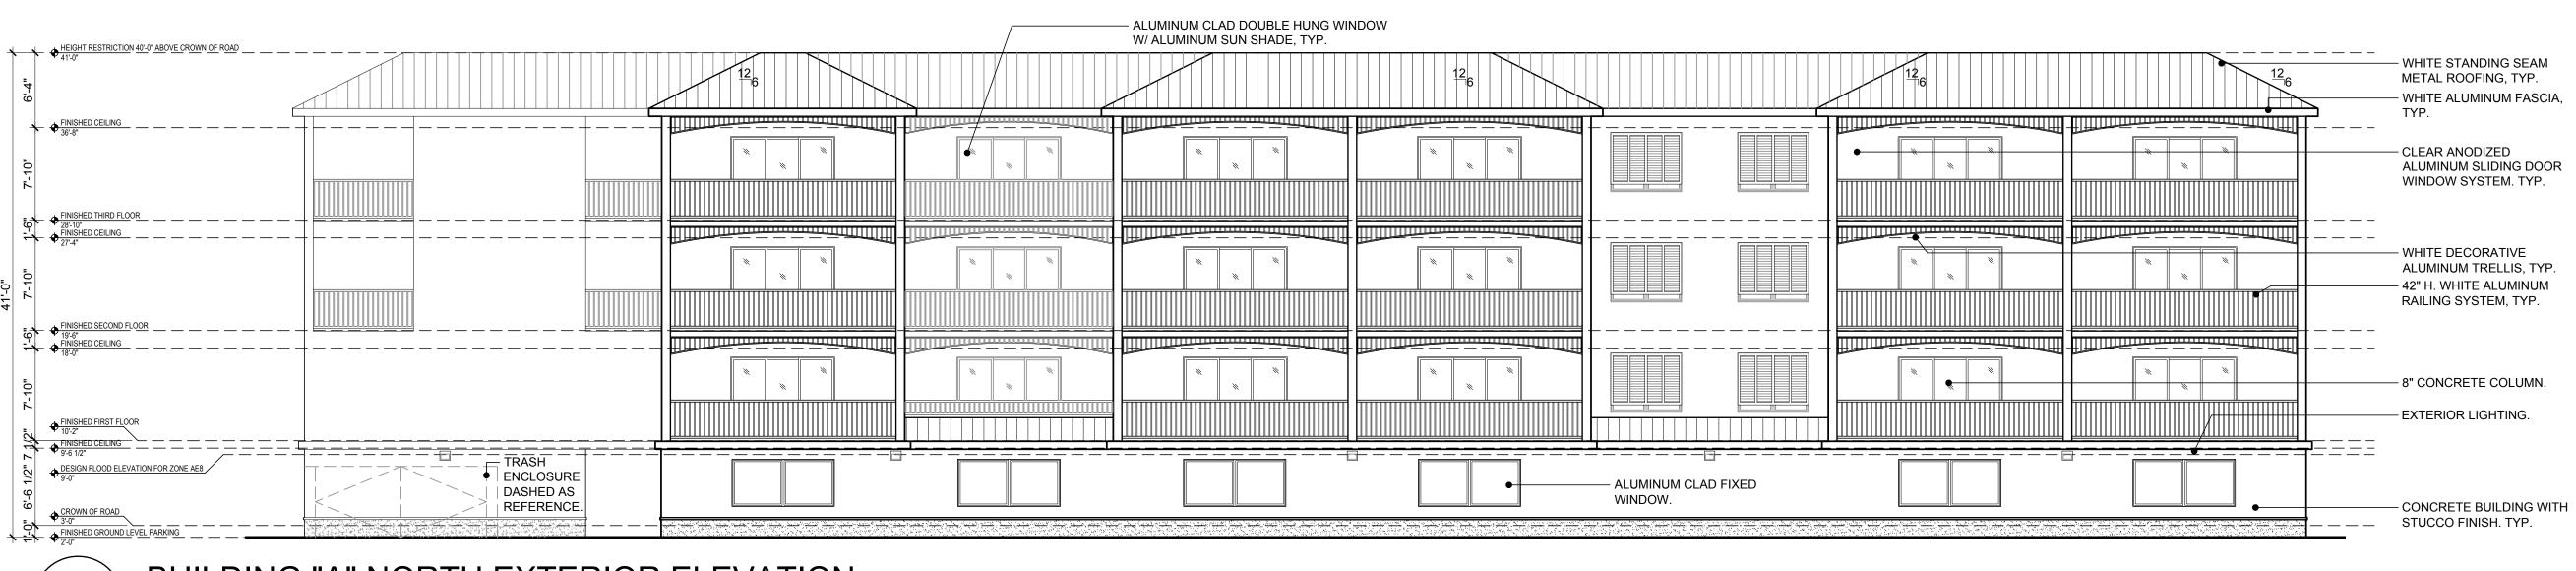


BUILDING "A" NORTH EXTERIOR ELEVATION

SCALE: 1/8"=1'-0"

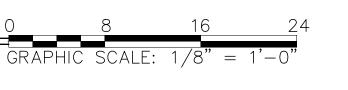

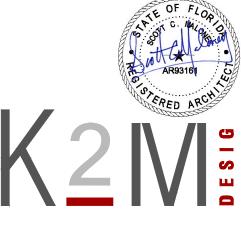

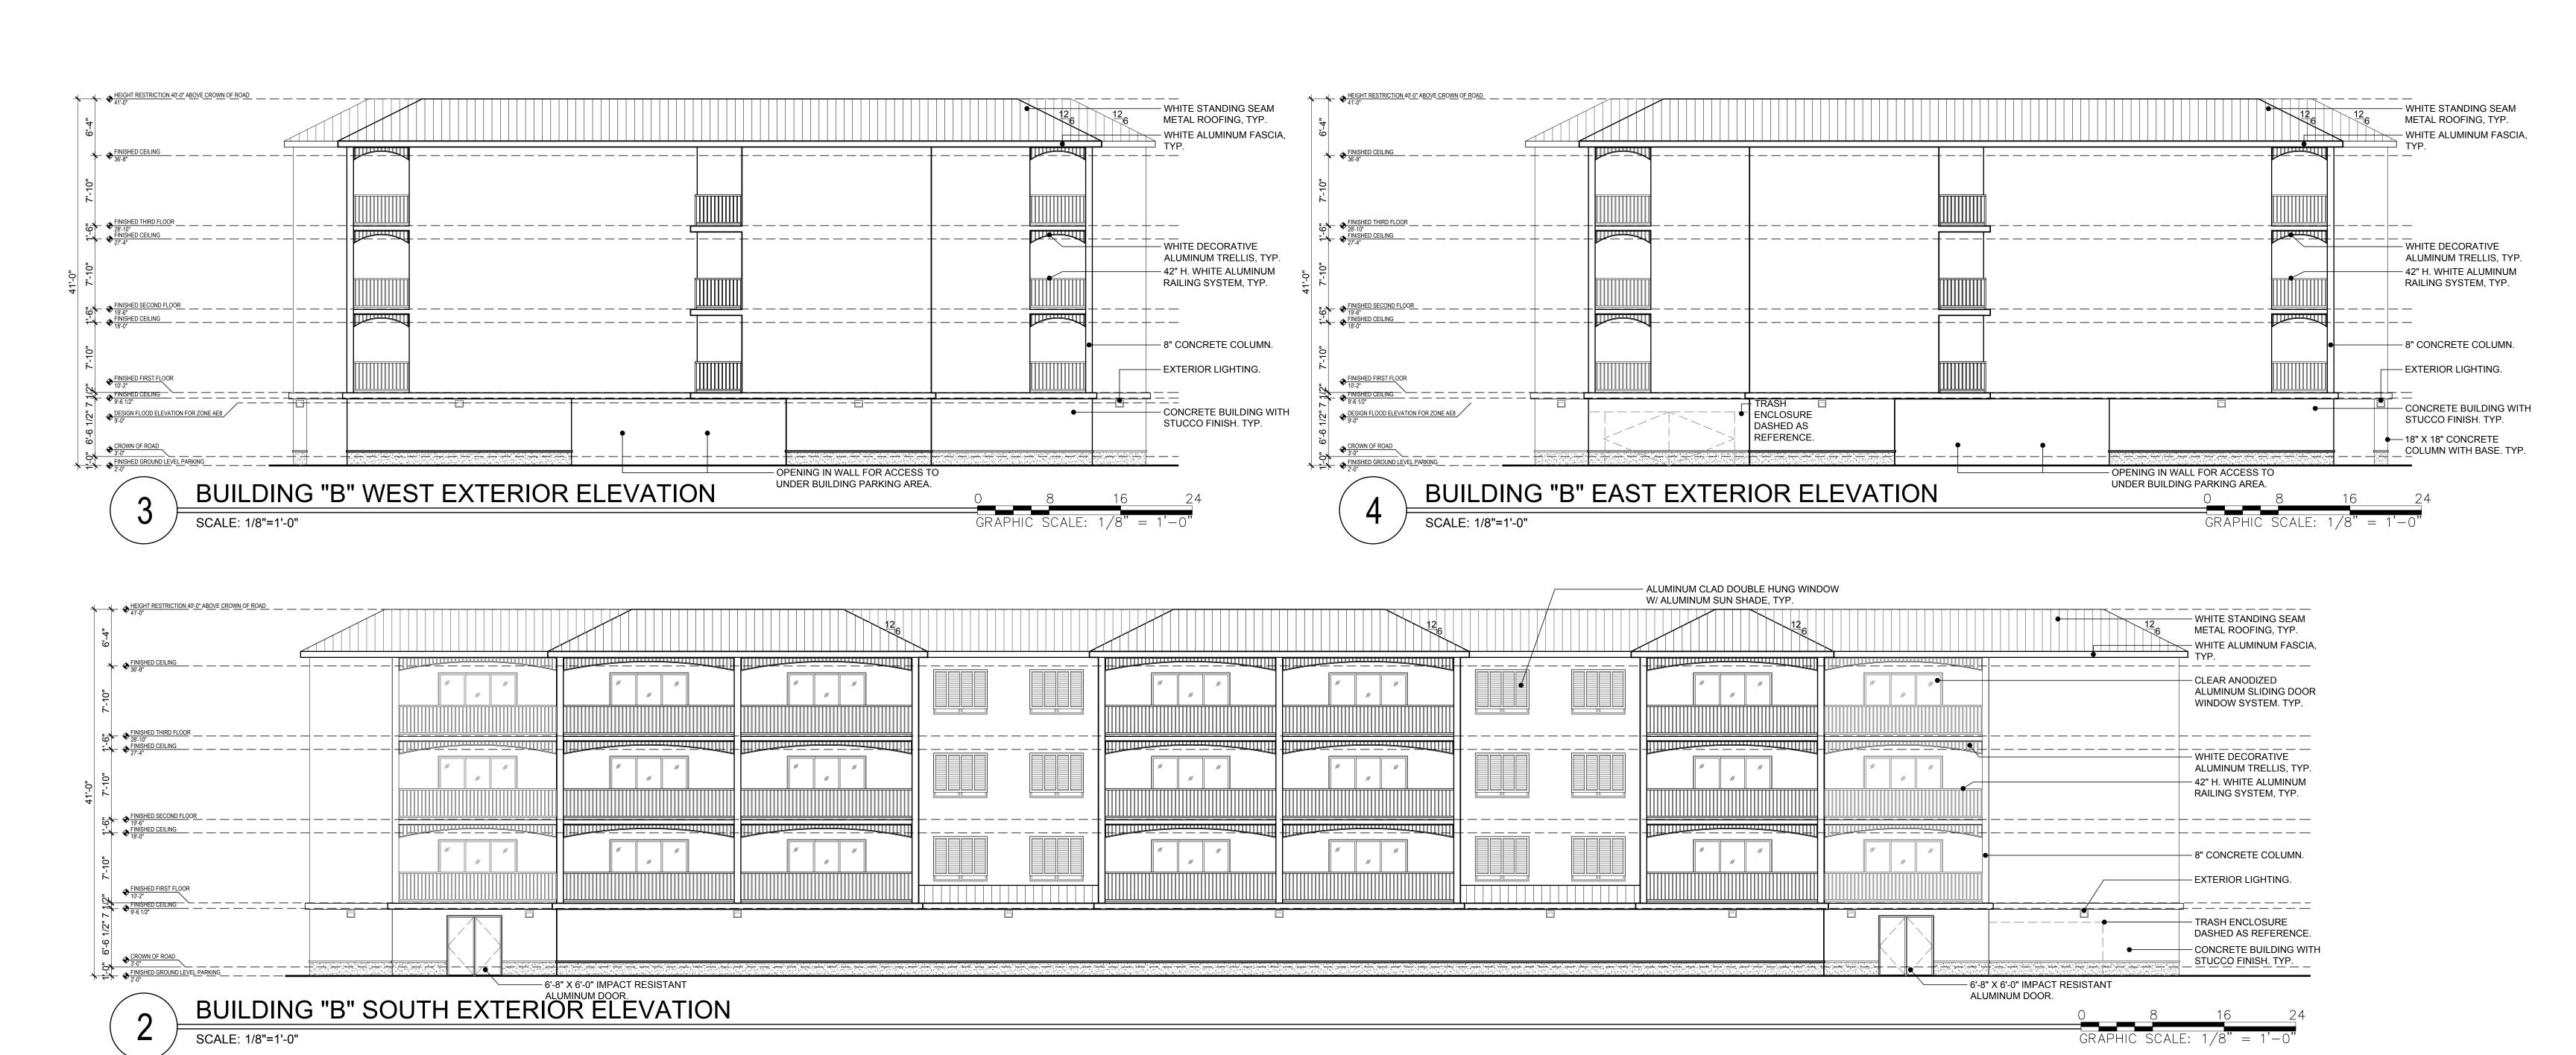


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BUILDING "B" NORTH EXTERIOR ELEVATION

A3.1.2

COLUMN WITH BASE. TYP.



SCALE: 1/60" = 1'-0"

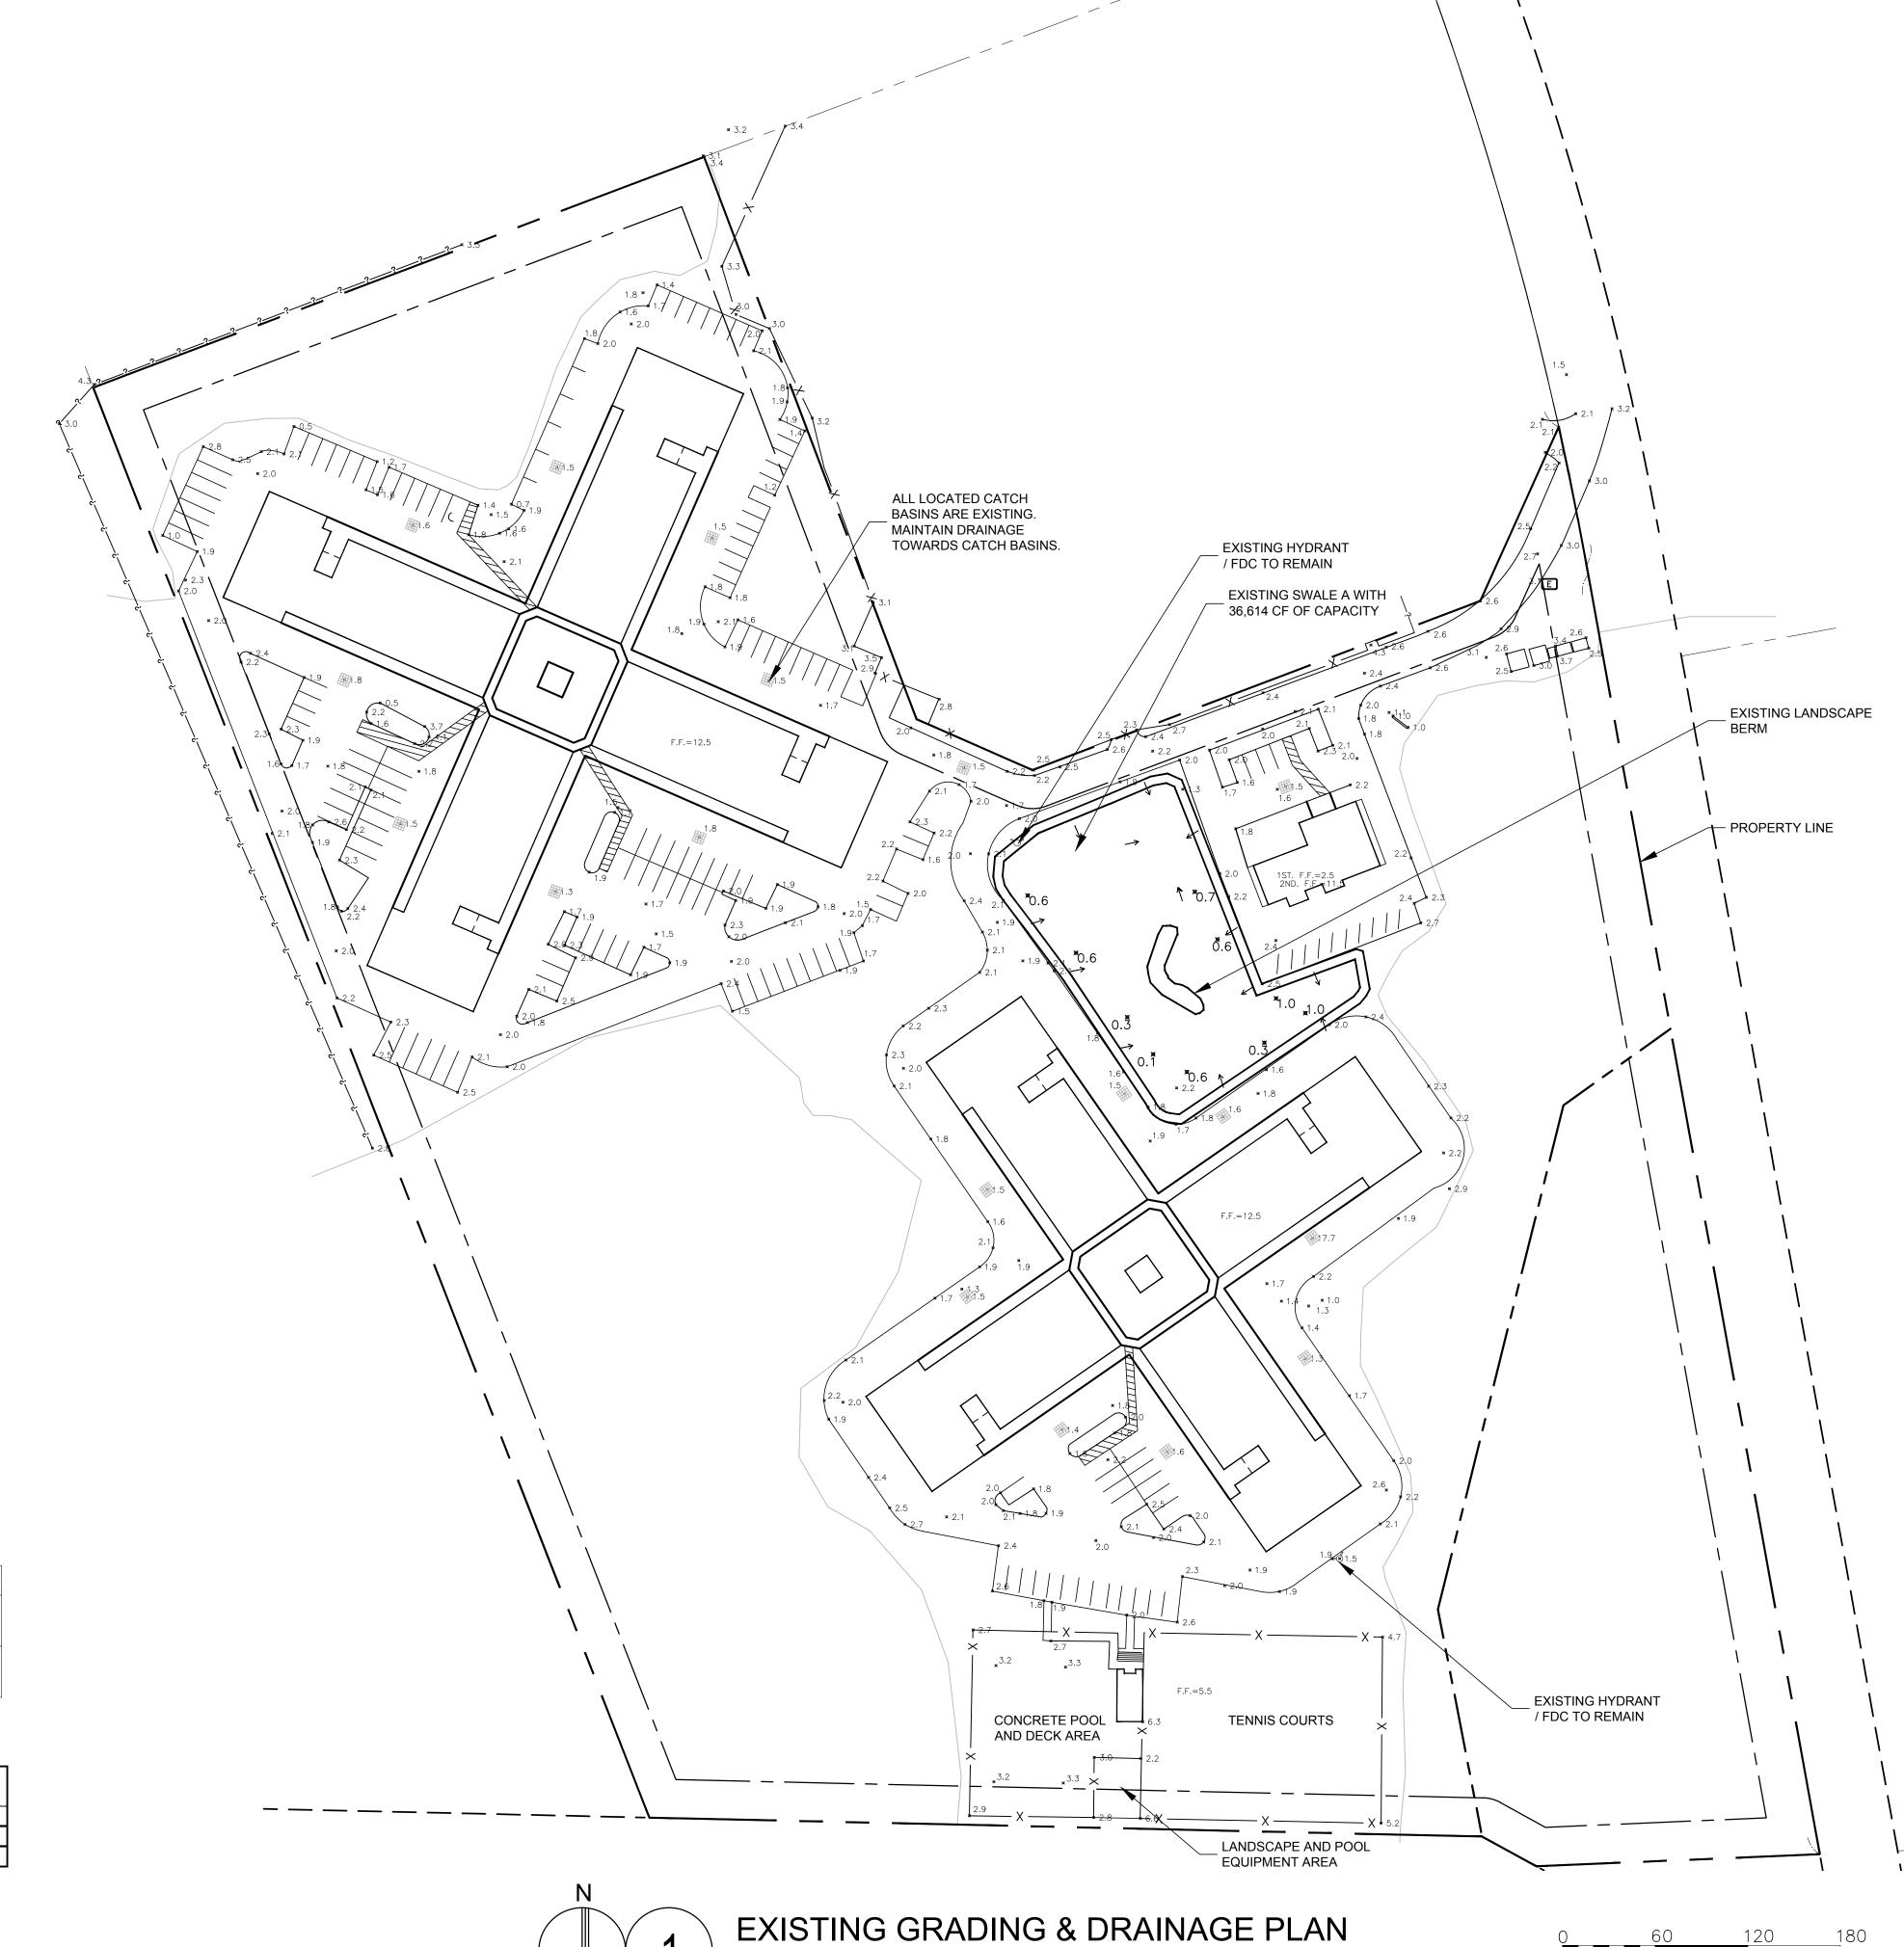LEGEND * 2.4 SPOT ELEVATIONS PER SURVEY PROVIDED BY OWNER *0.6 ASSUMED SPOT ELEVATIONS PER FIELD CONDITIONS

Existing Swale Calculation

	Top Area	Bot Area	Depth	Volume
	(Average FT)	(Average FT)	(FT)	(CF)
Swale A	26,968	21,852	1.5	36,615
Total				36,615

NOTE: ALL EXISTING DRAINAGE AREAS ARE ASSUMED AND BASED OFF OF SITE VISITS, PHOTOGRAPHS, SURVEYS, AND AERIAL DATABASES.

Proposed Site

	Area	Area	Imperv
Land Use	sf	ac	ac
Total Acreage	745312	17.11	
Existing Impervious Area	332171	7.63	7.63
Proposed Impervious Area	371238	8.52	8.52
Percent Impervious	49.81%		

Volume	of Water That needs to be Treated				
	2.5" ove	r impervious surface =	77,341	cf	< Base Requireme
		1" over entire site =	62,109	cf	

Amount of Water to be Treated by Proposed Swales	42,127 cf
Amount of Water to be Held for Irrigation Use by Proposed Cisterns	3,234
Amount of Water to be Treated by Proposed Injection Well	31,980 cf
Total amount of water treated	77,341 cf

Injection Well Capacity Calculation


Well Flow Capacity (CFS) = π x Well Diameter x Exposed Well Length x k				
Well Flow Capacity (CFS)	0.3701	Req'd CF / 24 hours		
Exposed Well Length	35	ft		
k, Per Monroe County Geotechnical Design Data	0.03	CFS/SF		
Well Diameter (min. required)	1.35	in		
Proposed Well Diameter	8	in		
Proposed Well Depth, total	95	ft		
Proposed Exposed Well Length	35	ft		
Proposed Encased Well Length	60	ft		

Proposed Swale Capacity

	Top Area	Bot Area	Depth	Volume
	(Average FT)	(Average FT)	(FT)	(CF)
Swale B	34268.4	29139.6	1	31,704
Swale A	7995.5	5901.7	1.5	10,423
Total				42,127

Proposed Cistern Capacity

	Proposed Gallons		Volume (CF)
Cistern A	12096		1,617
Cistern B	12096		1,617
Total			3 23/1

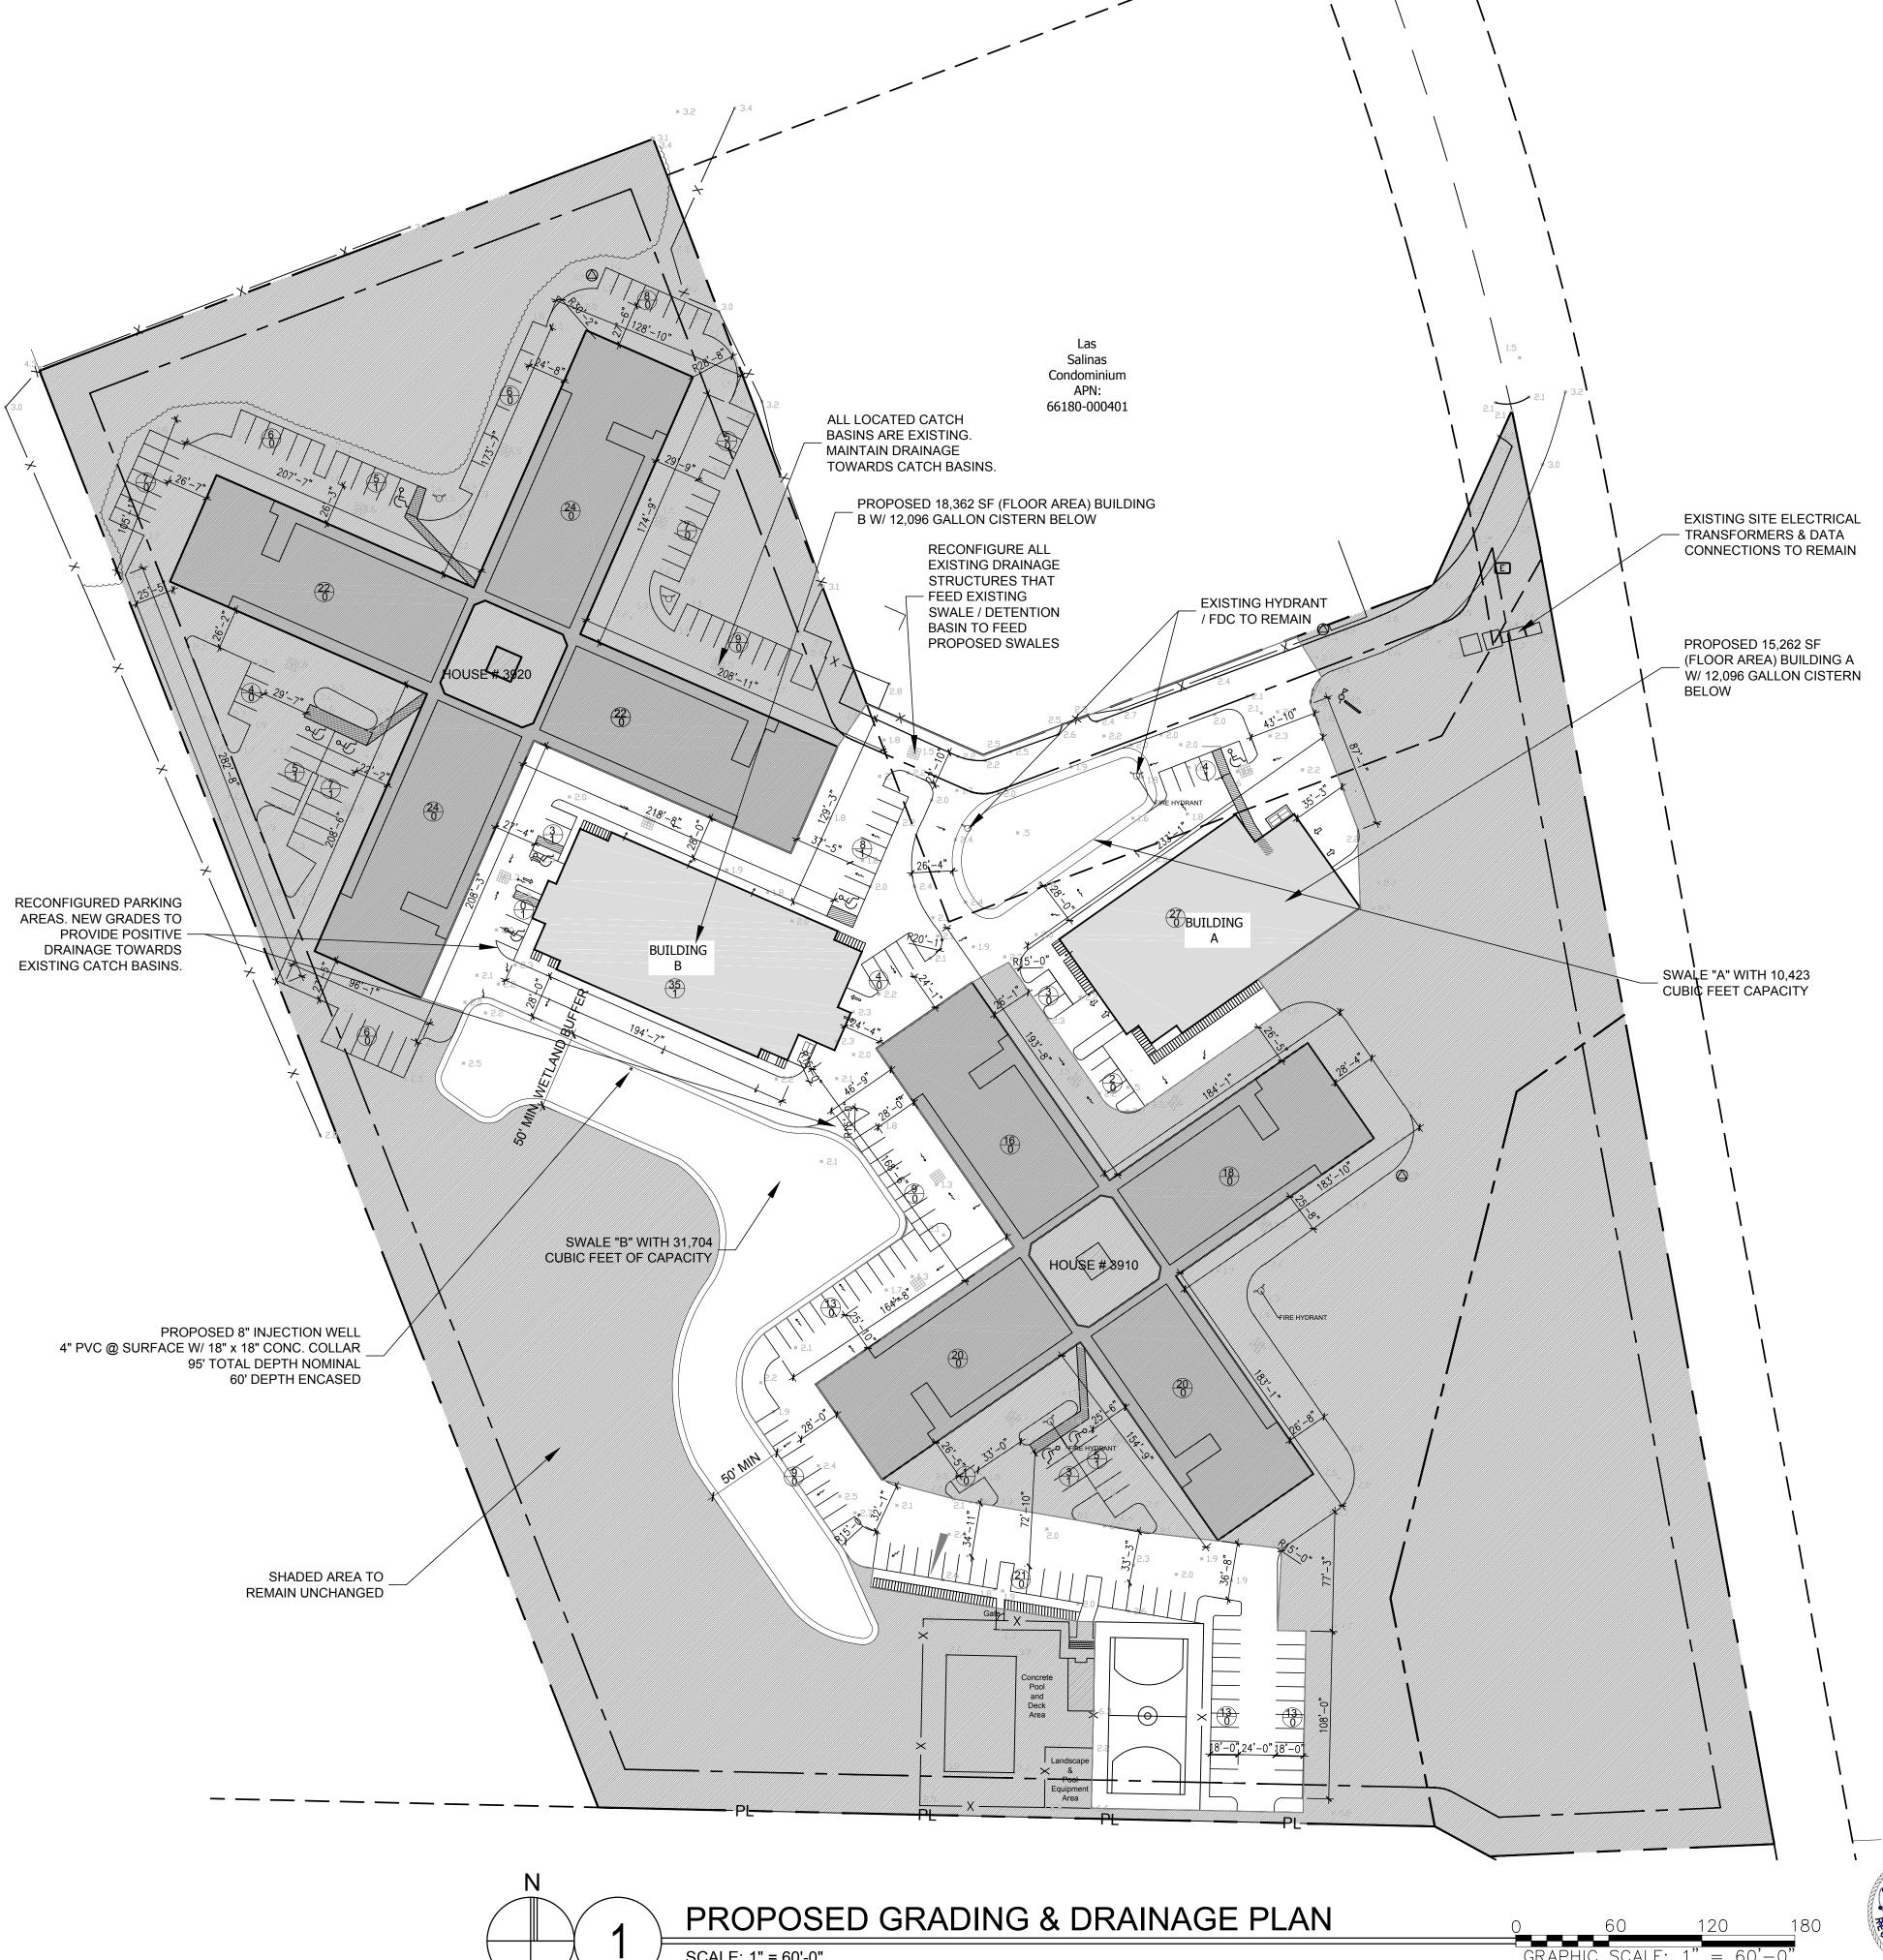







GENERAL LANDSCAPE NOTES:

AT LEAST 70% OF THE SPECIFIED SPECIES FOR REQUIRED MATERIAL WILL BE NATIVE AS STIPULATED IN THE


MINIMUM PLANT REQUIREMENT.

100% OF THE REQUIRED REPLACEMENT TREES SHALL BE NATIVE. REPLACEMENT TREES SHALL BE FIELD LOCATED AND STAFF SHALL BE PROVIDED WITH AN AS-BUILT PLAN LOCATING THEIR POSITIONS ON SITE.

100% IRRIGATION COVERAGE SHALL BE PROVIDED TO ALL PROPOSED PLANTING AREAS. SAID SYSTEM SHALL BE DESIGNED TO MAXIMIZE WATER CONSERVATION AND SHALL CONFORM TO SECTION 3-13.12 'C' OF THE CITY OF KEY WEST CODE. AS BUILT DRAWING REQUIRED.

ALL LARGE CANOPY AND RELOCATED TREES SHALL UTILIZE IRRIGATION BUBBLERS AT BASE OF TREE.

LANDSCAPE PLAN

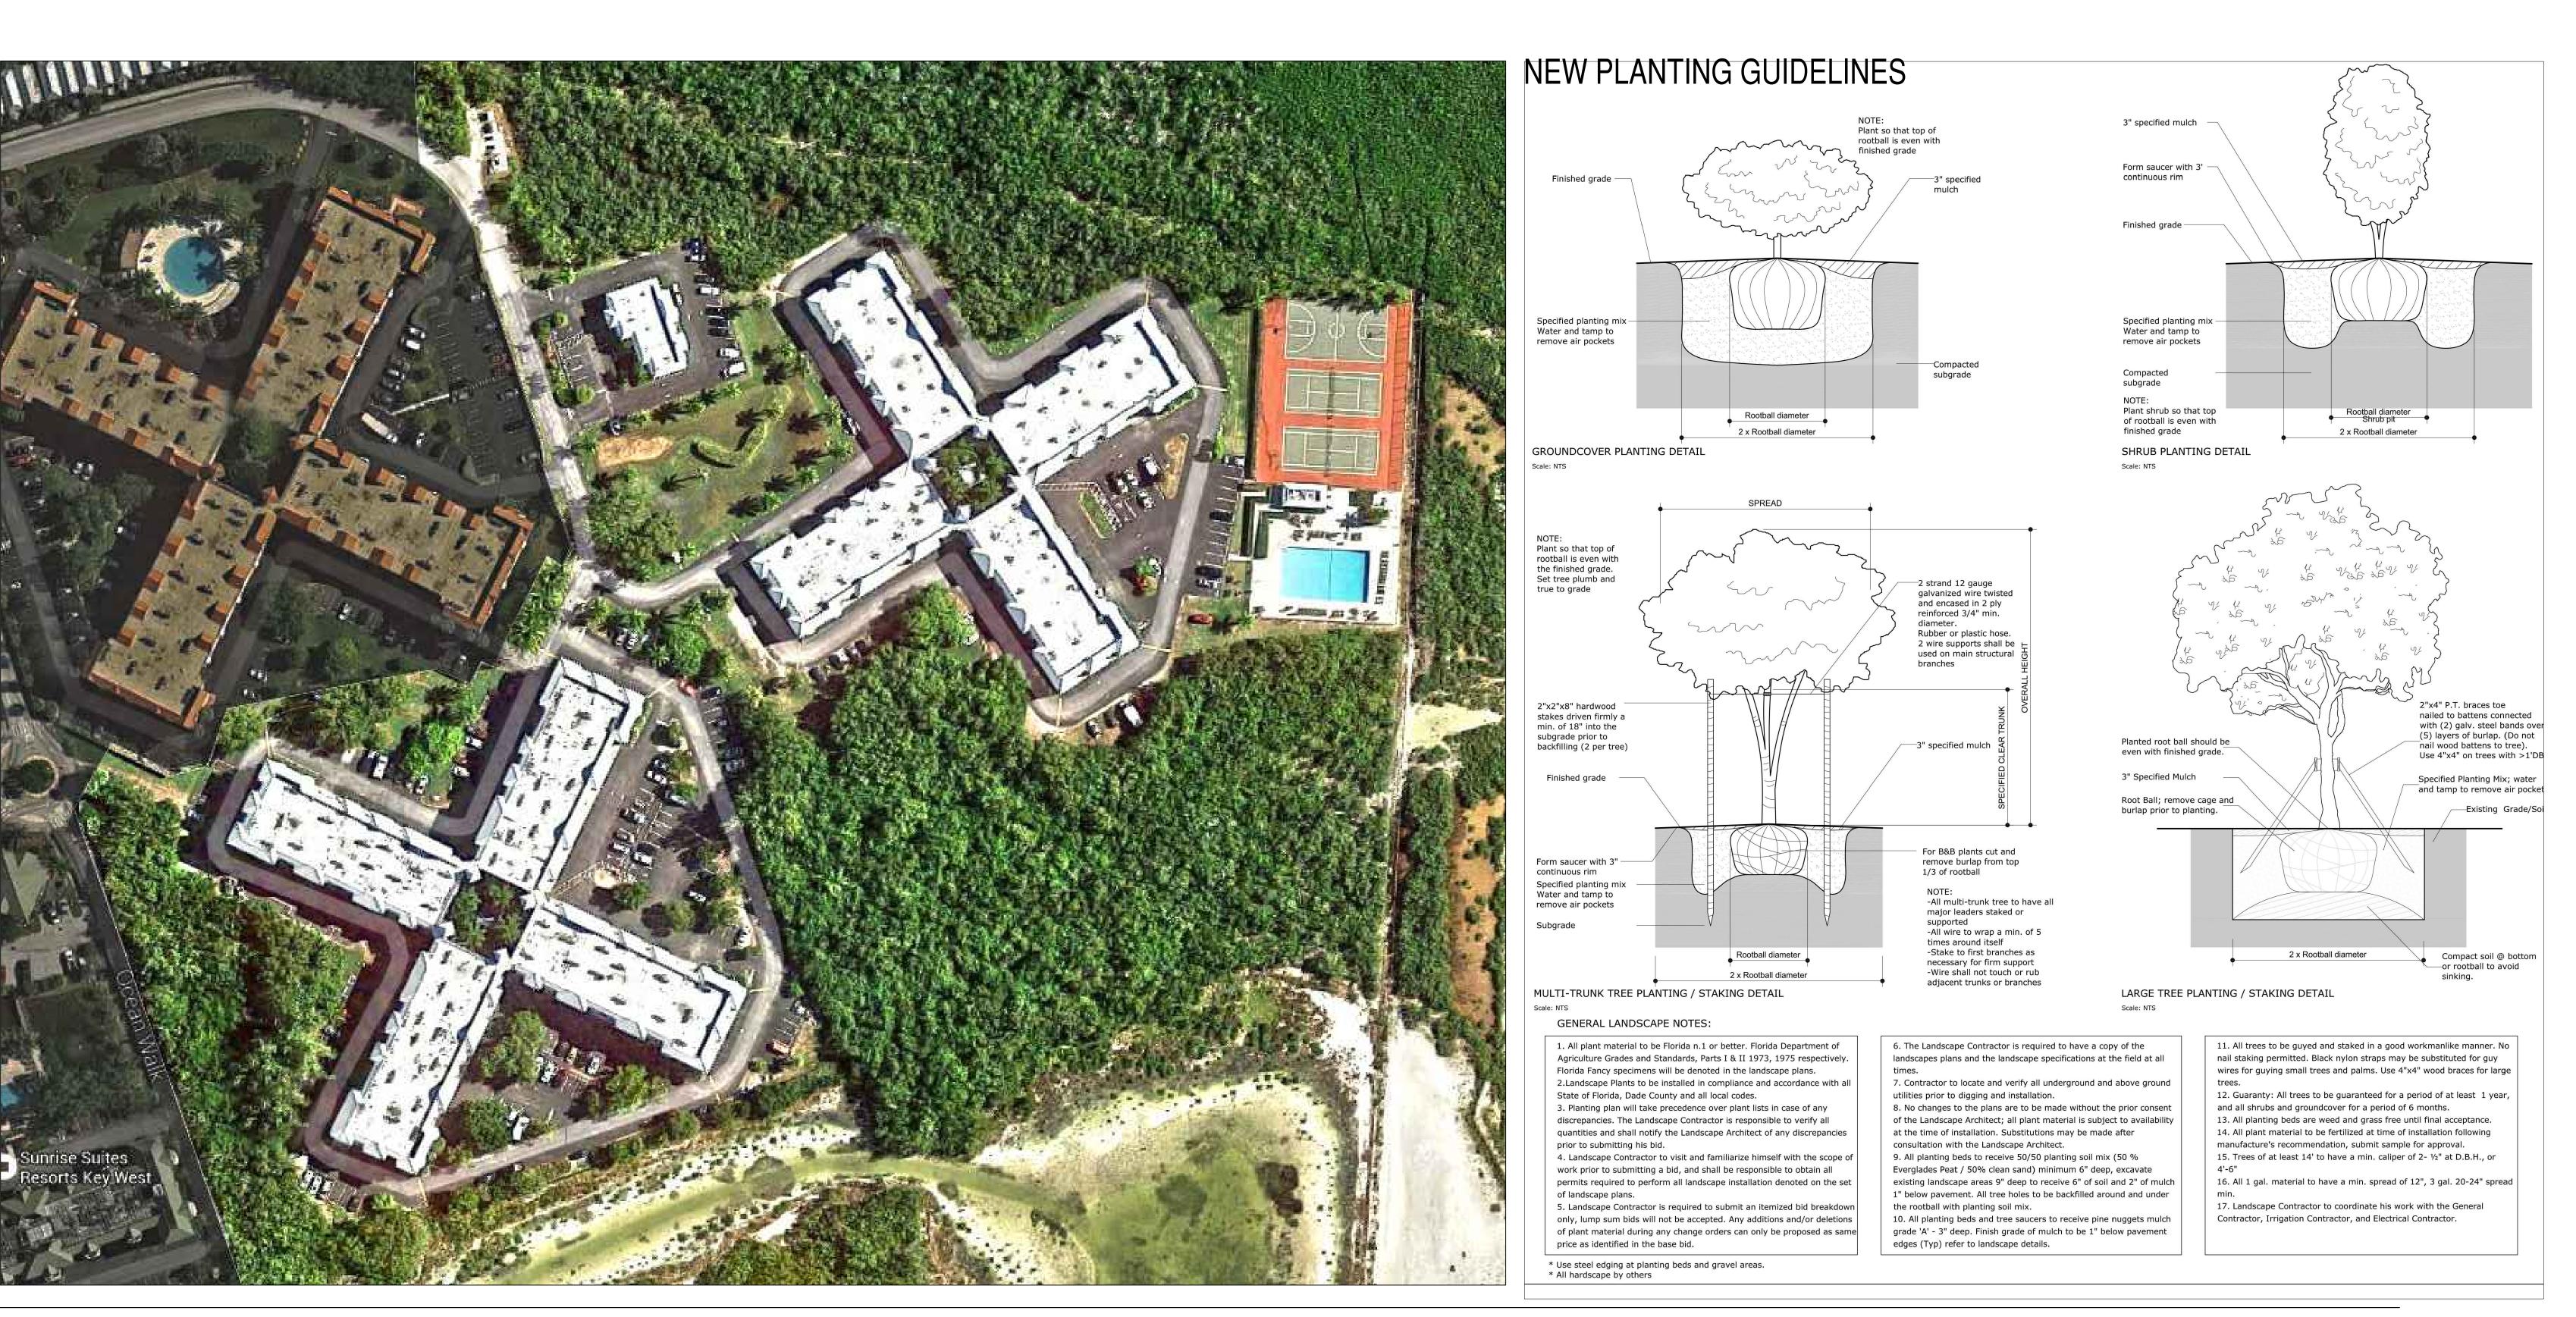

ISSUE FOR PERMIT + CONSTRUCTION

OCEAN WALK APARTMENTS

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OWNER / CLIENT

MAST CAPITAL

CASSIE RESNICK

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SUITE 505

MIAMI BEACH, FL 33139


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COVER PAGE



NORTH	SHEET NUMBER				
	L.000				
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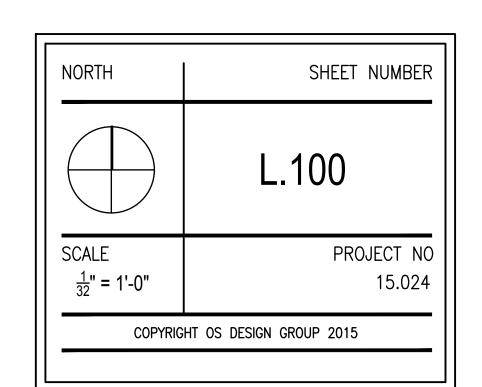
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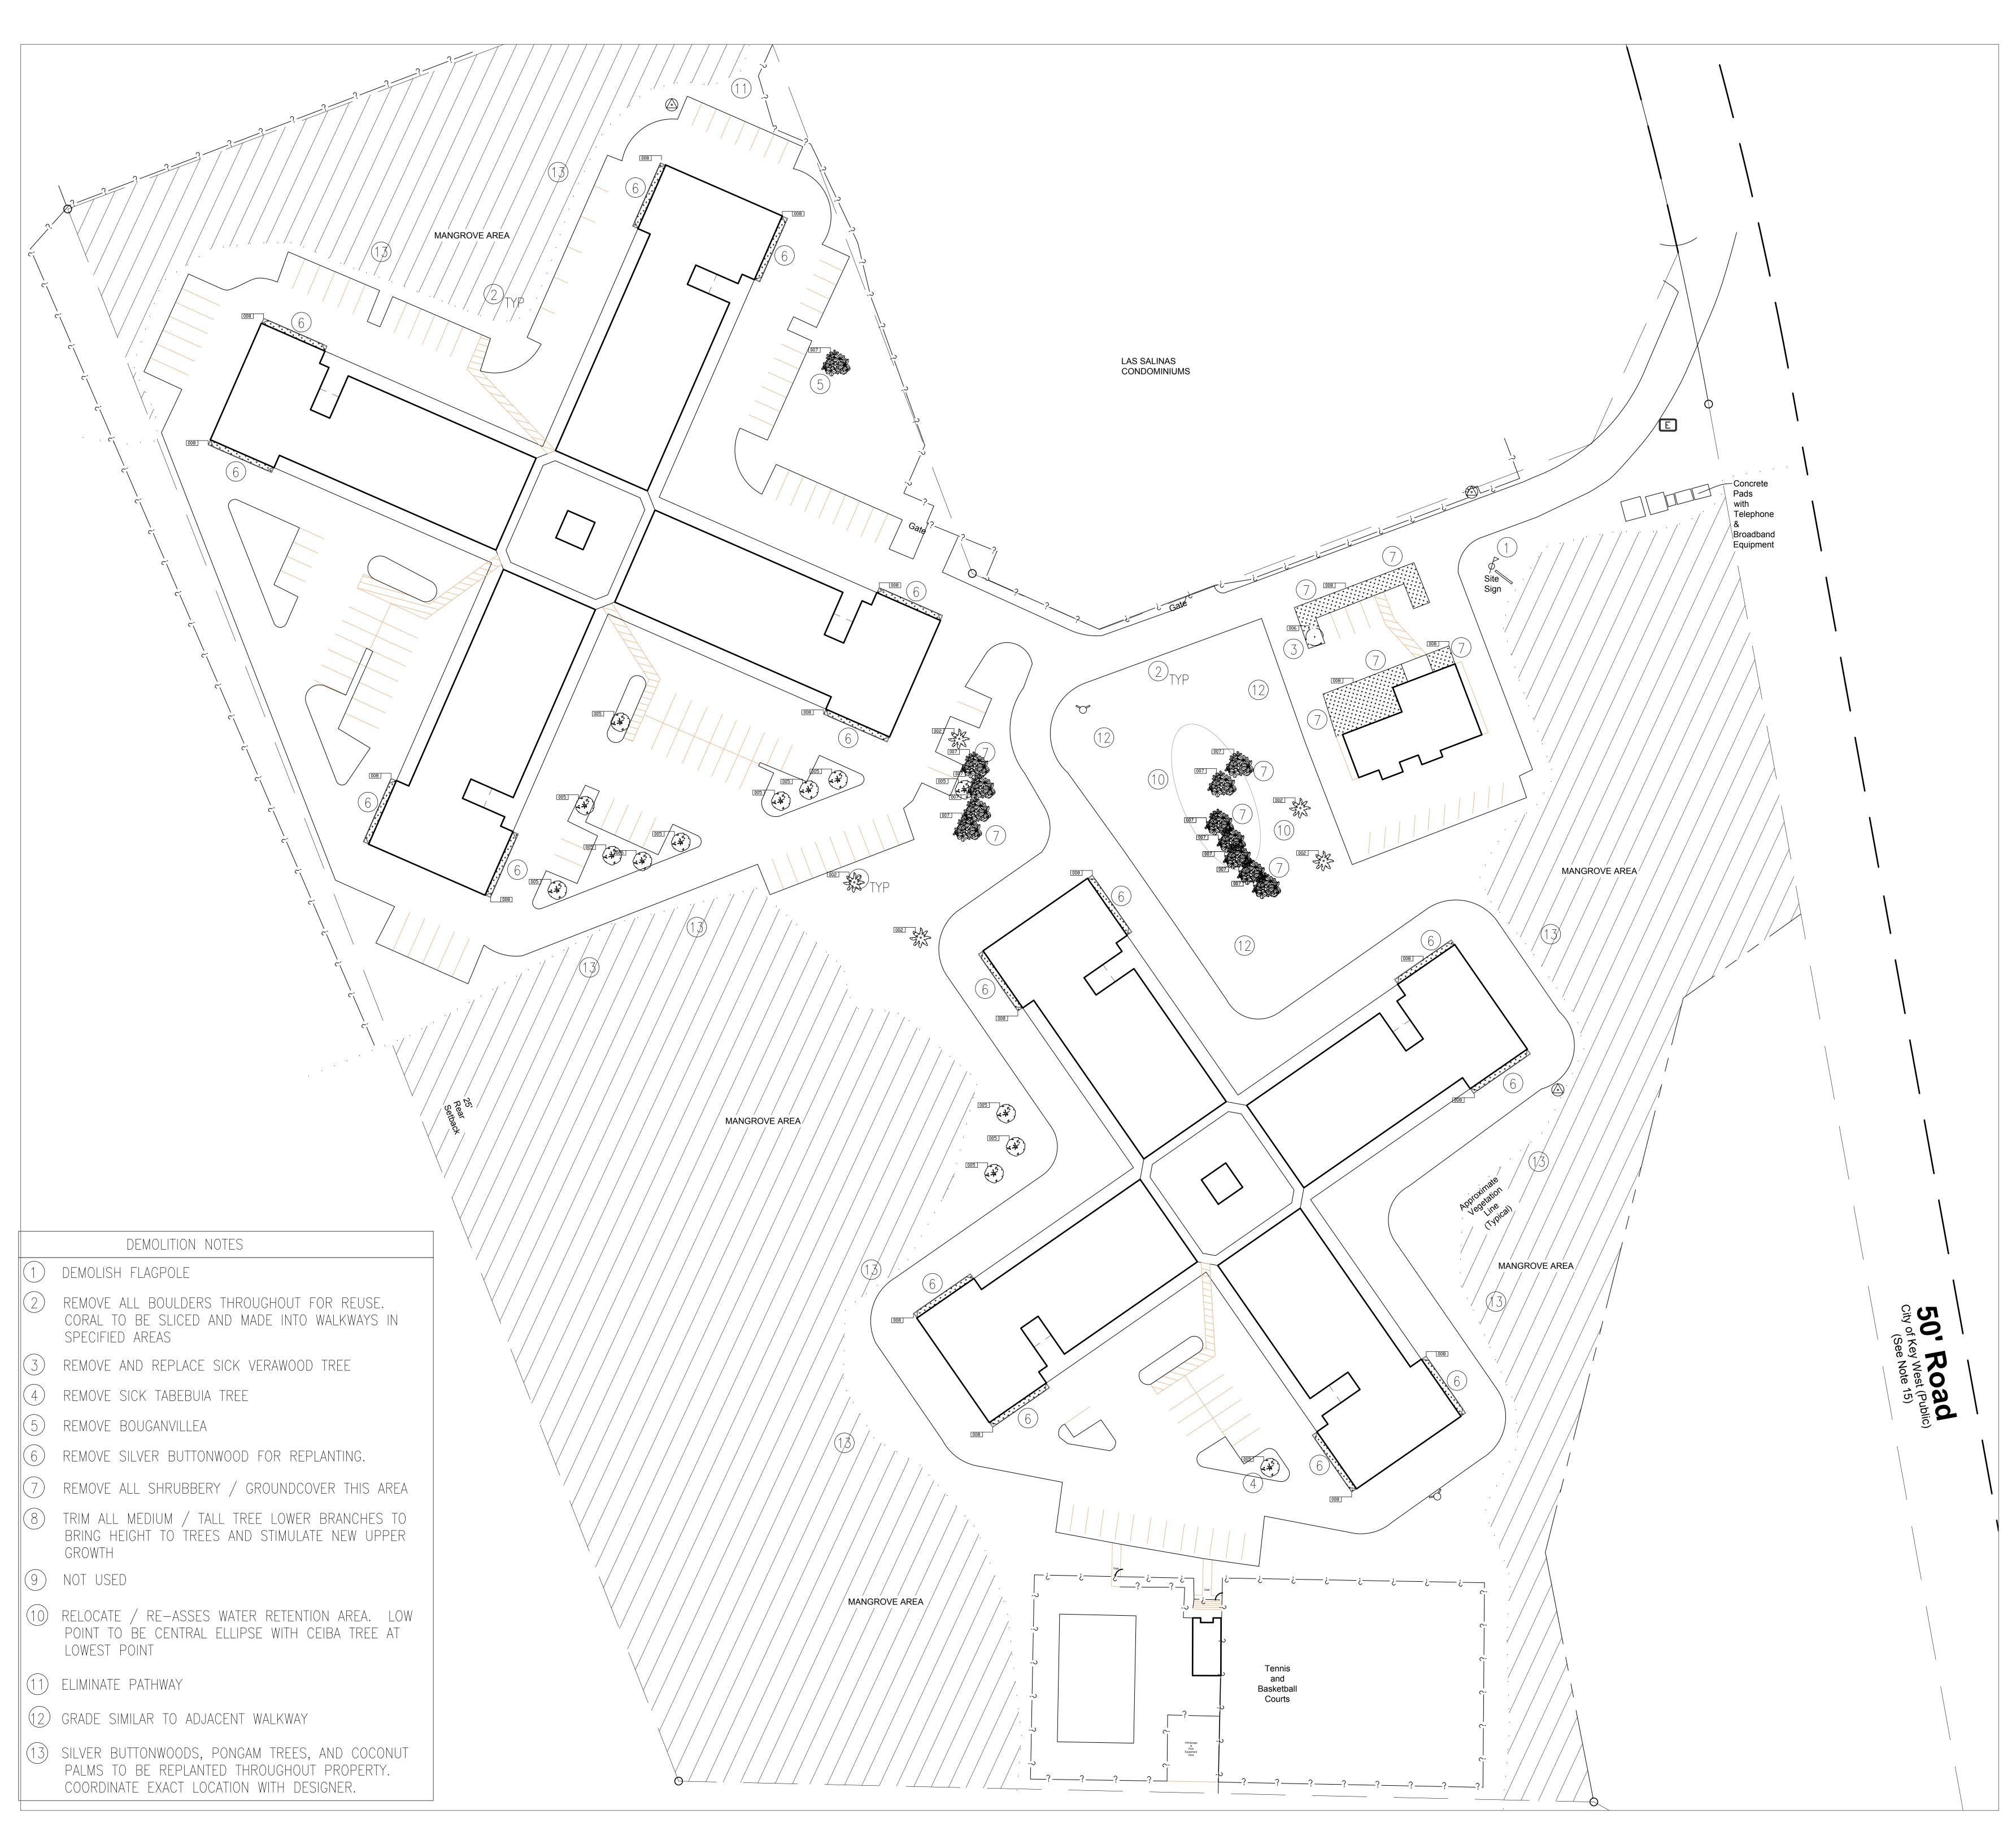
DRAWING TITLE

LANDSCAPE: EXISTING TREE PLAN

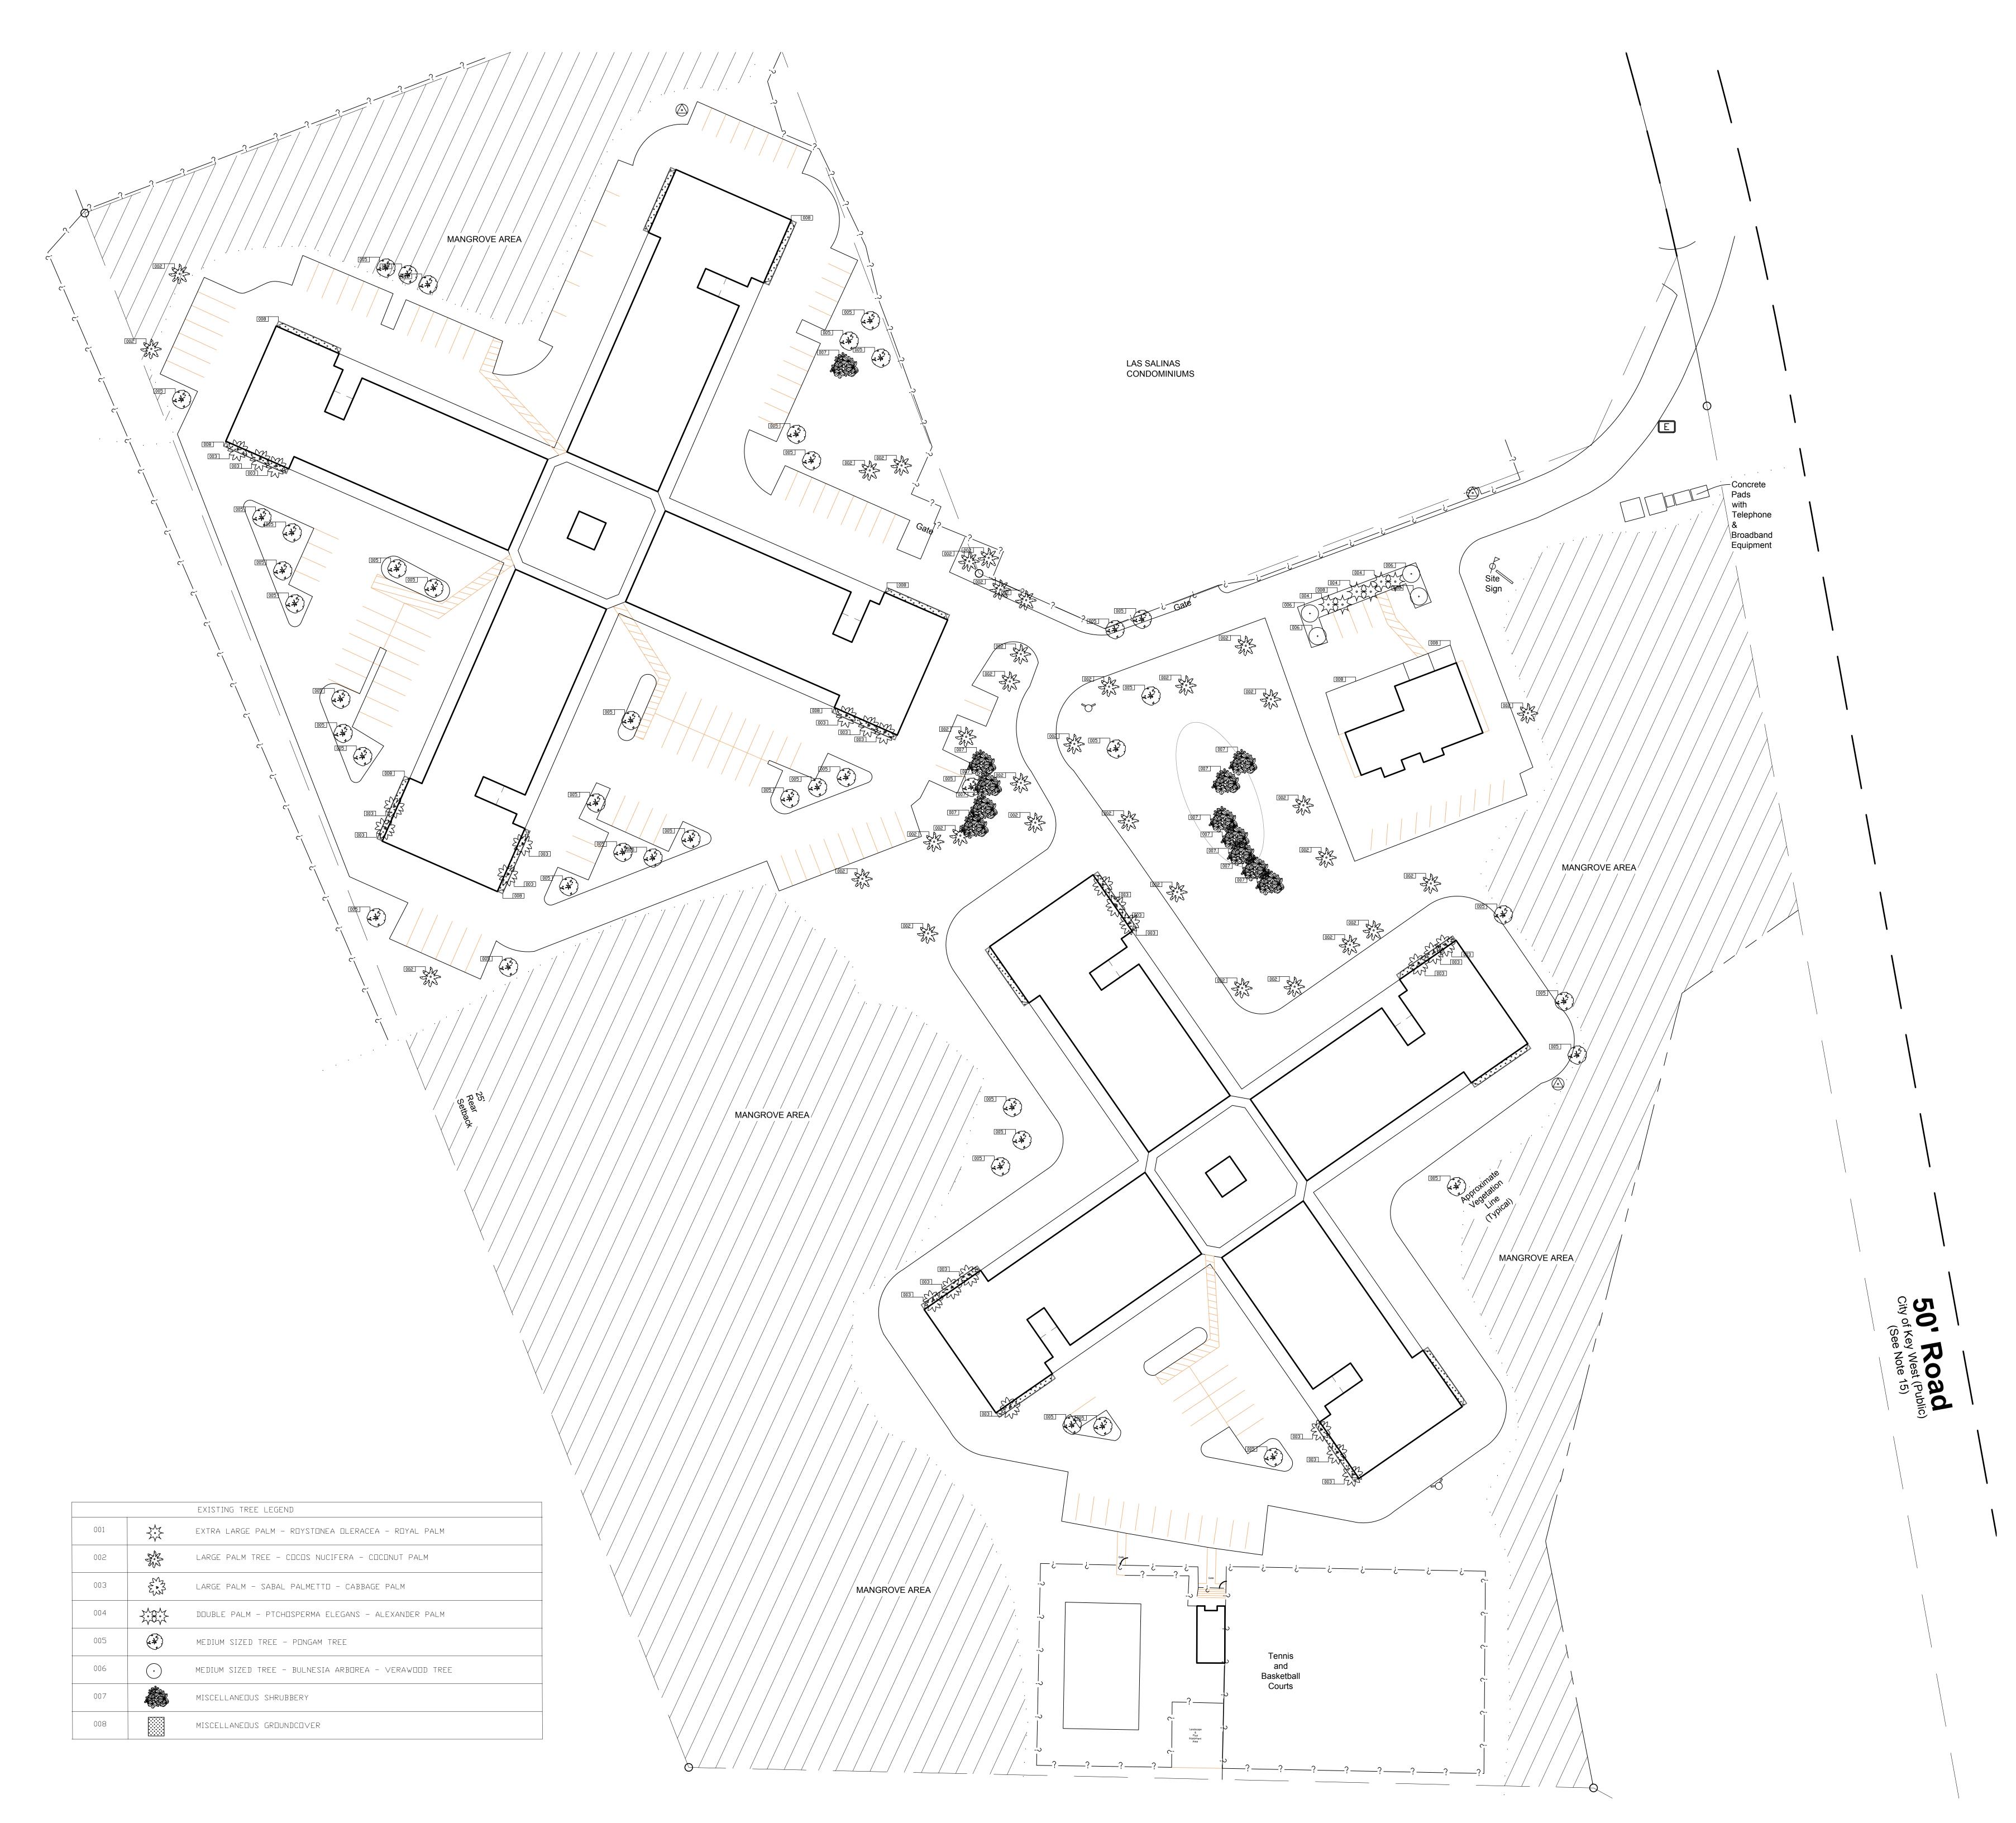

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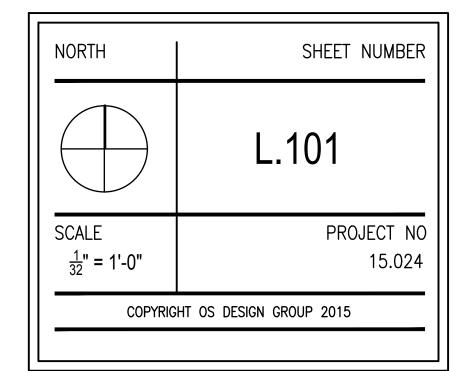
LANDSCAPE:
DEMOLITION PLAN




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LANDSCAPE: OVERALL PLANTING PLAN

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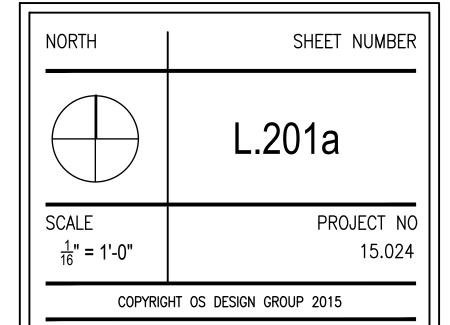
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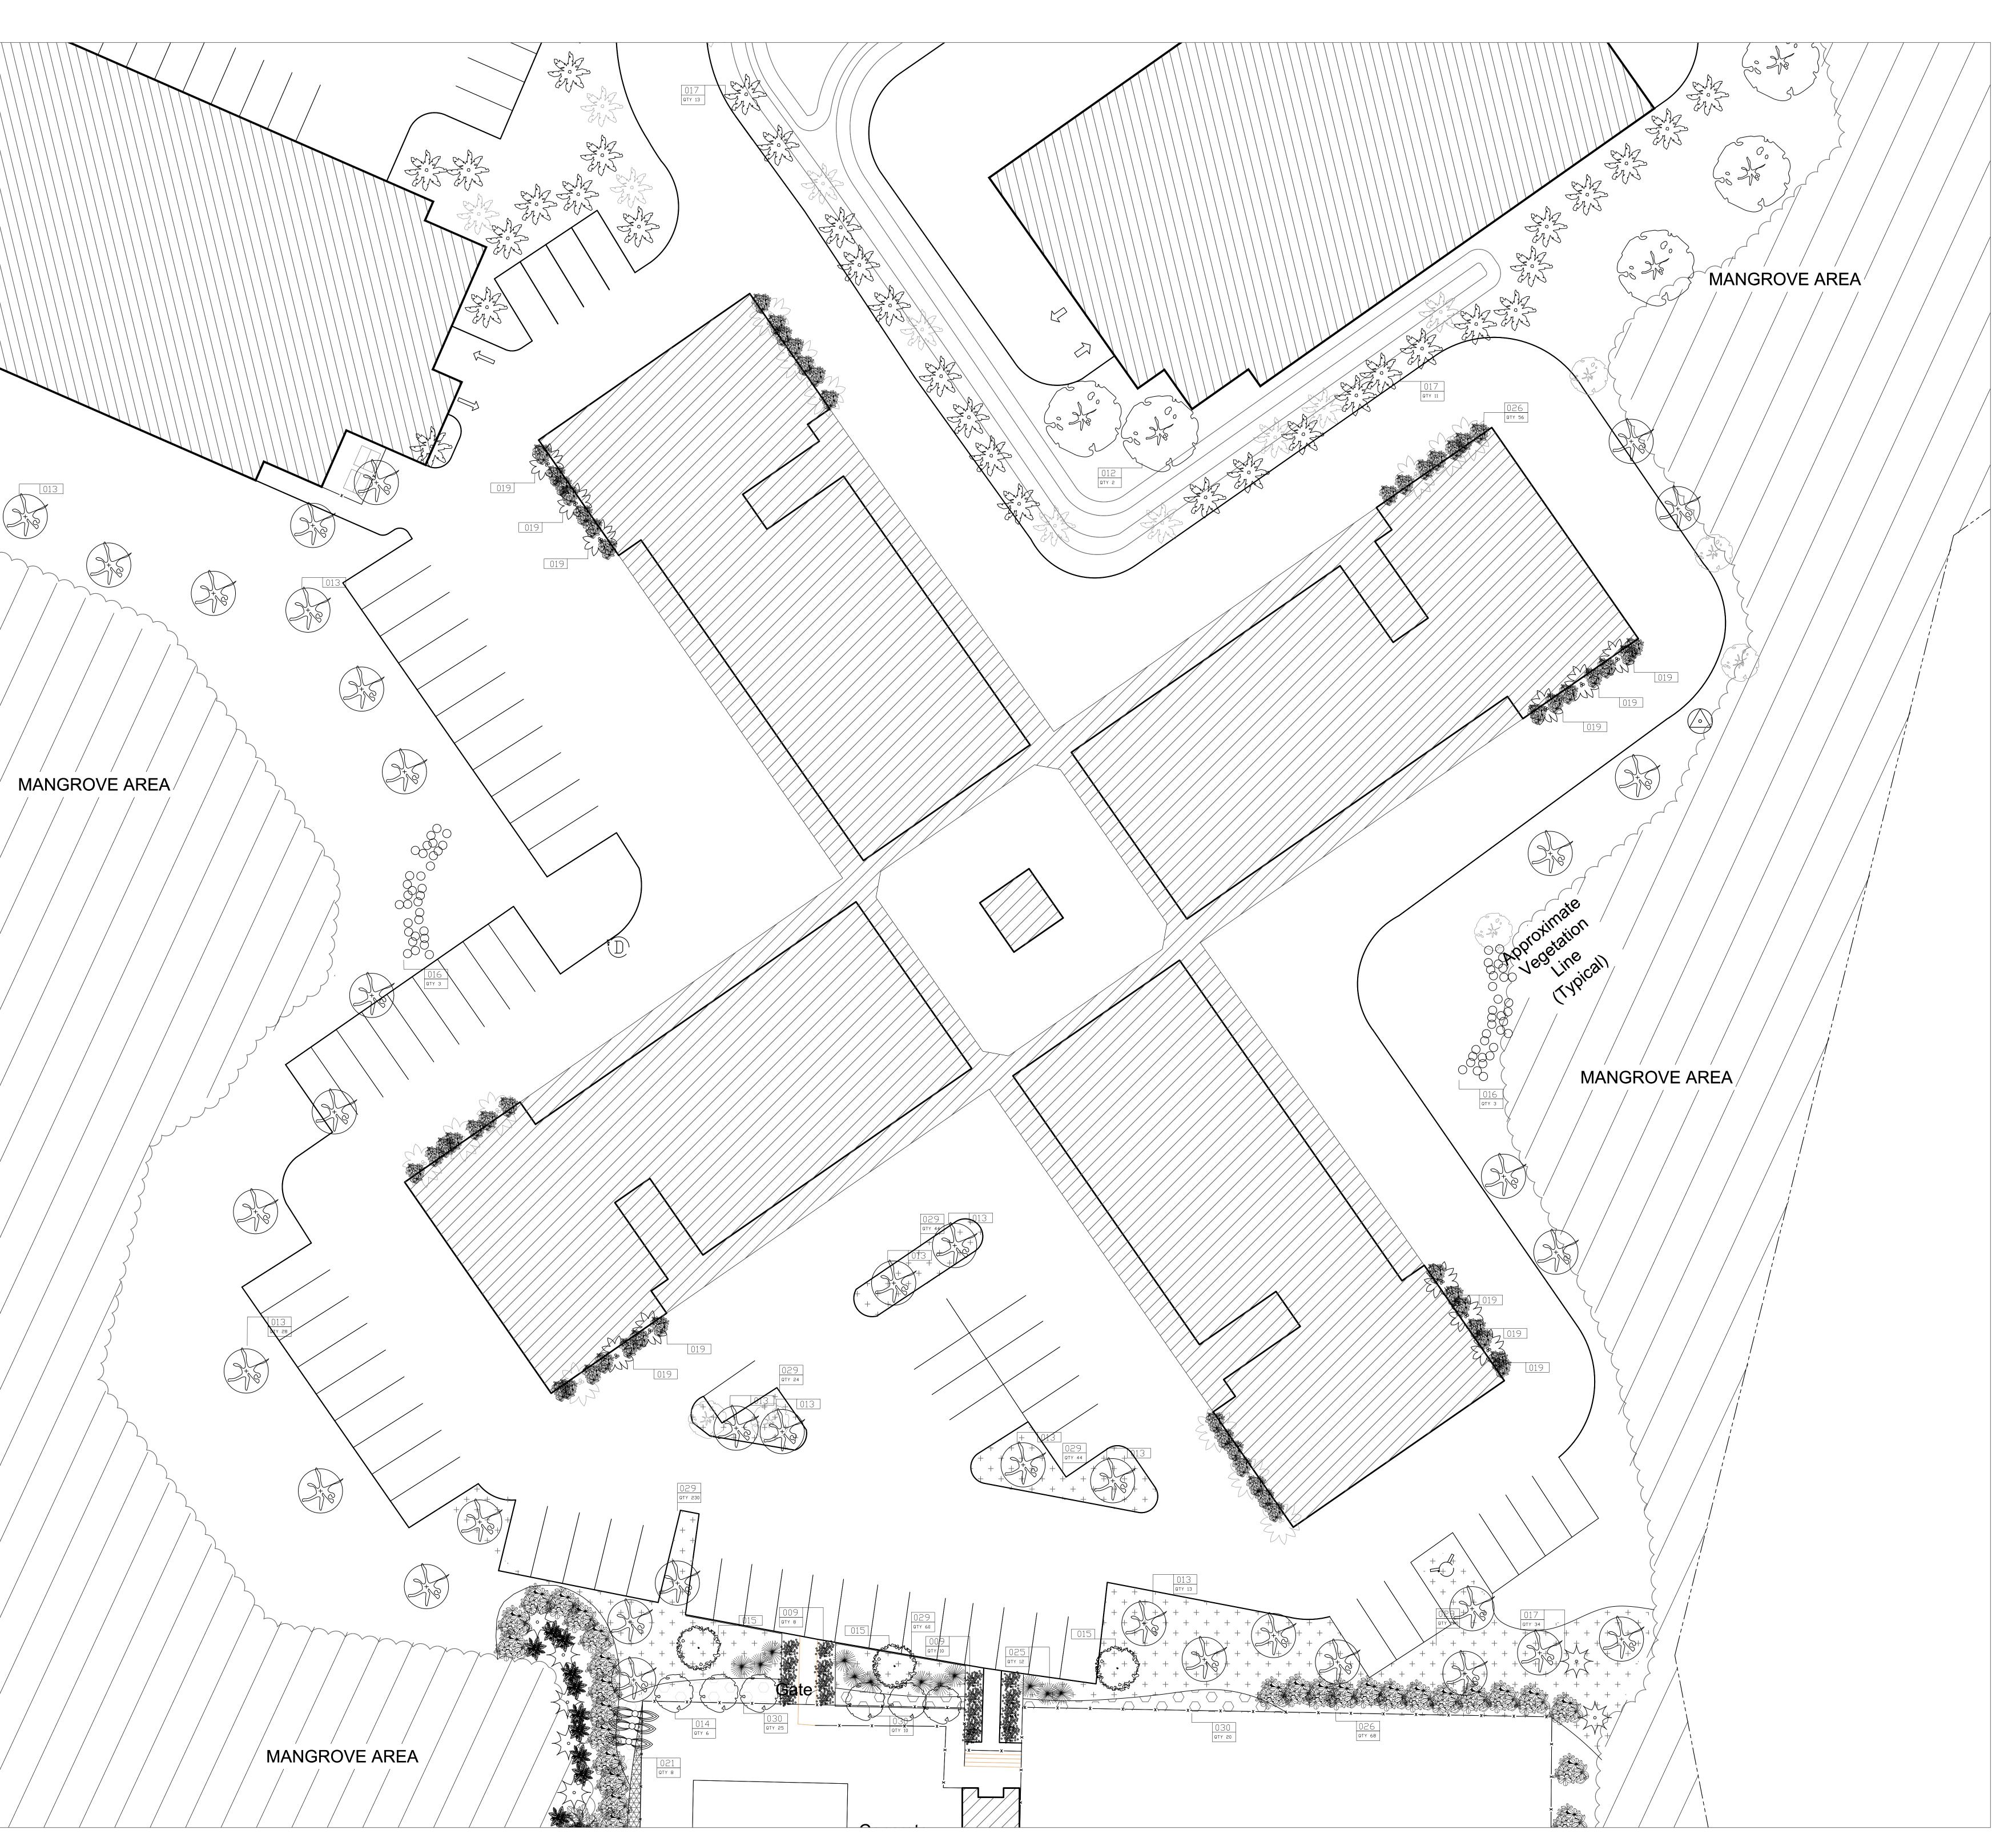
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ENLARGED LANDSCAPE: PLANTING PLAN A



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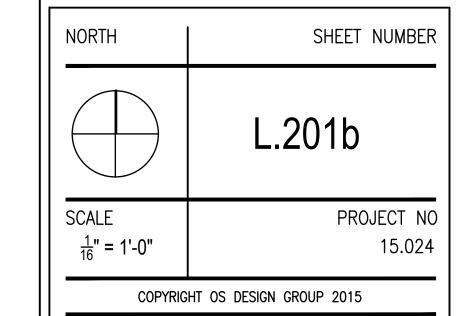
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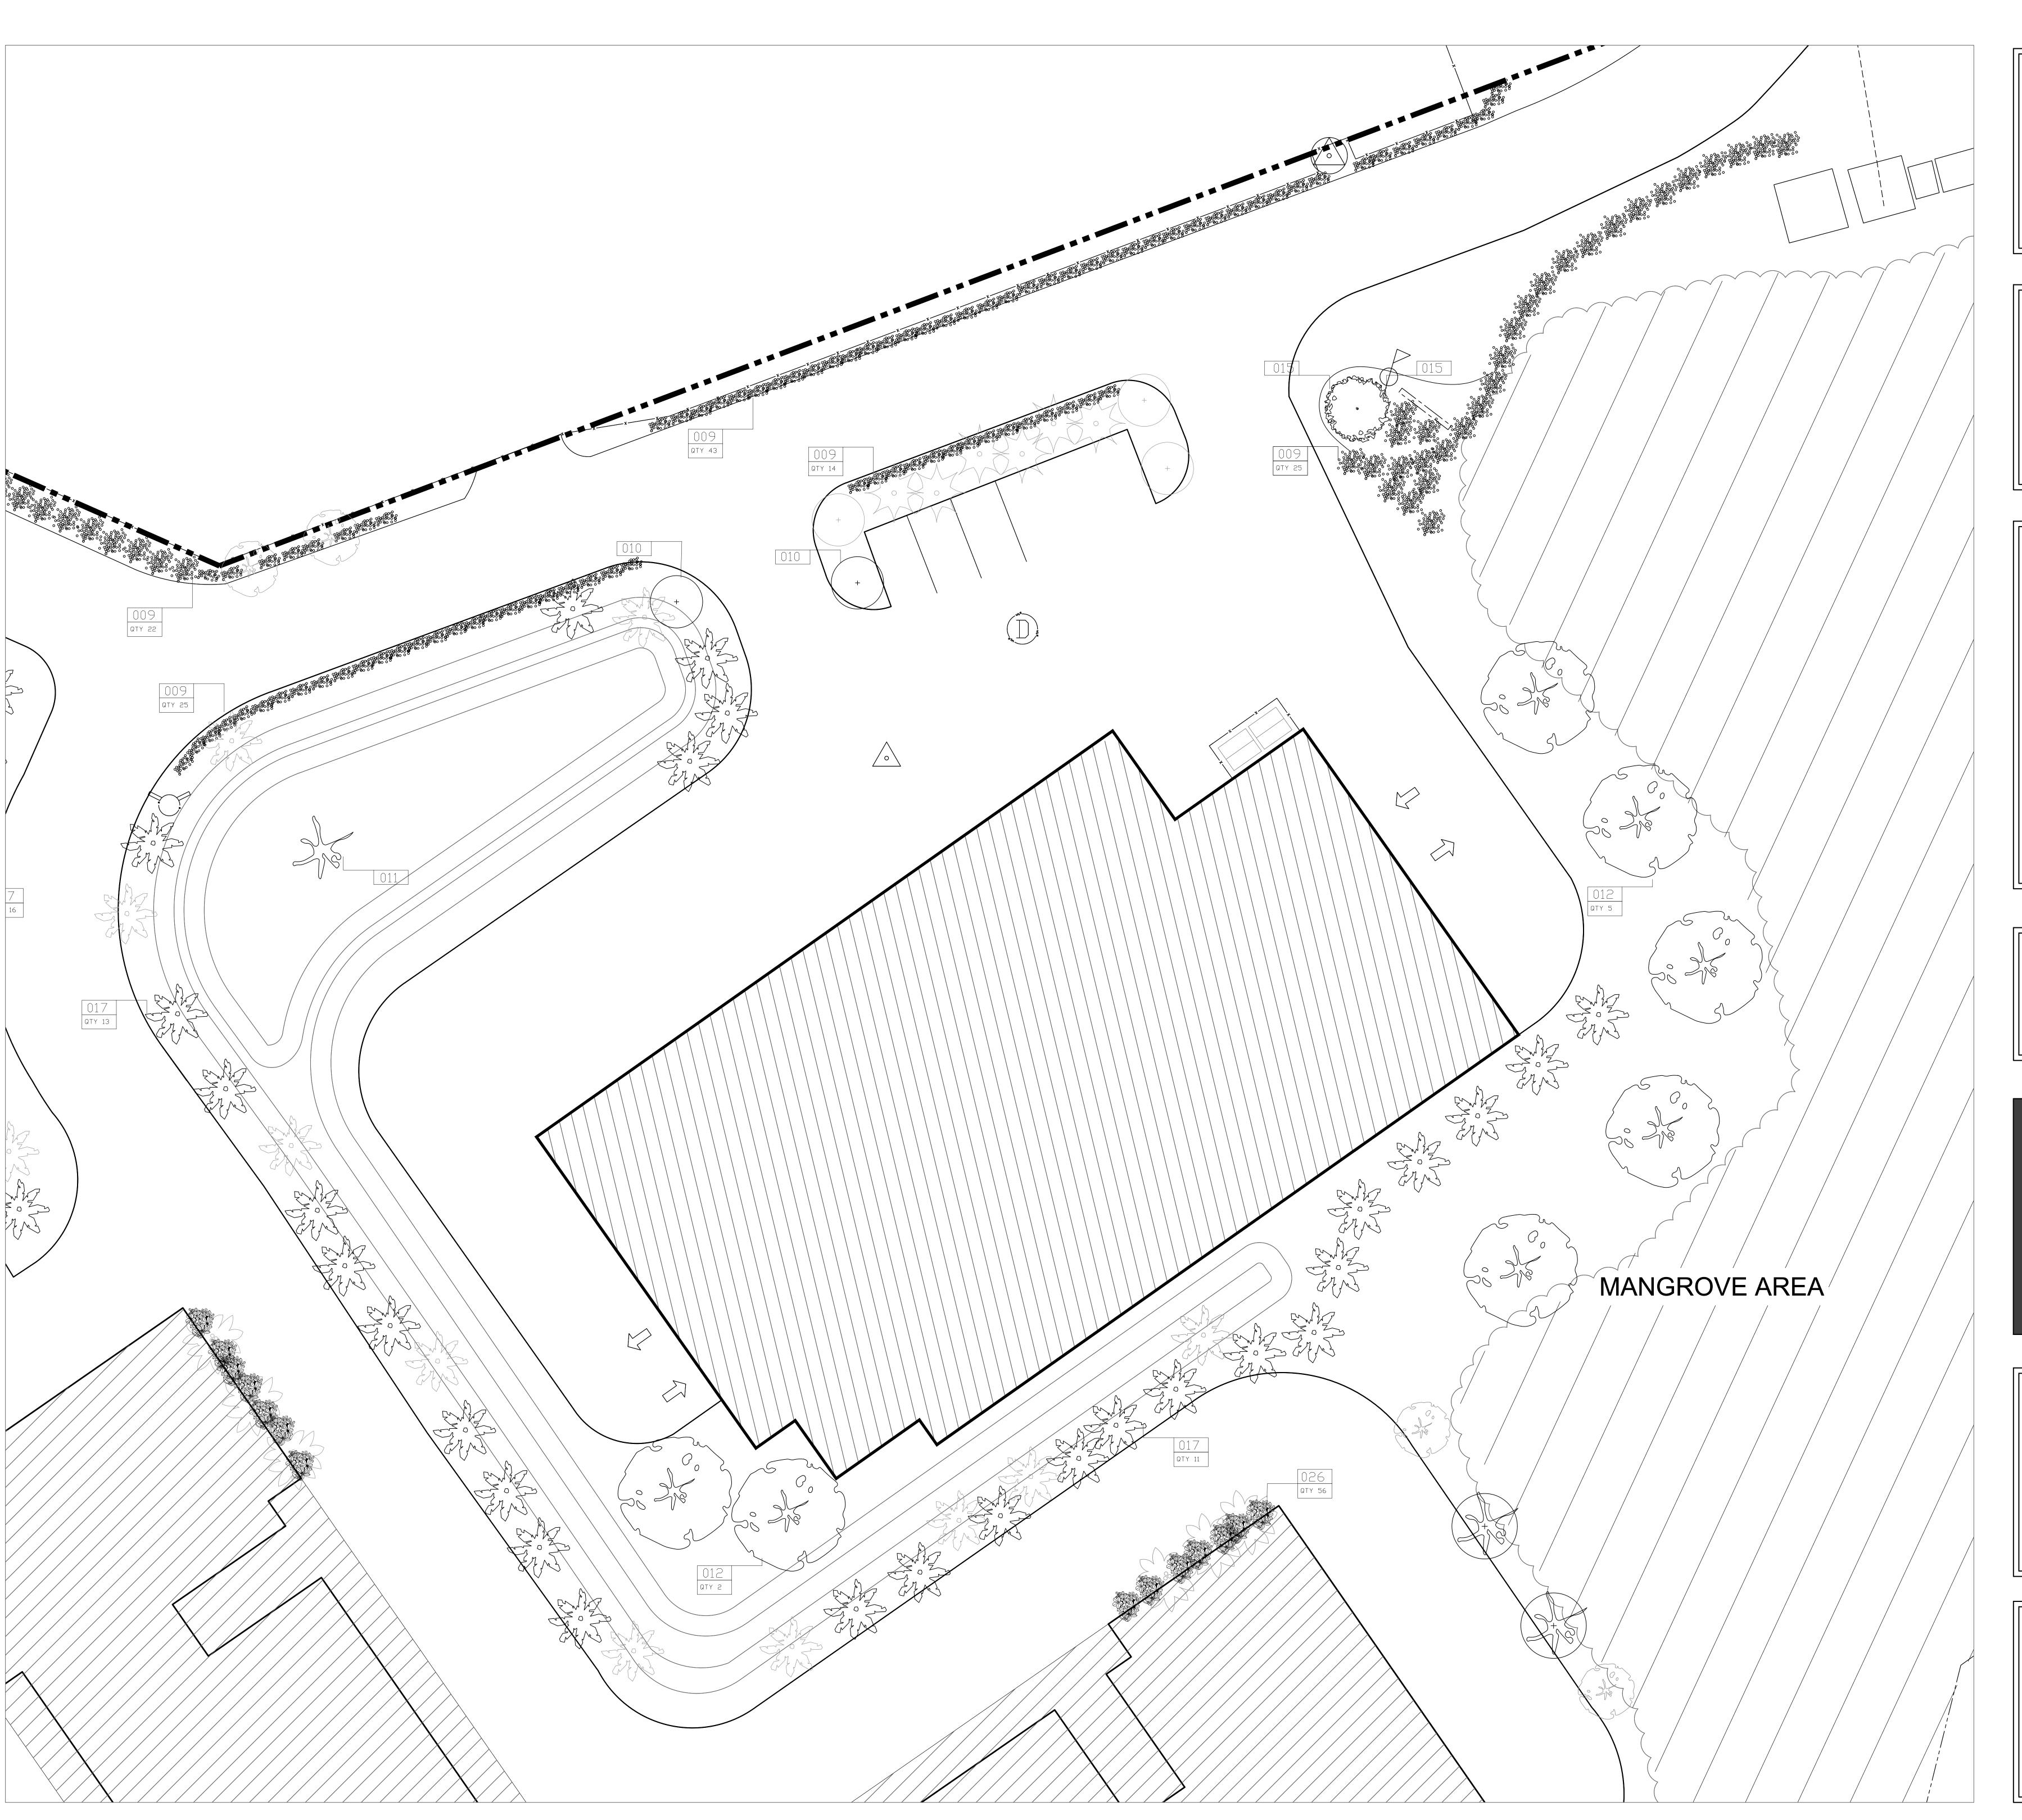
DRAWING TITLE

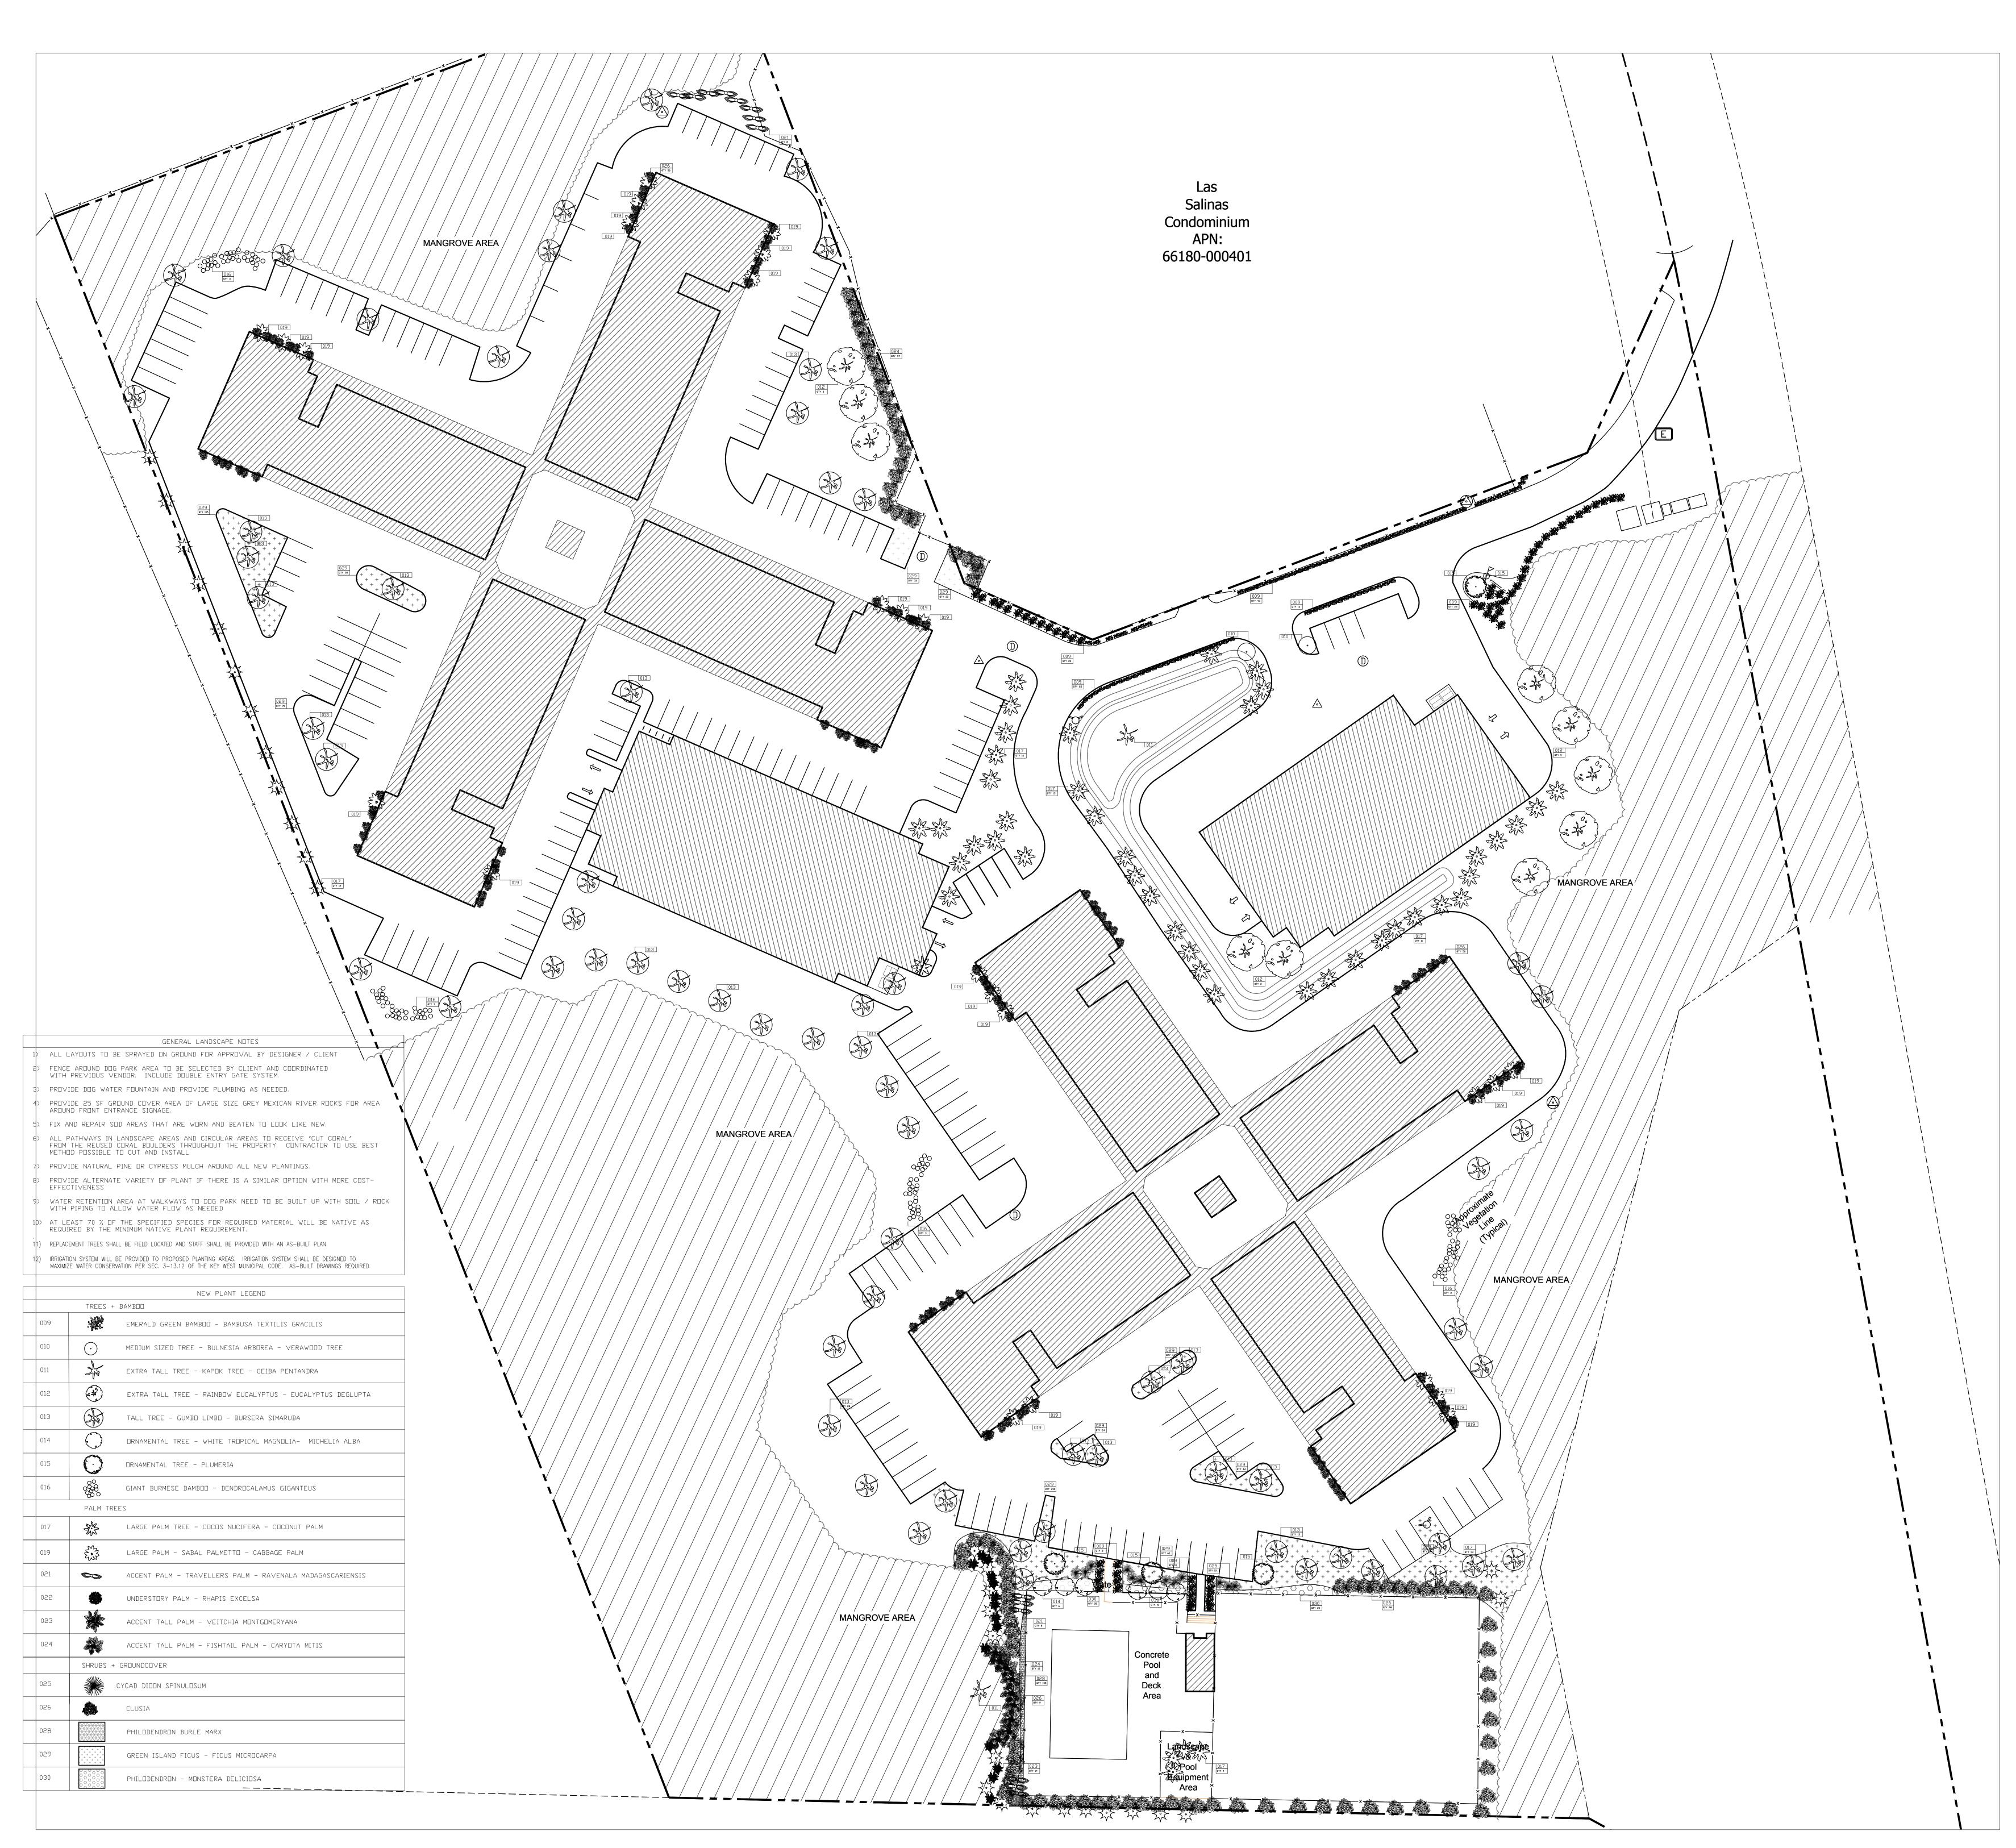ENLARGED LANDSCAPE: PLANTING PLAN B



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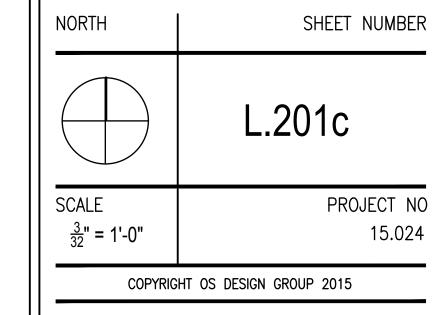
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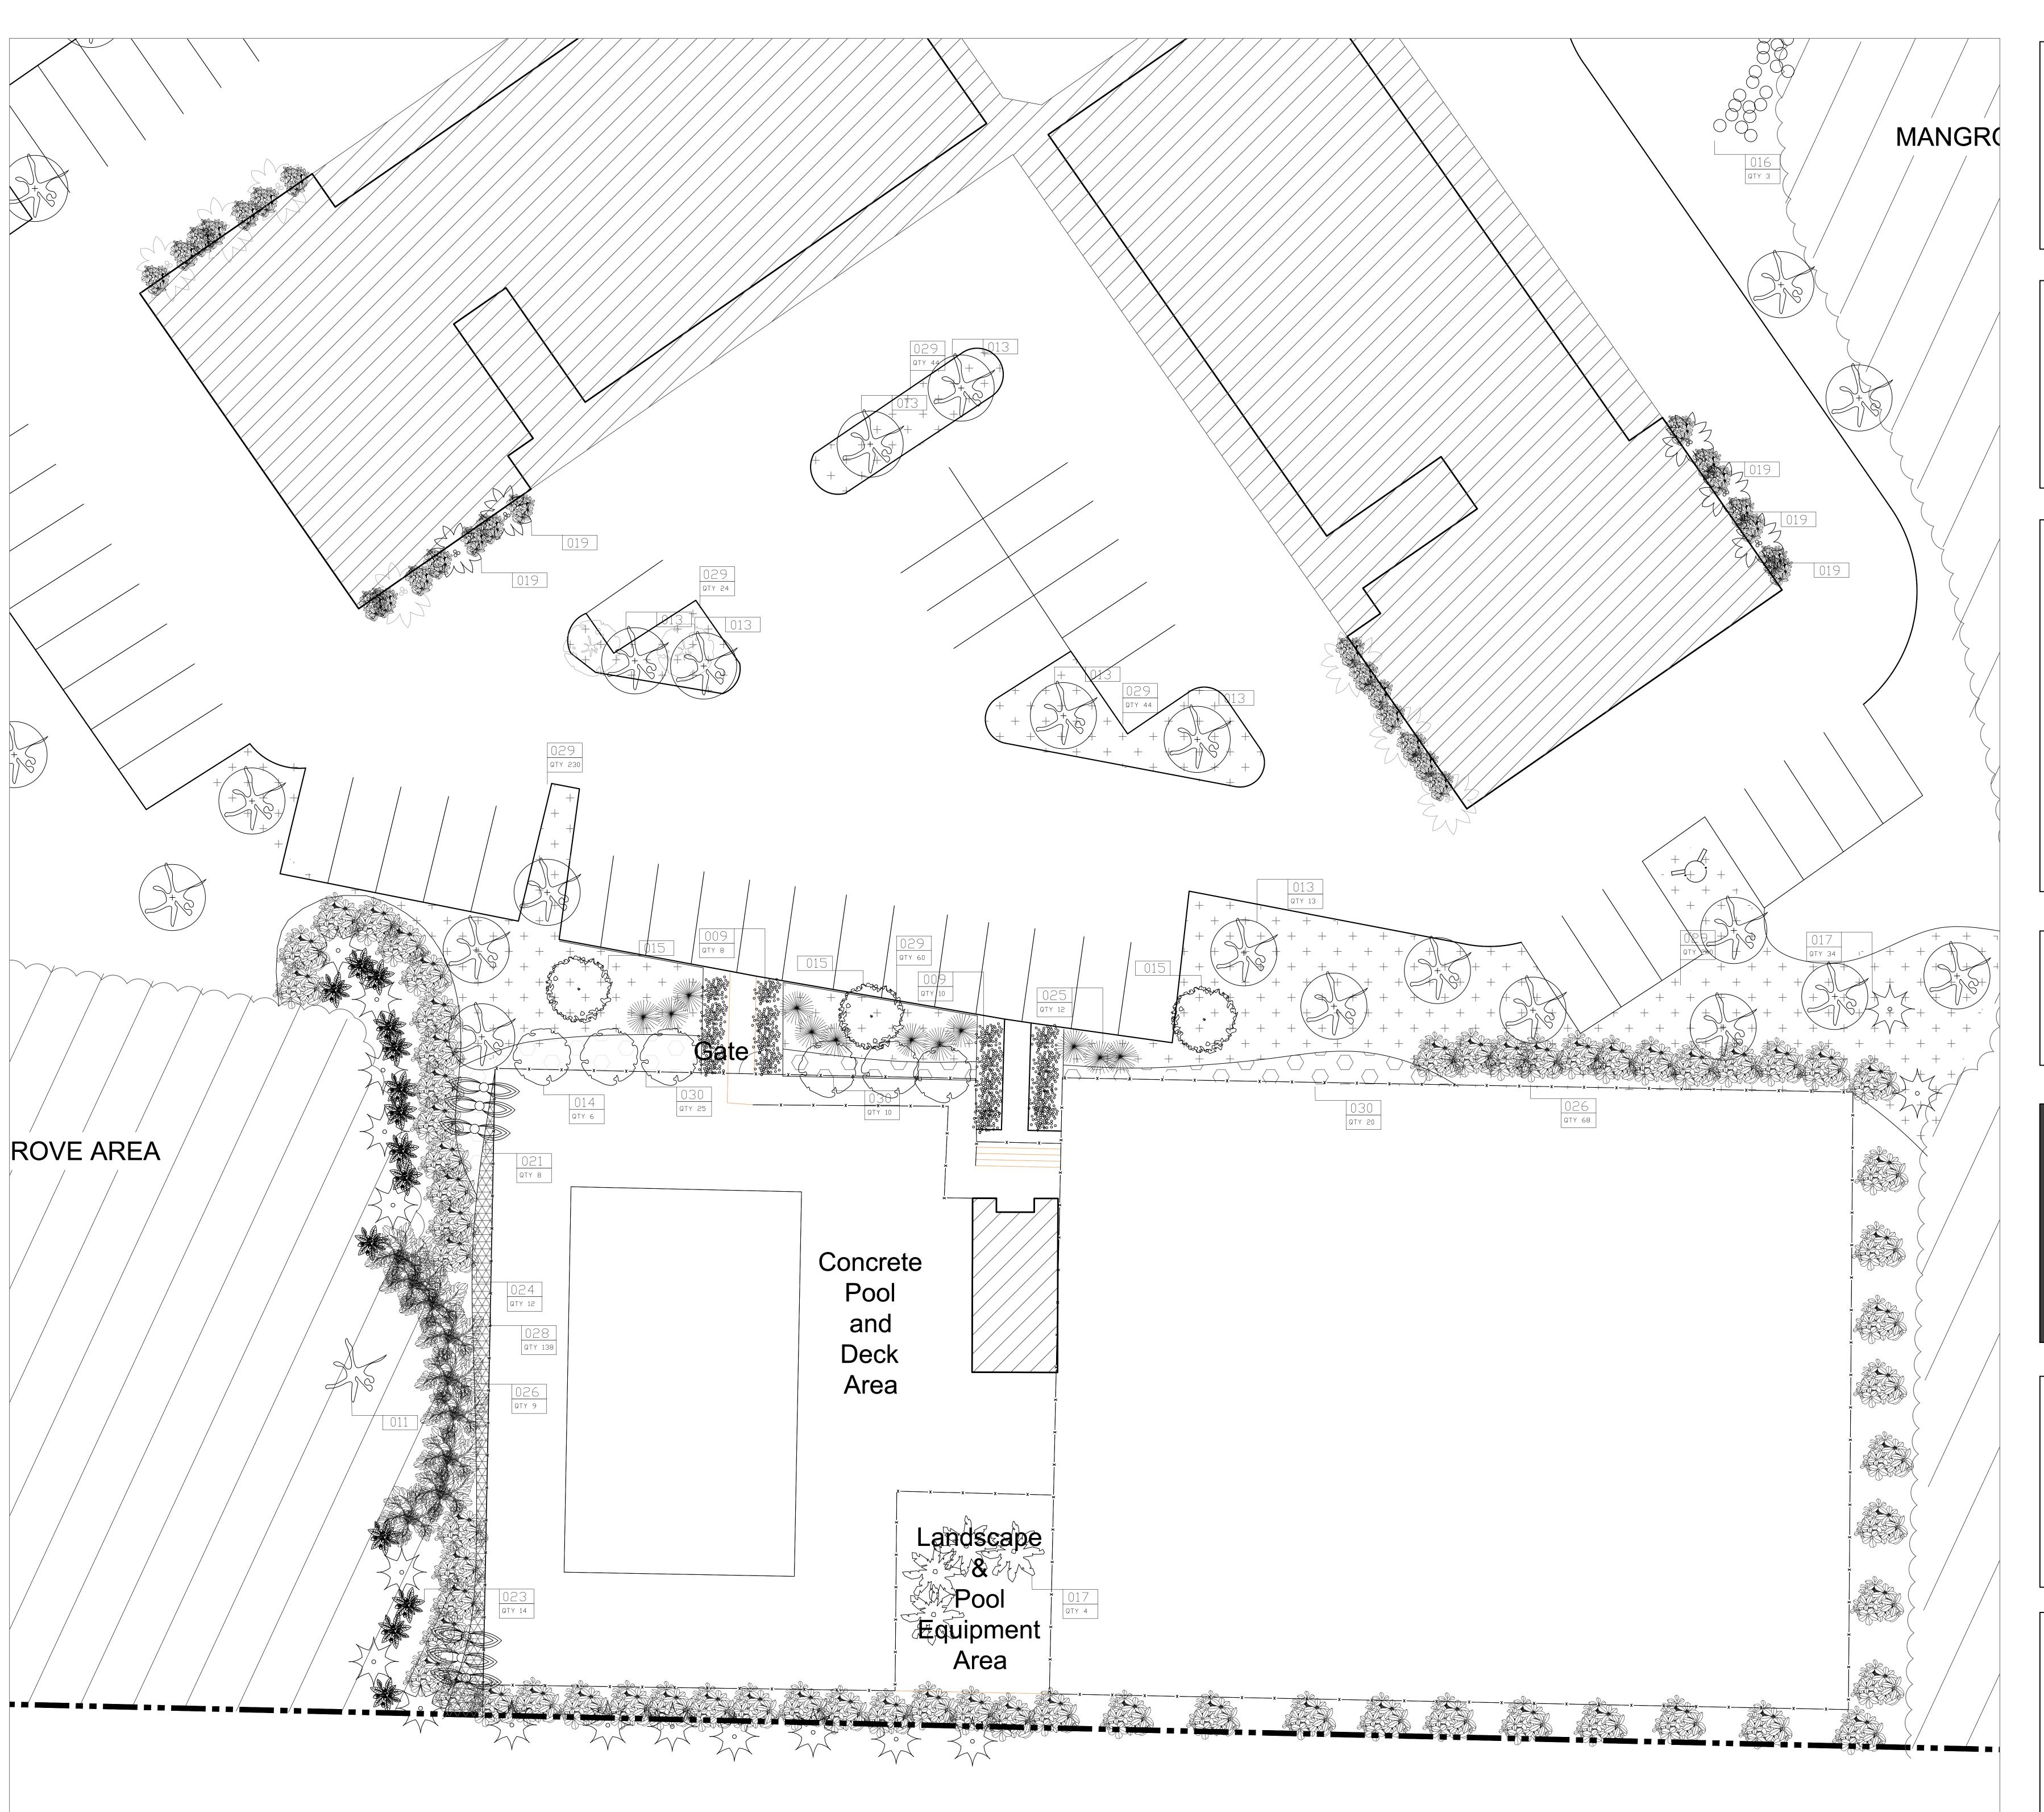
DRAWING TITLE

ENLARGED LANDSCAPE: PLANTING PLAN C



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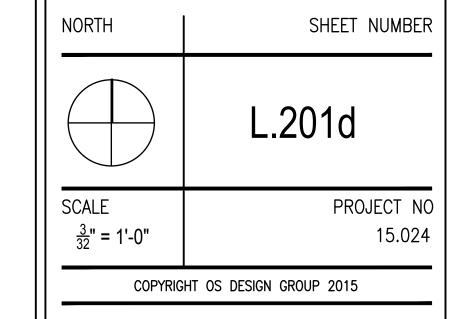
ENLARGED LANDSCAPE: PLANTING PLAN D



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GENERAL NOTES

- 1) AT LEAST 70 % OF THE SPECIFIED SPECIES FOR REQUIRED MATERIAL WILL BE NATIVE AS REQUIRED BY THE MINIMUM NATIVE PLANT REQUIREMENT.
- 2) REPLACEMENT TREES SHALL BE FIELD LOCATED AND STAFF SHALL BE PROVIDED WITH AN AS-BUILT PLAN.
- 3) IRRIGATION SYSTEM WILL BE PROVIDED TO PROPOSED PLANTING AREAS. IRRIGATION SYSTEM SHALL BE DESIGNED TO MAXIMIZE WATER CONSERVATION PER SEC. 3—13.12 OF THE KEY WEST MUNICIPAL CODE. AS—BUILT DRAWINGS REQUIRED.
- 4) EXISTING CALIPER INCH TO REMAIN.
- 5) ALL PLANTS RELOCATED AND REMOVED COCUNT PALMS, PONGAM TREES, AND SILVER BUTTONWOOD TO BE RELOCATED ON SITE.
 TEAM TO BE ON SITE FOR COORDINATION OF NEW LOCATION OF RELOCATED PLANTS.

		NEW PLANT LEGEND	QTY	SIZE.	NATIVE/END.
	TREES -	+ BAMBOO			
009	0 8 90 0 0 8 9 0 0 8 9 0 0 8 9 0 0 9 0 0 0 0 0 0 0 0 0 0 0 0 0 0 0 0	EMERALD GREEN BAMBOO - BAMBUSA TEXTILIS GRACILIS	147	15 GAL. MIN HT 12'	
010	\odot	MEDIUM SIZED TREE - BULNESIA ARBOREA - VERAWOOD TREE	2	15 GAL. MIN HT 12'	
011	S.F.	EXTRA TALL TREE - KAPOK TREE - CEIBA PENTANDRA	1	15 GAL. MIN HT 12'	
012		EXTRA TALL TREE - RAINBOW EUCALYPTUS - EUCALYPTUS DEGLUPTA	10	15 GAL. MIN HT 12'	
013	STE STE	TALL TREE - GUMBO LIMBO - BURSERA SIMARUBA	63	15 GAL. MIN HT 12'	NATIVE
014		ORNAMENTAL TREE - LIGNUM VITAE	6	15 GAL. MIN HT 12'	ENDANGERED
015		DRNAMENTAL TREE - PLUMERIA	5	15 GAL. MIN HT 12'	NATIVE
016	00 008 000	GIANT BURMESE BAMBOO - DENDROCALAMUS GIGANTEUS	15	15 GAL. MIN HT 12'	
	PALM TR	EES			
017	Jun	LARGE PALM TREE - COCOS NUCIFERA - COCONUT PALM	58	15 GAL. MIN HT 6'	NATIVE
019	E**3	LARGE PALM - SABAL PALMETTO - CABBAGE PALM	25	15 GAL, MIN HT 6'	NATIVE
021		ACCENT PALM - TRAVELLERS PALM - RAVENALA MADAGASCARIENSIS	27	15 GAL. MIN HT 7'	NATIVE
023		ACCENT TALL PALM - VEITCHIA MONTGOMERYANA	14	15 GAL. MIN HT 6'	
024		ACCENT TALL PALM - FISHTAIL PALM - CARYDTA MITIS	53	15 GAL. MIN HT 6'	
	SHRUBS -	+ GROUNDCOVER			
025		CYCAD DIOON SPINULOSUM	12	7 GAL, MIN HT 2'	
026		CLUSIA	172	3 GAL, MIN HT 1.5'	
028		PHILODENDRON BURLE MARX	138	15 GAL, MIN HT 6'	
029	+ + + + + + + + + + + + + + + + + + +	GREEN ISLAND FICUS - FICUS MICROCARPA	880	15 GAL, MIN HT 6'	
030	00000	PHILODENDRON - MONSTERA DELICIOSA	132	15 GAL. MIN HT 6'	

	MISCELLANEDUS PLANT LIST - TO BE HAND PLACED BY DESIGNER AT TIME OF INSTALL			
	TREES + BAMBOO	QTY		
001a	ALOCASIA PORTORA	7	7 GAL. MIN HT 3'	
001b	ALOCASIA MACRORRHIZA 'BORNEO GIANT'	7	7 GAL. MIN HT 3'	
002a	CORDYLINE FRUTICOSA	25	3 GAL. MIN HT 2'	
002b	CORDYLINE FRUTICOSA 'JACKIE'	22	3 GAL. MIN HT 2'	
003	HELICONIA STRICTA 'SHARONII'	5	10 GAL. MIN HT 4'	
004	CODIAEUM VARIAGATUM - MAMMEY, MAGNIFICENT, DREADLOCKS	25	3 GAL. MIN HT 2'	
005	MIHCAELIA ALBA	5	15 GAL. MIN HT 3'	NATIVE
006	MISCELLANEOUS ORCHIDS TO BE TIED ON TREES	45	4″ P□TS	
007	AGLAIA ODORATA	5	15 GAL. MIN HT 6'	
008	CONFEDERATE JASMINE - TRACHELOSPERMUM JASMINOIDES	35	3 GAL. MIN HT 6'	

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