PROJECT PHOTOS



1415 Petronia Street circa 1965. Monroe County Library




































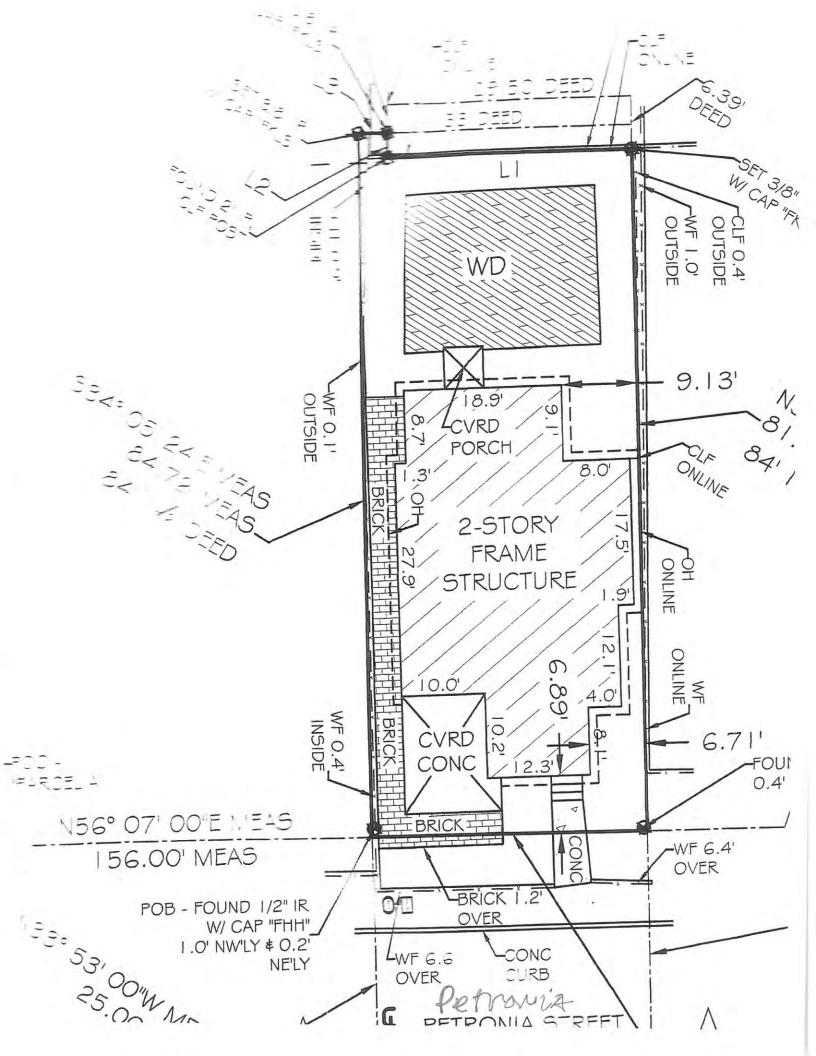


PROPOSED DESIGN

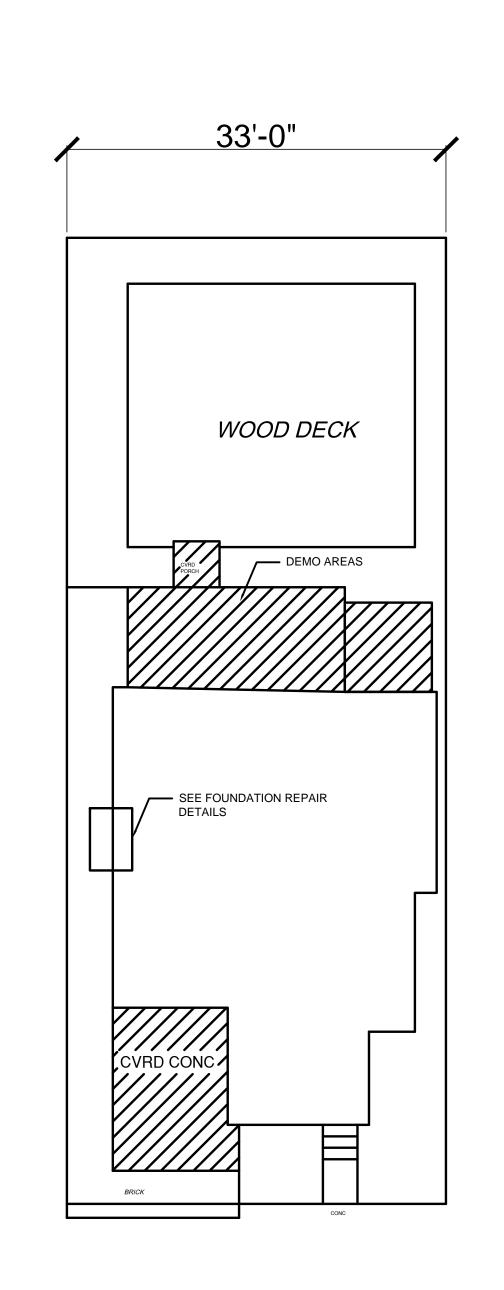



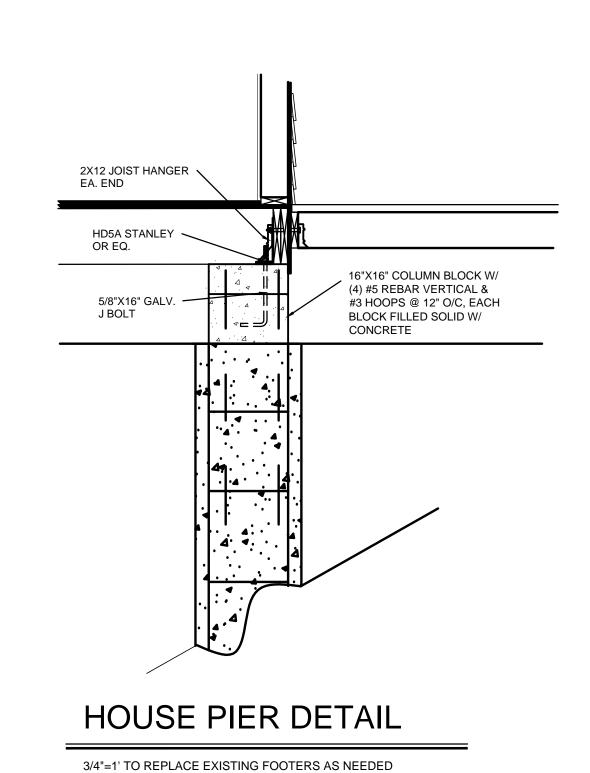

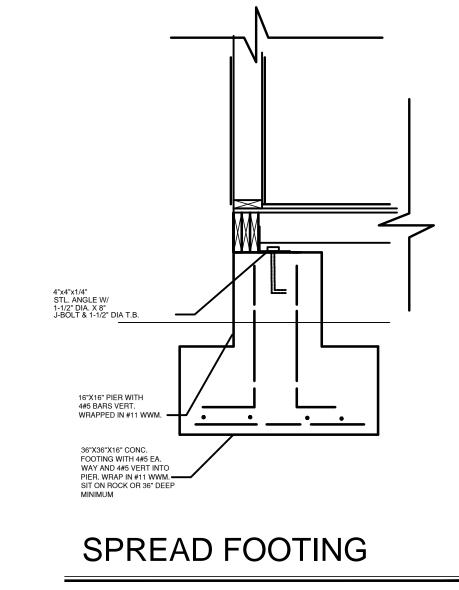


ALL WORK DEPICTED IN THESE DRAWINGS SHALL CONFORM TO REQUIREMENTS OF

THE FOLLOWING CODES:

FLORIDA BUILDING CODE 2014

NATIONAL ELECTRICAL CODE 2014 DESIGNED PER ASCE 7-10

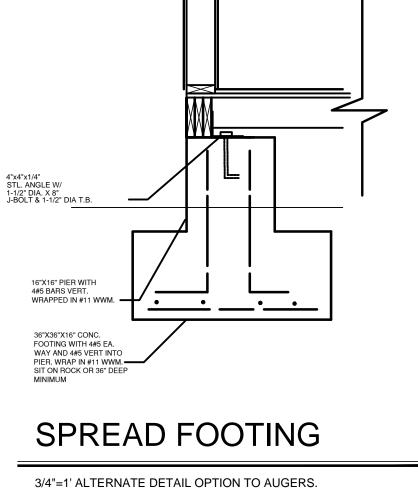

PROPOSED SITE PLAN

1/8" = 1'-0"

DRIVE WAY

FLORIDA BUILDING CODE 2014

MAXIMUM DESIGN PRESSURES FOR ROOF COMPONENTS
AND CLADING 180 MPH PER R301.2.1.3= 139 Vasd, ZONE C,
20 FOOT ROOF HEIGHT 1.29 MULTIPLIER 7 TO 27 DEGREE

1 POSITIVE PRESSURES: +35.61 NEGATIVE PRESSURES: -38.63

POSITIVE PRESSURES: +35.61 NEGATIVE PRESSURES: -83.34

POSITIVE PRESSURES: +26
NEGATIVE PRESSURES: -106

4 POSITIVE PRESSURES: +39.9 NEGATIVE PRESSURES: -72.7

5 POSITIVE PRESSURES: +39.92 5EGATIVE PRESSURES: -77.79

DESIGN DATA:

WIND VELOCITY: 180 MPH ASCE 7 - 10 WIND PRESSURE COEFFICIENT(S) BASED ON ASCE 7-10 VELOCITY PRESSURE: 48.1 P.S.F. WIND IMPORTANCE: 1.0

BUILDING CONDITION: ENCLOSED EXPOSURE CATEGORY: "C"

SOIL BEARING 2000 PSF (ASSUMED) COMPACT & TEST ALL FOOTINGS CONC. @ 28 DAYS 2500 PSI REINF. STL. - ASTM A615 GR 40 MORTAR TYPE "S"

CONC. MAS. - ASTM 90 OR ASTM C145 (1900 P.S.I. MIN.) GROUT - 3/8" MIN. AGGREGATE 2,000 PSI ROOF: LIVE LOAD - 40 PSI DEAD LOAD - 25 PSI

FLOOR LOADING:

LIVING AREAS-----50 PSF (LIVE LOAD) DECKS/ENTRYS-----40 PSF (LIVE LOAD)

ALL STRUCTURAL WOOD MEMBERS ARE #2 SOUTHERN YELLOW PINE LIVE LOADS ARE BASED UTILIZING THE TRIBUTARY AREA METHOD (TABLE 1604.6)

CONTRACTOR TO FIELD VERIFY DIMENSIONS TO EXISTING STRUCTURES & ALL DIMENSIONS CONTAINED IN THESE PLANS. NOTIFY ARCHITECT IMMEDIATELY IF ANY DISCREPANCIES OCCUR.


Revisions


Project Number 012016 Date 4/21/2016


Drawn By


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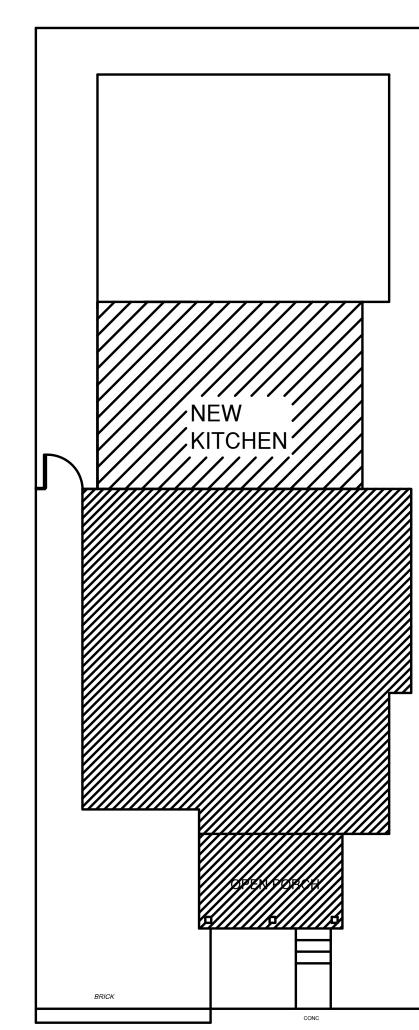
SITE CONDITIONS				
	EXISTING CONDITIONS	ALLOWABLE CONDITIONS	PROPOSED CONDITIONS	COMMENTS
DISTRICT	HMDR	HMDR	HMDR	
LOT SIZE	2772 SF	4000 SF MIN	2772 SF	EXISTING HARDSHIP
BUILDING AREA	1262 SF	1108 SF	1253 SF	NOT EXPANDING IN COMPLIANCE
BUILDING COVERAGE %	45%	40%	45%	NOT EXPANDING IN COMPLIANCE
IMPERVIOUS COVERAGE	1283 SF	1664 SF	1274 SF	IN COMPLIANCE
IMPERVIOUS COVERAGE %	46%	60%	45%	IN COMPLIANCE
BUILDING HEIGHT	-30'-0"	30'-0"	-30'-0"	IN COMPLIANCE
FRONT SETBACK	7'-0"	10'-0"	7'-0"	NOT EXPANDING IN COMPLIANCE
SIDE SETBACK	0"/2'-3"	5'-0"	5'-0"/5'-3"	NOT EXPANDING IN COMPLIANCE
REAR SETBACK	26'-5"	15'-0"	23'-6"	IN COMPLIANCE




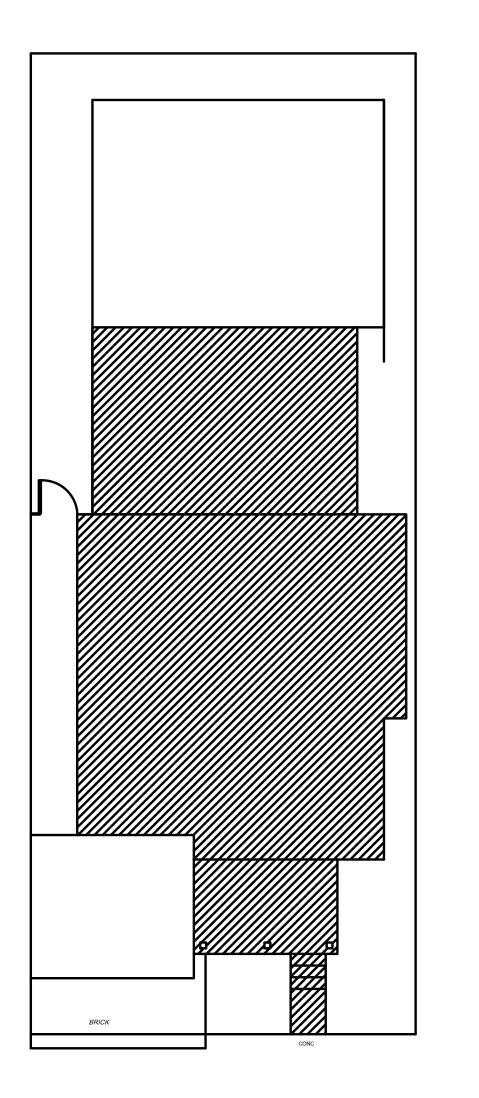

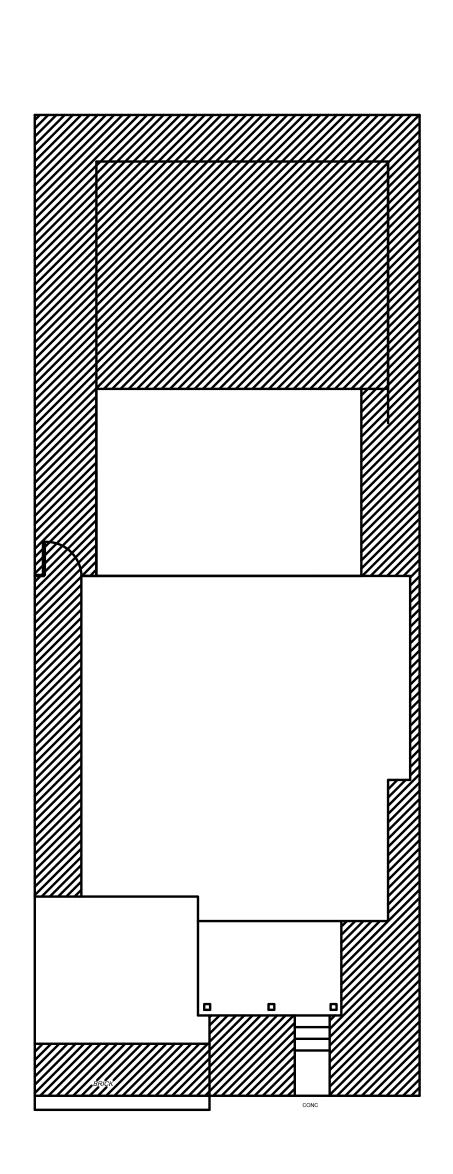


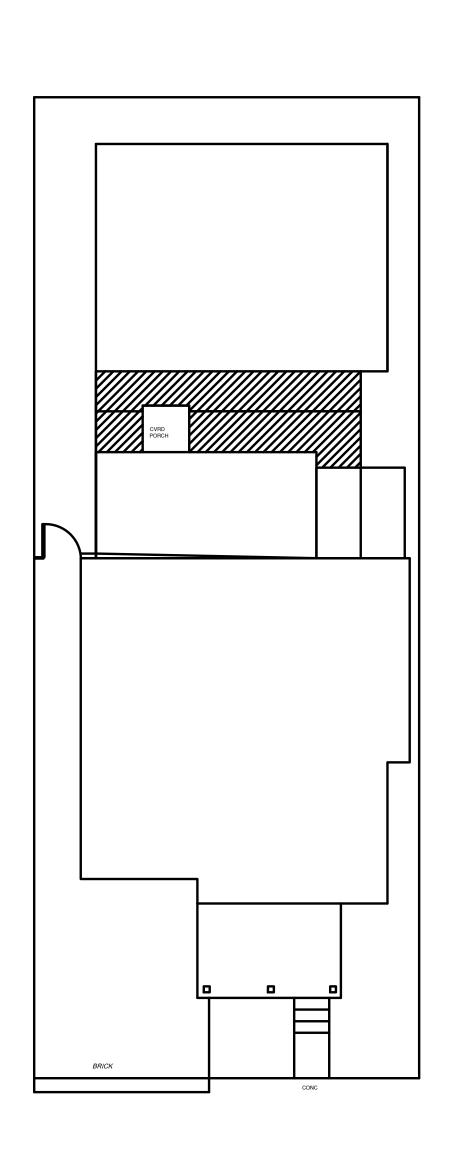

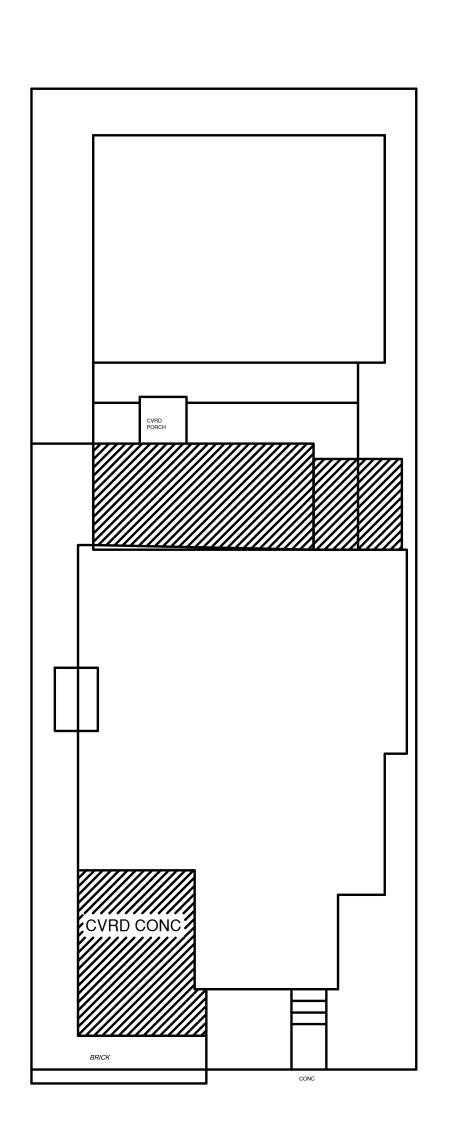

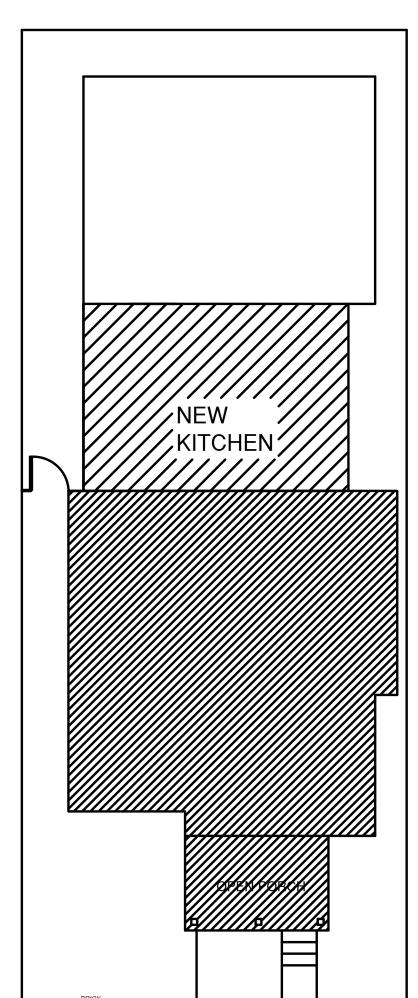



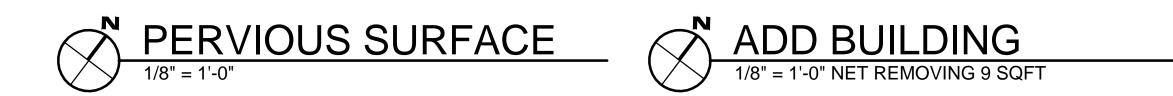










Project Number 012016


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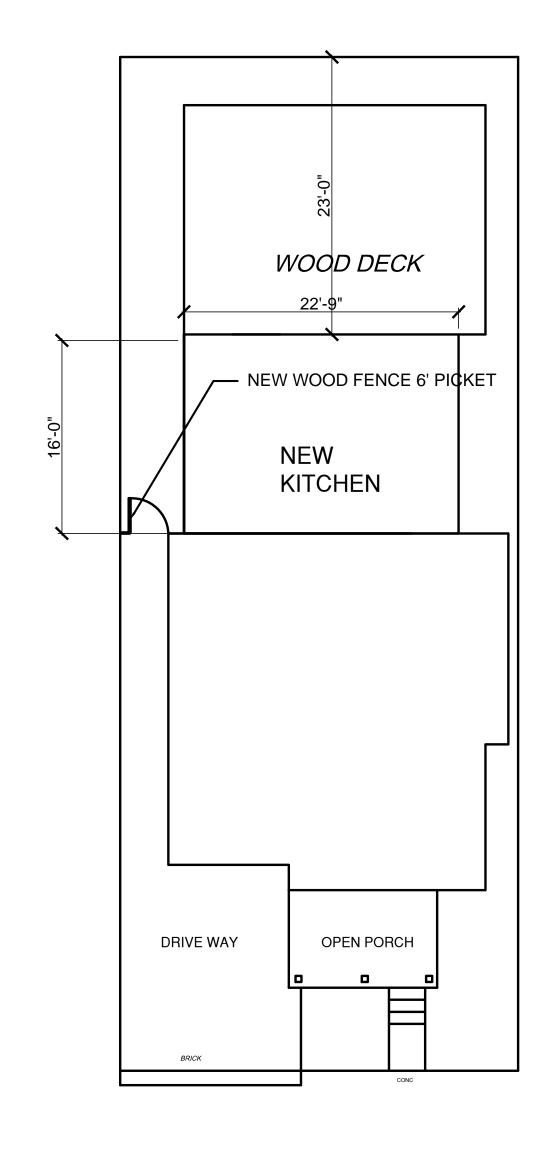
4/21/2016 Drawn By

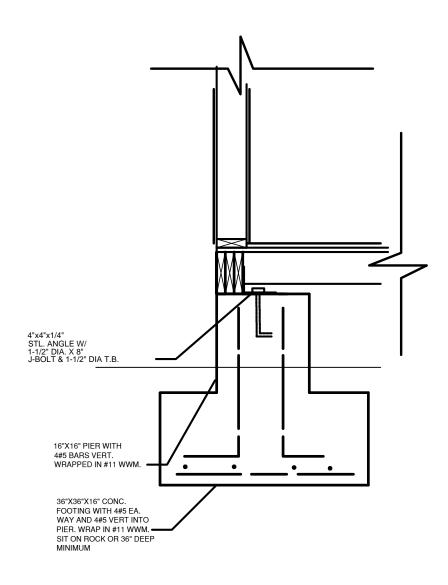

SPREAD FOOTING

3/4"=1' ALTERNATE DETAIL OPTION TO AUGERS.



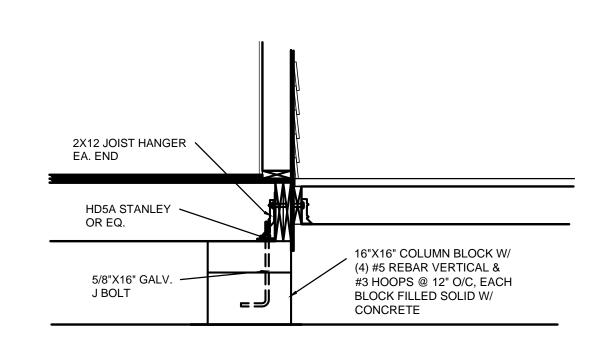


HOUSE PIER DETAIL

3/4"=1' TO REPLACE EXISTING FOOTERS AS NEEDED

ALL WORK DEPICTED IN THESE DRAWINGS
SHALL CONFORM TO REQUIREMENTS OF
THE FOLLOWING CODES:
FLORIDA BUILDING CODE 2014
NATIONAL ELECTRICAL CODE 2014
DESIGNED PER ASCE 7-10

PETRONIA STREET



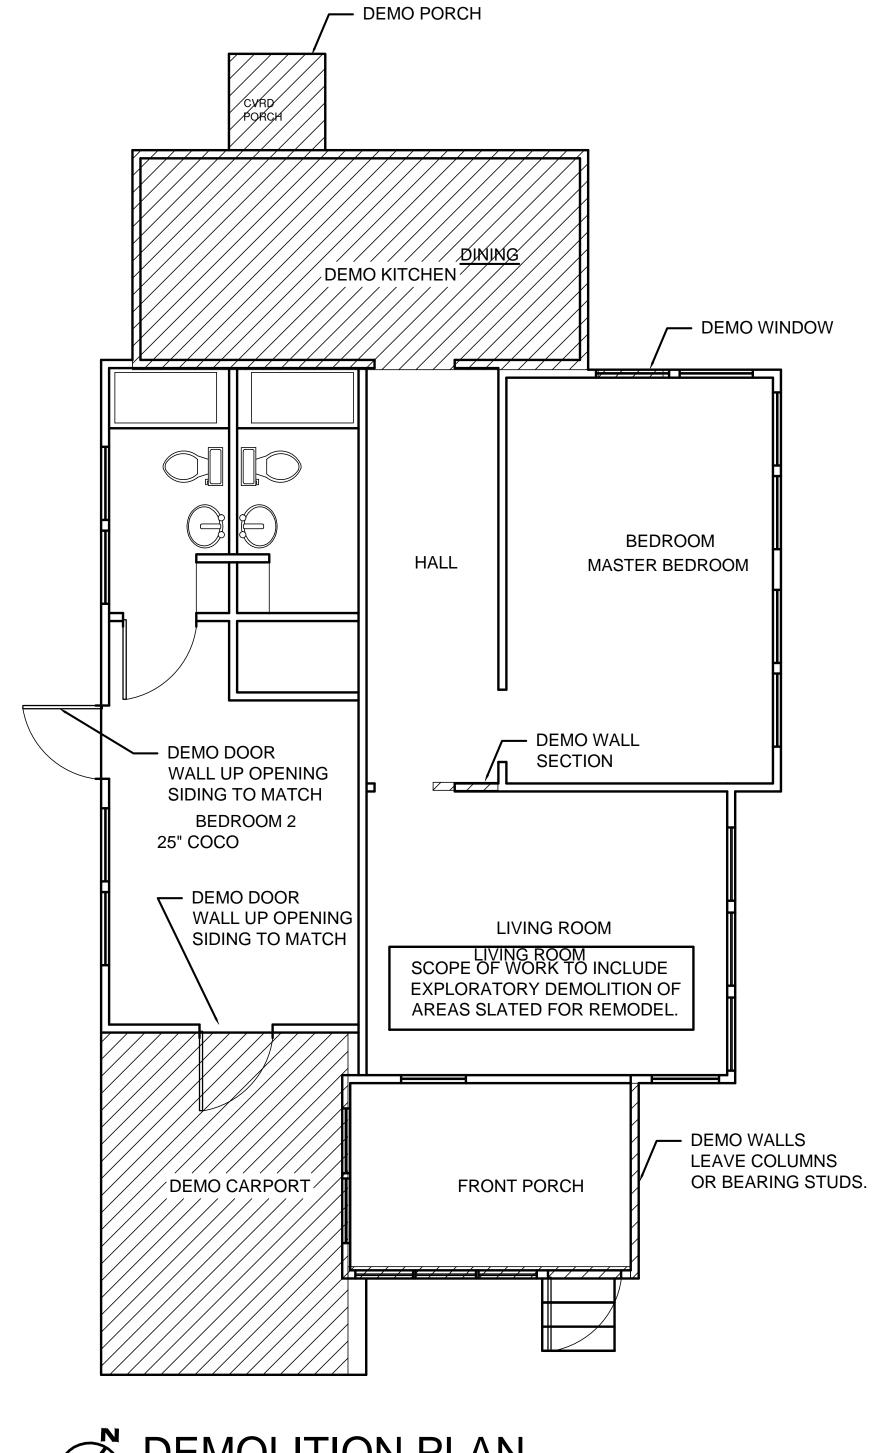





2012 Roosevelt Drive Key West, FI 33040 (305) 292-4870

Revisions

visions


Carlos O. Rojas, AIA 1415 Petronia Street

Project Number
012016

Date
4/21/2016


Drawn By
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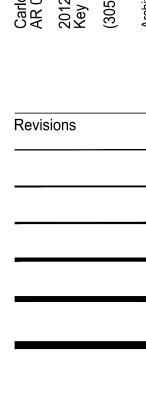


DOOR AND WINDOW PLAN

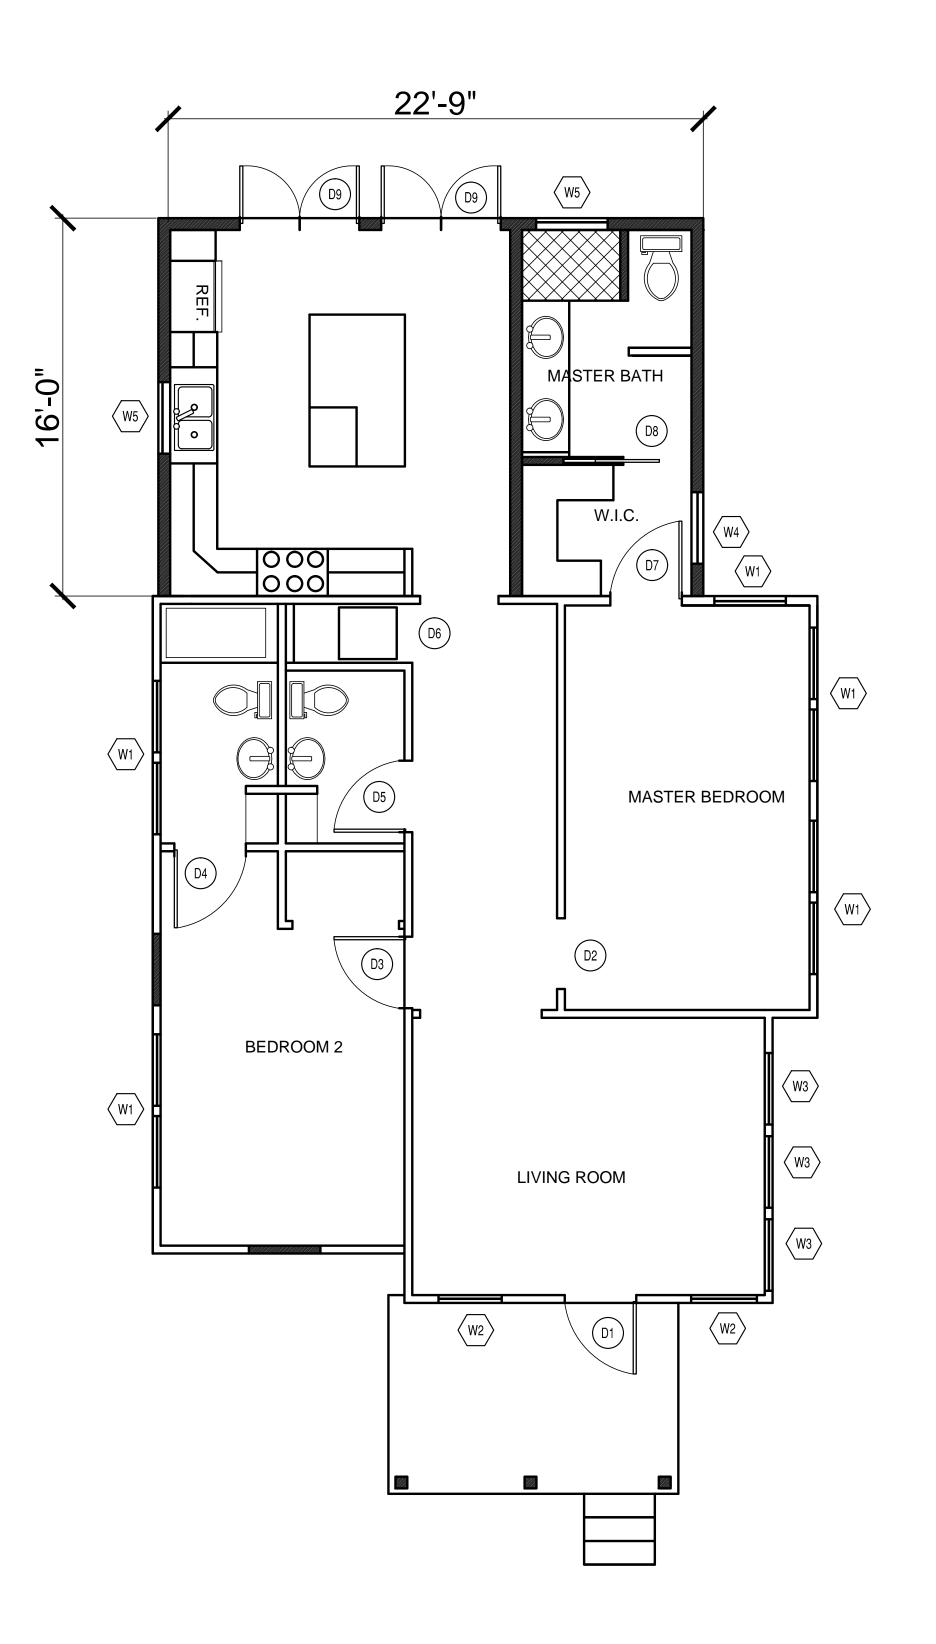1/4" = 1'-0"





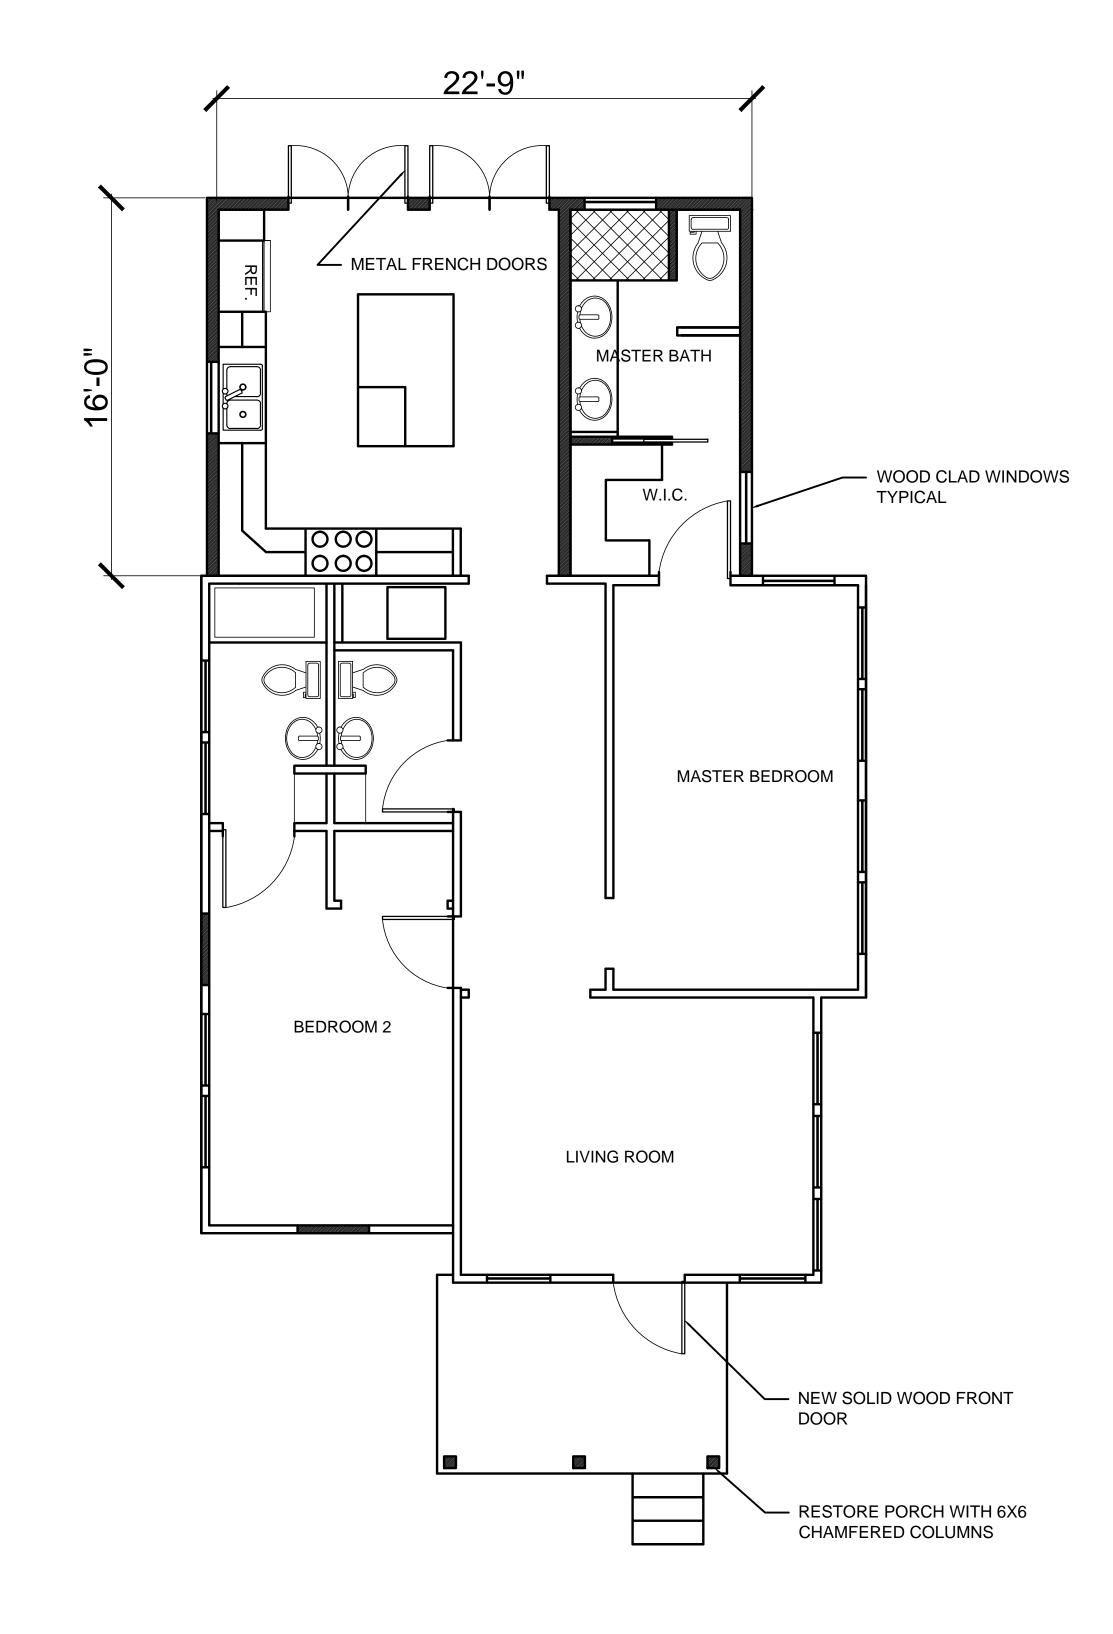

Carlos O. Rojas, Ala 1415 Petronia Stree Kay West Florida 33040

Project Number
012016

Date
4/21/2016

Date
4/21/2016
Drawn By
COR

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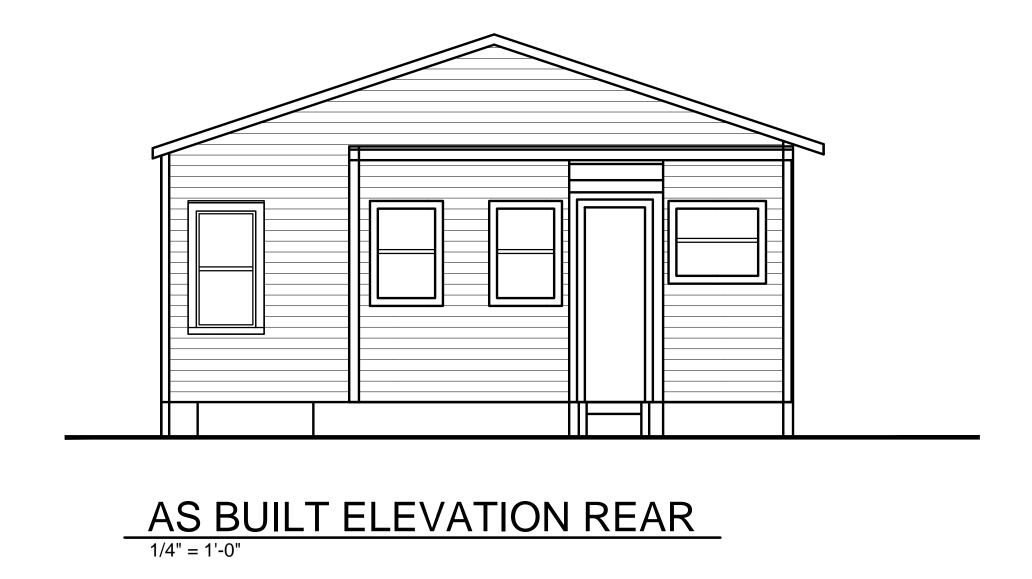



EXTERIOR MATERIAL SECTION




Revisions

Project Number 4/21/2016 Drawn By COR



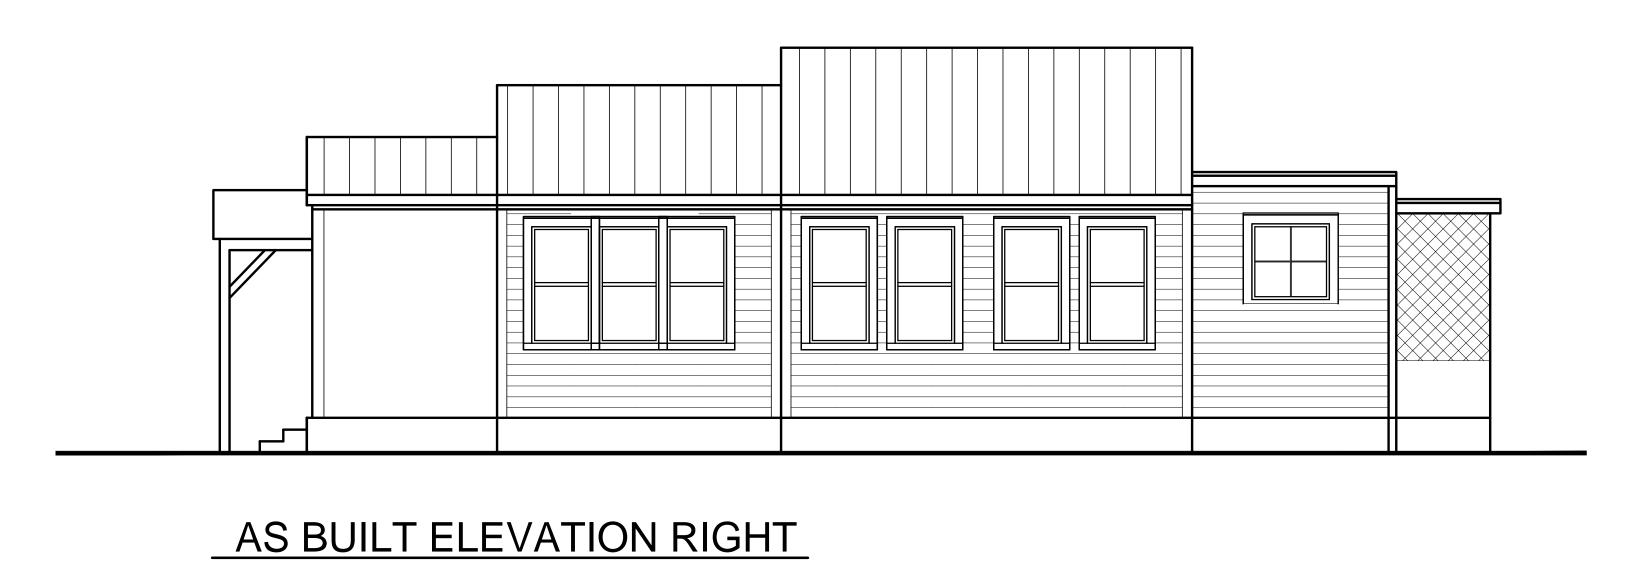

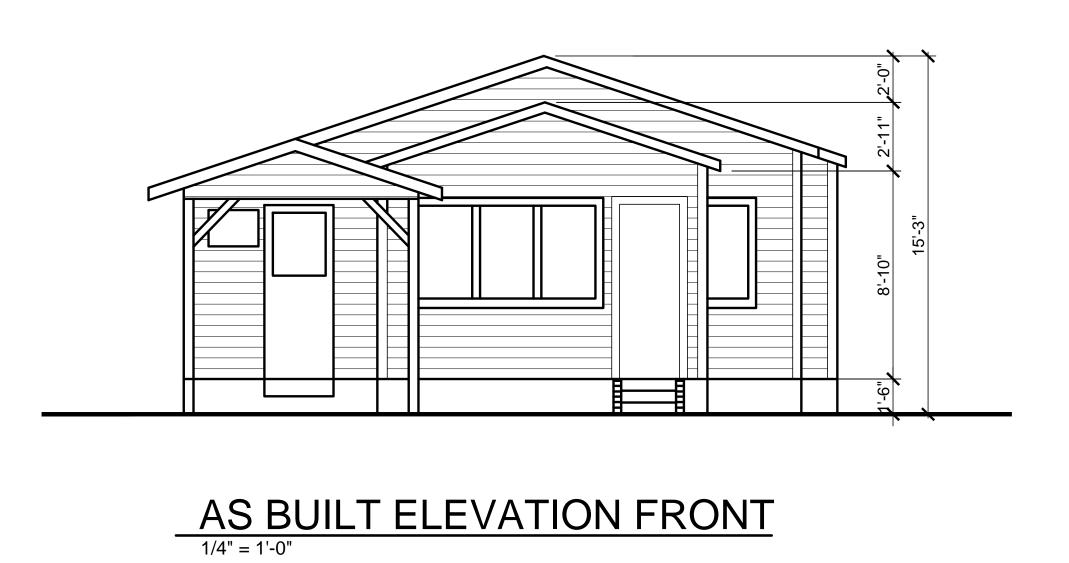



AS BUILT ELEVATION LEFT

1/4" = 1'-0"

4/21/2016 Drawn By