

Historic Architectural Review Commission Staff Report for Item 10

To: Chairman Bryan Green and Historic Architectural Review

Commission Members

From: Kelly Perkins, MHP

HARC Assistant Planner

Meeting Date: April 24, 2018

Applicant: Hood Depot

Application Number: 18-0227

Address: #517 Truman Avenue

Description of Work:

New mechanical equipment including two kitchen hood systems and required safety railings.

Site Facts:

Located at the corner of Truman Avenue and Center Street, 517 Truman Avenue is listed as a non-contributing building in the survey. The property appraiser's state that the building was constructed in 1963, and it does not show up on the 1962 Sanborn map. The structure is a two-story, cbs structure with little architectural detail or significance.

Guidelines Cited in Review:

Secretary of the Interior's Standards for Rehabilitation (pages 16-17), specifically Standards 9 and 10.

HARC Guidelines for New Construction (pages 38a-38q), specifically guideline 19.

HARC Guidelines for Air Conditioning Units, antennas, Trash Facilities & Satellite Dishes (pages 42-43), specifically guidelines 1, 2, 5, and 7.

Staff Analysis

This Certificate of Appropriateness proposes adding kitchen hood equipment, as well as other equipment, to the roof on a one-story portion on the rear of the building. The kitchen hood will project more than 48 inches above the roof. The plans also include a 4-foot-tall security rail with a louvered design to hide the equipment. The elevations still show that the equipment will protrude above the security rail.

Consistency with Guidelines

Staff believes that the proposed design does not meet guidelines 19 of new construction as the equipment and the required security rail will be visible from a public right-of-way (Center Street). On the other hand, there is no other location to place the kitchen hood without it being publicly visible or having a larger impact on the historic district. The guidelines state that equipment should be mounted out of sight of the public right-of-way, and be obscured behind landscaping or fencing wherever possible.

APPLICATION

MASTER PERMIT COMBINATION APPLICATION: FLOODPLAIN, CONSTRUCTION AND HARC

\$50.00 APPLICATION FEE NON-REFUNDABLE

O THE STATE OF THE	130 KEY Pho
ADDRESS OF PROPOSE	DPRO

ity of Key West

00 WHITE STREET Y WEST, FLORIDA 33040

IA-IVEL OND	ADLL	
IIT NUMBER	BUILDING PERMIT	NUMBER INITIAL & DATE
	18-02:	27
PERMIT	ZONING	REVISION #
PANEL#	ELEV. L. FL. SUBS	STANTIAL IMPROVEMENT YES NO %
	IT NUMBER	18-023 ERMIT ZONING

	5.809.3956	FLOOD ZONE	PANEL#	ELEV. L. FL.	SUBSTANTIAL IMP	PROVEMENT	
BLDG@CIT	YOFKEYWEST-FL.GOV				YES	NO%	
ADDRESS OF PROPOSED PROJECT.	517 TRUMAN AVE	NUE			#	OF UNITS	
RE # OR ALTERNATE KEY:	00017770-000000	00017770-000000					
NAME ON DEED:	GEO AND 517 TRU	JMAN LLC		PHONE NUMB	ER		
OWNER'S MAILING ADDRESS:	517 TRUMAN AVE	NUE		EMAIL			
-	KEY WEST 33040						
CONTRACTOR COMPANY NAME:	HOOD DEPOT			PHONE NUMB	ER -9860	2	
CONTRACTOR'S CONTACT PERSON:	710 S POWERLINE	ROD #H	DEERFI				
ARCHITECT / ENGINEER'S NAME:				PHONE NUMB			
ARCHITECT / ENGINEER'S ADDRESS:				EMAIL			
DETAILED Project Description(The ap work that is considered by the City. Sho as described herein versus the scope of	pplicant further hereby acknowld further action be taken l f work shown on the plans o	owledges that by the City for	the scope o	f work as decr	ibed shall be the	scope of	
aforementioned decription of work shall							
INSTALL 2 HOOD SYS	TEMS					-	
Printed name of property owner or licensed		Signature.	1				
MICHAEL LUBO\		~	1				
Notary Signature as to applicant. State of Personally known of produced	f Florida, County of Monroe,		(407) 398 0	MY COMMIS	L V FARLEY SSION # FF96753 March 16, 2020 otalyService com	1	
Official Use Only							

APP Fee

	SIGN SPECIFICATIONS	
SIGN COPY:	PROPOSED MATERIALS:	SIGNS WITH ILLUMINATION:
		TYPE OF LTG.:
		LTG. LINEAL FTG.:
MAX. HGT. OF FONTS:		COLOR AND TOTAL LUMENS:
IF USING LIGHT FIXTURES PLEASE INDICATE HOW MANY	: INCLUDE SPEC. SHEET WITH LO	CATIONS AND COLORS.
OFFICIAL USE ONLY:	RC STAFF OR COMMISSION REVIEW	
APPROVED NOT APPROVED	DEFERRED FOR FUTURE CONSIDER	ATION TABLED FOR ADD'L. INFO.
HARC MEETING DATE:	HARC MEETING DATE:	HARC MEETING DATE:
REASONS OR CONDITIONS:		
STAFF REVIEW COMMENTS:		
HARC PLANNER SIGNATURE AND DATE:	HARC CHAIRPERSON	I SIGNATURE AND DATE:


PART D: STATE OF FLORIDA OFFICIAL NOTIFICATIONS AND WARNINGS

FLORIDA STATUTE 713.135: WARNING TO OWNER: YOUR FAILURE TO RECORD A 'NOTICE OF COMMENCEMENT' MAY RESULT IN YOUR PAYING TWICE FOR IMPROVEMENTS TO YOUR PROPERTY. A NOTICE OF COMMENCEMENT MUST BE RECORDED WITH THE COUNTY RECORDER AND A COPY POSTED ON THE JOB SITE BEFORE THE FIRST INSPECTION. IF YOU INTEND TO OBTAIN FINANCING CONSULT WITH YOUR LENDER OR AN ATTORNEY BEFORE RECORDING A NOTICE.

FLORIDA STATUTE 469: ABESTOS ABATEMENT. AS OWNER / CONTRACTOR / AGENT OF RECORD FOR THE CONSTRUCTION APPLIED FOR IN THIS APPLICATION, I AGREE THAT I WILL COMPLY WITH THE PROVISIONS F. S. 469.003 AND TO NOTIFY THE FLORIDA D. E. P. OF MY INTENT TO DEMOLISH / REMOVE ASBESTOS. IN ADDITION TO THE REQUIREMENTS OF THIS PERMIT APPLICATION, THERE MAY BE DEED RESTRICTIONS AND / OR ADDITIONAL RESTRICTIONS APPLICABLE TO THIS PROPERTY THAT MAY BE FOUND IN THE PUBLIC RECORDS OF MONROE COUNTY AND THERE MAY BE ADDITIONAL PERMITS REQUIRED FROM OTHER GOVERNMENT ENTITIES SUCH AS AQUADUCT ATHORITY, FLORIDA DEP OR OTHER STATE AGENCIES; ARMY CORPS OF ENGINEERS OR OTHER FEDERAL AGENCIES.

FEDERAL LAW REQUIRES LEAD PAINT ABATEMENT PER THE STANDARDS OF THE USDEP ON STRUCTURES BUILT PRIOR TO 1978.

ALL NECESSARY APPROVALS FROM ASSOCIATIONS, GOV'T. AGENCIES, AND OTHER PARTIES ARE THE APPLICANT'S RESPONSIBILITY.

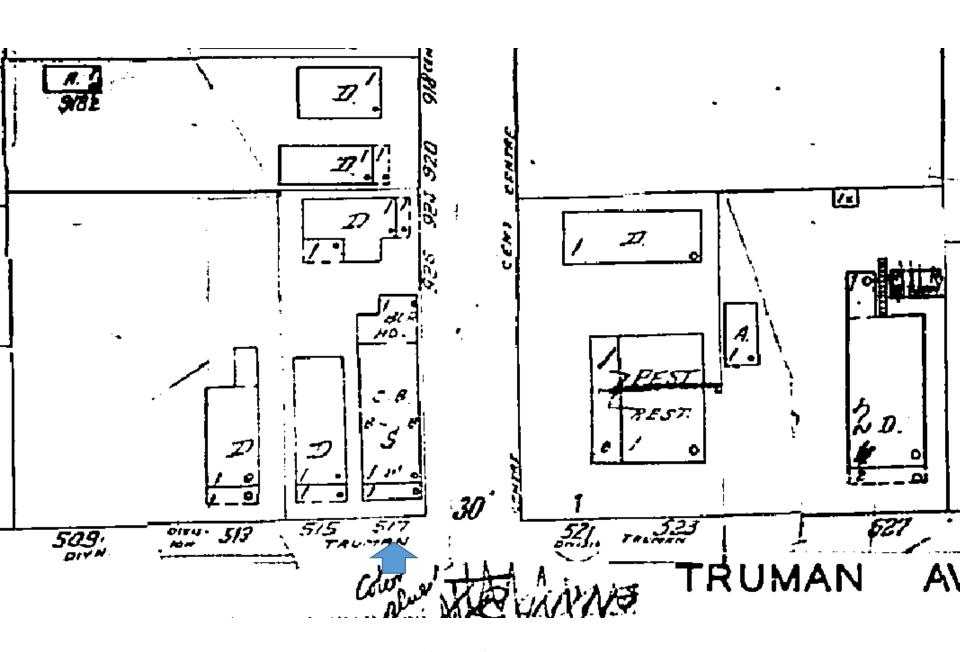

1962 Sanborn Map

PROJECT PHOTOS



Property Appraisers Photograph, c.1965. Monroe County Public Library.











PROPOSED DESIGN



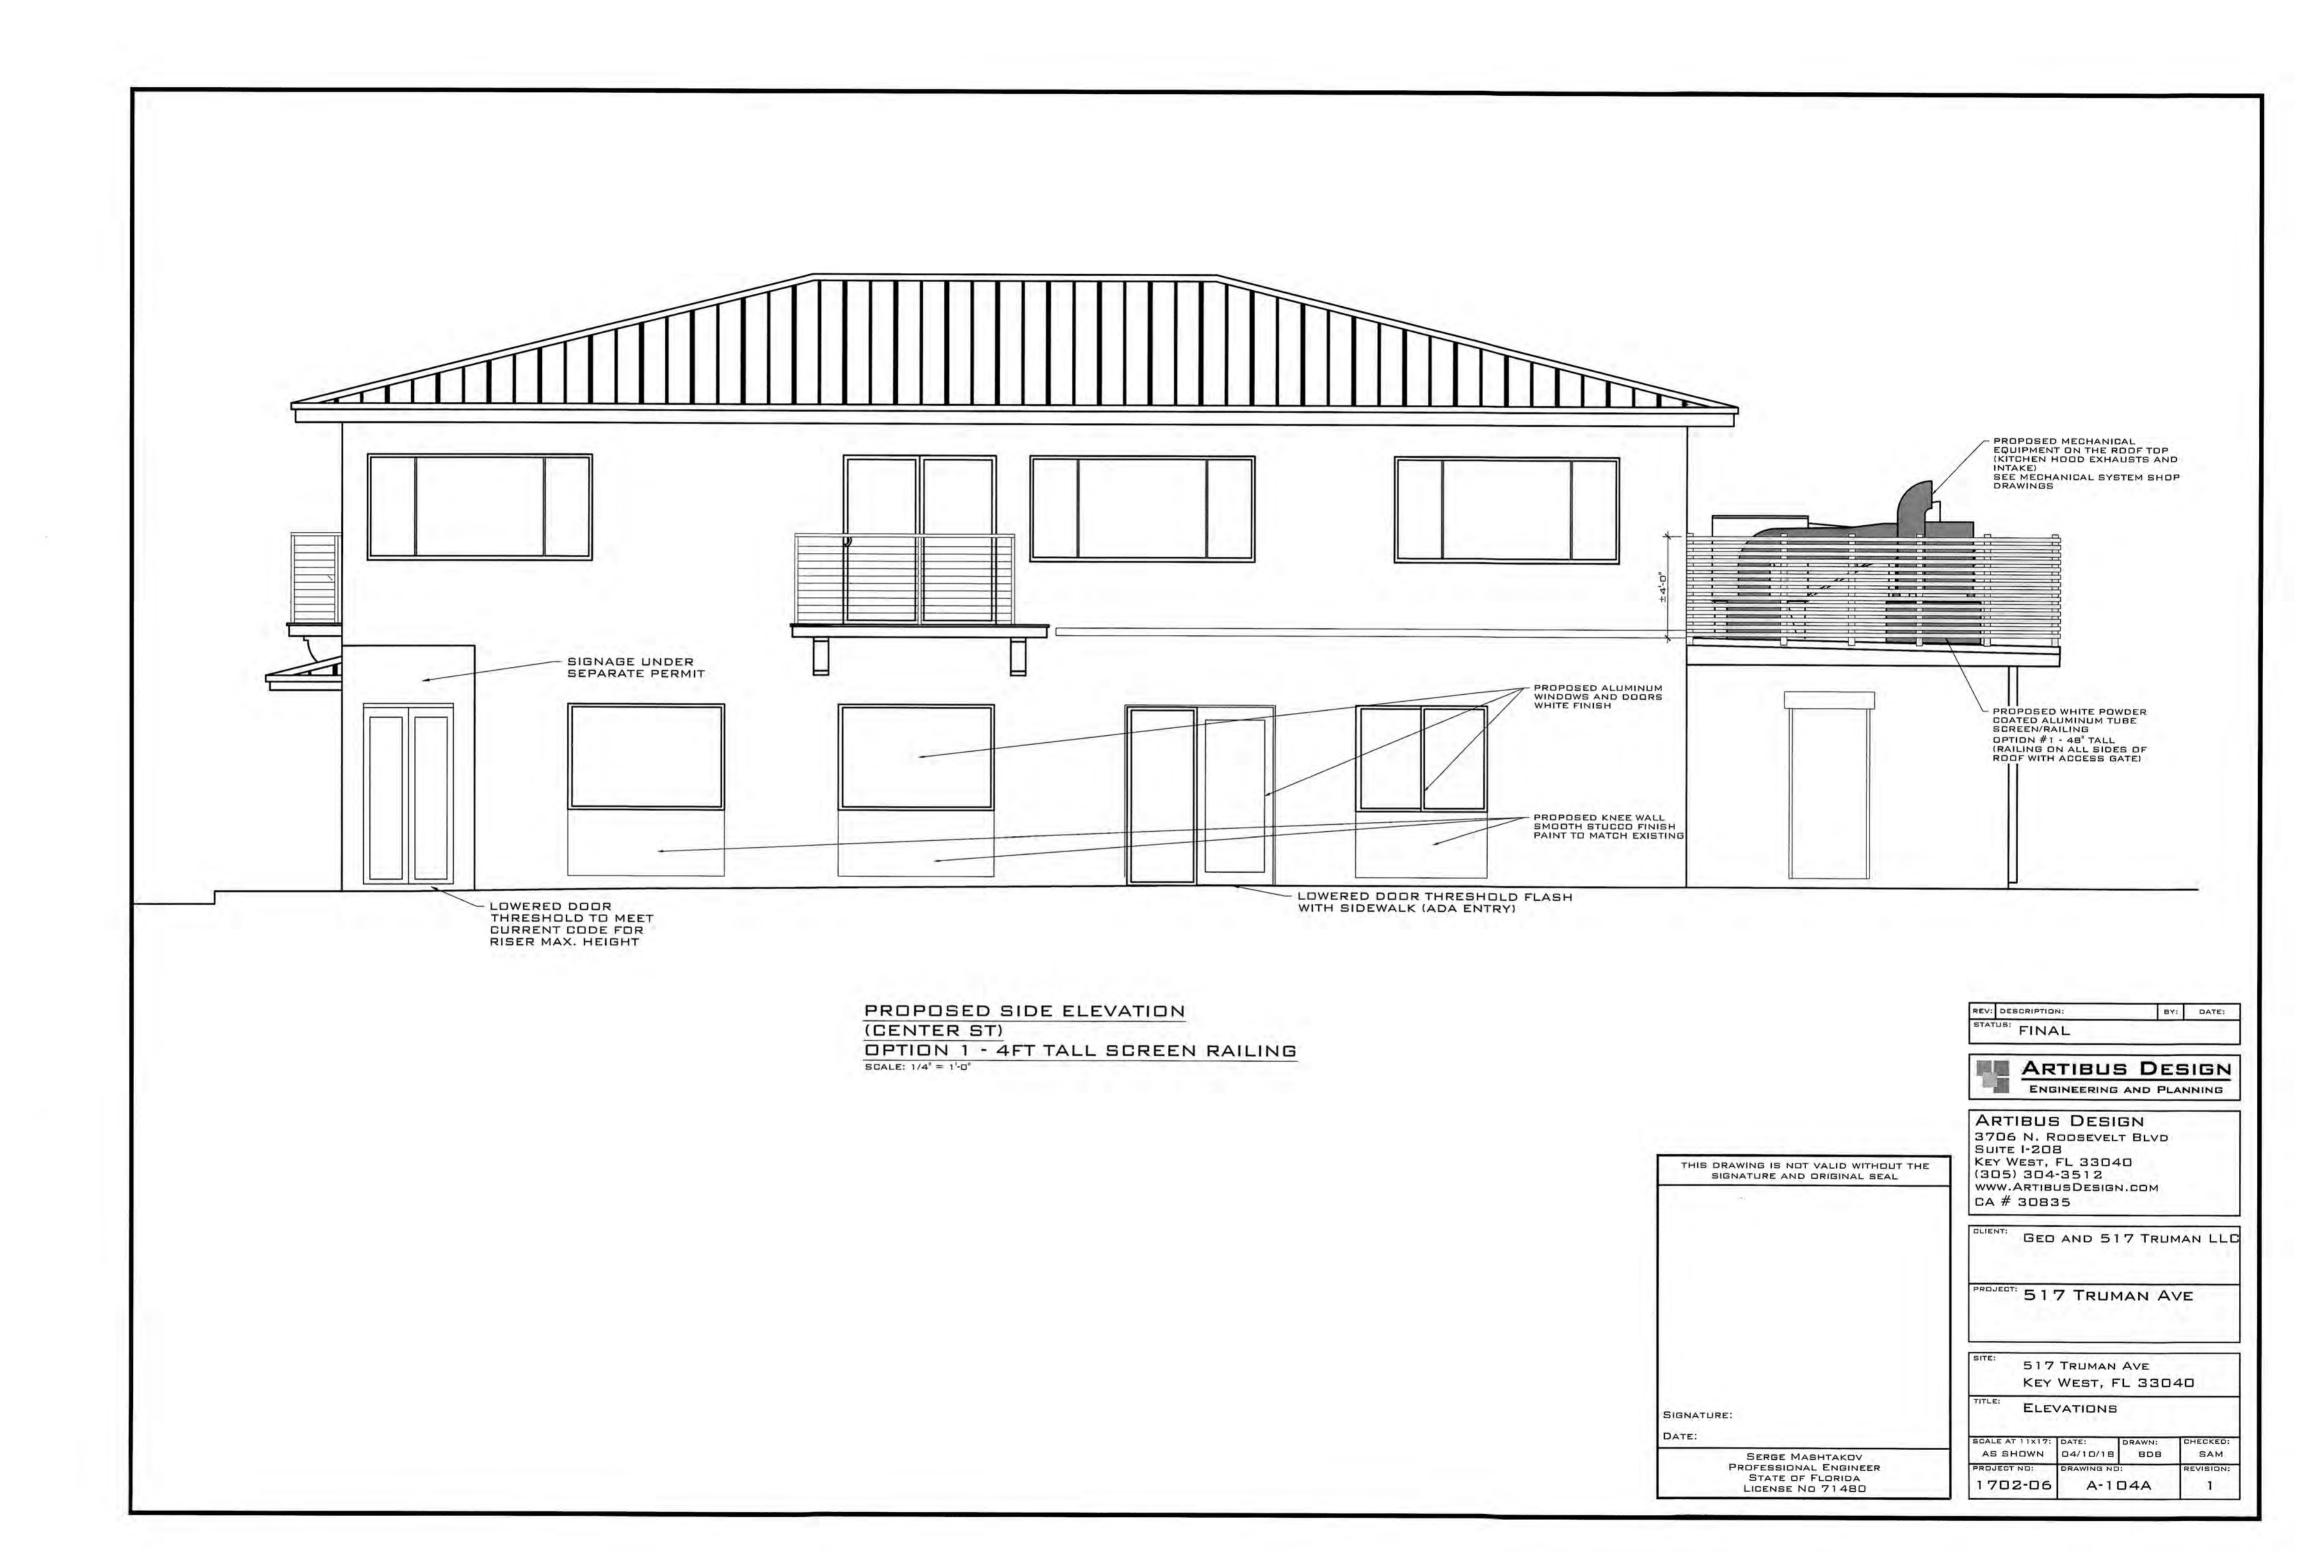

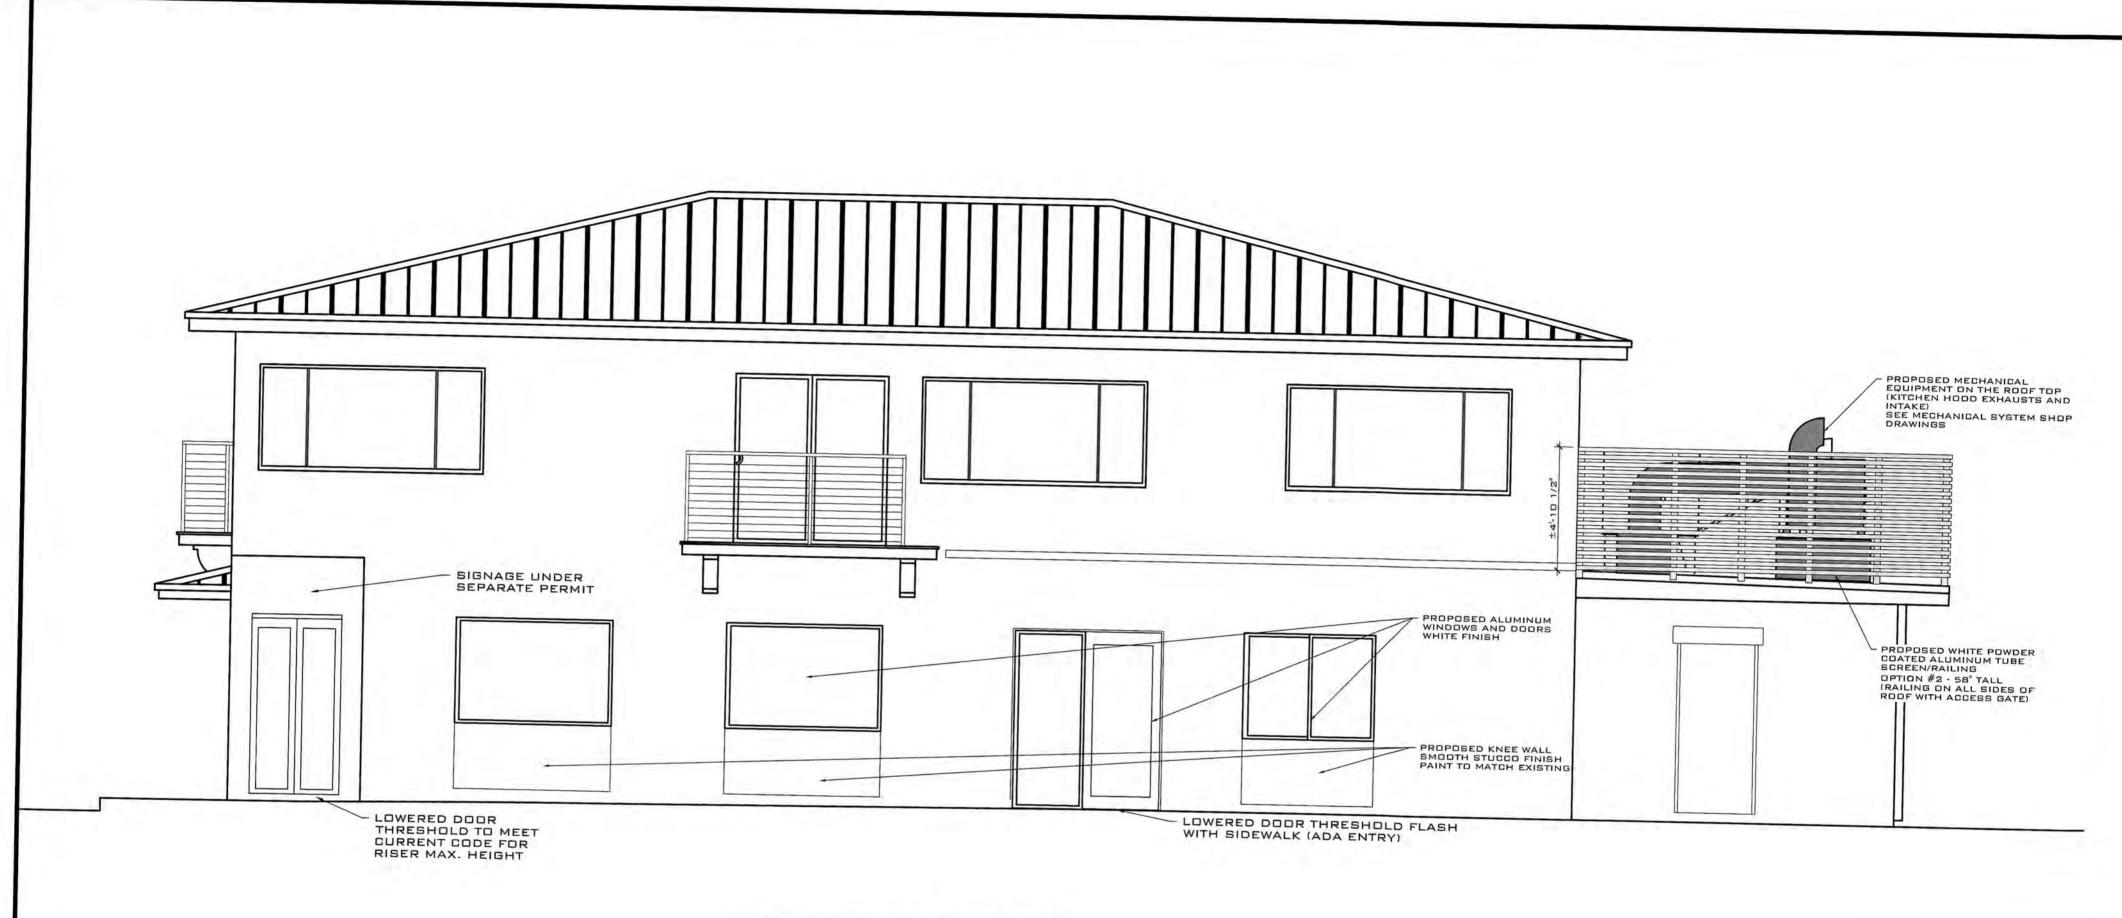

PROPOSED SIDE ELEVATION
(CENTER ST)

OPTION 2 - 4.9FT TALL SCREEN RAILING

SCALE: 1/4" = 1'-0"

THIS DRAWING IS NOT VALID WITHOUT THE SIGNATURE AND ORIGINAL SEAL

SIGNATURE:

DATE:

SERGE MASHTAKOV
PROFESSIONAL ENGINEER
STATE OF FLORIDA
LICENSE NO 71480

REV: DESCRIPTION: BY: DATE:

ARTIBUS DESIGN
ENGINEERING AND PLANNING

ARTIBUS DESIGN
3706 N. RODSEVELT BLVD
SUITE I-208
KEY WEST, FL 33040
(305) 304-3512
www.ARTIBUS DESIGN.COM
CA # 30835


GED AND 517 TRUMAN LLC


517 TRUMAN AVE


517 TRUMAN AVE
KEY WEST, FL 33040


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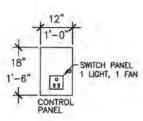
SCALE AT 11x17: DATE:
AS SHOWN 04/10/18 BDB SAM
PROJECT NO: DRAWING NO: REVISION:
1702-06 A-104B 1



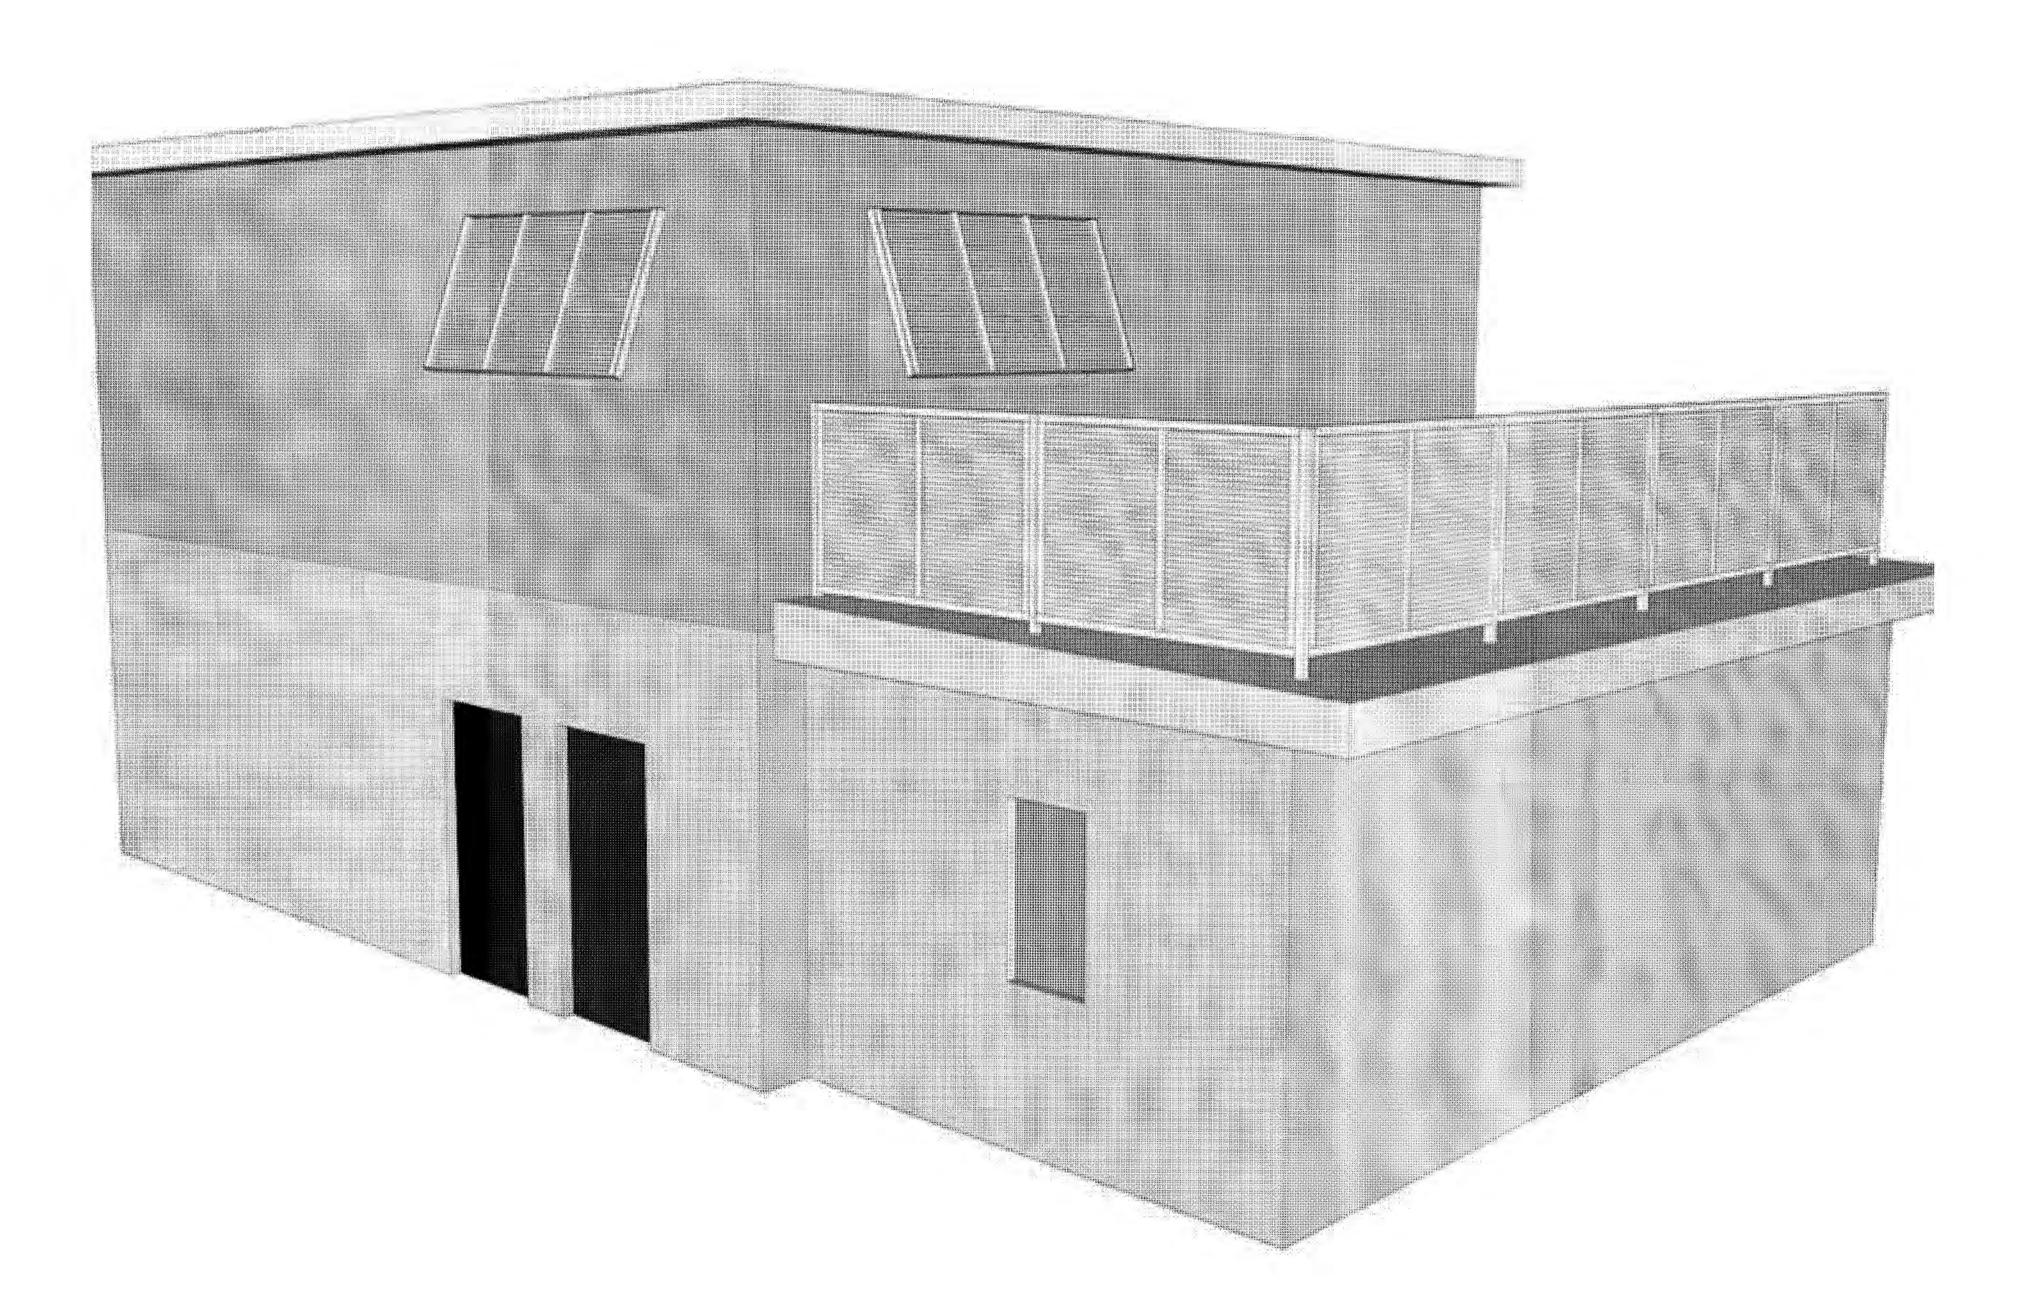

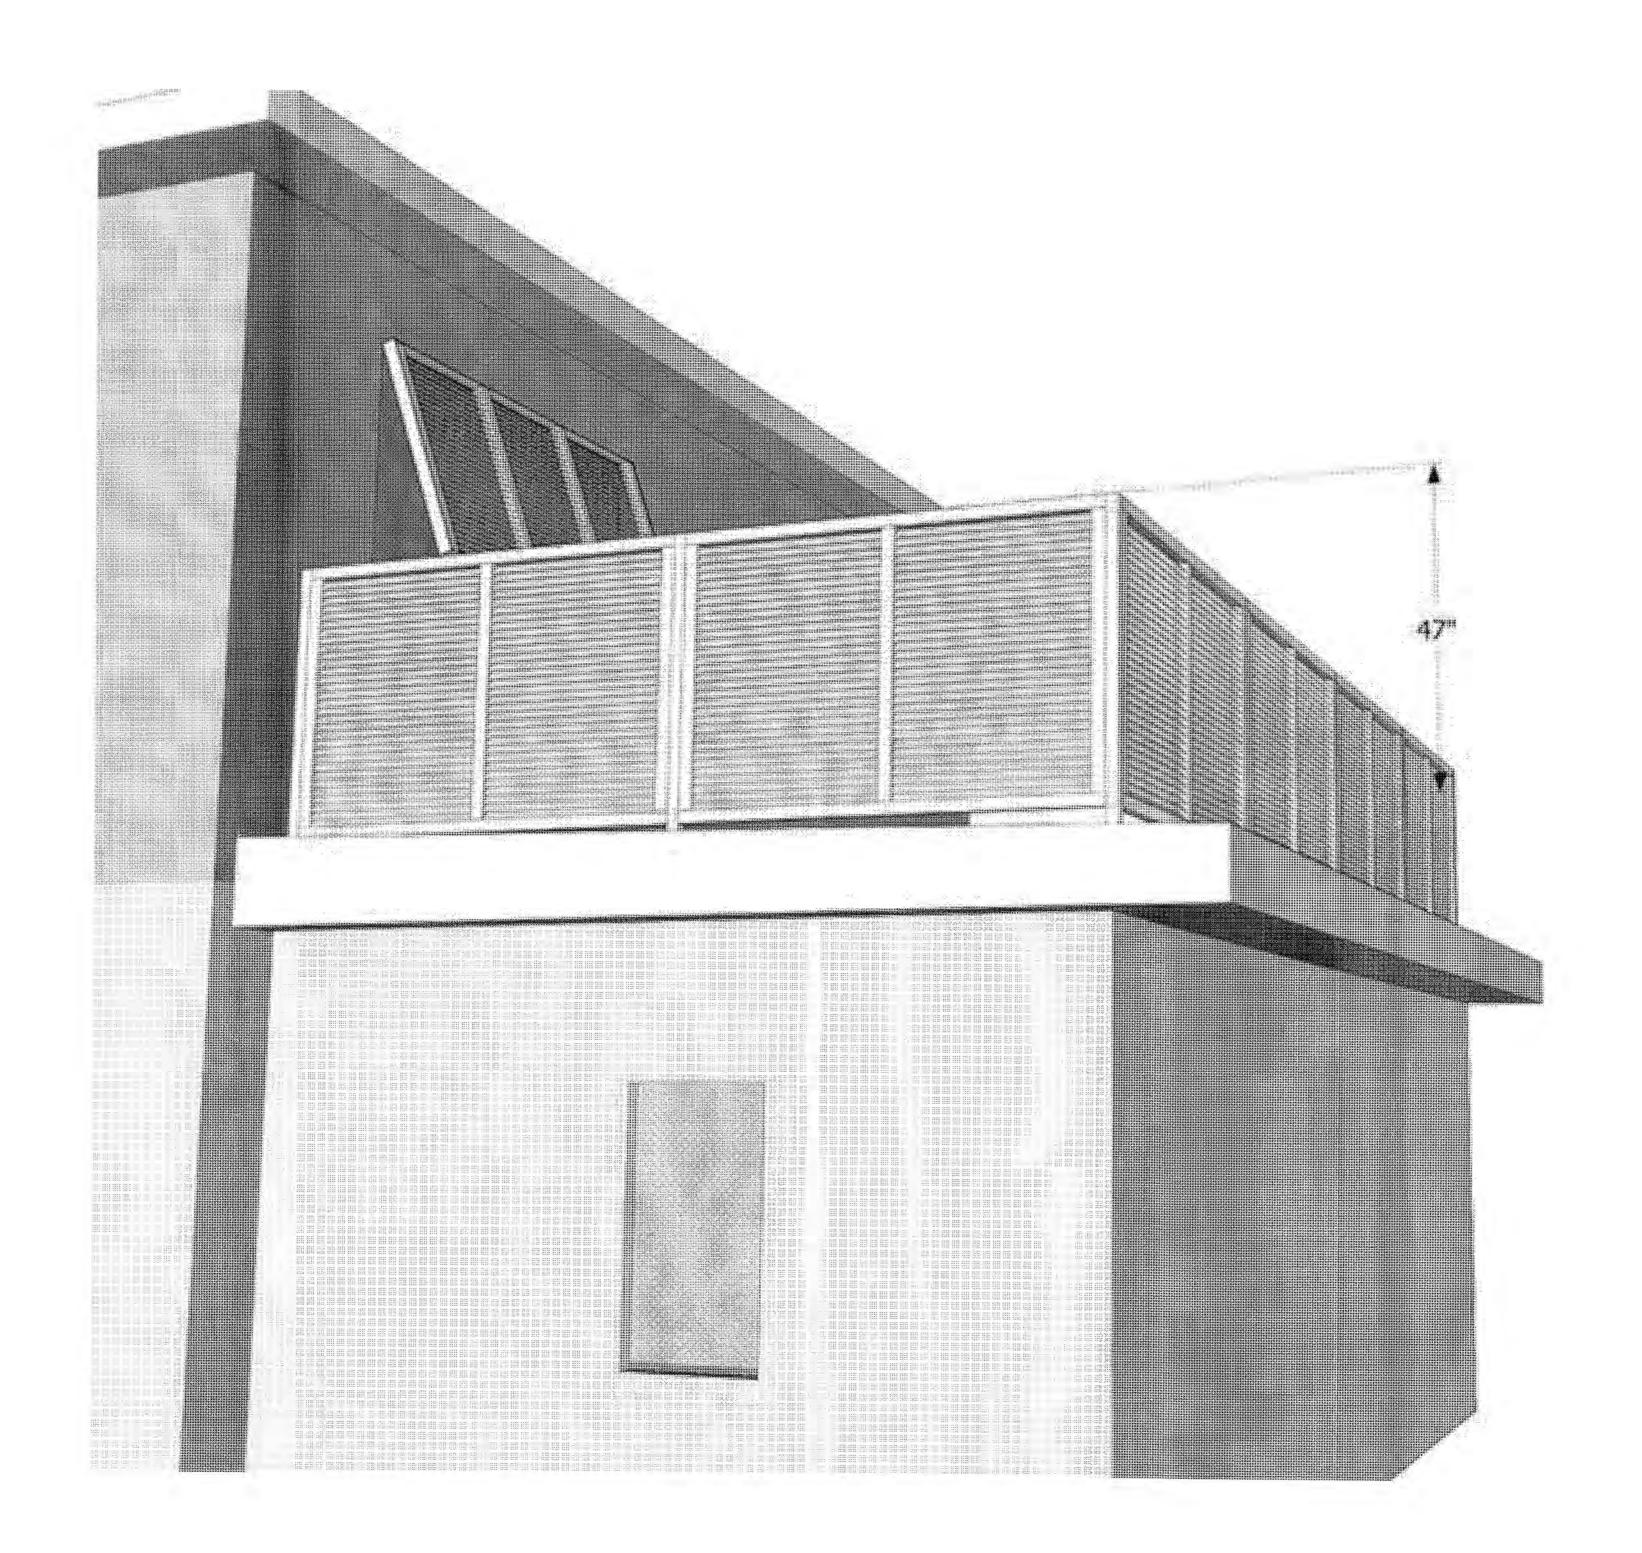

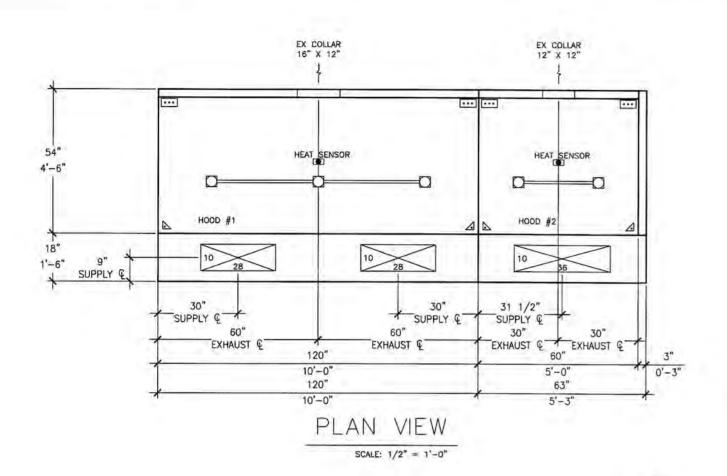

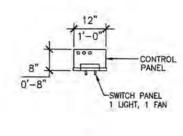

REMOTE CONTROL PANEL

SCALE: 1/2" = 1'-0"

REQUIREMENTS BY ELECTRICAL CONTRACTOR

- WIRE EACH FAN CIRCUIT FROM CIRCUIT BREAKER TO LINE SIDE OF CONTACTOR IN CONTROL PANEL.
 WIRE EACH FAN FROM LOAD SIDE OF CONTACTOR IN CONTROL PANEL TO DISCONNECT SWITCHES ON FAN. DISCONNECT SWITCHES PROVIDED
- ON FANS.

 3. WIRE A 120V 20 AMP CONTROL CIRCUIT TO TERMINALS L AND N IN CONTROL PANEL.

 4. IF THERE IS NO FIRE ALARM PRESENT IN THE BUILDING THEN WIRE FROM CONTROL PANEL TERMINALS NO AND N TO HORN/STROBE
- FROM CONTROL PANEL TERMINALS NO AND N TO HORN/STROBE DEVICE IN KITCHEN. 120V HORN/STROBE DEVICE TO BE PROVIDED BY ELECTRICAL CONTRACTOR.

 5. WIRE FROM CONTROL PANEL TERMINALS NO AND N TO SHUNT TRIP BREAKERS IN CIRCUIT BREAKER PANEL. ALL ELECTRICAL OUTLETS AND APPLIANCES UNDER THE HOOD NEED TO SHUT DOWN UPON FIRE SYSTEM ACTIVATION, SHUNT TRIP BREAKERS PROVIDED BY ELECTRICAL CONTRACTOR. ELECTRICAL POWER UNDER THE HOOD CAN ALSO BE SHUT DOWN USING RELAYS OR CONTACTORS WIRED TO TERMINALS NO AND N.


 6. FIRE ALARM CONNECTIONS IF A FIRE ALARM IS PRESENT IT NEEDS TO BE CONNECTED TO THE SPARE MICROSWITCH (DRY CONTACTS)
- TO BE CONNECTED TO THE SPARE MICROSWITCH (DRY CONTACTS).
 WIRES FOR MICROSWITCH ARE LOCATED IN THE 190 JBOX NEAR THE
 FIRE SYSTEM CONTROL HEAD. IF A BUILDING FIRE ALARM IS PRESENT
- FIRE SYSTEM CONTROL HEAD. IF A BUILDING FIRE ALARM IS PRESEN A HORN/STROBE DEVICE IS NOT REQUIRED.

 7. HEAT SENSORS NEED TO BE WIRED FROM EACH HOOD TO CORRESPONDING TERMINAL BLOCKS IN CONTROL PANEL.


 8. LIGHTS ARE PRE WIRED ON TOP OF EACH HOOD TO A SINGLE JUNCTION BOX. WIRING NEEDS TO BE PROVIDED AND INSTALLED IN BETWEEN HOOD SECTIONS AND FROM THE HOOD TO THE CONTROL PANEL AND CONNECT TO TERMINALS 14 AND 15.

 9. WHEN THERE IS NOT A FIRE CABINET BUILT INTO OUR HOOD THE MICRO SWITCH MUST BE WIRED FROM THE FIRE SYSTEM CONTROL HEAD TO DUE CONTROL PANEL THE COLM WIRE (BLUE) COSES TO. MICHO SWITCH MUST BE WIRED FROM THE FIRE STATEM CONTROL
 HEAD TO OUR CONTROL PANEL, THE COM WIRE (BLUE) GOES TO
 TERMINAL C IN OUR PANEL, THE NORMALLY CLOSED WIRE (YELLOW)
 GOES TO TERMINAL NC IN OUR PANEL AND THE NORMALLY OPEN
- WIRE (BROWN) GOES TO TERMINAL NO IN CONTROL PANEL.


 10. FIRE SYSTEMS IN TYPE I HOODS THAT SHARE A FIRE HAZARD AREA MUST ACTIVATE SIMULTANEOUSLY.

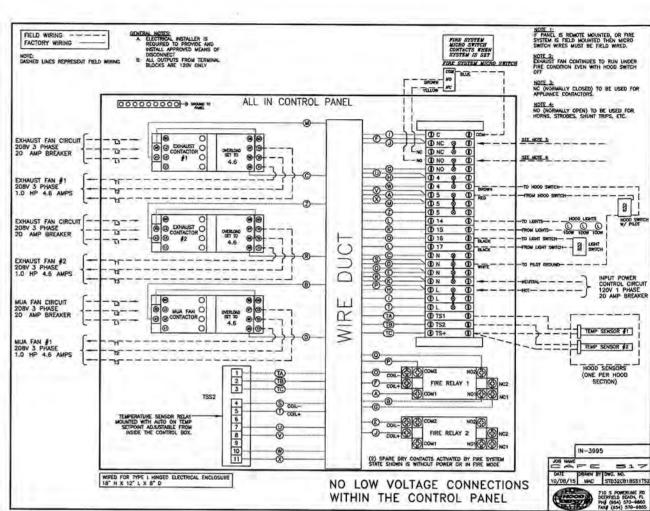

GENERAL NOTES:

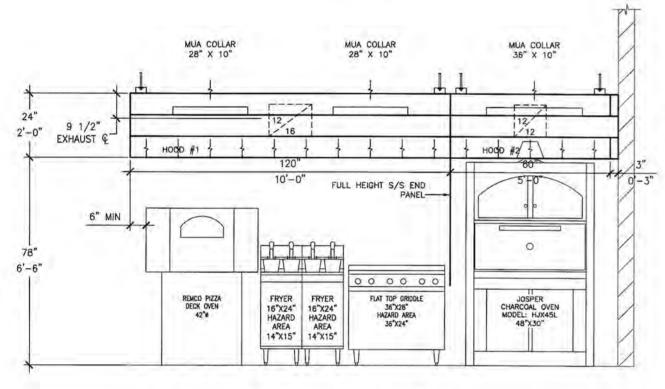

FRONT ELEVATION

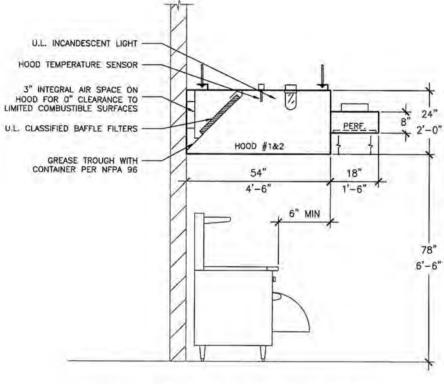

LEFT SIDE ELEVATION

SCALE: 1/2" = 1'-0"

APPLIANCE PROTECTION REMOTE MANUAL PULL STATION SRM CONTROL HEAD TYPICAL REMOTE BUCKEYE BFR SYSTEM LAYOUT

- FIRE MODE REQUIRES EXHAUST FAN TO OPERATE CONTINUALLY AND STOP SUPPLY FAN.
- HODD EXHAUST FANS SHALL DPERATE WHENEVER THE EXTINGUISHING SYSTEM IS ACTIVATED.
- FIXED PIPE EXTINGUISHING SYSTEMS IN A SINGLE HAZARD AREA SHALL BE ARRANGED FOR SIMULTANEOUS AUTOMATIC OPERATION UPON ACTIVATION OF ANYONE OF THE SYSTEMS.
- GAS AND ELECTRICAL EQUIPMENT AND DUTLETS SERVED BY THE HODD SHALL BE DEACTIVATED IN THE EVENT OF A FIRE SYSTEM ACTUATION PER NFPA 96 10.4
- ACTUATION OF THE FIRE SYSTEM SHALL SIGNAL THE ALARM SYSTEM SERVING THE AREA OCCUPIED BY THE HODD PER NFPA96 10.6

OPTIONAL PRE-WIRED ELECTRICAL— TERMINAL BOX WITH TERMINAL STRIPS, 3-PHASE CONTACTORS AND OVERLOADS (IF APPLICABLE) SUPPLY AND EXHAUST FANS ARE INTERLOCKED WITH PILOT LIGHT IN KITCHEN AREA.

U.L. FILE #: MH18803

- FIRE SUPPRESSION SYSTEM:
 FIRE SUPPRESSION SYSTEM UNDER SEPERATE PERMIT PRIOR TO FINAL INSPECTION.
- EQUIPMENT SCREENING:
 ALL ROOF EQUIPMENT TO BE CONCEALED FROM PUBLIC VIEW, IF REQUIRED, IS TO BE FURNISHED BY OWNER/G.C. UNDER SEPARATE PERMIT.

UL RANGE HOOD:

MATERIAL: 18 GAUGE STAINLESS STEEL CONSTRUCTION ON EXPOSED SURFACES 18 GA.
GALV. ON EXH. PLENUM ALL CONTINUOUS EXTERNAL LIQUID TIGHT WELDS, POLISHED.
FILTERS UL CLASSIFIED BAFFLE TYPE. SET IN HOOD @ 45 DEGREE ANGLE,
INCANDESCENT LIGHT FIXTURES UL LISTED FOR USE IN COMMERCIAL COOKING HOODS.
GREASE TRAY BELOW FILTERS WITH REMOVABLE GREASE CONTAINER, LIQUID VOLUME LESS
THAN 1 QUART. ALL IN COMPLIANCE WITH NFPA #96 AND LOCAL BUILDING CODES.

2. TYPE I RANGE HOOD EXHAUST DUCTS:

MATERIAL: 16 GAUGE GALVANIZED STEEL, CONSTRUCTION ALL CONTINUOUS LIQUID TIGHT
EXTERNAL WELDS. DUCT IS CONNECTED BY 1/2" FLANGES FULL WELDED. DUCTS TO
SLOPE TOWARD HOOD. CLEANING ACCESS AT CHANGEIN DIRECTION OF DUCT RUN EXCEPT

RANGE HOOD SUPPLY DUCTS:
MATERIAL: GALVANIZED SHEET METAL GAUGES, HANGING AND REINFORCING PER SMACNA

RANGE HOOD EXHAUST FAN:
AS SPECIFIED ON DRAWING AND CONFORMING TO SMOKE AND GREASE - LADEN VAPOR REMOVAL UL LISTED SUBJECT BULLETIN 762 YZHW.

RANGE HOOD SUPPLY FAN:
AS SPECIFIED ON DRAWINGS AND CONFORMING TO A NATIONAL TESTING AUTHORITY FOR PERFORMANCE CERTIFICATION. TO BE LOCATED A MINIMUM OF 10'-O" HORIZONTALLY OR

ELECTRICAL:
ELECTRICAL HOOK UP AND EQUIPMENT SUCH AS MOTOR STARTERS, SWITCHES, CONTROLS AND COMPONENTS OTHER THAN WHAT IS SPECIFICALLY MENTIONED ON DRAWINGS IS BY OTHERS.

3' VERTICALLY BELOW FROM ANY EXHAUST FAN, PLUMBING VENT AND FLUE STACKS.

7. FIRE ALARM CONNECTIONS:

IF PRESENT IN THE BUILDING, ALL FIRE ALARM CONNECTIONS ARE TO BE MADE OUTSIDE

OF THE CONTROL PANEL. THERE IS A SPARE MICROSWITCH (DRY CONTACTS) IN THE FIRE

SYSTEM CONTROL HEAD THAT IS WIRED TO A 190 JBOX NEARBY THAT WILL ALLOW LOW

VOLTAGE CONNECTIONS.

10. COMPLIANCE:
SYSTEM TO BE MANUFACTURED AND INSTALLED IN STRICT ACCORDANCE WITH NFPA #96, LOCAL FIRE PREVENTION BUREAU MECH. AND HEALTH DEPT. STANDARDS

	EX CFM	SUPPLY CFM	DIFFERENCE
AIR EXHAUSTED FROM HOODS	4300		
AIR SUPPLIED TO HOODS		3440	
TOTAL AIR VOLUME	4300	3440	-860

HVAC SYSTEM OF BUILDING TO PROVIDE MORE THAN 860 CFM TO INSURE OVERALL BUILDING BALANCE IS POSITIVE. KITCHEN TO BE NEGATIVE WITH RESPECT TO ADJACENT AREAS NOT TO EXCEED -0.02" WATER COLUMN

MODEL

NDFC-1205424118

1 1 18"

1 18"


MFG.

HOOD DEPOT

HOOD

10'-0"

10'-0" 2

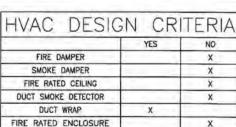

EXHAUST COLLAR

SIZE S.P.


0.411"

12 x 16

17.40

FIRE RATED ENCLOSURE

SCALE: 1/2" = 1'-0"

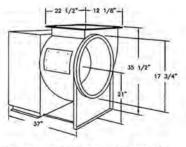

FILTERS

TYPE VI 0 20 x 16 6 20 x 20

SIZE

TYPE QTY

HOOD SCHEDULE

(FPM)

1725

2000

COLLAR GREASE DUCT


CFM (SQFT)

1.33

2300

105,8 70

175.2 36.75

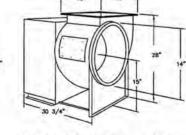


LIGHTS

TYPE

INCANDESCEN

CFL

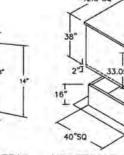

UTILITY CABINET

LOCATION

N/A

N/A

SIZE

N/A

CM-18 EXHAUST FAN DETAIL N.T.S. CM-14 EXHAUST FAN DETAIL N.T.S. KC-F50015 SUPPLY FAN DETAIL N.T.S.

SWITCHES

CONTROL CONTROL PANEL PANEL

CONTROL CONTROL PANEL PANEL

LIGHT

HOOD

MODEL "NDFC" EXHAUST HOODS ARE U.L. LISTED FOR USE OVER COMMERCIAL COOKING APPLIANCES BY UNDERWRITER'S LABORATORIES IN ACCORDANCE WITH NFPA 96 AND UL 710 STANDARDS.






CHIEF ENGINEER

RODNEY L FRITZ, P.E.

PH# 800-322-8730

LICENSE # 0050003

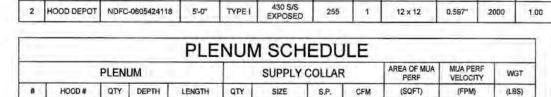

LENGTH TYPE MATERIAL WGT (LBS) QTY

430 S/S ALL

510

10 x 28 .25" 1840

5'-3" 1 10 x 36 .25" 1600 9.13

TYPE

				FAN S	SCHED	ULE					
HOOD#	LABEL	MFG.	MODEL	CFM	S.P.	HP	VOLTAGE	PHASE	RPM	AMPS	WGT (LBS
1	EF-1	JENCO	CM-18	2300	1.125	1	208V	зРН	1085	4,6	160
2	EF-2	JENCO	CM-14	2000	1.5	1	208V	зРН	1730	4.6	102
1-2	SF-1	HOOD DEPOT	KC-F 50015	3440	0.5	1	208V	ЗРН	552	4.6	185

FILTER VELOCITY THR

151


(SQFT)

15.24

HOOD TEMPERATURE SENSOR DETAIL

HOOD TEMPERATURE SENSOR TEMPERATURE SENSOR TO BE PLACED IN THE

GREASE EXHAUST HOOD TO ACTIVATE THE EXHAUST HOOD SYSTEM PER FLORIDA MECHANICAL CODE 507.2.1.1 OPERATION. WHICH STATES TYPE I HOOD SYSTEMS SHALL BE DESIGNED AND INSTALLED TO AUTOMATICALLY ACTIVATE THE EXHAUST FAN MENEVER COOKING OPERATIONS OCCUR. THE ACTIVATION OF THE EXHAUST FAN SHALL OCCUR THROUGH AN INTERLOCK WITH THE COOKING APPLIANCES, BY MEANS OF HEAT SENSORS OR BY MEANS OF OTHER APPROVED

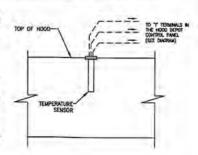


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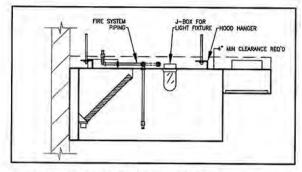
Trans.	
40	

710 SOUTH POWERLINE ROAD DEERFIELD BEACH, FL. 33442 E-MAIL: HOODDEPOT@AOL.COM

CERTIFICATE OF AUTHORIZATION #29593

	REVISIONS		11005	0	O.T. 15.172	11.10
NUMBER	DESCRIPTION	DATE			OT INT'I RD. #H DEERFIELI	
			JOB NAME: 517 TRUN		517 KEY WEST, FL	IN-3995
			SCALE: NOTED	DRAWN BY: MAC	CHECK BY: RLF	DATE: 04/19/17
7.11			MECHAN	VICAL HOC	D DRAWING	1 or 4



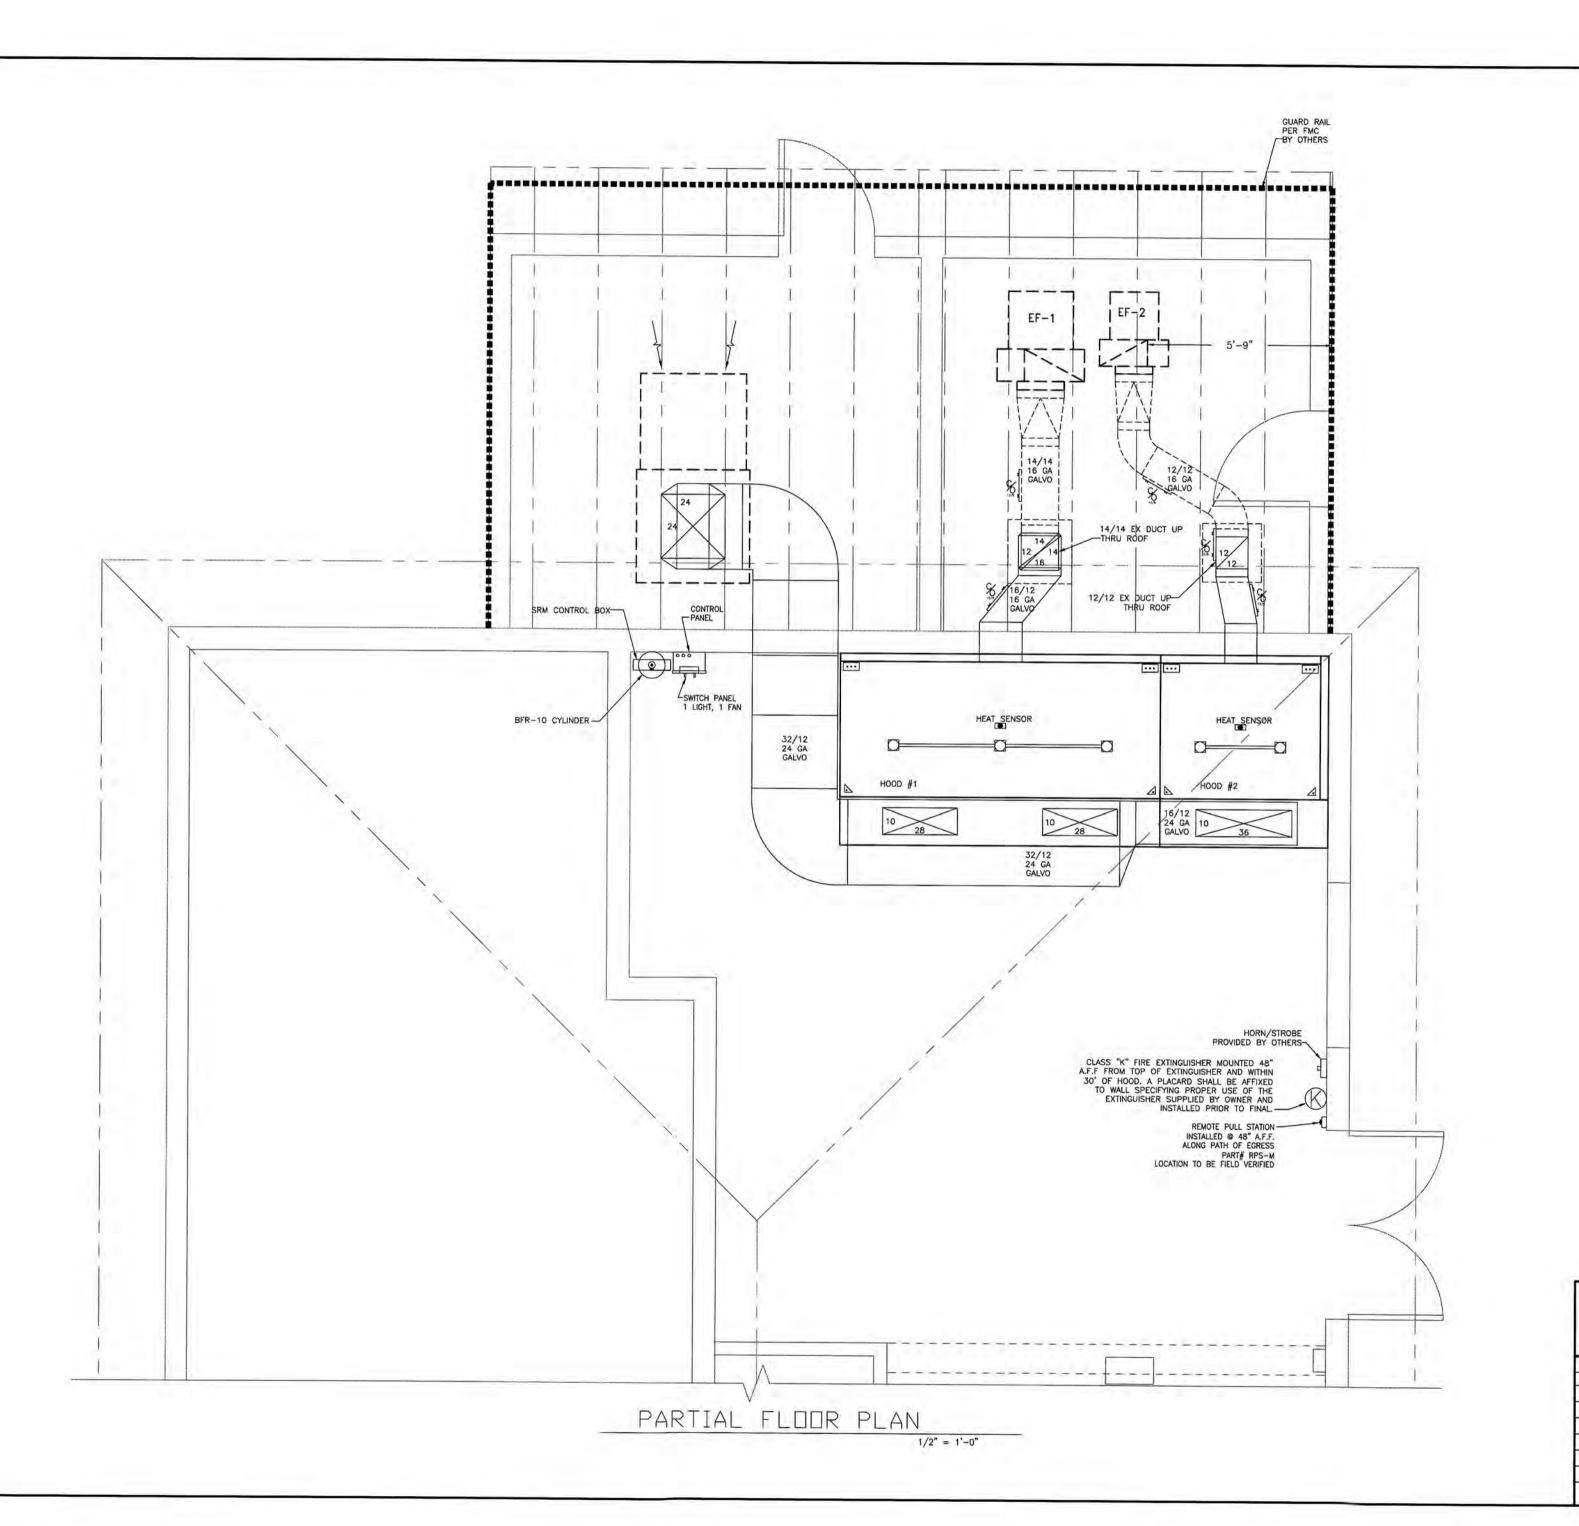

TOP OF HOOD CLEARANCE







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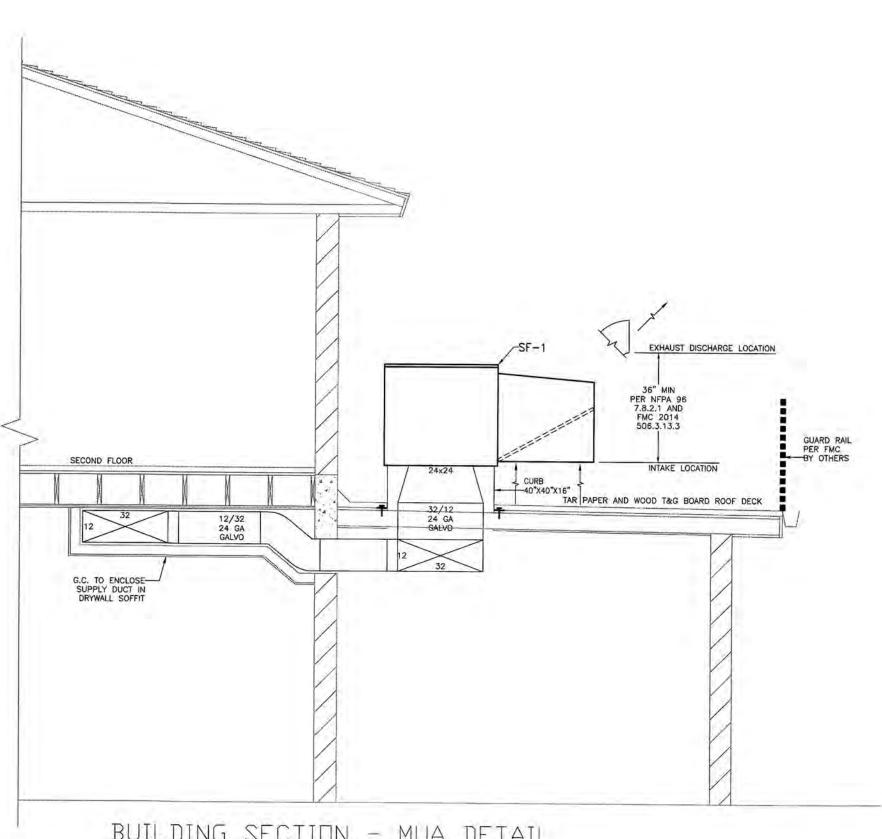
CHIEF ENGINEER RODNEY L FRITZ, P.E. PH# 800-322-8730 LICENSE # 0050003 CERTIFICATE OF AUTHORIZATION #29593

REVISIONS			11005		O.T. 11.1-21	11.10
NUMBER	DESCRIPTION	DATE	710 SOUTH	POWERLINE	OT INT'I rd. #h deerfieli	_ INC. D BEACH, FL
			JOB NAME: C 517 TRUI	AFE S	517 KEY WEST, FL	IN-3995
			SCALE: NOTED	DRAWN BY: MAC	CHECK BY:	DATE: 04/19/17
			MECHAI	VICAL HOO	D DRAWING	2 OF 4



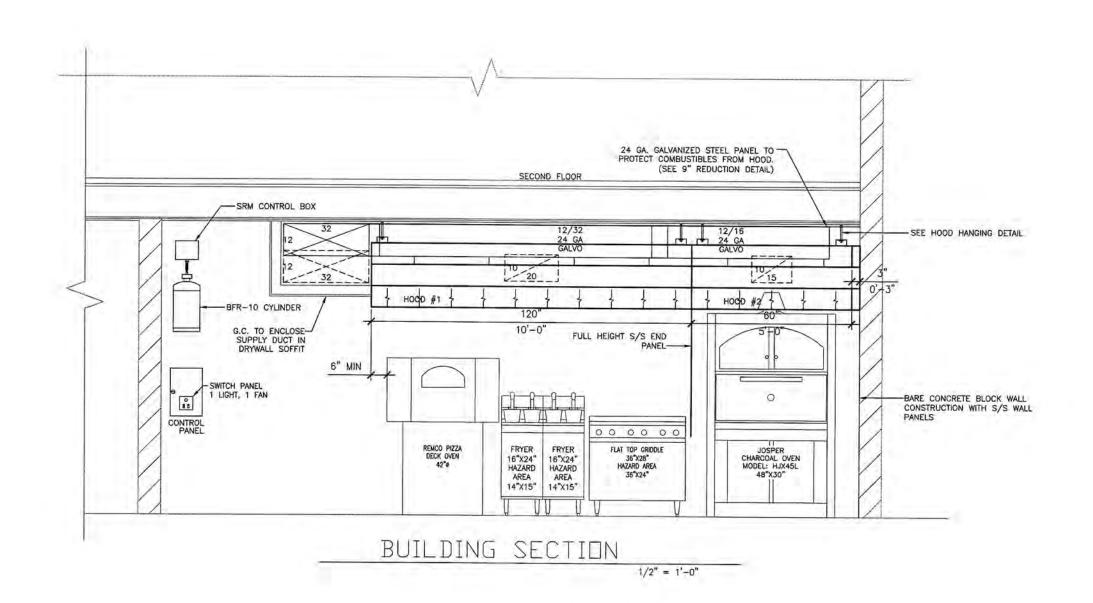

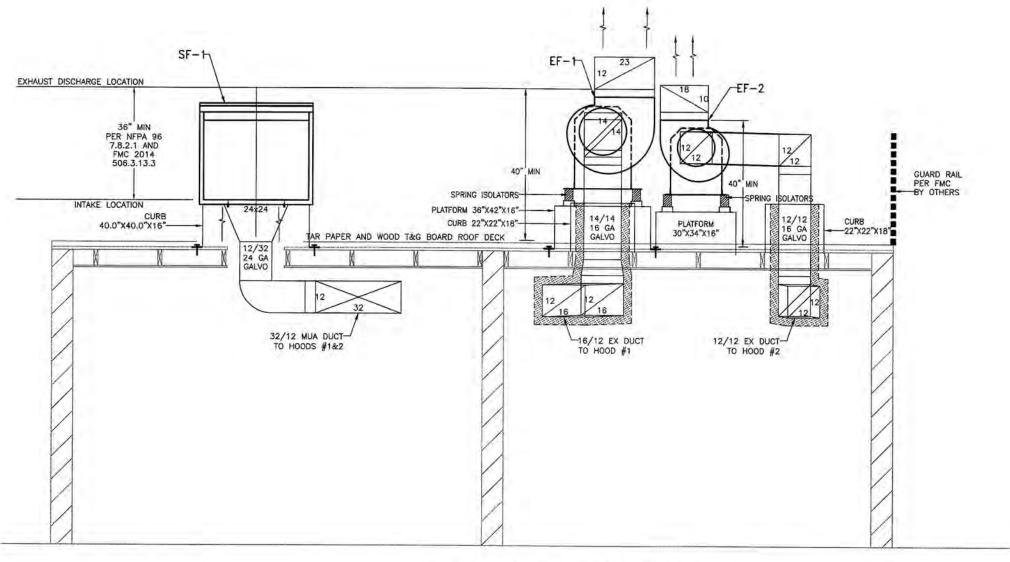BUILDING SECTION



BUILDING SECTION - MUA DETAIL 1/2" = 1'-0"


9" CLEARANCE REDUCTION METHOD PER FMC 308.6



THERMAL CERAMICS - "FIRE MASTER" / FASTWRAP+
INSTALLED PER MANUFACTURER'S SPECS

SBCCI — REPORT 21.51 ASTME2336 — COMPLIES NFPA96 — COMPLIES IMC — COMPLIES W/ SECTION 506 & 507

EXHAUST DUCT FIRE WRAP DETAIL N.T.S.

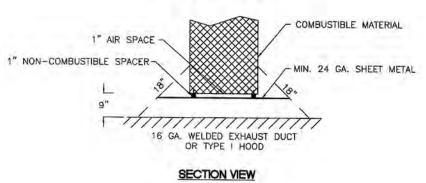









710 SOUTH POWERLINE ROAD DEERFIELD BEACH, FL. 33442 E-MAIL: HOODDEPOT@AOL.COM


CHIEF ENGINEER RODNEY L FRITZ, P.E. PH# 800-322-8730 LICENSE # 0050003 CERTIFICATE OF AUTHORIZATION #29593

	REVISIONS		11005	0 - 0	O.T. 11.1-7.	11.10
NUMBER	DESCRIPTION	DATE	710 SOUTH	POWERLINE	OT INT'L rd. #h deerfieli	
			JOB NAME: C, 517 TRUN	AFE !	517 KEY WEST, FL	IN-3995
			SCALE: NOTED	DRAWN BY: MAC	CHECK BY: RLF	DATE: 04/19/17
			MECHAN	NICAL HOC	D DRAWING	3 of 4

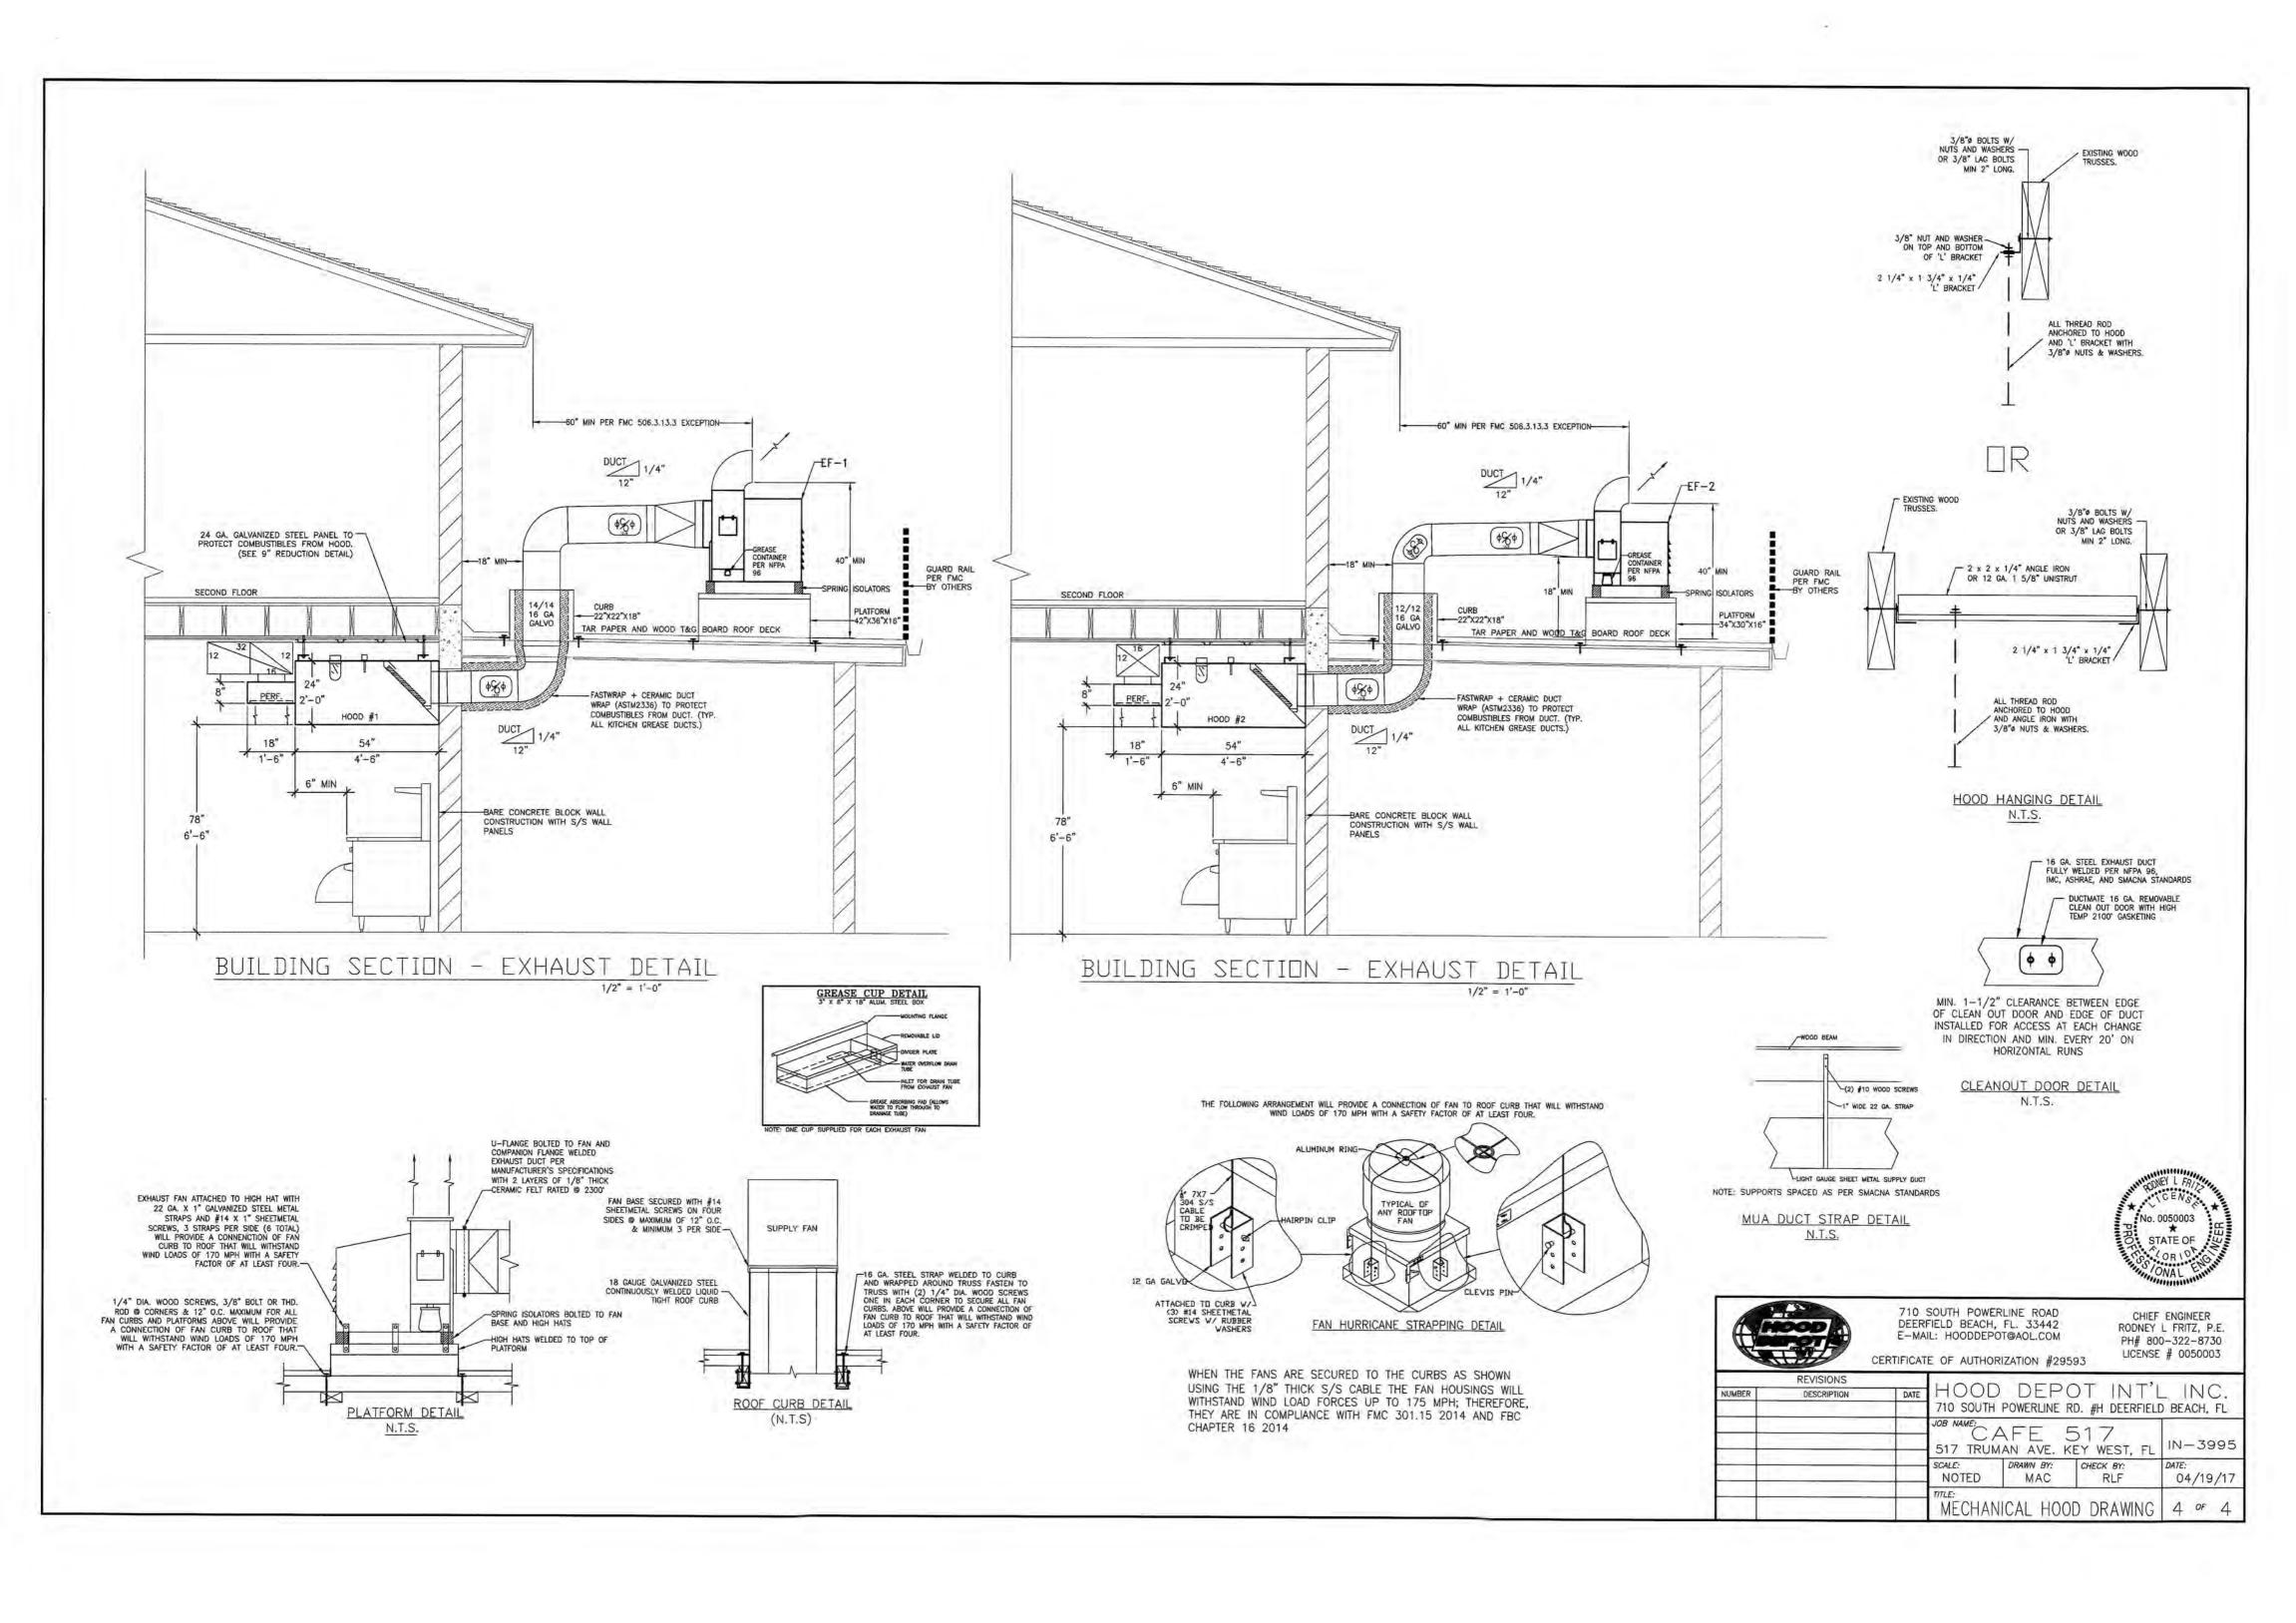

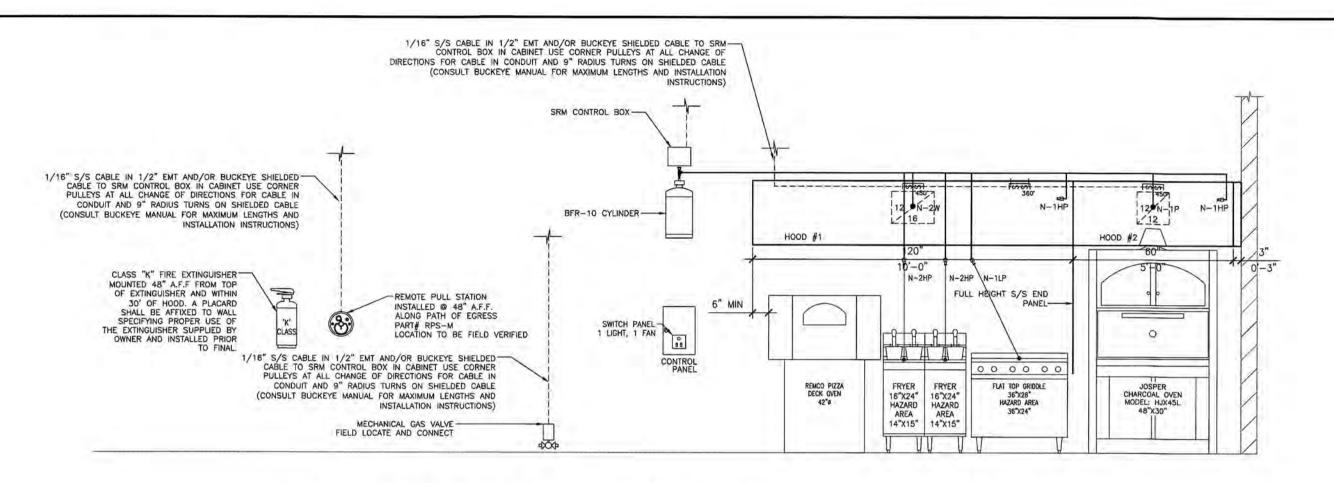

FIRE SUPPRESSION ELEVATION VIEW

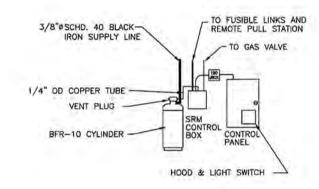


CONTROL PANEL & DOUBLE MICROSWITCH PROVIDED BY HOOD DEPOT. CONTROL PANEL PRE-WIRED TO LIGHT SWITCH, HOOD SWITCH, AND ONE FIRE SYSTEM MICROSWITCH. THE CONTROL PANEL IS PRE-WIRED TO SHUTDOWN MUA AND TURN ON EXHAUST IN CASE OF FIRE. ALL OTHER CONNECTIONS ARE TO BE MADE BY OTHERS. THERE IS AN ADDITIONAL SPDT MICROSWITCH (DRY CONTACTS) PRE-WIRED TO THE J-BOX FOR FIRE ALARM ACTIVATION. FOR OTHER REQUIREMENTS SUCH AS HE SHUTDOWN OF ELECTRIC APPLIANCES AND RECEPTACLES UNDER HOOD, GAS SOLENOID ACTIVATION. AND ANY OTHER REQUIREMENTS BY NATIONAL, STATE, OF LOCAL AUTHORITIES HAVING JURISICTION USE TERMINALS NC AND NO IN THE CONTROL PANEL AS REQUIRED. NC/NO IN THE CONTROL PANEL HAVE 115V/1PHASE AND ARE DEACTIVATED/ACTIVATED (RESPECTIVELY) UPON FIRE


NOTE: IF THERE IS NO BUILDING ALARM IT MAY BE REQUIRED TO PROVIDE A HORN TO BE SOUNDED


UL-300 LISTED	GENERAL NOTES: FOR PIPING ALLOWANCES BUCKEYE TECHNICAL MANUAL-U.L. FILE EXO SHALL CONFORM TO THE REQUIREMENTS O APPLICABLE STATE AND LOCAL CODES.	885. THE SYSTEM INSTALLATION		MAXIMUM FLOW POINTS: BFR-5: 5 FLOW POINTS BFR-10: 10 FLOW POINTS BFR-12: 15 FLOW POINTS BFR-20: 20 FLOW POINTS			
		BUCKEYE B	FR SCHEDULE			BFR	-10
NOZZLE	APPLICATION	COVERAGE	NOZZLE LIMITATIONS	SPECIAL NOTES FOR COVERAGE	FLOW	TAN	K1
NOZZLE APPLICATION	APPLICATION	APPLICATION	NOZZEE LIMITATIONS	SPECIAL NOTES FOR COVERAGE	POINTS	QTY	F,P
N-1LP	DUCT (50")	50" PERIMETER	UNLIMITED	CENTER OF DUCT	1	1	1
N-2W	DUCT (150")	150" PERIMETER	UNLIMITED	CENTER OF DUCT	2	1	2
N-1HP	PLENUM	MAX. 12' LONG	N/A	"V" BANK OR SINGLE	1	2	2
N-2HP	SINGLE VAT FRYER (dripboards up to 6")	20.25" X 24"	24" MIN / 45" MAX	ANYWHERE WITHIN PERIMETER	2	2	4
N-1LP	GRIDDLE	42" X 30"	24" MIN / 48" MAX	ON PERIMETER	1	1	1
	TOTAL NOZZLE COUNT	7		TOTAL FLOW POINTS			10

FIRE CABINET/FIRE SYSTEM DETAILS

BU	CKEYE PARTS	LEGEND
SYMBOL	DESCRIPTION	BUCKEYE P/N
ļ	APPLIANCE NOZZLE	N-1HP, N-1LP N-2HP, N-2LP
l _e ,	PLENUM NOZZLE	N-1HP
ø	50IN PERIMETER DUCT NOZZLE	N-1LP
φ	150IN PERIMETER DUCT NOZZLE	N-2W
&	REMOTE PULL STATION	RPS-M
	GAS VALVE	.75", 1", 1.25", 1.5 2", 2.5", 3".

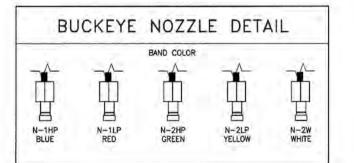

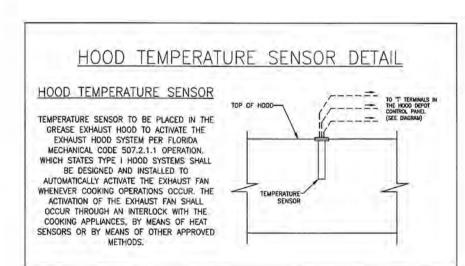

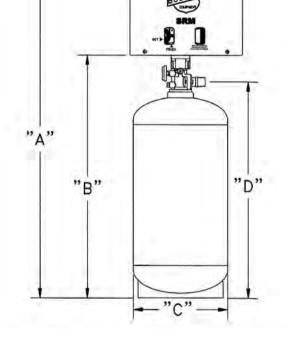

Model Number	A inches (cm)	B inches (cm)	C inches (cm)	D inches (cm)	Max. Flow Points	Weight Ibs. (kg)	Mounting Bracket
BFR-10	34.4 (87)	25.8 (66)	10 (25)	23 (58)	10	74 lbs. (33)	MB-2

CYLINDER AND VALVE ASSEMBLY DIMENSIONS

REQUIREMENTS BY ELECTRICAL CONTRACTOR

WIRE EACH FAN CIRCUIT FROM CIRCUIT BREAKER TO LINE SIDE OF CONTACTOR IN CONTROL PANEL.
WIRE EACH FAN FROM LOAD SIDE OF CONTACTOR IN CONTROL PANEL TO DISCONNECT SWITCHES ON FAN.
DISCONNECT SWITCHES PROVIDED ON FANS,
WIRE A 120V 20 AMP CONTROL CIRCUIT TO TERMINALS L AND N IN CONTROL PANEL.
IF THERE IS NO FIRE ALARM PRESENT IN THE BUILDING THEN WIRE FROM CONTROL PANEL TERMINALS NO AND

IF THERE IS NO FIRE ALARM PRESENT IN THE BUILDING THEN WIRE FROM CONTROL. PANEL TERMINALS NO AND NOTO HORN/STROBE DEVICE IN KITCHEN. 120V HORN/STROBE DEVICE TO BE PROVIDED BY ELECTRICAL CONTRACTOR.
 WIRE FROM CONTROL PANEL TERMINALS NO AND NOTO SHUNT TRIP BREAKERS IN CIRCUIT BREAKER PANEL. ALL ELECTRICAL OUTLETS AND APPLIANCES UNDER THE HOOD NEED TO SHUT DOWN UPON FIRE SYSTEM ACTIVATION. SHUNT TRIP BREAKERS PROVIDED BY ELECTRICAL CONTRACTOR. ELECTRICAL POWER UNDER THE HOOD CAN ALSO BE SHUT DOWN USING RELAYS OR CONTACTORS WIRED TO TERMINALS NO AND N.
 FIRE ALARM CONNECTIONS —IF A FIRE ALARM IS PRESENT IT NEEDS TO BE CONNECTED TO THE SPARE HERSENT OF THE PANEL OF

MICROSWITCH (DRY CONTACTS). WIRES FOR MICROSWITCH ARE LOCATED IN THE 190 JBOX NEAR THE FIRE SYSTEM CONTROL HEAD. IF A BUILDING FIRE ALARM IS PRESENT A HORN/STROBE DEVICE IS NOT REQUIRED.

HEAT SENSORS NEED TO BE WIRED FROM EACH HOOD TO CORRESPONDING TERMINAL BLOCKS IN CONTROL

 LIGHTS ARE PRE WIRED ON TOP OF EACH HOOD TO A SINGLE JUNCTION BOX. WIRING NEEDS TO BE PROVIDED AND INSTALLED IN BETWEEN HOOD SECTIONS AND FROM THE HOOD TO THE CONTROL PANEL AND CONNECT TO TERMINALS 14 AND 15.

 WHEN THERE IS NOT A FIRE CABINET BUILT INTO OUR HOOD THE MICRO SWITCH MUST BE WIRED FROM THE FIRE SYSTEM CONTROL HEAD TO DUR CONTROL PANEL. THE COM WIRE (BLUE) GOES TO TERMINAL C IN OUR PANEL, THE NORMALLY CLOSED WIRE (YELLOW) GOES TO TERMINAL NC IN OUR PANEL AND THE NORMALLY

OPEN WIRE (BROWN) GOES TO TERMINAL NO IN CONTROL PANEL.

10. FIRE SYSTEMS IN TYPE I HOODS THAT SHARE A FIRE HAZARD AREA MUST ACTIVATE SIMULTANEOUSLY.

GENERAL FIRE SYSTEM NOTES

1. NO GALVANIZED PIPE TO BE USED ONLY USE SCHEDULE 40 BLACK IRON PIPE PER NFPA #17A

2 SYSTEM TO HAVE AUDIBLE/VISUAL DEVICE TO SOUND UPON ACTUATION OF FIRE SUPPRESSION SYSTEM. (INSTALLED AND PROVIDED BY ELECTRICIAN)

3. ALL HOOD PENETRATIONS TO BE WELDED LIQUID TIGHT OR SHALL USE A UL LISTED SEAL PER NFPA #17A

4. ALL MOTORS, LIGHTS AND OTHER ELECTRICAL DEVICES INSTALLED IN TYPE I HOODS OR DUCTS ARE SPECIFICALLY APPROVED FOR SUCH USE

5. FIXED PIPE EXTINGUISHING SYSTEMS IN A SINGLE HAZARD AREA SHALL BE ARRANGED FOR SIMULTANEOUS AUTOMATIC OPERATION UPON ACTIVATION OF ANY ONE OF THE SYSTEM COMMON EXHAUST DUCT FOR MORE THAN ONE HOOD WOULD DEFINE A SINGLE HAZARD AREA EXCEPTION WOULD BE A SECONDARY FIRE SUPPRESSION SYSTEM CONTAINED IN THE COMMON EXHAUST.

HOOD AND FANS OPERATIONS

FIRE MODE REQUIRES EXHAUST FAN TO OPERATE AND SUPPLY FAN STOPS.

SUPPLY AND EXHAUST FANS ARE INTERLOCKED WITH PILOT-LIGHTED SWITCH IN KITCHEN AREA. HOOD EXHAUST FANS SHALL OPERATE

WHENEVER THE FIRE EXTINGUISHING SYSTEM IS ACTIVATED (EVEN WHEN HOOD SWITCH IS IN OFF POSITION).

ALL ELECTRIC AND GAS TO ALL EQUIPMENT AND RECEPTACLES UNDER THE HOOD SHALL SHUT DOWN UPON FIRE SYSTEM ACTIVATION

SYSTEM TO HAVE REMOTE PULL STATION FOR MANUAL MEANS OF ACTUATION AND FUSIBLE LINKS FOR AUTOMATIC MEANS OF ACTUATION PER NFPA 17A






710 SOUTH POWERLINE ROAD DEERFIELD BEACH, FL. 33442 E-MAIL: HOODDEPOT@AOL.COM

CHIEF ENGINEER RODNEY L FRITZ, P.E. PH# 800-322-8730 LICENSE # 0050003

CERTIFICATE OF AUTHORIZATION #29593

	REVISIONS		HD SERVICE DIVISION				
NUMBER	DESCRIPTION	DATE	HD :	2FK AL	CE DIV	12101	
			710 S PO	WERLINE RD	#H DEERFIELD	BEACH, FL	
			JOB NAME: 517 TRUM	AFE S	517 KEY WEST, FL	IN-3995	
			SCALE: NOTED	DRAWN BY: MAC	CHECK BY: RLF	DATE: 04/19/17	
			FIRE SU	JPPRESSI ¹	ON SYSTEM	1 of 2	

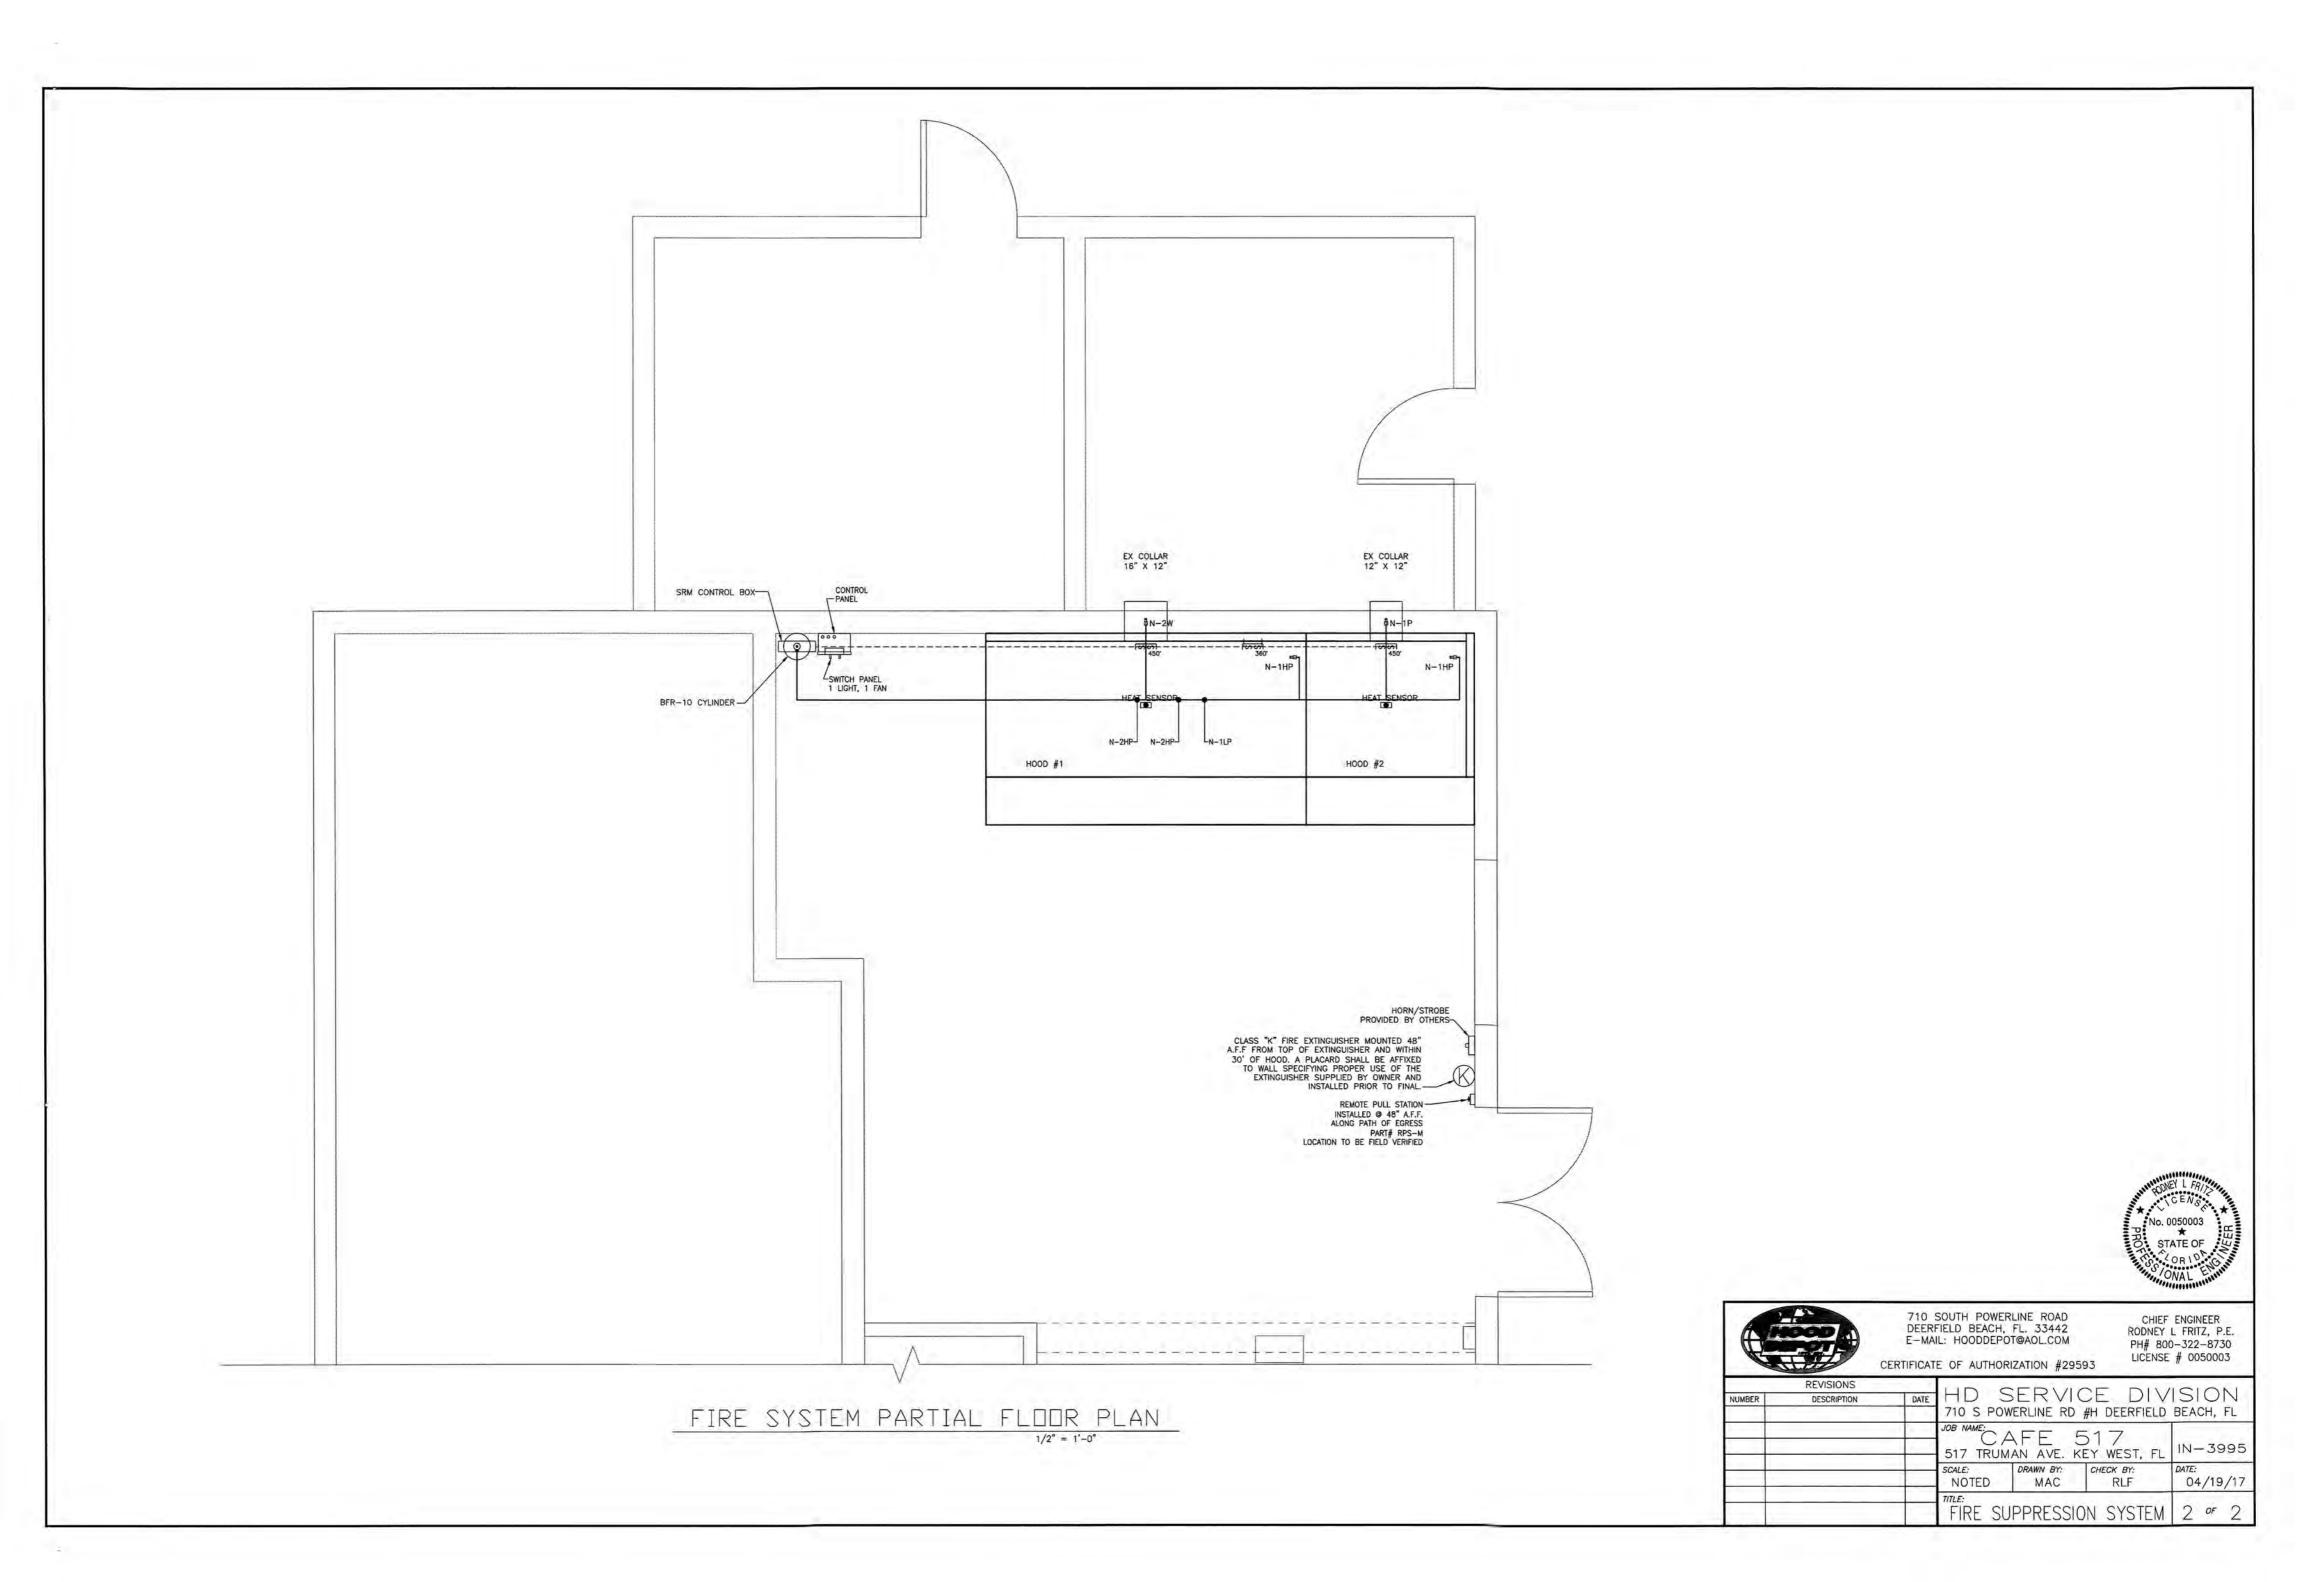

The Historic Architectural Review Commission will hold a public hearing <u>at 5:30 p.m., April 24, 2018 at Key West</u> <u>City Hall, 1300 White Street</u>, Key West, Florida. The purpose of the hearing will be to consider a request for:

NEW MECHANICAL EQUIPMENT INCLUDING TWO KITCHEN HOOD SYSTEMS AND REQUIRED SAFETY RAILINGS

FOR #517 TRUMAN AVENUE

Applicant – Hood Depot

Application #18-0227

If you wish to see the application or have any questions, you may visit the Planning Department during regular office hours at 1300 White Street, call 305-809-3975 or visit our website at www.cityofkeywest-fl.gov.

THIS NOTICE CAN NOT BE REMOVED FROM THE SITE UNTIL HARC FINAL DETERMINATION

ADA ASSISTANCE: It is the policy of the City of Key West to comply with all requirements of the Americans with Disabilities Act (ADA). Please call the TTY number at 800-955-8771 or 800-955-8770 (Voice) or the ADA Coordinator at 305-809-3731 at least five business days in advance for sign language interpreters, assistive listening devices, or materials in accessible format.

PROPERTY APPRAISER INFORMATION



Disclaimer

The Monroe County Property Appraiser's office maintains data on property within the County solely for the purpose of fulfilling its responsibility to secure a just valuation for ad valorem tax purposes of all property within the County. The Monroe County Property Appraiser's office cannot guarantee its accuracy for any other purpose. Likewise, data provided regarding one tax year may not be applicable in prior or subsequent years. By requesting such data, you hereby understand and agree that the data is intended for ad valorem tax purposes only and should not be relied on for any other purpose.

By continuing into this site you assert that you have read and agree to the above statement.

Summary

Parcel ID 00017770-000000 1018228 Account # Property ID 1018228 Millage Group 10KW

Location 517 TRUMAN Ave, KEY WEST

Address

KW PT LOT 4 SQR 8 TR 4 OR304-10 OR401-724/725 OR525-802/803 Legal

OR803-292/293 OR808-420 OR818-2026 CASE #79-834-CA-04 OR1480-416/417 Description

OR1613-1705/06T/C OR1889-1499/1500 OR2049-492/495 OR2739-419/20

(Note: Not to be used on legal documents)

Neighborhood 32080

Property Class

STORE COMBO (1200)

Subdivision Sec/Twp/Rng

06/68/25 Affordable

Housing



Owner

GEO AND 517 TRUMAN LLC 517 Truman Ave Key West FL 33040

Valuation

	2017	2016	2015	2014
+ Market Improvement Value	\$389,609	\$368,641	\$413,836	\$422,993
+ Market Misc Value	\$3,836	\$4,013	\$2,464	\$2,240
+ Market Land Value	\$773,674	\$615,987	\$263,194	\$263,194
= Just Market Value	\$1,167,119	\$988,641	\$679,494	\$688,427
= Total Assessed Value	\$1,087,505	\$988,641	\$679,494	\$688,427
- School Exempt Value	\$O	\$0	\$0	\$0
= School Taxable Value	\$1,167,119	\$988,641	\$679,494	\$688,427

Land

Land Use	Number of Units	Unit Type	Frontage	Depth
(1200)	4,280.00	Square Foot	40	107

Commercial Buildings

HOTEL/MOTEL C / 39C Style

Gross Sa Ft 4.465 Finished Sq Ft 3,916 Perimiter Stories Interior Walls **Exterior Walls** C.B.S.

Quality 400 () Roof Type

Roof Material

Exterior Wall1

Exterior Wall2 Foundation Interior Finish **Ground Floor Area** Floor Cover **Full Bathrooms** Half Bathrooms **Heating Type**

Year Built 1963

Year Remodeled

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Effective Year Built 1985 Condition

Code	Description	Sketch Area	Finished Area	Perimeter
FLA	FLOOR LIV AREA	3,916	3,916	0
OUU	OP PR UNFIN UL	112	0	0
OPF	OP PRCH FIN LL	99	0	0
SBF	UTIL FIN BLK	338	0	0
TOTAL		4.465	3.916	0

HOTEL/MOTEL C / 39C Style

Gross Sq Ft 600 $Finished \, Sq \, Ft$ 544 Perimiter 0 Stories 1

Interior Walls

WALL BD/WD WAL MIN WOOD SIDING with 10% AVE WOOD SIDING 350 () Exterior Walls

Quality Roof Type GABLE/HIP Roof Material METAL

Exterior Wall1 MIN WOOD SIDING AVE WOOD SIDING CONC BLOCK Exterior Wall2 Foundation Interior Finish WALL BD/WD WAL

Ground Floor Area

Floor Cover CONC S/B GRND

Full Bathrooms 0 Half Bathrooms 0

NONE with 0% NONE **Heating Type**

Year Built 1913 Year Remodeled Effective Year Built 1960 AVERAGE Condition

Code	Description	Sketch Area	Finished Area	Perimeter
FLA	FLOOR LIV AREA	544	544	0
OPF	OP PRCH FIN LL	56	0	0
TOTAL	·	600	544	0

Yard Items

Description	Year Built	Roll Year	Quantity	Units	Grade
FENCES	1979	1980	1	180 SF	4
WALL AIR COND	2005	2006	1	1 UT	1
WALL AIR COND	2012	2013	1	2 UT	2
PATIO	1963	1964	1	450 SF	2

Sales

Sale Date	Sale Price	Instrument	Instrument Number	Deed Book	Deed Page	Sale Qualification	Vacant or Improved
5/5/2015	\$1,800,000	Warranty Deed		2739	419	01 - Qualified	Improved
4/14/2003	\$74,000	Quit Claim Deed		1889	1499	P - Unqualified	Improved
1/13/2000	\$500,000	Warranty Deed		1613	1705	Q - Qualified	Improved
10/1/1997	\$590,500	Warranty Deed		1480	0416	Q - Qualified	Improved
2/1/1972	\$50,000	Conversion Code		803	292	Q - Qualified	Improved

Permits


Number ♦	Date Issued 🕏	Date Completed 🕏	Amount ♦	Permit Type 🕏	Notes ♦
15-4288	11/3/2015		\$4,000	Commercial	RELOCATE 2 CONDENSORS TO ROOF. INSTALL 1 MINI SPLIT TO OFFICE.
03-3346	9/18/2003	10/7/2003	\$5,051		REPLACMENT OF WINDOWS
03-3102	9/3/2003	7/28/2004	\$2,400		SEWAGE
02-3071	11/26/2002	10/7/2003	\$2,000		REPLACE SEWER LINE
0001453	5/26/2000	8/11/2000	\$550		INSTALL LAVATORY
0000963	4/25/2000	8/11/2000	\$400		PAINT BUILDING
0000964	4/20/2000	8/11/2000	\$2,500		PAINT BUILDING
0000943	4/12/2000	8/11/2000	\$450		REPLACE RISER/CAN
9903654	10/29/1999	11/29/1999	\$8,255		ROOF REPAIRS
9801331	4/23/1998	12/1/1998	\$1,800		RENOVATE FRONT PORCH
9800689	3/6/1998	12/1/1998	\$2,800		RENO KITCHEN
9800679	3/3/1998	12/1/1998	\$1,200		ELECTRICAL
9800457	2/11/1998	12/1/1998	\$1,500		REPLACE EXIST FIXTURES
9704167	12/18/1997	12/1/1998	\$3,000		RENOVATIONS
9603898	9/1/1996	12/1/1996	\$1,500		ROOF
E954121	11/1/1995	12/1/1995	\$2,700		INSTL 225AMP & 225AM SBFD

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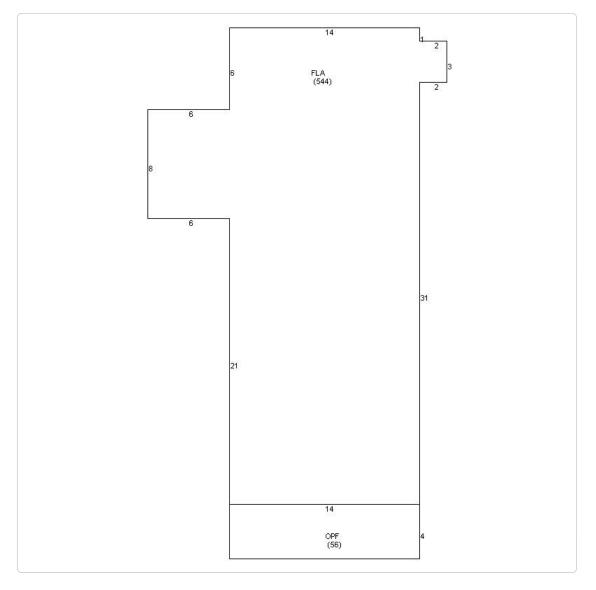
Notes ♦	Permit Type ◆	Amount ♦	Date Completed ♦	Date Issued ♦	Number ♦
PARTITION WALL FOR BATH		\$3,600	10/1/1995	3/1/1995	B950777
ELECTRICAL OUTLETS/SWITCH		\$200	10/1/1995	3/1/1995	E951057
NEW PLUMBING FIXTURES		\$3,000	10/1/1995	3/1/1995	P950817

Sketches (click to enlarge)

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Photos



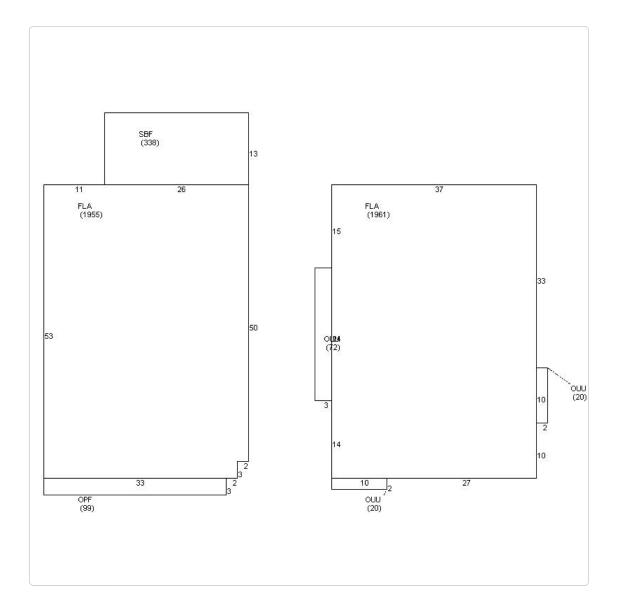

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No data available for the following modules: Buildings, Mobile Home Buildings, Exemptions.

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