KEYS OVERNIGHT TEMPORARY SHELTER (KOTS)

5537 COLLEGE ROAD, KEY WEST, FL 33040



PROJECT LIMITS




SITE DATA				
SITE AREA: ACRES)	XXX,XXX S.F. (X.XXX			
LAND USE: P5				
FLOOD ZONE: AE EL +10.0'				
FAR: XX DENSITY: ALI	LOWED = XX UNITS/ACRE			
	ALLOWED = 60' PROPOSED = XX'			
SETBACKS:				
	T SETBACK: REQUIRED = 20' PROPOSED = XX'			
	H SIDE SETBACK: REQUIRED = 15' PROPOSED = XX'			
	H SIDE SETBACK: REQUIRED = 15' PROPOSED = XX'			
	SETBACK: REQUIRED = 20' PROPOSED = XX'			
BUILDING CO	DVERAGE AREA:			
	ALLOWED = ?? S.F. PROPOSED = 9,600 S.F.			
IMPERVIOUS	AREA:			
	ALLOWED = S.F. PROPOSED = S.F.			
LANDSCAPE	AREA:			
	REQUIRED = S.F. PROPOSED = S.F.			
OPEN SPACE	E AREA:			
	REQUIRED = S.F. PROPOSED = S.F.			
PARKING:				
	REQUIRED = N/A PROPOSED = 8 SPACES			
BIKE:				
	REQUIRED = N/A PROPOSED = 100 SPACES			
BUILDING DATA				
FLORIDA BU	ILDING CODE INFORMATION			
CONSTRUCT ALLOWABLE ALLOWABLE	Y TYPE: R-1 -TRANSIENT TION TYPE: IIB/SPRINKLERED E HEIGHT: 60' E NUMBER OF STORIES: 4 E AREA/FLOOR: 16,000 S.F./FLOOR			
BUILDING A	ENCLOSED COVERED			
GROUND FLOOR 9,600 S.F. FIRST FLOOR 9,600 S.F				
TOTAL:	9,600 S.F. 9,600 S.F.			
	INDEX OF SHEETS			
PAGE	DESCRIPTION			
A.O.O1	COVER SHEET			
A.0.02	SURVEY			
A.1.00	PROPOSED CONCEPTUAL AERIAL SITE PLAN			
A.1.01	PROPOSED CONCEPTUAL GROUND FLOOR			
A.1.02	PROPOSED CONCEPTUAL FIRST FLOOR PLAN			

PROPOSED CONCEPTUAL ROOF PLAN

PROPOSED CONCEPTUAL EXTERIOR ELEVATIONS

PROPOSED CONCEPTUAL EXTERIOR ELEVATIONS

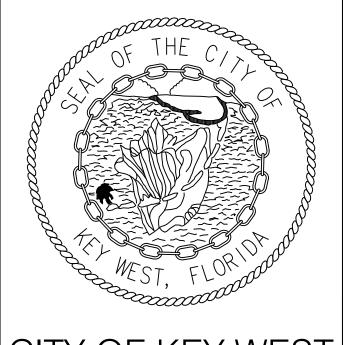

CITY OF KEY WEST

ENGINEERING SERVICES
1300 WHITE STREET, KEY WEST, FL

(S)

OVERNIGHT TEMPORARY SHELTEI
ss:
5537 COLLEGE ROAD,
KEY WEST, FLORIDA, 33040

Revision/Issue

DATE: 01/10/2020

SHEET NAME:

COVER SHEET

SHEET NUMBER:

A.0.01

N.T.S.






SURVEYOR'S REPORT:

- 1. The specific purpose of this survey is to show spot elevations and the fences relative to the approximate boundary lines. 2. Reproductions of this Sketch are not valid without the signature and the original raised seal of a Florida licensed surveyor
- and mapper. Additions or deletions to this survey map or report by other than the signing party is prohibited without 3. No Title Opinion or Abstract to the subject property has been provided. It is possible that there are Deeds, Easements, or
- other instruments (recorded or unrecorded) which may affect the subject property. No search of the Public Records has been made by the Surveyor.
- 4. Right—of—way lines and lot lines are graphically delineated from information obtained by this firm from recorded deeds, plats and right—of—way maps, at the time of the survey. This information is spatially placed within the digital file of the topographic survey, based on recovered monumentation to depict the lines relative to the topographic locations. This is not a boundary survey and the information should not be relied as such. It is strongly recommended that if the design is contingent on accurate boundary placement and especially prior to construction, a boundary survey should be performed to establish the lines. We will not be responsible for the misuse of the survey information for purposes it was not intended. No attempt was made to resolve conflicts between the recovered boundary information and occupational lines, if any.
- 5. No underground improvement were located. 6. a. Bearings shown hereon are referenced to Grid North, based on the 2011 Adjustment of the North American Datum of 1983, NAD 83 (2011) Epoch 2010.00 of the Florida State Plane Coordinate System (Transverse Mercator Projection), East
- b. Method: Wide Area Continuopusly Operating GPS Reference Station Network
 c. Equipment Used: Leica GS18 LTE & UHF Performance Smart Antenna, Serial Number 3602394
- d. Processing Software: Leica Infinity, Version 3.1.0.3188
- 7. Elevations shown hereon are based on the North American Vertical Datum of 1988. To convert elevations from NAVD 88 to NGVD 29, add algebraically (+) 1.34 feet to the elevation. Conversion factor was derived from the National Geodetic Survey (NGS) recovery Data Sheet for Tidal Benchmark "872 4527 F Tidal".
- 8. Benchmark Description: National Geodetic Survey Station Designation "872 4527 F TIDAL" (PID AA1629). Elevation=10.05 feet (NGVD 1929). Elevation=8.71 feet (NAVD 1988).
- 9. Units of measurement are in U.S. Survey Feet and decimal parts thereof. Well identified features in this survey were field measured to a horizontal positional accuracy of 0.10'. The elevations on impervious surfaces were field measured to 0.03'
- 10.Abbreviation Legend: F.B. = Field Book; I.R. = Iron Rod; L.B. = Licensed Business; NAVD = North American Vertical Datum; NGVD = National Geodetic Vertical Datum; P = Per Record Plat; P.B. = Plat Book; PG. = Page; W/CAP = With Surveyors

LEGEND BENCHMARKS ◆ 0.00 EXISTING ELEVATION

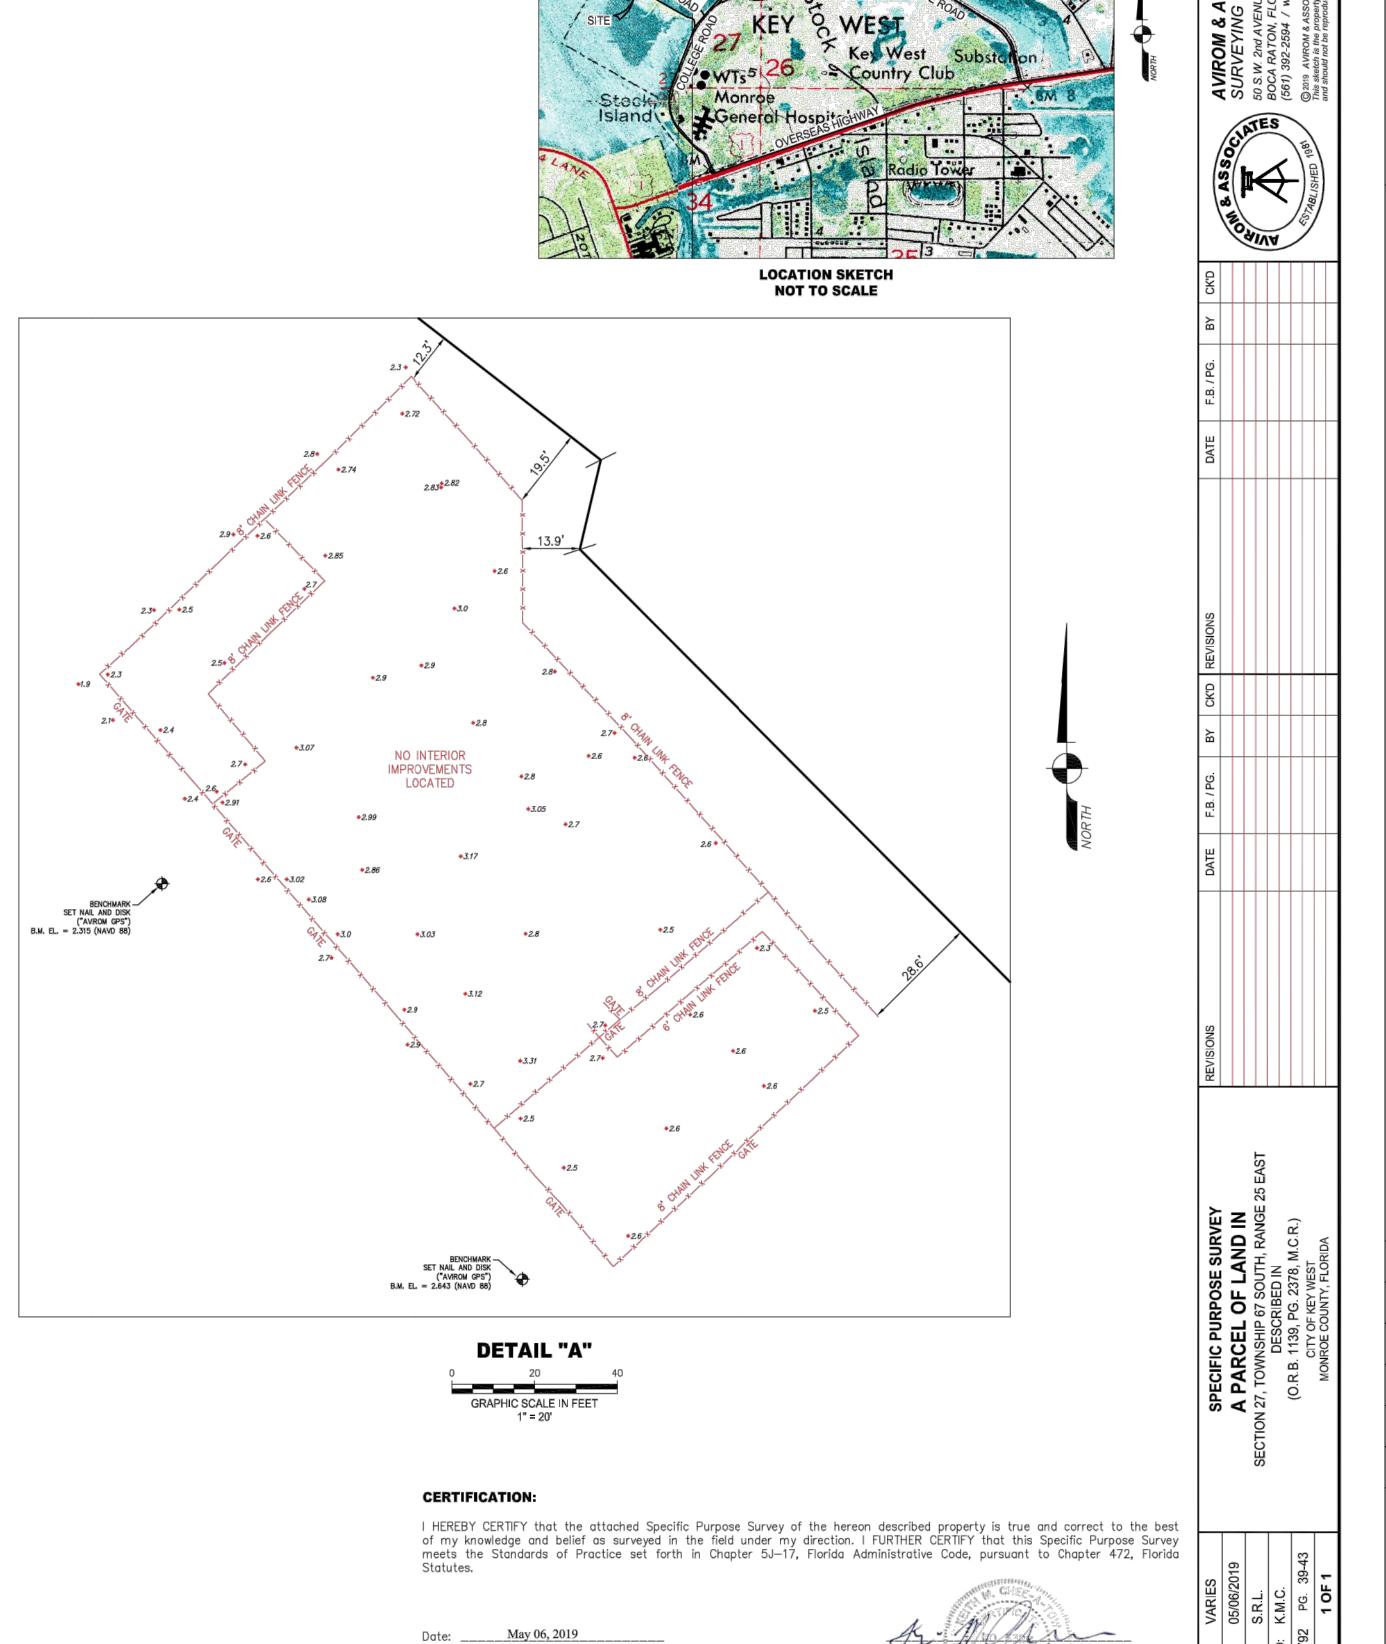

Digitally signed by Keith M.

Chee-A-Tow
Date: 2019.05.14 14:21:25 -04'00'

AVIROM & ASSOCIATES, INC.
L.B. No. 3300
EMAIL. keith@aviromsurvey.com

CITY OF KEY WEST

1300 WHITE STREET, KEY WEST, FL

33040

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Revision/Issue

DATE: 01/10/2020

SHEET NAME:


SURVEY


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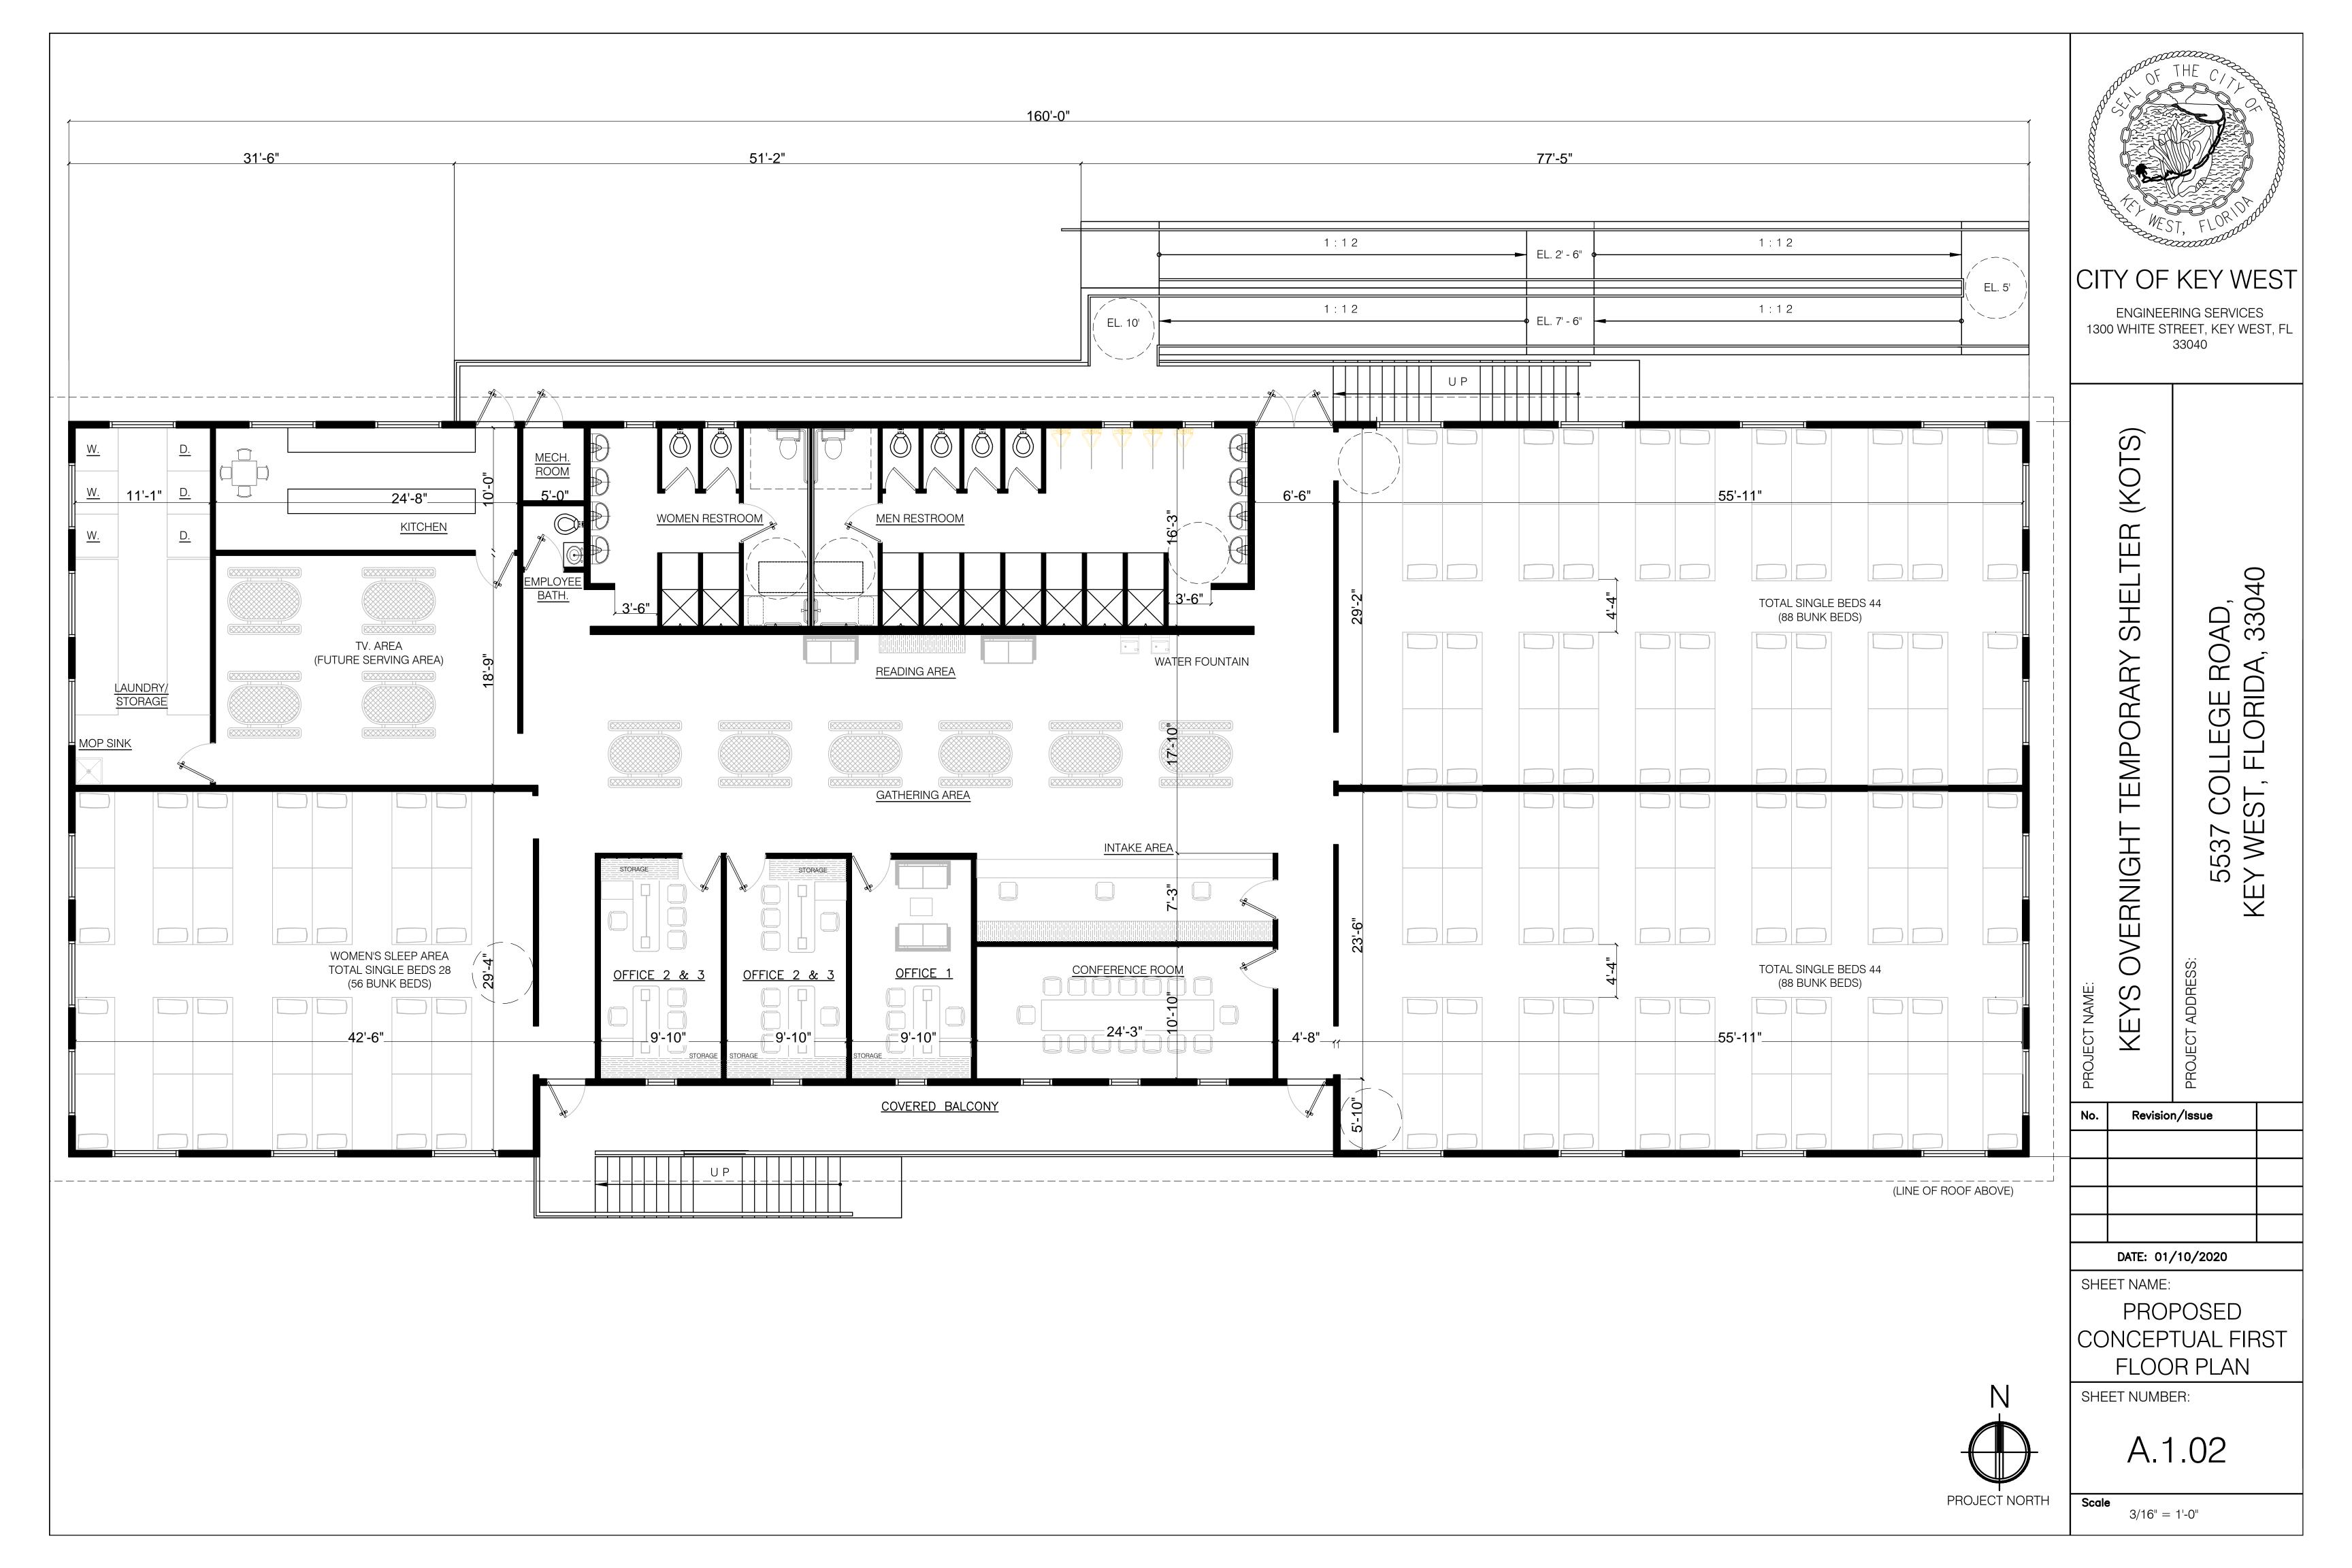
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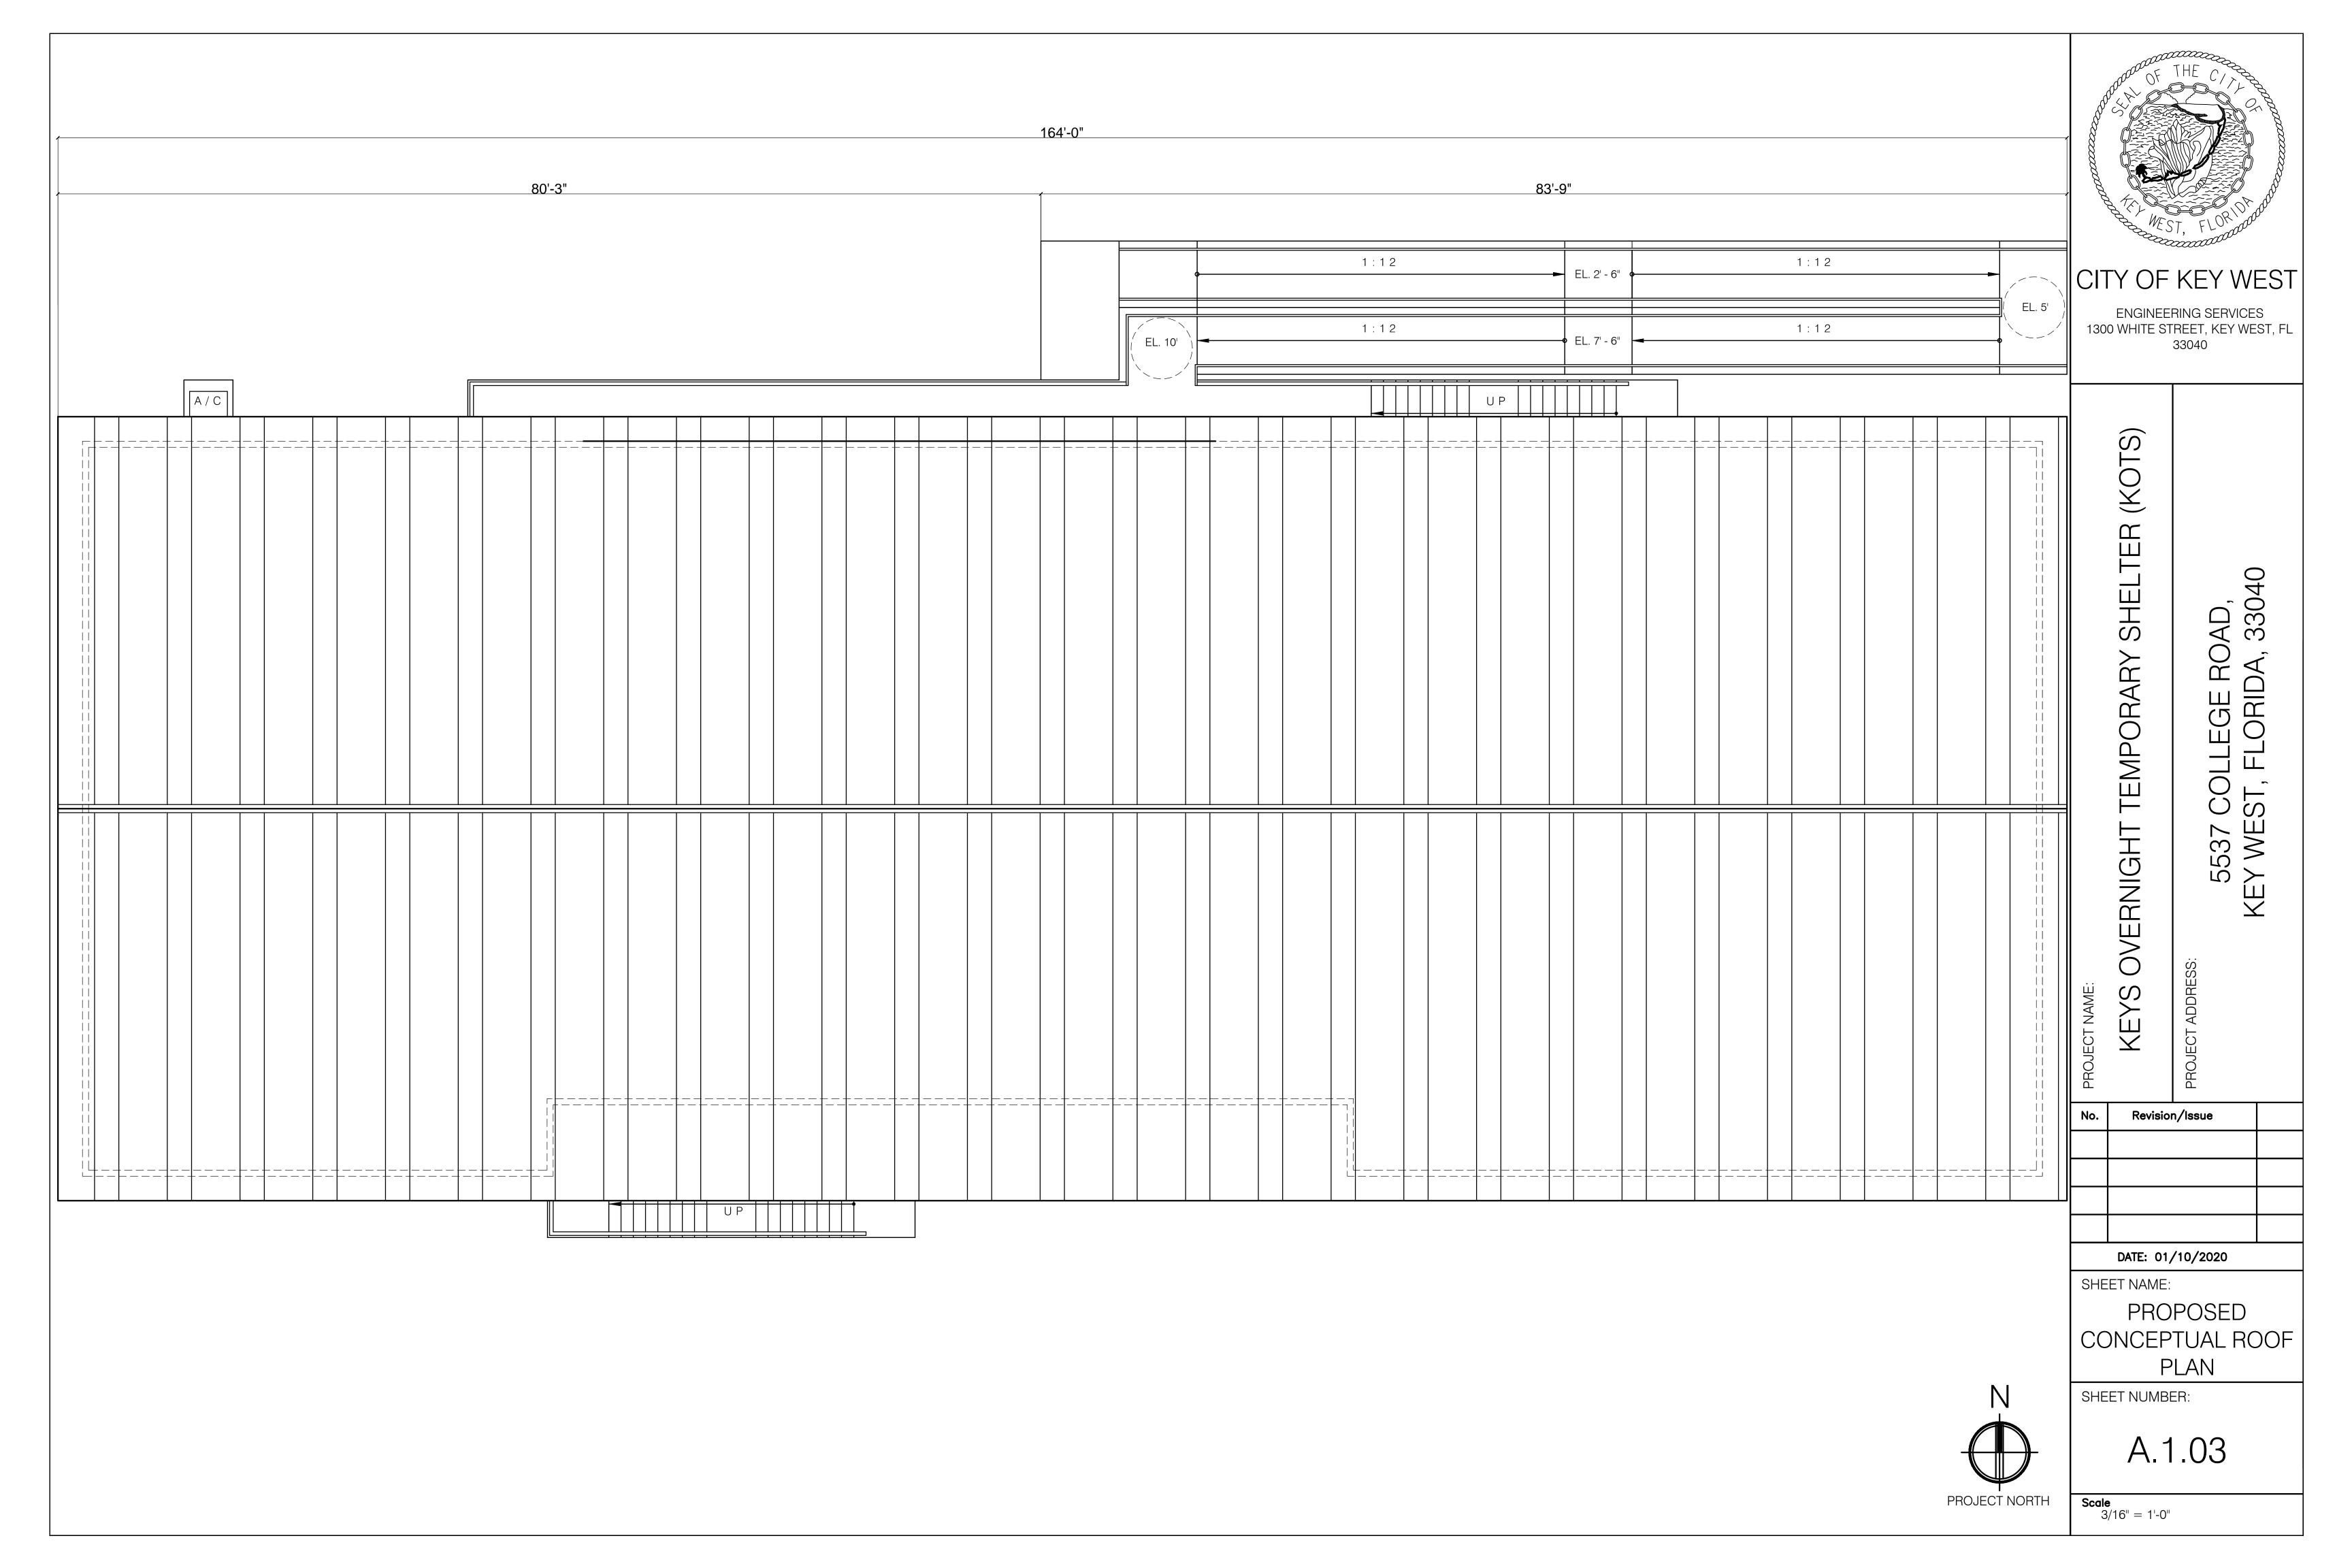
A.0.02


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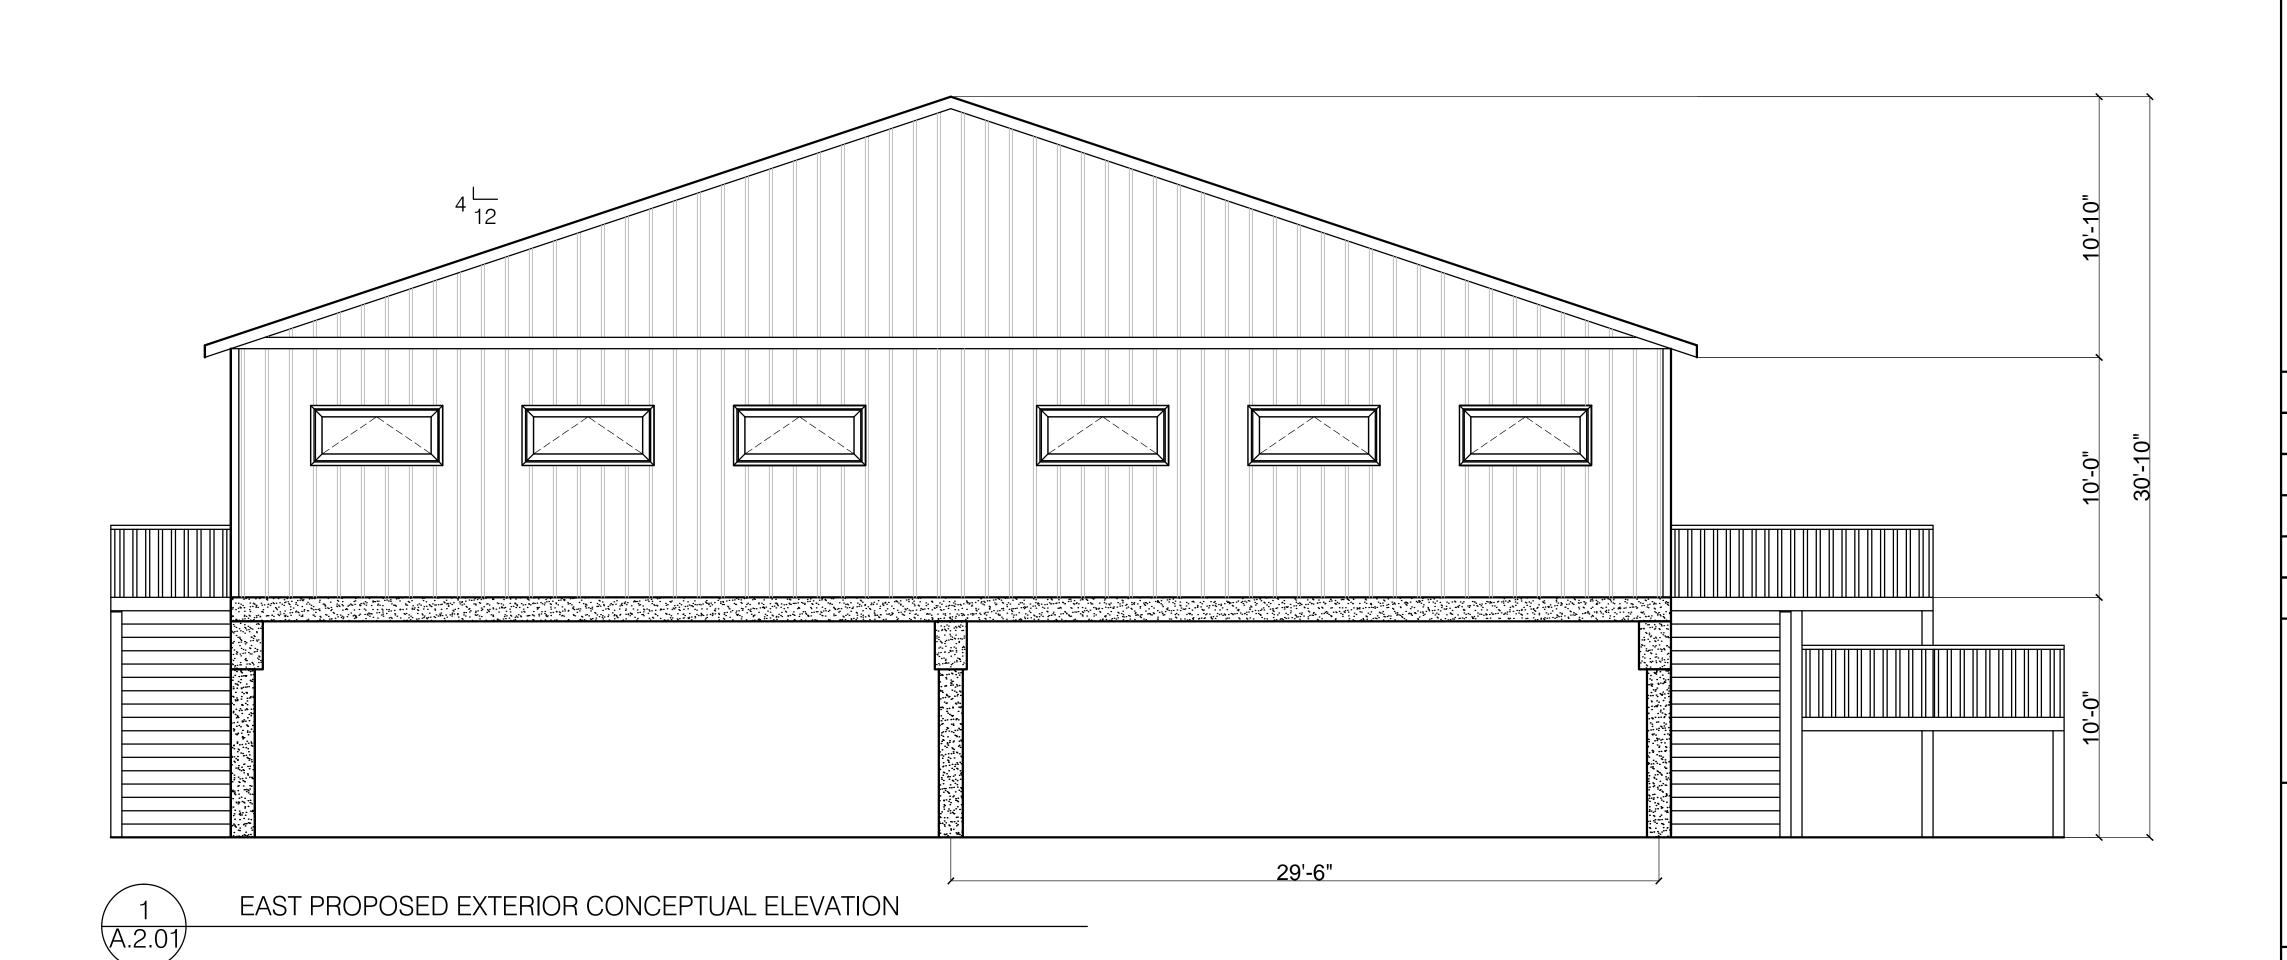







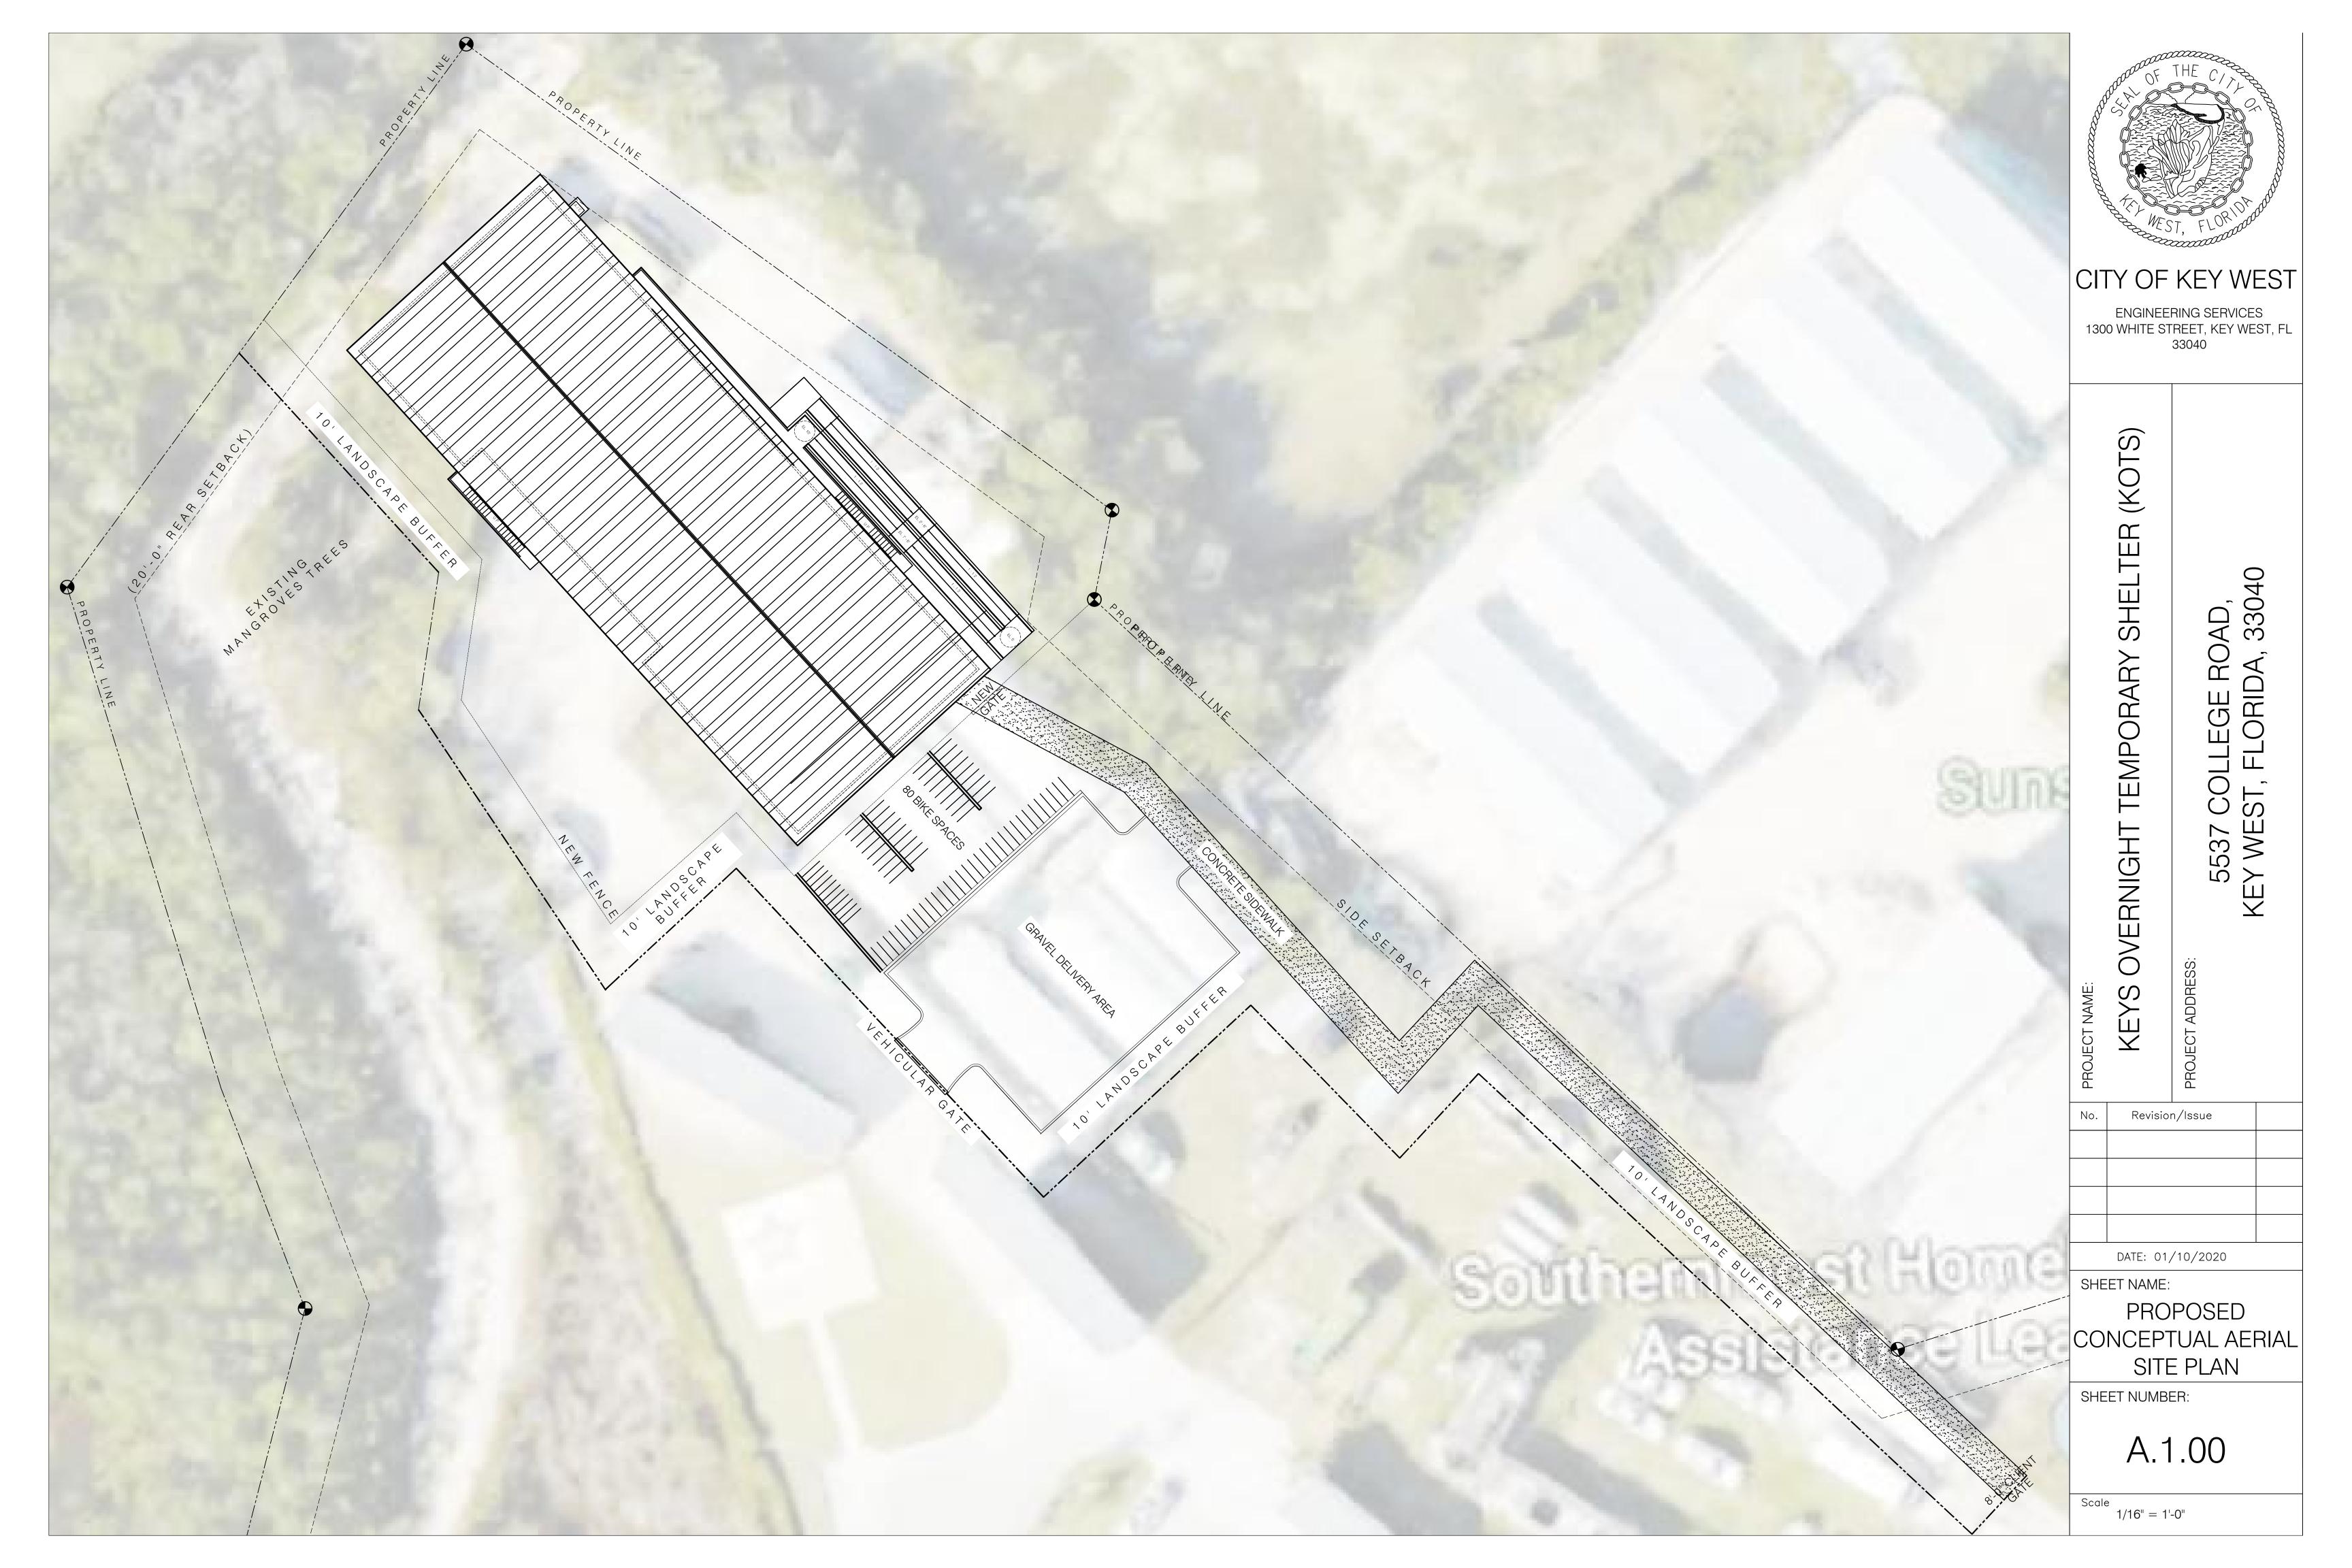

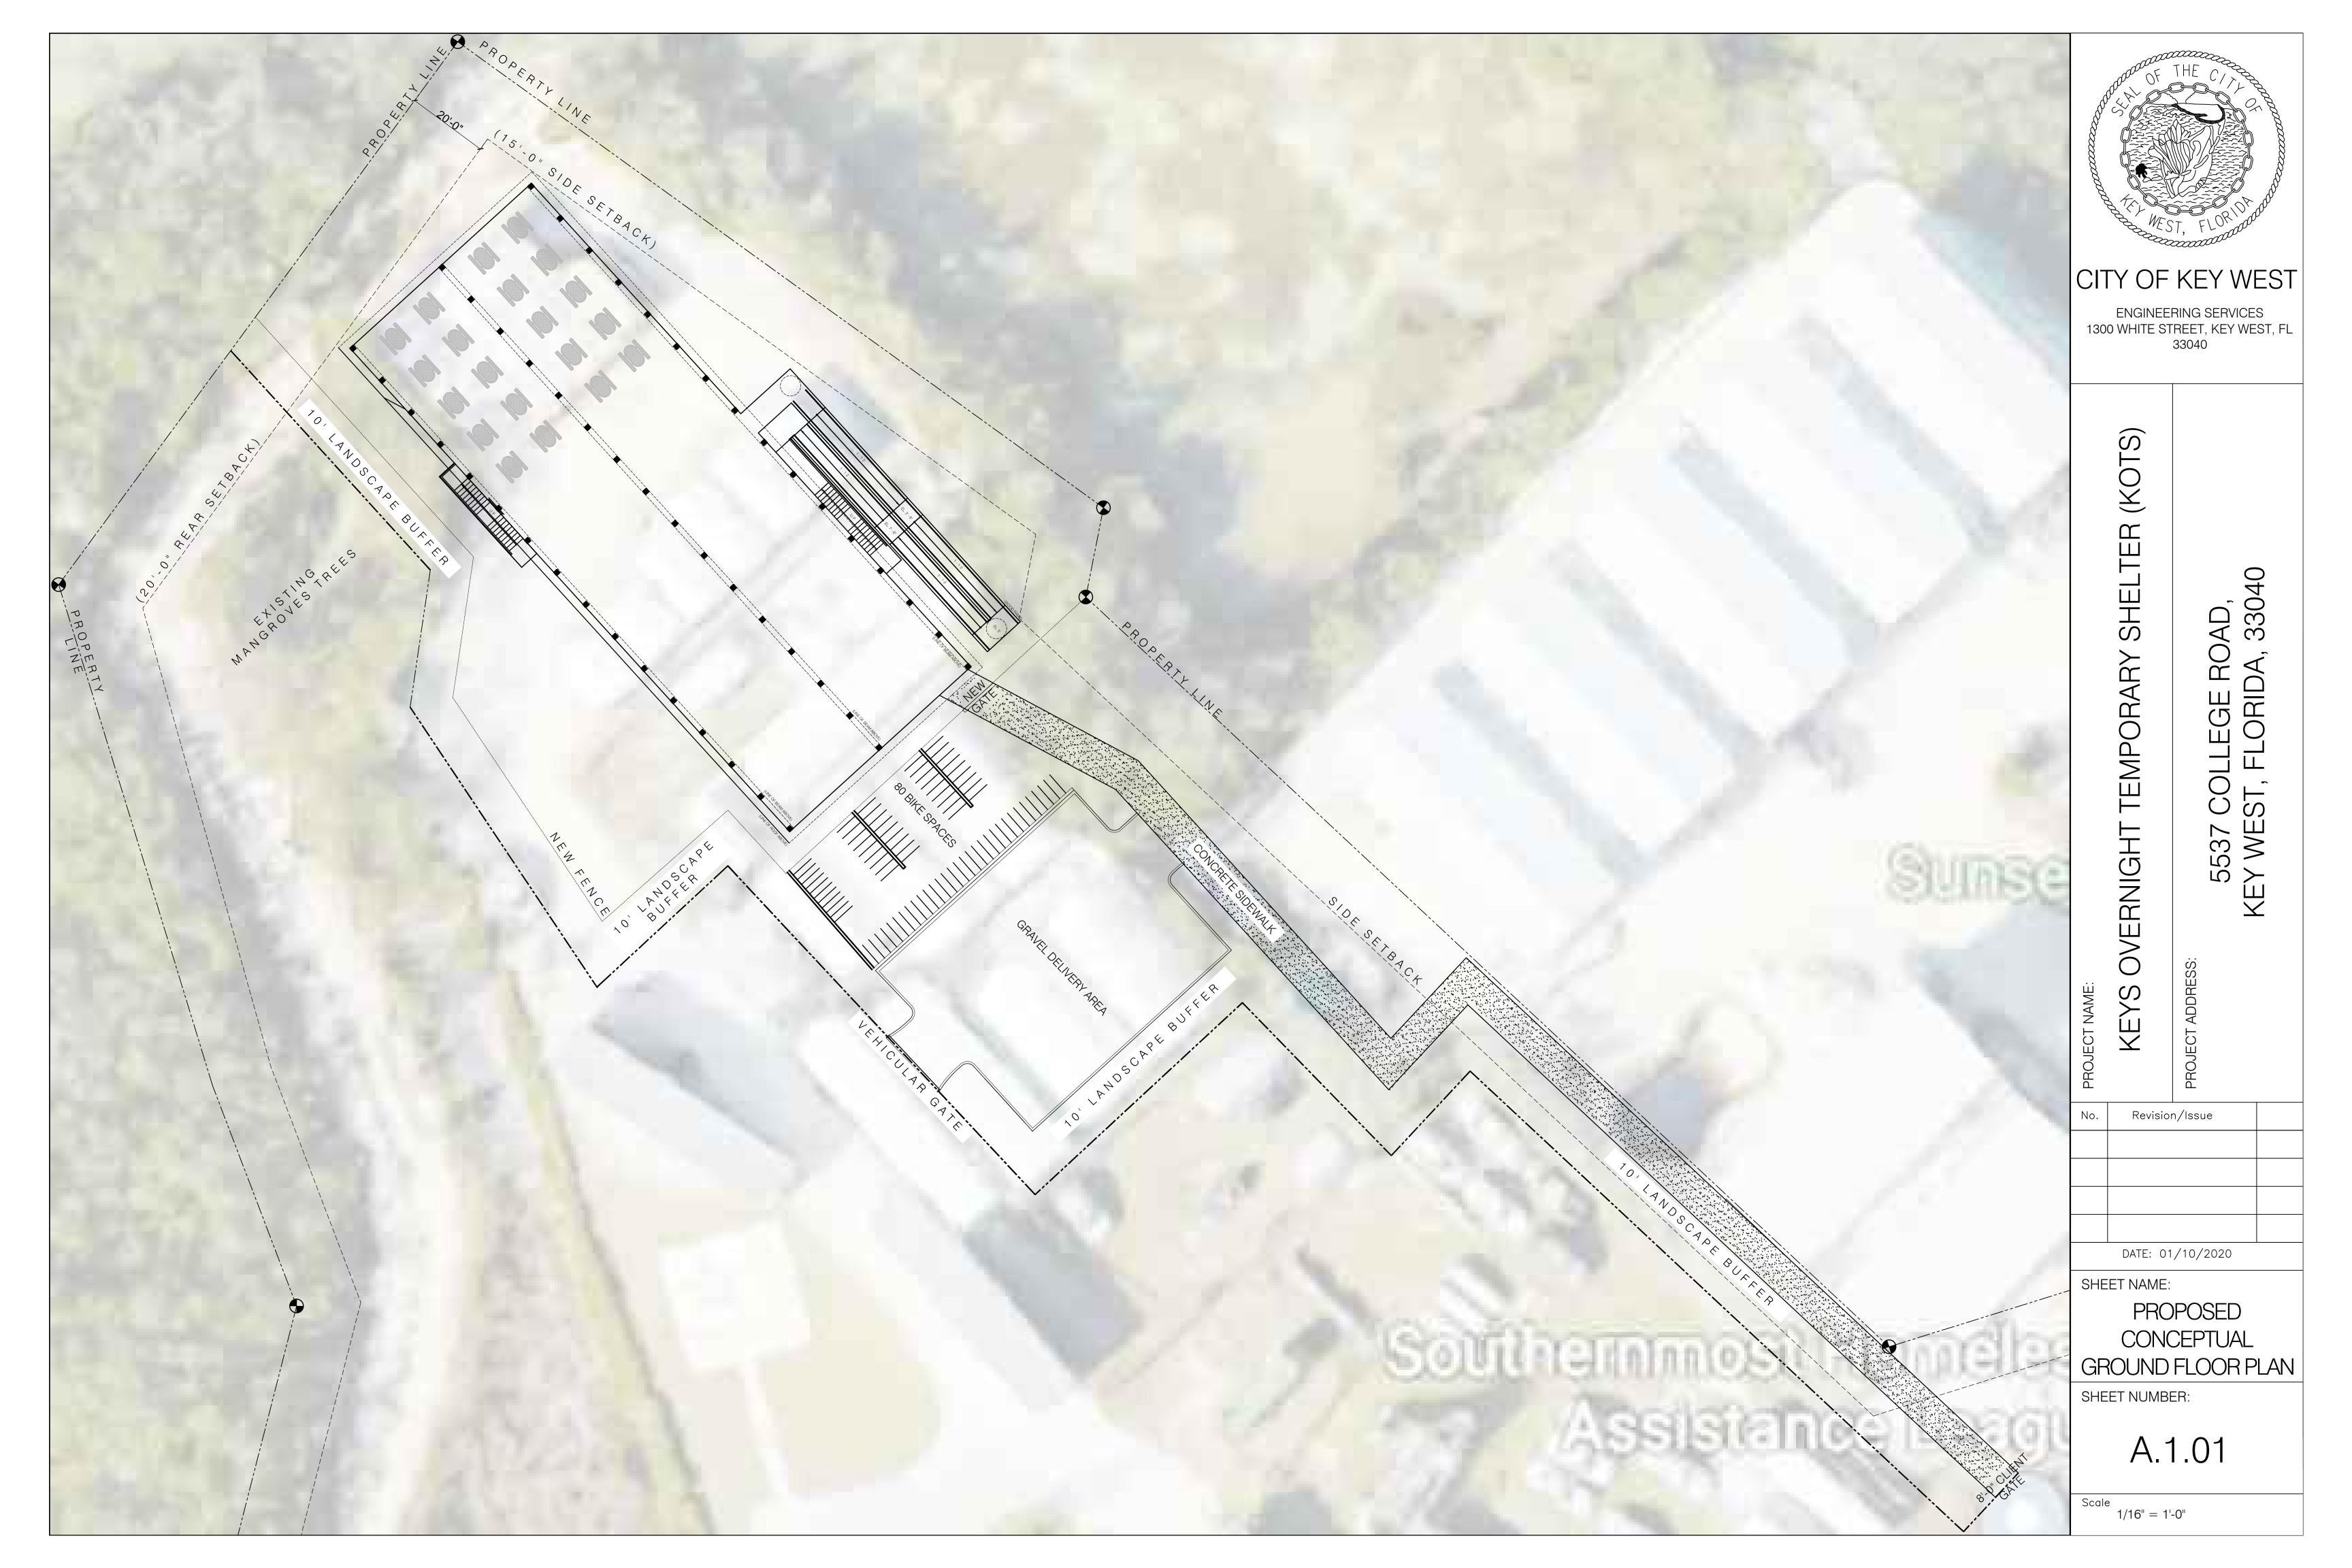

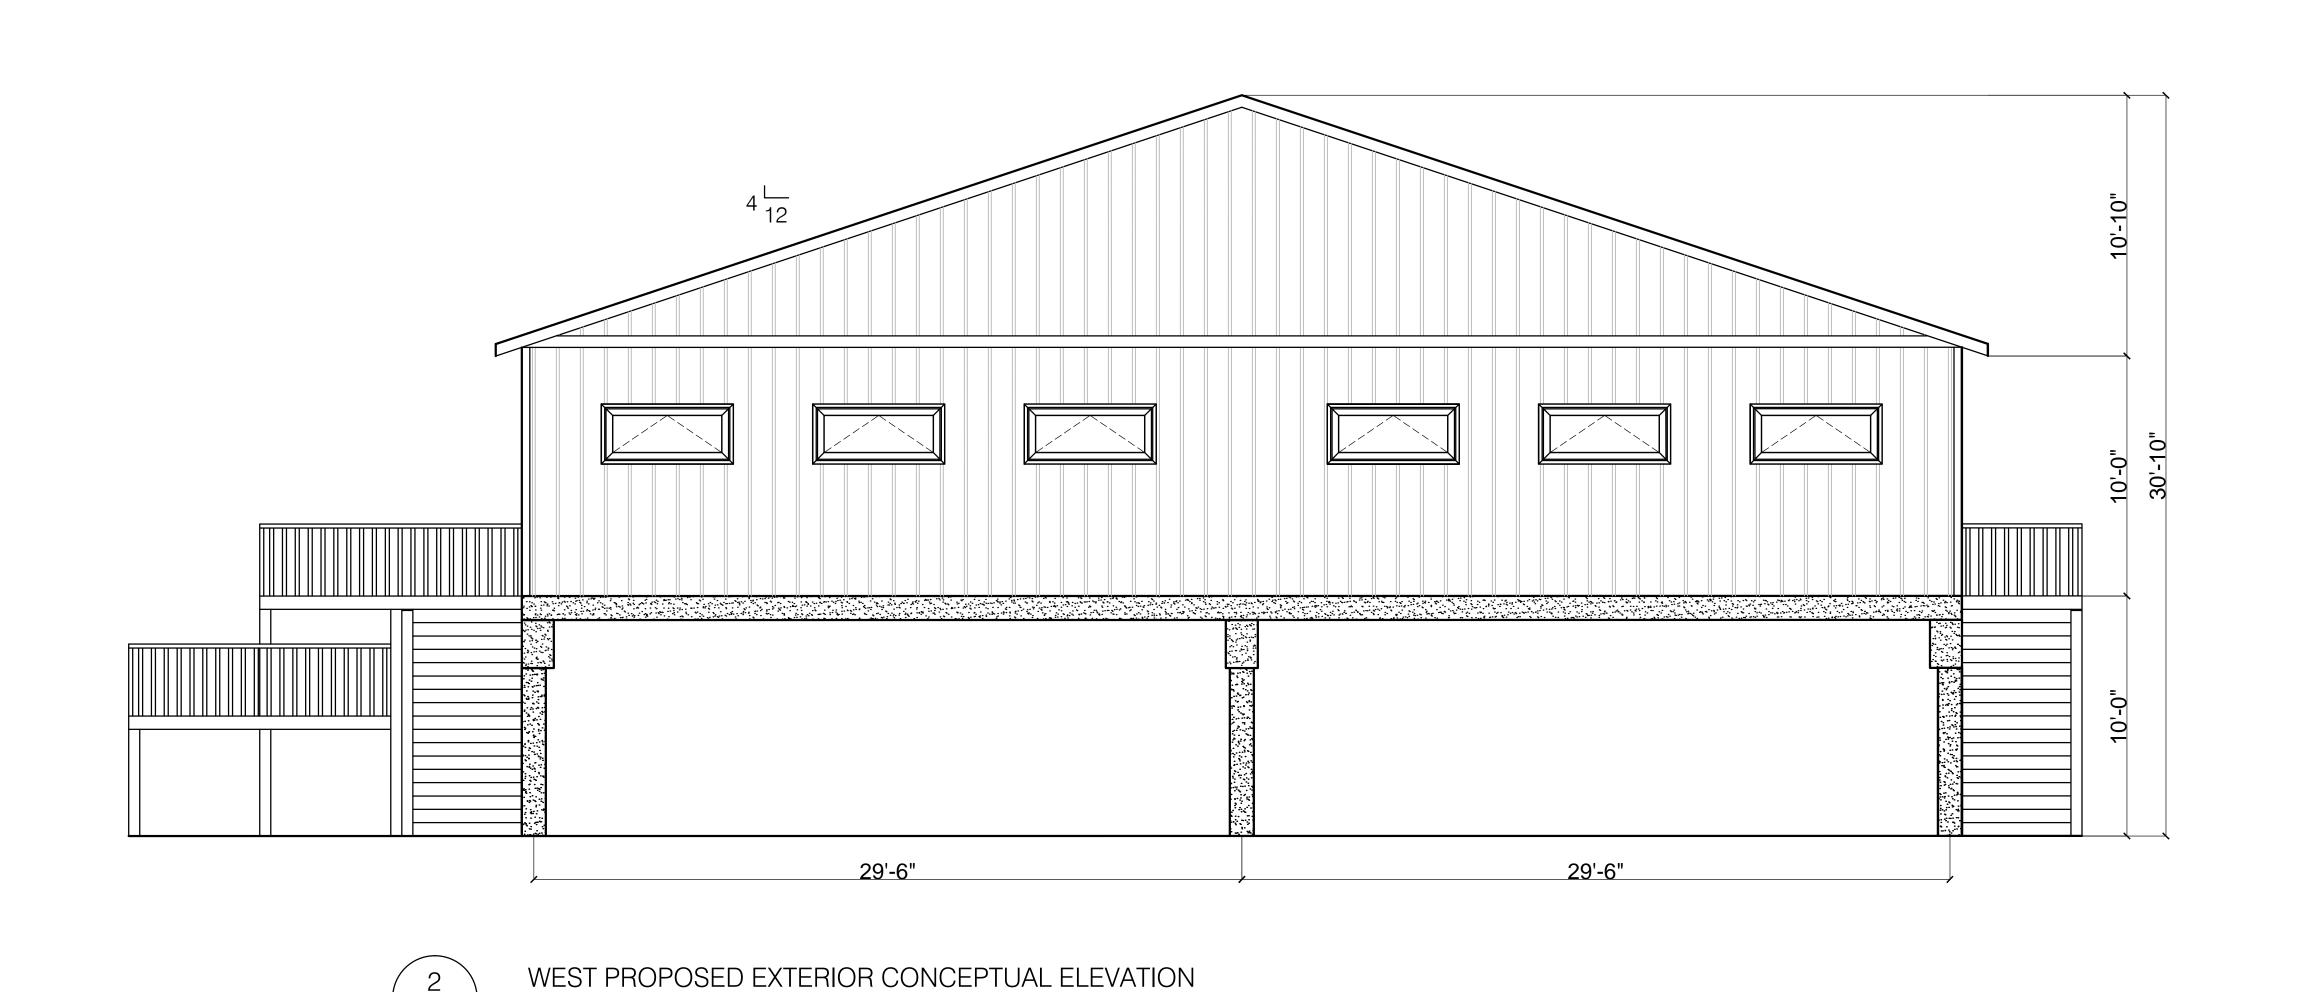

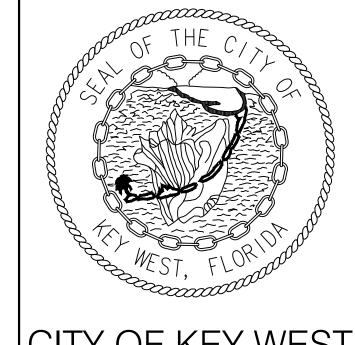

CITY OF KEY WEST

ENGINEERING SERVICES 1300 WHITE STREET, KEY WEST, FL 33040

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TEMPORARY

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OVERNIGHT

Revision/Issue DATE: 01/10/2020


SHEET NAME:

PROPOSED CONCEPTUAL **EXTERIOR** ELEVATIONS

SHEET NUMBER:


A.2.01

1/4" = 1'-0"

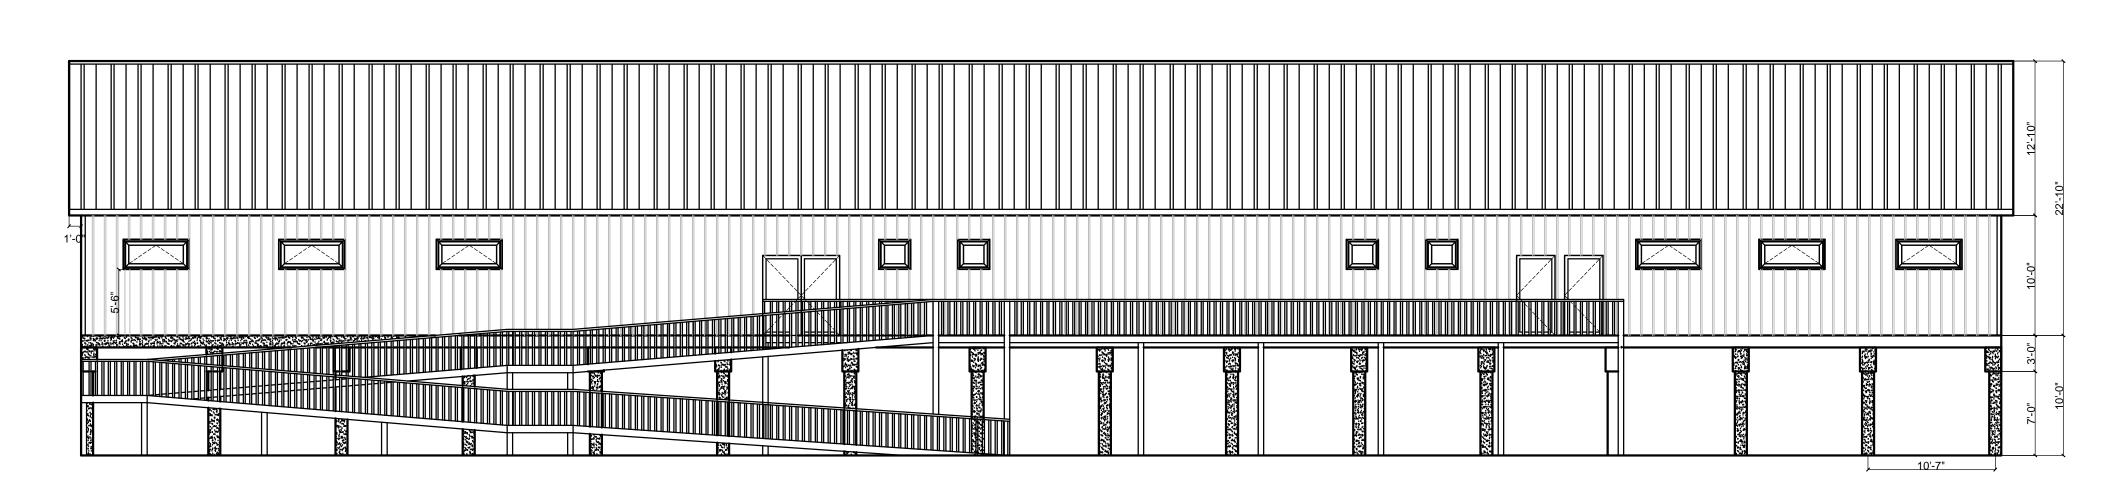




NORTH PROPOSED EXTERIOR CONCEPTUAL ELEVATION

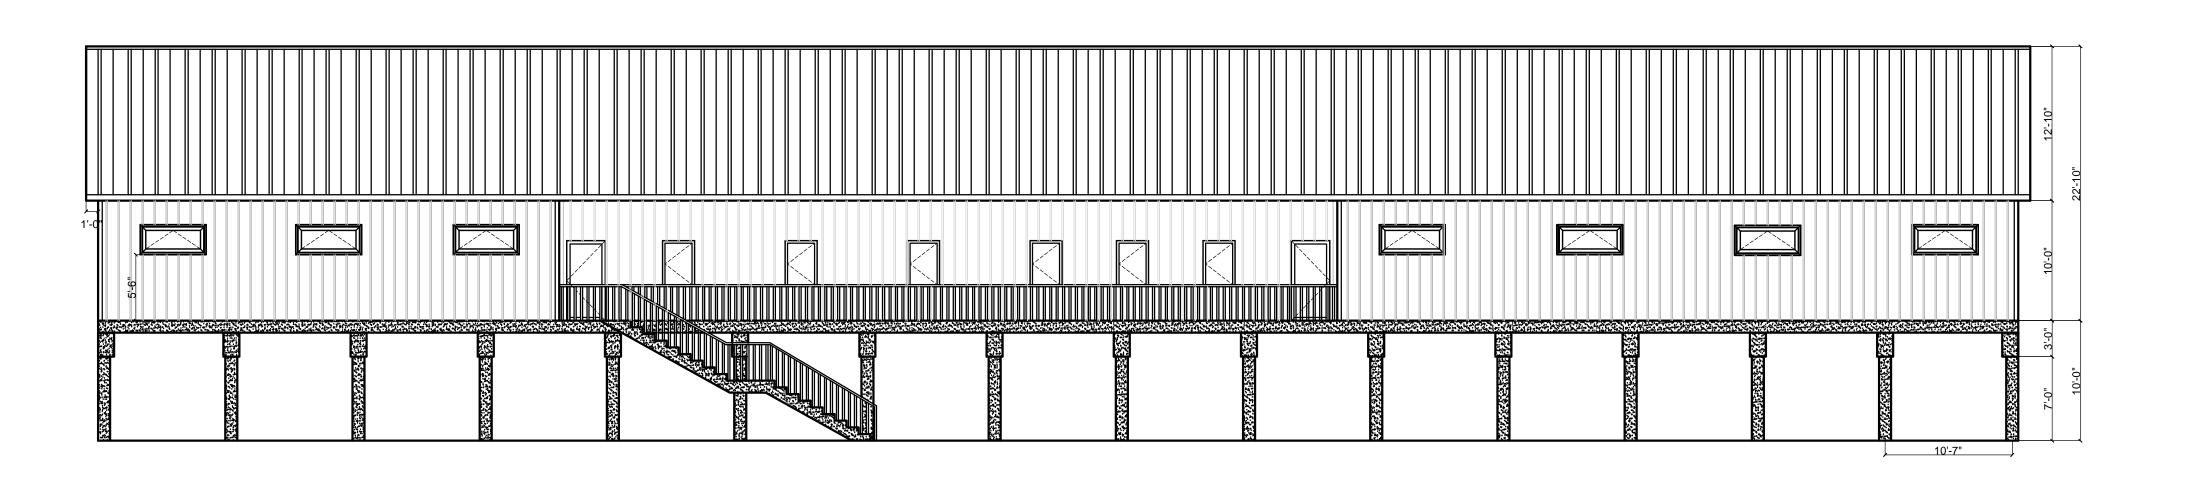



SOUTH PROPOSED EXTERIOR CONCEPTUAL ELEVATION

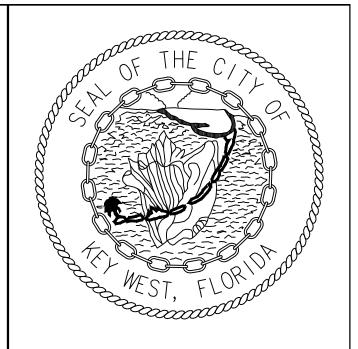

CITY OF KEY WEST

ENGINEERING SERVICES 1300 WHITE STREET, KEY WEST, FL 33040

> (KOTS) SHELTER

TEMPORARY

OVERNIGHT

5537 (KEY WES

PROJECT NAME:	KEYS	PROJECT ADDRE	
No.	Revision/Issue		

DATE: 01/10/2020

SHEET NAME:

PROPOSED CONCEPTUAL **EXTERIOR** ELEVATIONS

SHEET NUMBER:

A.2.02

Scale

1/8" = 1'-0"