Historic Architectural Review Commission

Staff Report Item 5

Meeting Date:	August 27, 2014
Applicant:	City of Key West/ Bermello Ajamil, Architects
Application Number:	H14-01-1100
Address:	Southwest corner of Truman Waterfront Park
Description of Work:	New pre-fabricated horse stables facilities.
Site Facts:	Truman Waterfront is a site of approximately 32 acres located on the west side of the historic district. The land was transferred by the Navy to the City of Key West. A Memorandum of Agreement was signed by the parts and includes, among others, land use limitations, setbacks, State Park access as well as specific requirements for Navy vehicular accesses through the land. Currently, the Police Department has horse stables in the site. On January 28, 2014 the Commission approved the demolition of the existing horse stables, which are attached to Navy building 1278.
Guidelines Cited in Review:	Additions, alterations and new construction (pages 36-38a), specifically guidelines for new construction.


Staff Analysis

The Certificate of Appropriateness proposes the construction of a prefabricated free standing structure to be used as a horse stables facilities for the Police Department' horses and personnel. The horse stable requires space for at least five horses.

The structure will be prefabricated, one story height. The structure has three bays on its main façade or east side. The central bay will be the tallest portion of the building and will raise approximately 20' from ground. Windows and doors will be metal impact resistant units. Roof will be covered with silver color metal standing seam. Tubular galvanized panels, five feet tall, will be used in the exterior as part of the horse's corral. The proposed color for the building will be light blue.

Consistency with Guidelines

The proposed design does not mimic nor is based on any structure found in the historic district. As a utilitarian structure, the architecture responds to the size and needs of the horses. The proposed scale and massing will not have an adverse impact in to the existing open area. The minimal exterior design is a reflect of the use of the structure. It is staff's opinion that the design conforms to the guidelines for new construction.

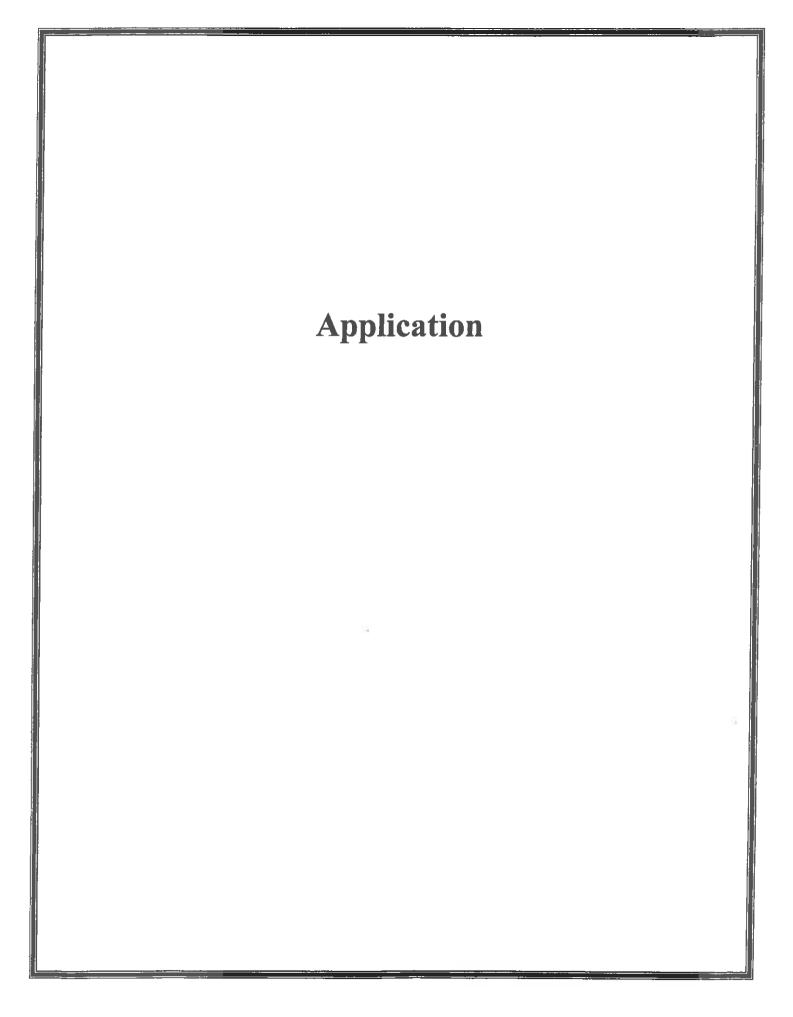

CITY OF KEY WEST				
BUILDING DEPARTMEN				
CERTIFICATE OF APPROPRIATENENSS APPLICATION #07-01-2014 011100				
OWNER'S NAME: The City of Key West	DATE: 07/01/2014			
OWNER'S ADDRESS: P.O. Box #1409, 3140 Flagler Ave. Key West Fl. 33040	PHONE #: 305-809-3973			
APPLICANT'S NAME: Saul G. Suarez, R.A.	PHONE #: 305-860-3772			
APPLICANT'S ADDRESS: 2601 South Bayshore Drive, Su	ite #1000 Miami, FL.			
ADDRESS OF CONSTRUCTION: South-west Corner of Truman Wa	terfront Park #OF UNITS N/A			
THERE WILL BE A FINAL INSPECTION REQUIRED UNI	DER THIS PERMIT			
DETAILED DESCRIPTION OF WORK: New Horse Stable Facilities for the use by the City of Key West Mounted Police Department, which makes the Building 100% Utilitarian and Strictly Functional for the Care and Wellbeing of the Horses and the Police Officers that work with them on a daily schedule. The Basis of Design for this Project, is to use a Pre-fabricated and Pre-engineered Building Manufacturer, that only deals with this type of Facilities.				
Chapter 837.06 F.SFalse Official Statements – Whoever knowingly makes a false statement in writing with the intent to mislead a public servant in the performance of his or her official duty shall be guilty of a misdemeanor of the second degree punishable as provided for in s. 775.082 or 775.083				

This application for Certificate of Appropriateness must precede applications for building permits, right of way permits, variances, and development review approvals.	Required Submittals TWO SETS OF SCALED DRAWINGS OF FLOOR PLAN, SITE PLAN AND EXTERIOR ELEVATIONS			
Applications must meet or exceed the requirements under the secretary of the Interior's Standards for the secretary of the Interior's Standards for the secretary of the secreta	(for new buildings and additions) TREE REMOVAL PERMIT (If applicable)			
Rehabilitation and Key West's Historic Architectural Guidelines.	PHOTOGRAPHS OF EXISTING BUILDING (repairs, rehabs, or expansions)			
Once completed, the application shall be reviewed by staff				
for completeness and either approved or scheduled for presentation to the Historic Architectural Review Commission at the next available meeting. The applicant must be present at this meeting. The filing of this application doos not onsure approved as submitted				
application does not ensure approval as submitted.	Staff Use Only			
Applications that do not possess the required Submittals will be considered incomplete and will not be reviewed for approval.	Date:			
Date: July 1st, 2014	Staff Approval:			
Applicant's Signature: And C. Ann	Fee Due:\$			

HISTORIC ARCHITECTURAL REVIEW APPLICATION

HISTORIC ARCHITECTURAL REVIEW COMMISSION USE ONLY			

Approved	Denied		Deferred
Reason for Deferral o	or Denial:		
-			
HARC Comments: <u>Human</u> Wate <u>Guidchin</u>	nts for nur	construction	~ (papes 36-38a)
Limit of Work Approv Changes:	red, Conditions of Ap	oproval and/or Sugge	ested
Date:	Signature:	Historic Archite Review Commi	





TRUMAN WATERFRONT PARK

The City of Key West HARC SUBMITTAL July 01, 2014

HORSE STABLE FACILITIES



BERMELLO AJAMIL & PARTNERS • INC

Architecture • Engineering • Planning Interior Design • Landscape Architecture 2601 South Bayshore Drive Suitle 1000 Milami, Florida 33133 (306) 859-2050 Fax (305) 860-3700



PREPARED FOR/OWNER: CITY OF KEY WEST, FL P. O. BOX 1409 3140 FLAGLER AVENUE KEY WEST, FL 33041





HORSE STABLE FACILITIES PHOTOGRAPHS OF EXISTING SITE OVERALL AERIAL PHOTOGRAPH







HORSE STABLE FACILITIES PHOTOGRAPHS OF EXISTING SITE PHOTOGRAPH #(1)







HORSE STABLE FACILITIES PHOTOGRAPHS OF EXISTING SITE













HORSE STABLE FACILITIES PHOTOGRAPHS OF EXISTING SITE PHOTOGRAPH #(3)



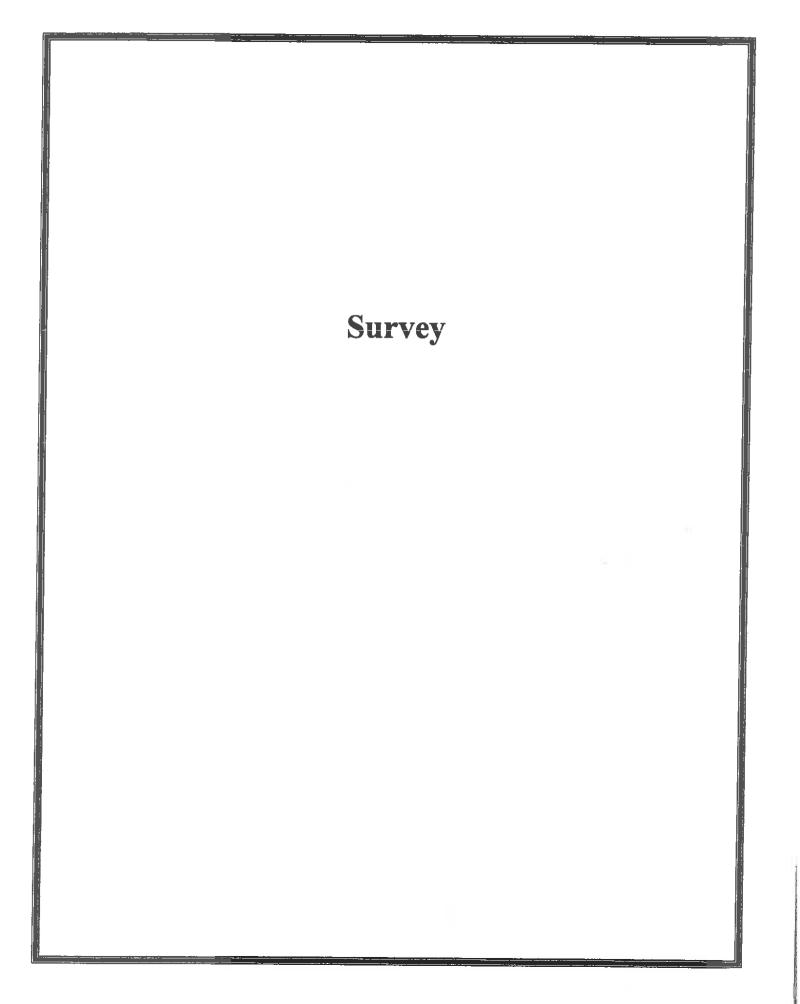

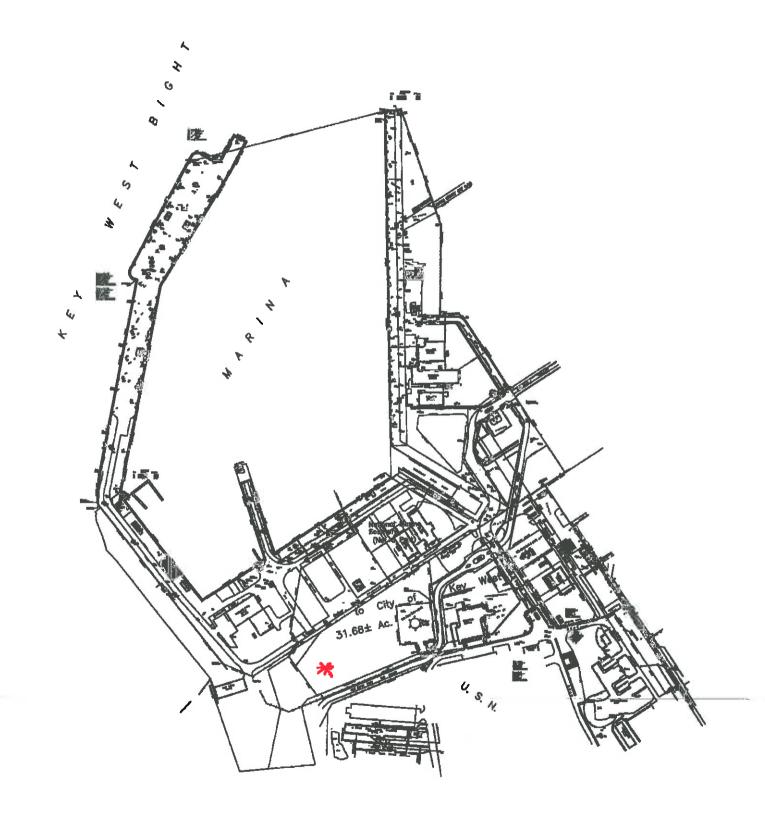

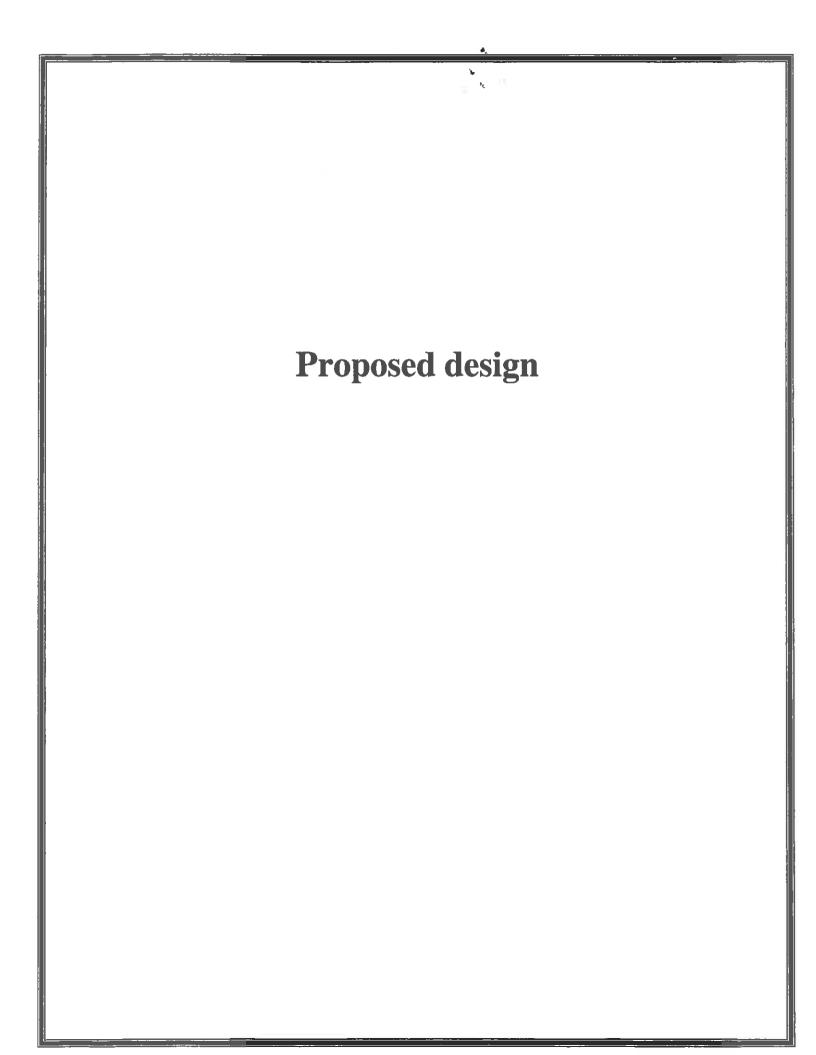

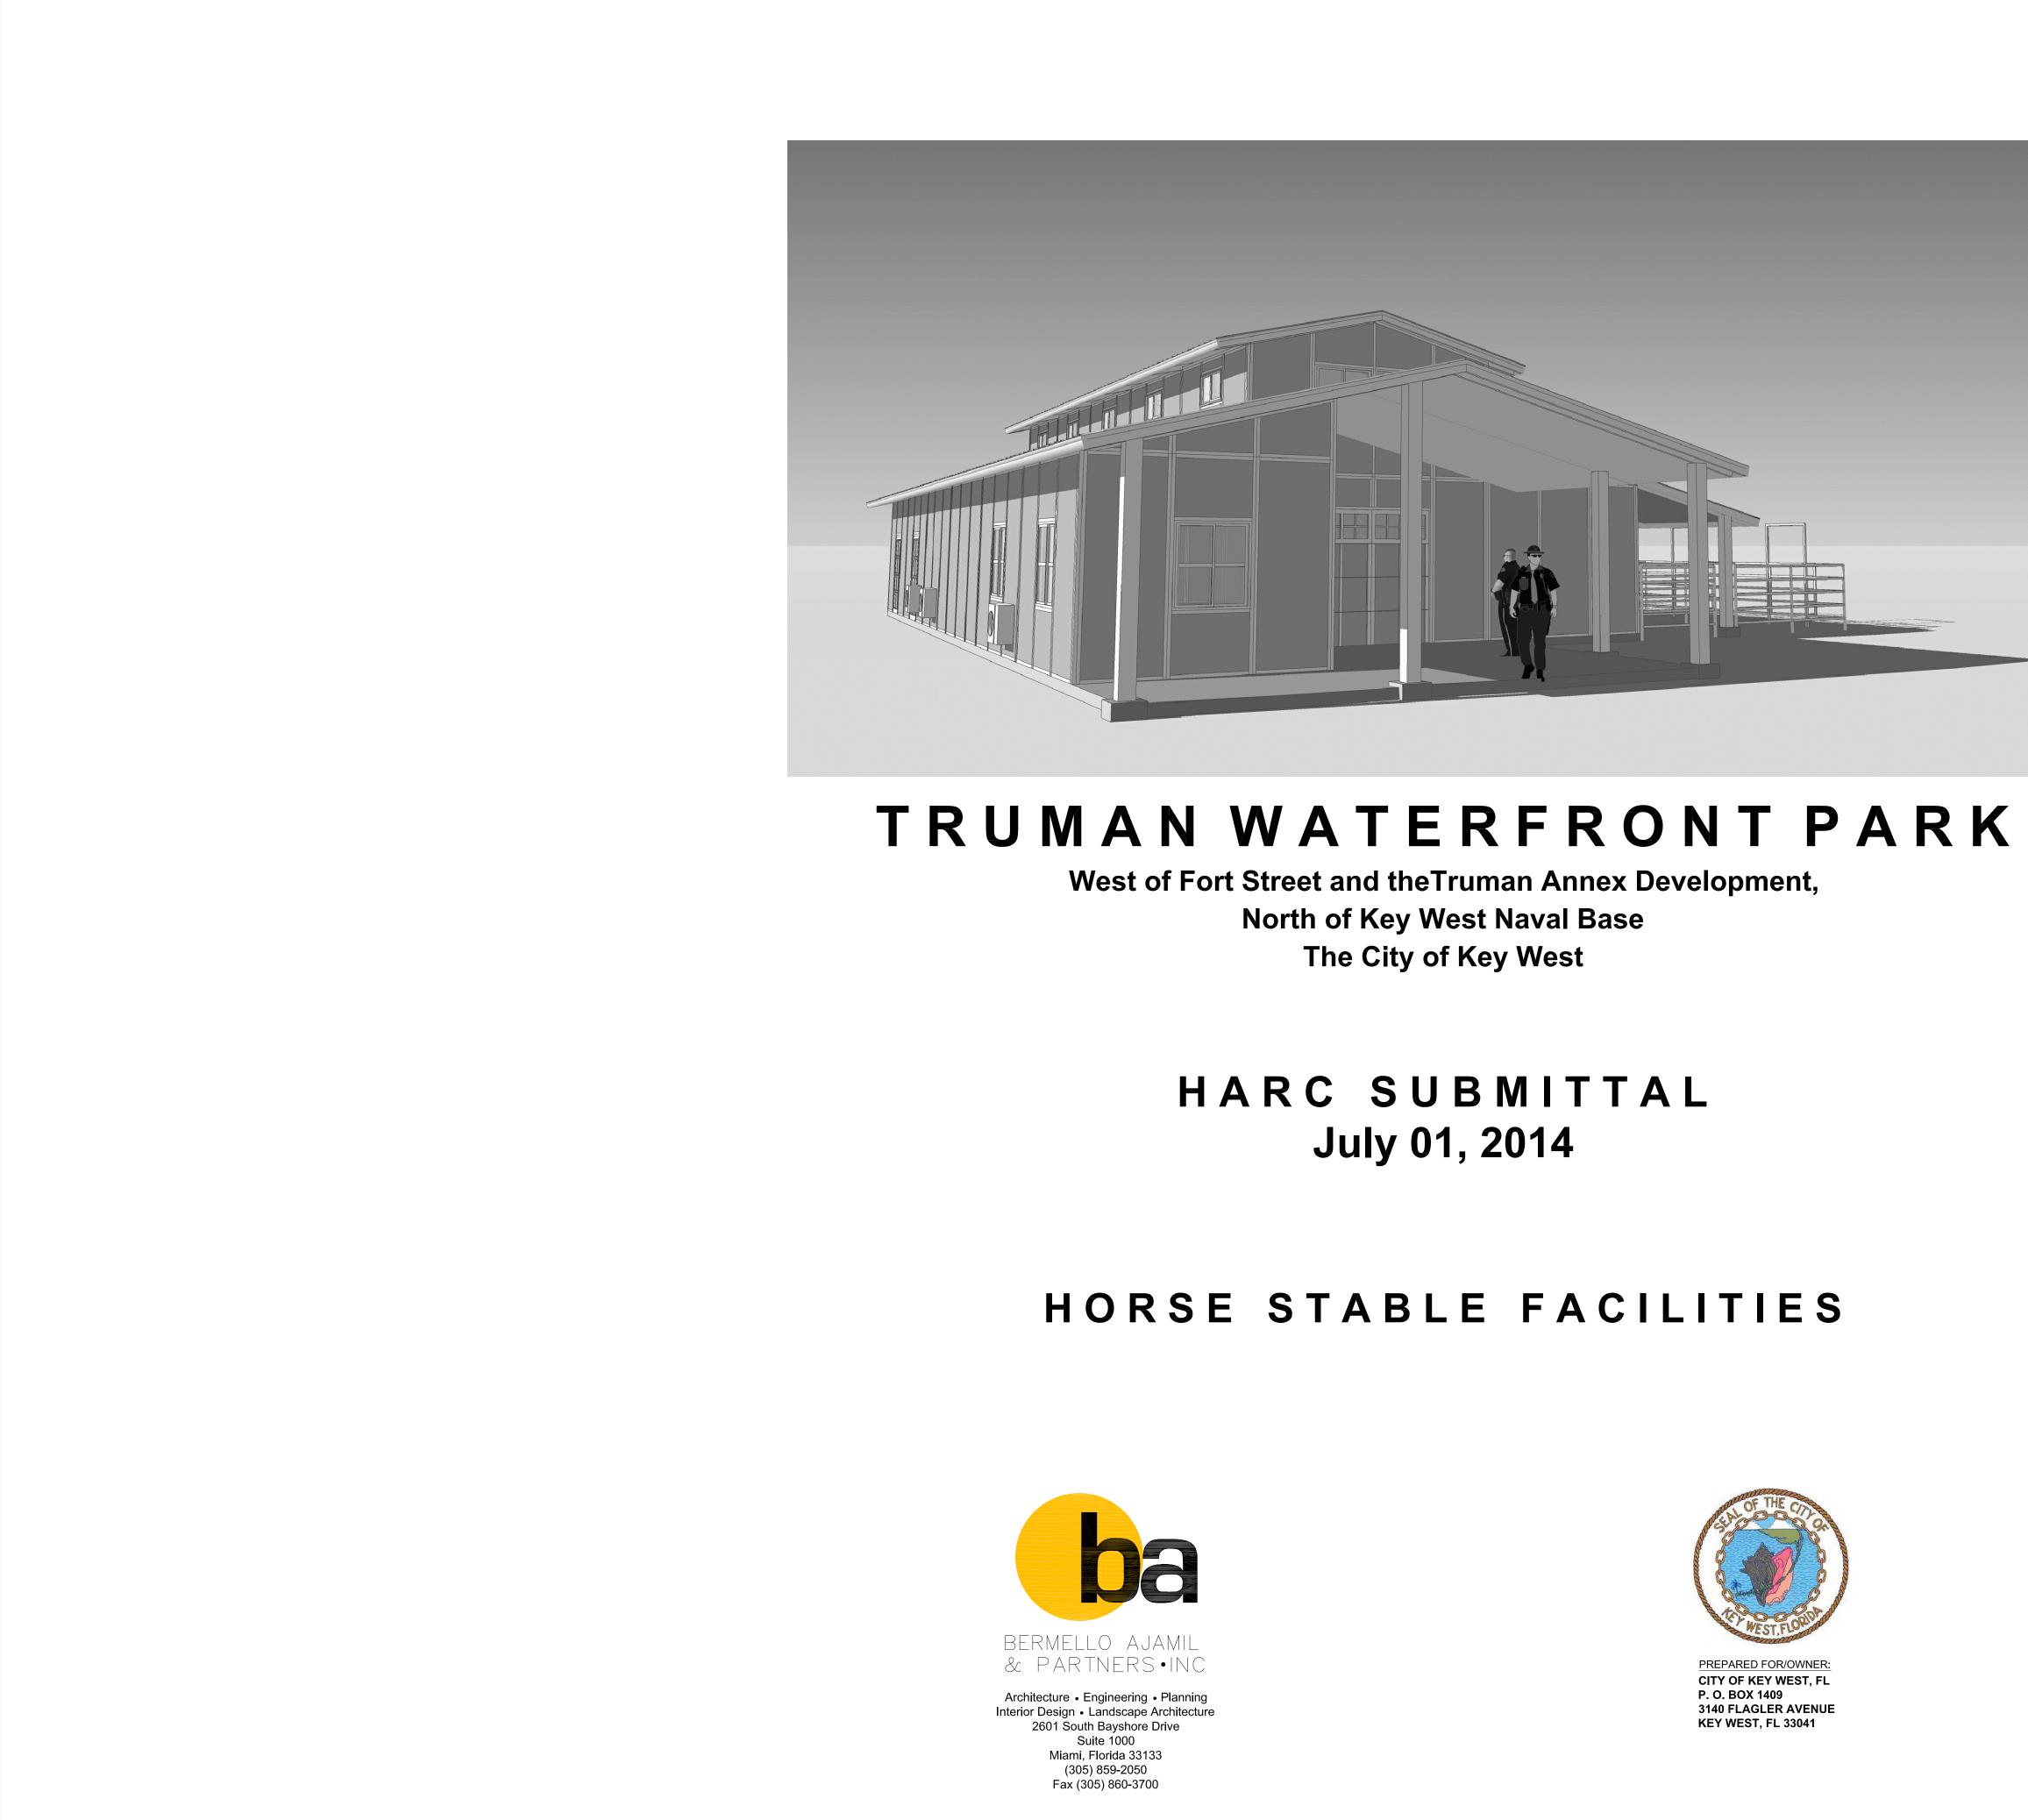



A-01 SCALE: 1/4" = 1'-0"


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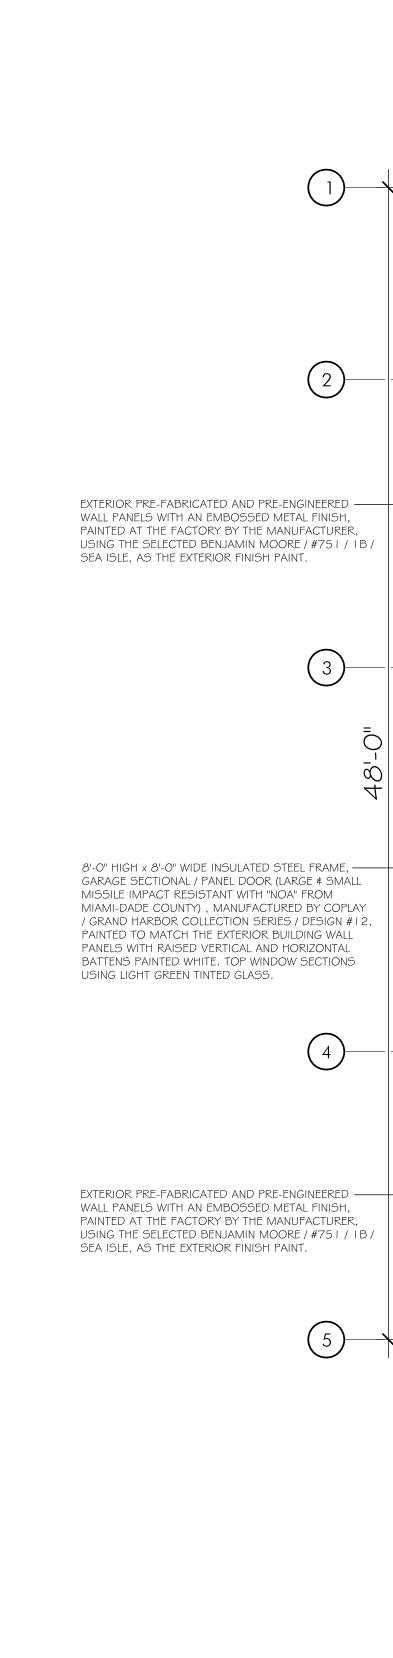
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(305)	lorida 33133 859-2050
Fax (305	5) 860-3700
PREPARED FOR/OV	
P. O. BOX 1409 3140 FLAGLER AV	
KEY WEST, FL 330	041
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	Con Martin
WEST, FL	OR
PROJECT NAME: TRUMAN	
WATERFR	ONT
PARK	
PROJECT LOCATIO	N/ADDRESS:
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TRUMAN ANNEX I NORTH OF KEY W	DEVELOPMENT, /EST NAVAL BASE
SUB-CONSULTANT	INFORMATION:
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R	# 6878
	# 681
SUBMITTAL DESCR	IPTION / MILESTONE:
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	onstruction 01, 2014
REVISIONS:	
DRAWING SHEET IN BA PROJECT NO.:	
SCALE:	14041 1" = 20'
DATE:	July 01, 2014
DRAWN BY:	DP
CHECKED BY: CADD FILE:	SGS M:\14041 Truman Waterfront Park
DRAWING TITLE:	Task 2 Phase I CD's\Architecture\ARCF
HORSE S	TABLE
SITE PLA	

SHEET NO.


A-01




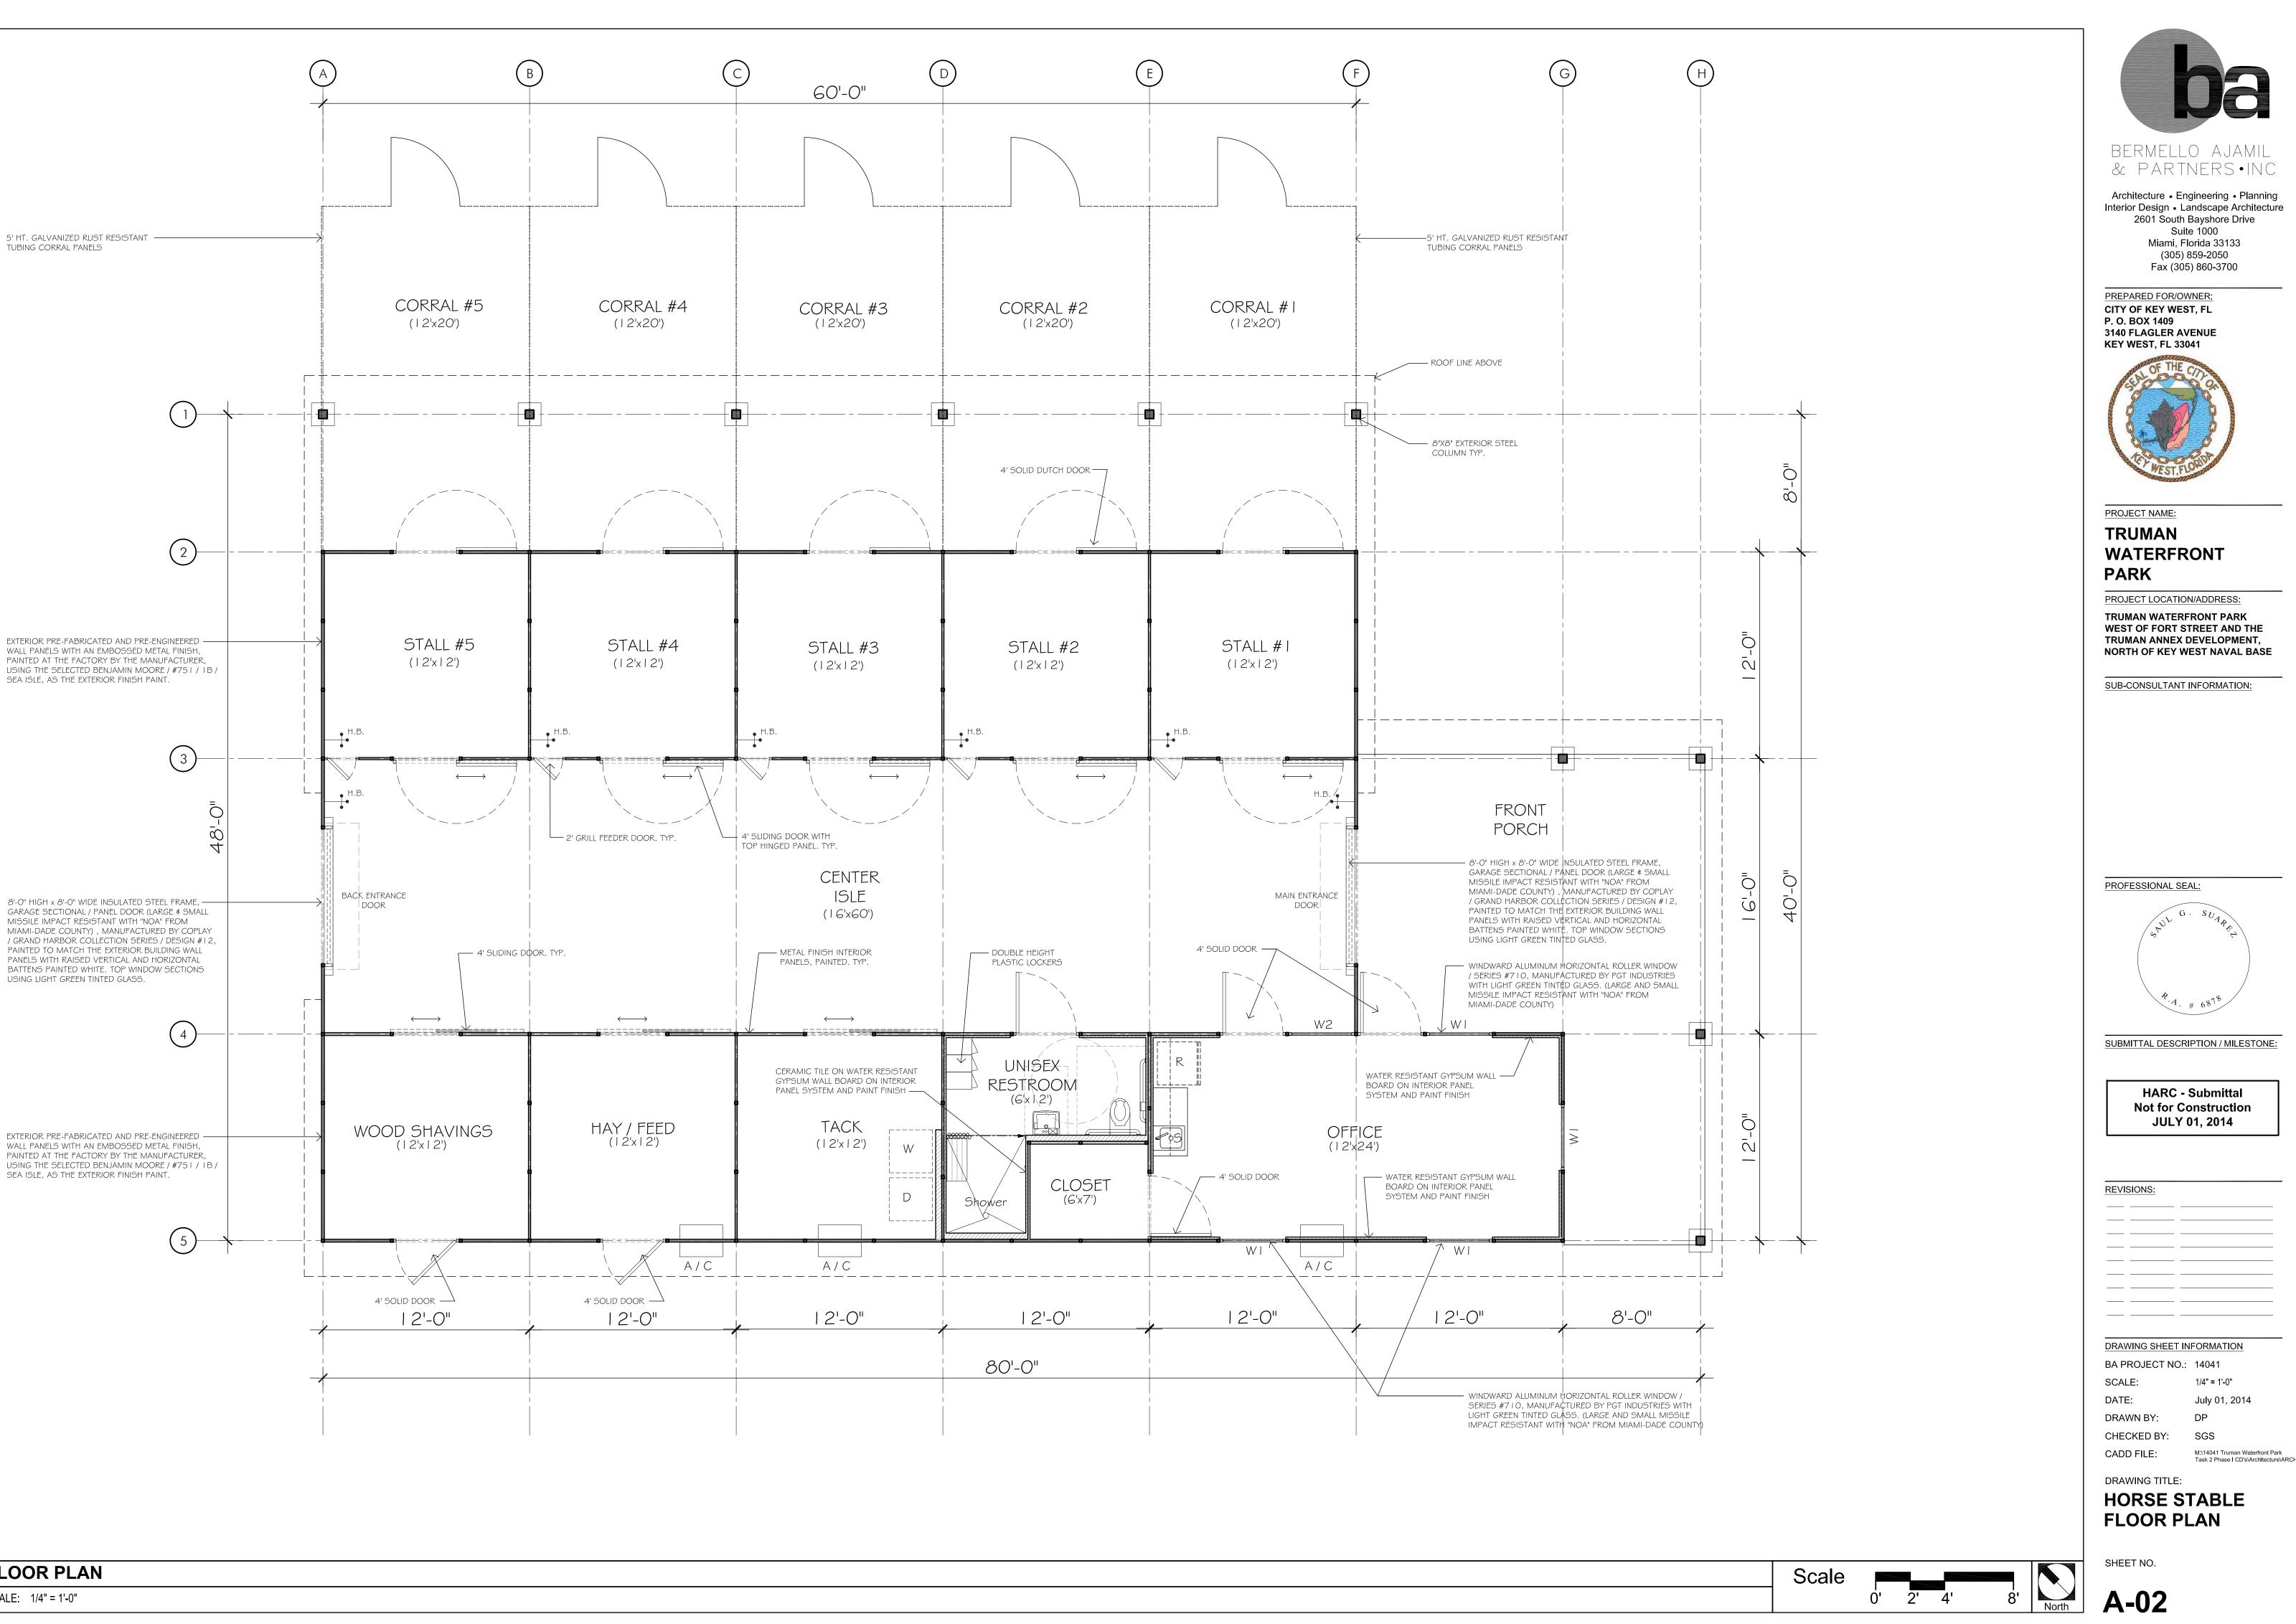

TUBING CORRAL PANELS


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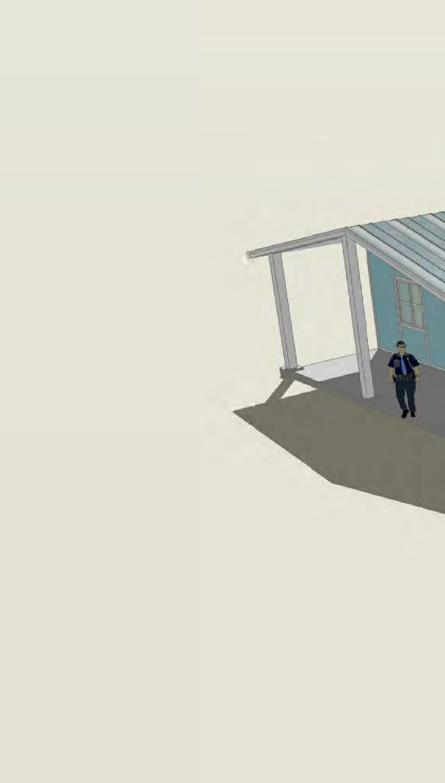


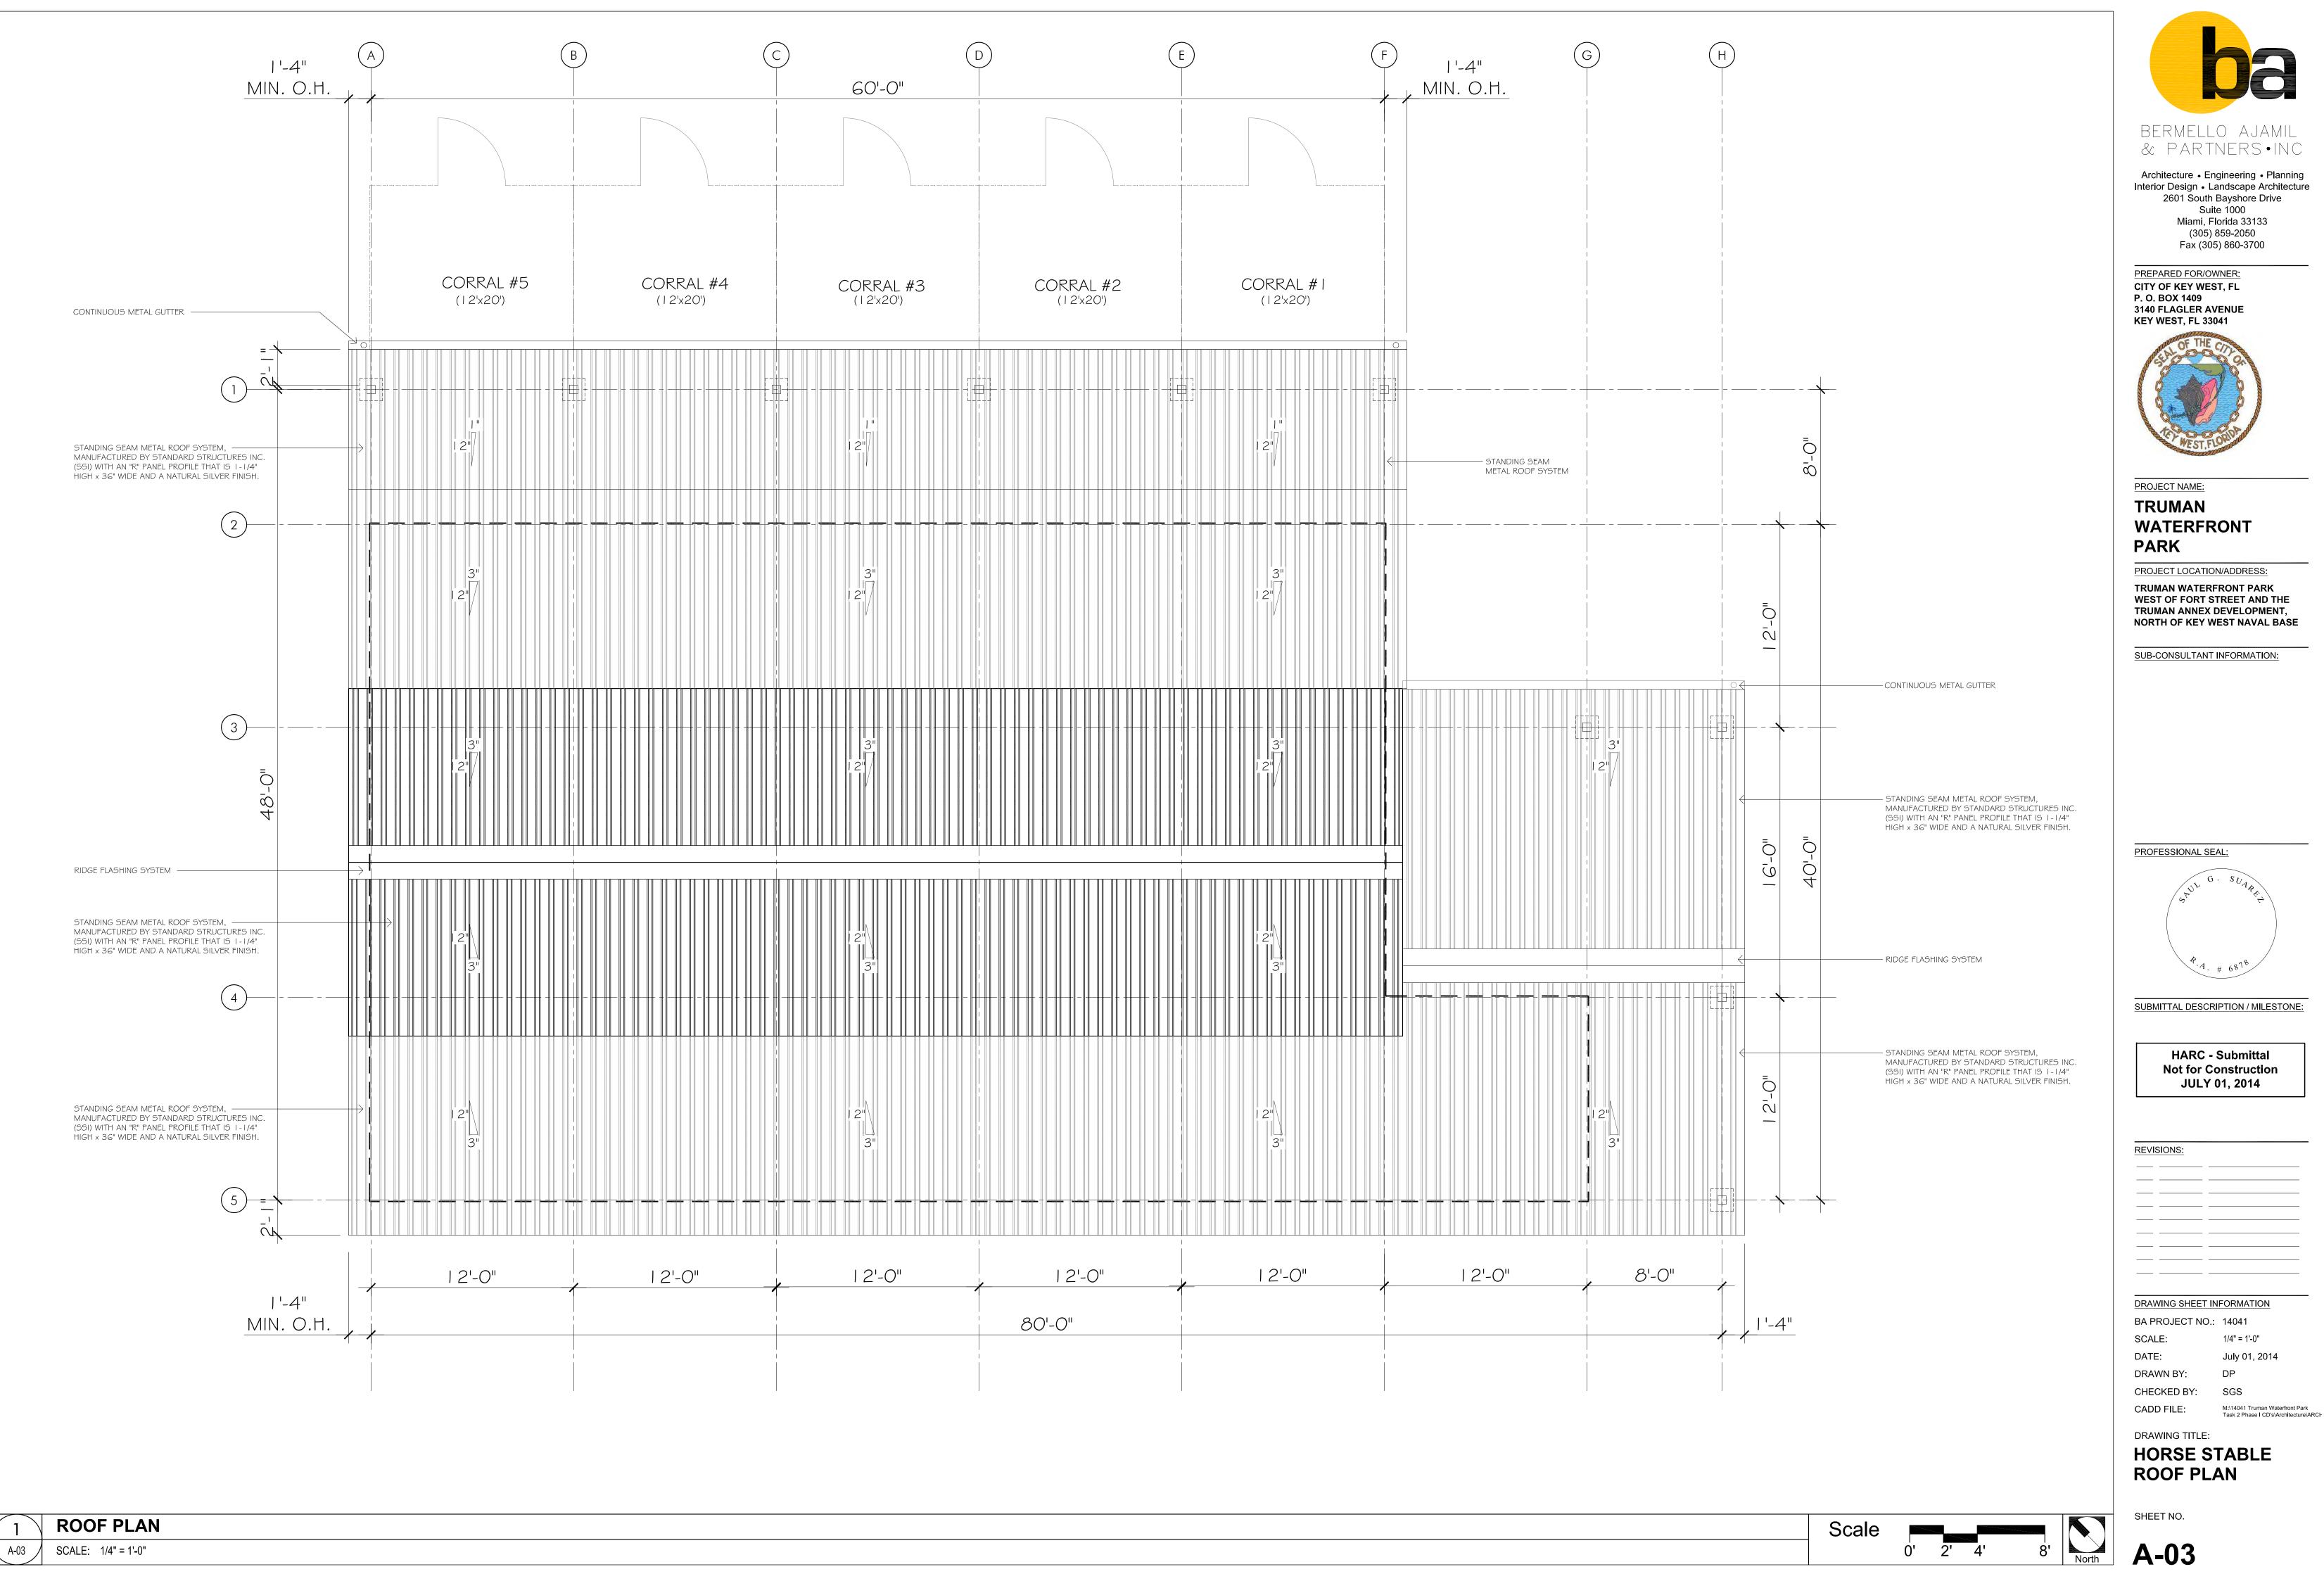

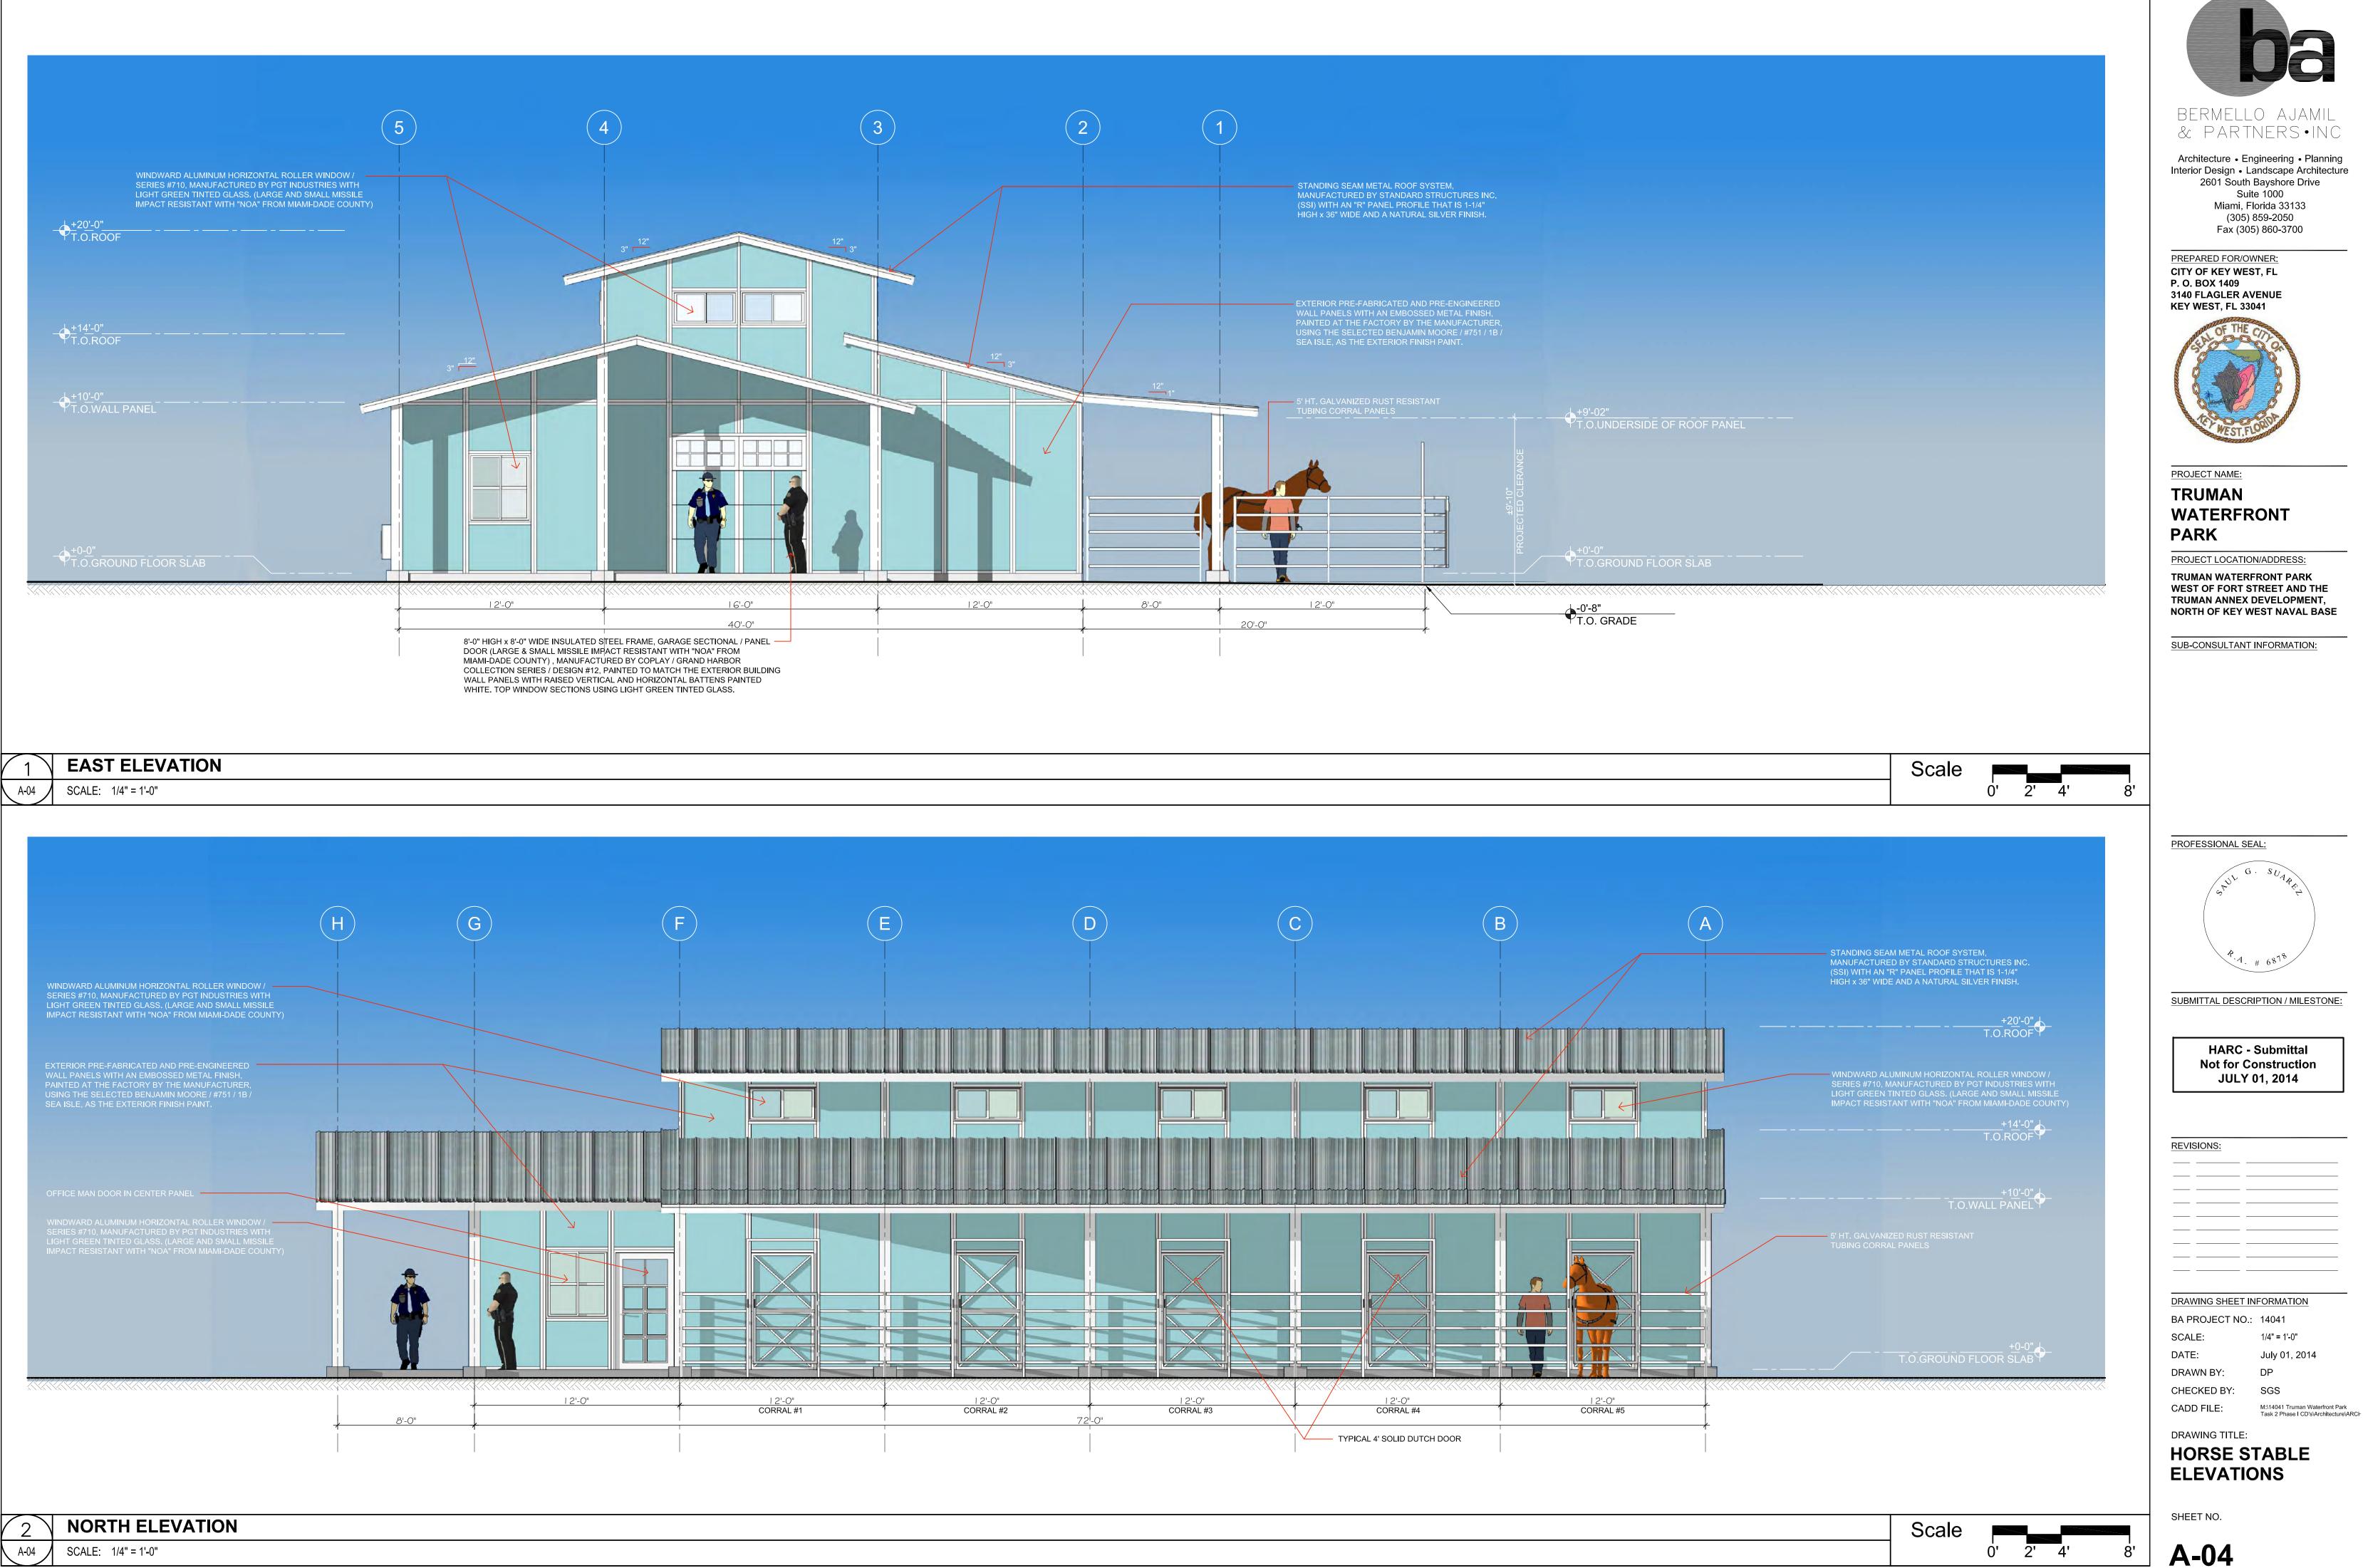

PERSPECTIVE - MAIN ENTRANCE

SCALE: NTS.

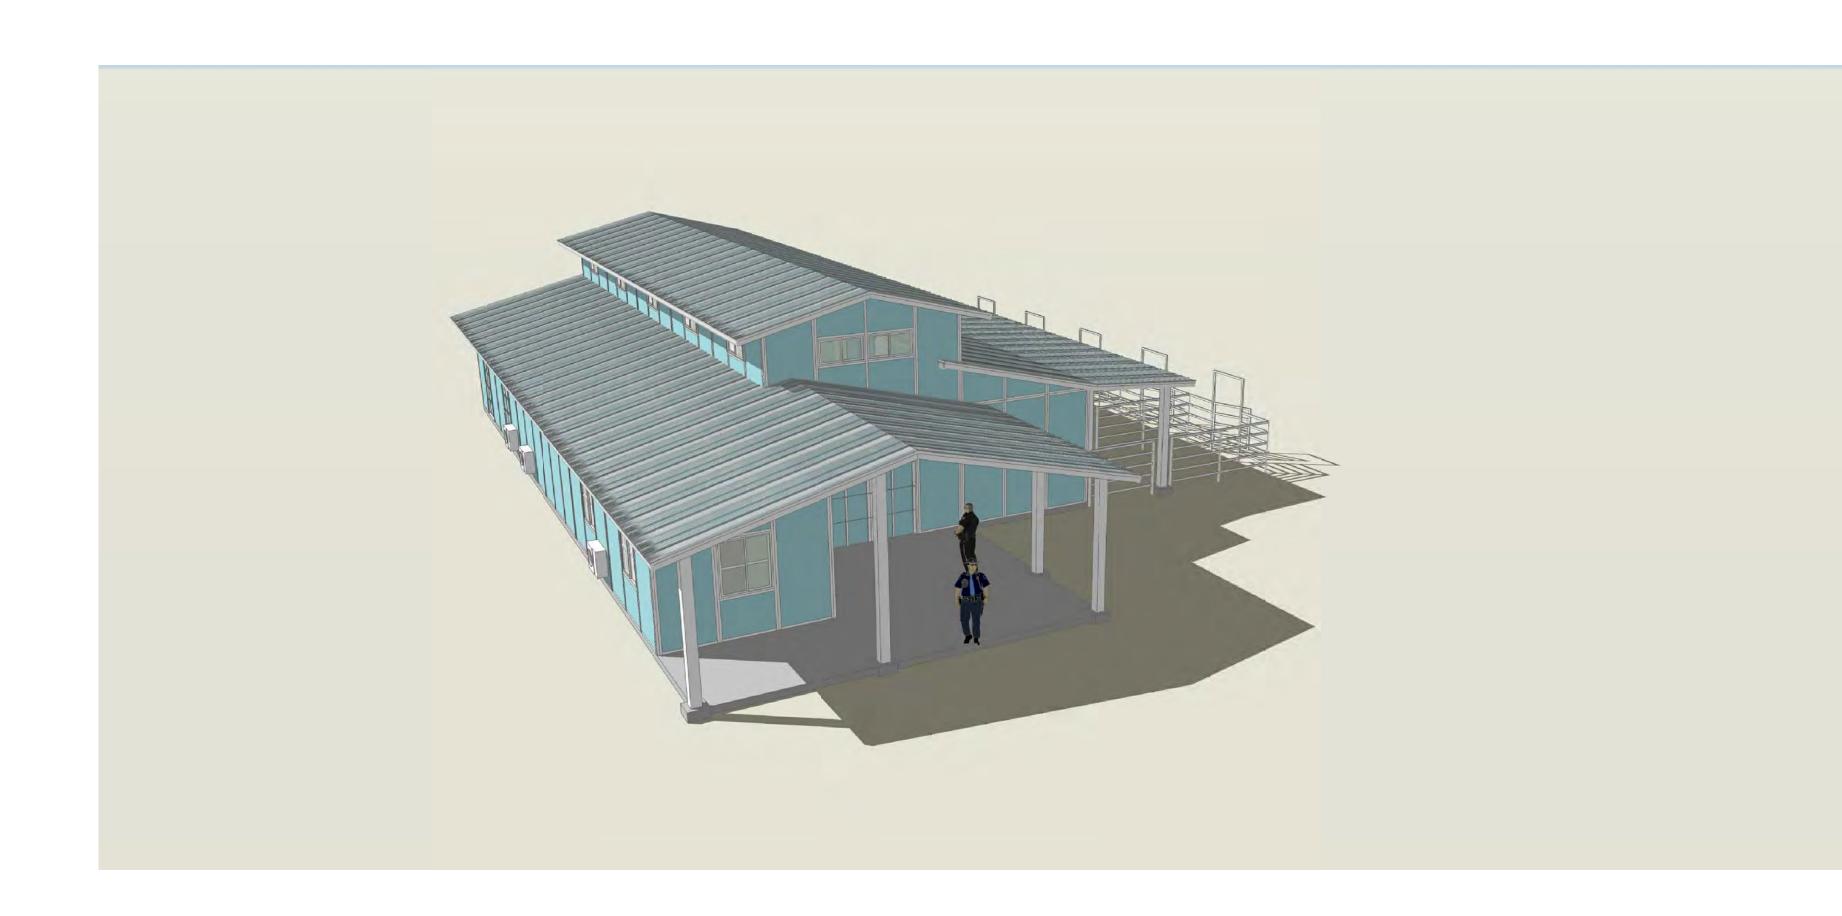



SCALE: NTS





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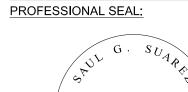
PREPARED FOR/OWNER: CITY OF KEY WEST, FL P. O. BOX 1409 3140 FLAGLER AVENUE KEY WEST, FL 33041



PROJECT NAME: TRUMAN WATERFRONT PARK

PROJECT LOCATION/ADDRESS: TRUMAN WATERFRONT PARK WEST OF FORT STREET AND THE TRUMAN ANNEX DEVELOPMENT, NORTH OF KEY WEST NAVAL BASE

SUB-CONSULTANT INFORMATION:





SUBMITTAL DESCRIPTION / MILESTONE:

HARC - Submittal	
Not for Construction	
JULY 01, 2014	

REVISIONS:

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DRAWING SHEET INFORMATION BA PROJECT NO.: 14041 SCALE: 1/4" = 1'-0" DATE: July 01, 2014 DP DRAWN BY: CHECKED BY: SGS


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DRAWING TITLE: HORSE STABLE PERSPECTIVES

SHEET NO.

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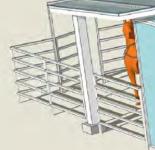




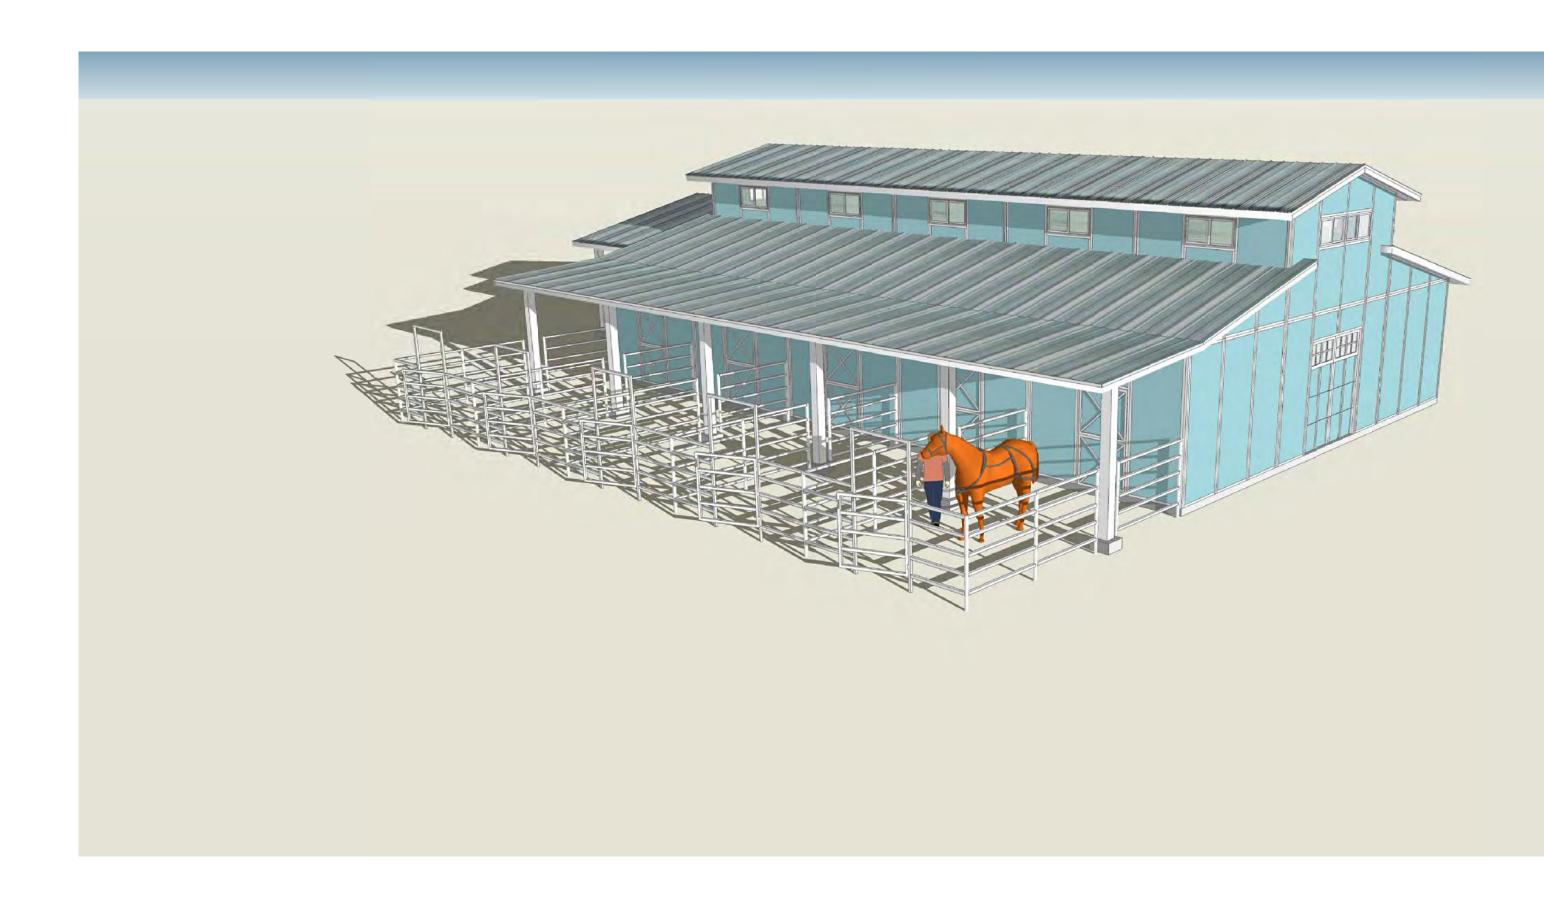

PERSPECTIVE - BACK ENTRANCE

SCALE: NTS.





SCALE: NTS





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SUB-CONSULTANT INFORMATION:





SUBMITTAL DESCRIPTION / MILESTONE:

HARC - Submittal
Not for Construction
JULY 01, 2014

REVISIONS:

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DRAWING SHEET INFORMATIONBA PROJECT NO.:14041SCALE:1/4" = 1'-0"DATE:July 01, 2014DRAWN BY:DPCHECKED BY:SGS

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DRAWING TITLE: HORSE STABLE PERSPECTIVES

SHEET NO.

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PERSPECTIVE - AEREAL VIEW

SCALE: NTS.







SCALE: NTS









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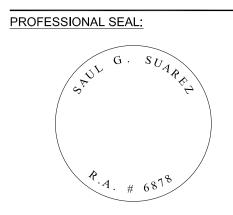
PREPARED FOR/OWNER: CITY OF KEY WEST, FL P. O. BOX 1409 3140 FLAGLER AVENUE KEY WEST, FL 33041



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REVISIONS:

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DRAWING TITLE: HORSE STABLE PERSPECTIVES

SHEET NO.





TRUMAN WATERFRONT PARK

The City of Key West HARC SUBMITTAL July 01, 2014

HORSE STABLE FACILITIES




BERMELLO AJAMIL & PARTNERS • INC


Architecture • Engineering • Planning Interior Design • Landscape Architecture 2801 South Bayshore Drive Suite 1000 Miami, Florida 33133 (305) 859-2050 Fax (305) 860-3700



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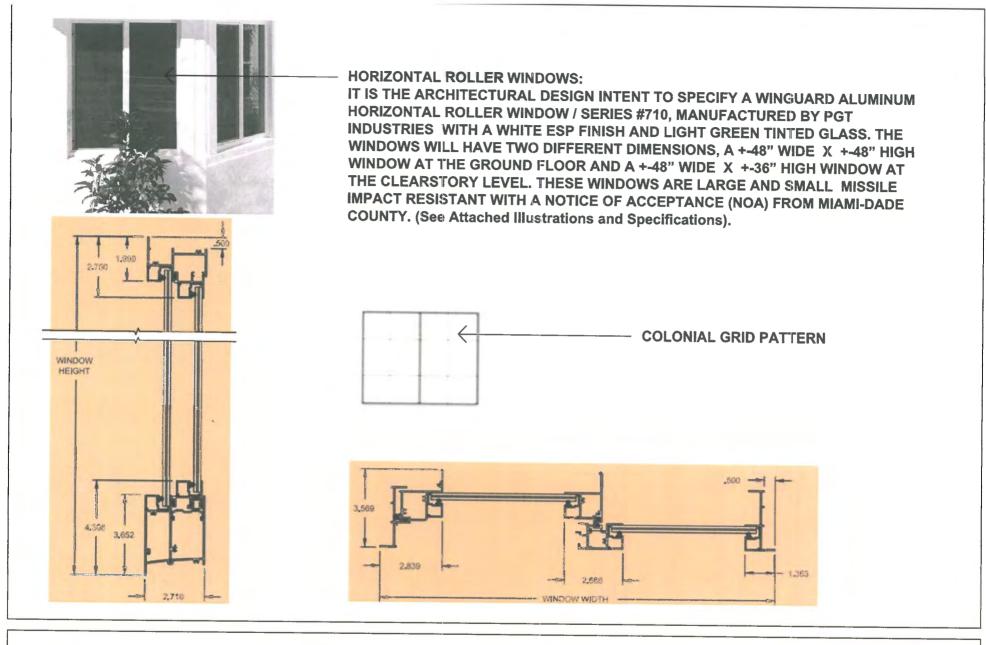
EXTERIOR WALL PANELS / BUILDING COLOR : IT IS THE ARCHITECTURAL DESIGN INTENT TO HAVE THE PRE-FABRICATED AND PRE-ENGINEERED WALL PANELS WITH AN EMBOSSED METAL FINISH ON ALL THE EXTERIOR SURFACES OF THE WALLS, PAINTED AT THE FACTORY BY THE MANUFACTURER, USING THE SELECTED BENJAMIN MOORE / #751 / 1B / SEA ISLE, AS THE EXTERIOR FINISH PAINT. SEE ATTACHED ORIGINAL COLOR CHIP.

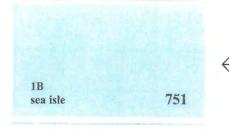

TRUMAN WATERFRONT PARK The City of Key West HARC SUBMITTAL July 01, 2014

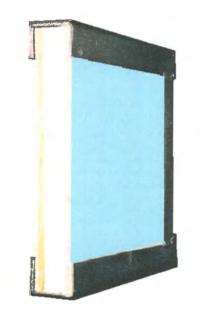HORSE STABLE FACILITIES EXTERIOR WALL PANELS / BUILDING COLOR





HORSE STABLE FACILITIES HORIZONTAL ROLLER WINDOWS





ba

TRUMAN WATERFRONT PARK The City of Key West HARC SUBMITTAL July 01, 2014

HORSE STABLE FACILITIES ROOF MATERIAL AND COLOR



- ROOF MATERIAL AND COLOR:

IT IS THE ARCHITECTURAL DESIGN INTENT TO SPECIFY A STANDING SEAM METAL ROOF SYSTEM, MANUFACTURED BY STANDARD STRUCTURES INC. (SSI) WITH AN "R" PANEL PROFILE THAT IS 1¼" HIGH X 36" WIDE (See illustration) AND A NATURAL SILVER FINISH FROM THE ACTUAL AND NATURAL 29 GA. ZINCALUME STEEL PANELS. (See Color Sample).

DEPARTMENT OF PERMITTING, ENVIRONMENT, AND REGULATORY AFFAIRS (PERA) BOARD AND CODE ADMINISTRATION DIVISION

NOTICE OF ACCEPTANCE (NOA)

PGT Industries, Inc.

1070 Technology Drive North Venice, FL 34275

SCOPE:

MIAMI-DADE COUNTY, FLORIDA PRODUCT CONTROL SECTION 11805 SW 26th Street, Room 208 Miami, Florida 33175-2474 T (786) 315-2590 F (786) 315-2599

www.miamidade.gov/pera/

This NOA is being issued under the applicable rules and regulations governing the use of construction materials. The documentation submitted has been reviewed and accepted by Miami-Dade County PERA --Product Control Section to be used in Miami-Dade County and other areas where allowed by the Authority Having Jurisdiction (AHJ).

This NOA shall not be valid after the expiration date stated below. The Miami-Dade County Product Control Section (In Miami-Dade County) and/ or the AHJ (in areas other than Miami-Dade County) reserve the right to have this product or material tested for quality assurance purposes. If this product or material fails to perform in the accepted manner, the manufacturer will incur the expense of such testing and the AHJ may immediately revoke, modify, or suspend the use of such product or material within their jurisdiction. PERA reserves the right to revoke this acceptance, if it is determined by Miami-Dade County Product Control Section that this product or material fails to meet the requirements of the applicable building code. This product is approved as described herein, and has been designed to comply with the Florida Building Code, including the High Velocity Hurricane Zone.

DESCRIPTION: Series "HR-710" Aluminum Horizontal Sliding Window - L.M.I.

APPROVAL DOCUMENT: Drawing No. 4127–10, titled "Alum. Horizontal Roller Window, Impact", sheets 1 through 11 of 11, dated 02/28/2006 with the latest revision "E" dated 10/17/2011, prepared by PGT Industries, Inc., dated 02/01/2012, signed and sealed by Anthony Lynn Miller, P. E., bearing the Miami–Dade County Product Control Revision stamp with the Notice of Acceptance number and Expiration date by the Miami–Dade County Product Control Section.

MISSILE IMPACT RATING: Large and Small Missile Impact Resistant.

LABELING: Each unit shall bear a permanent label with the manufacturer's name or logo, city, state, model/ series and following statement: "Miami-Dade County Product Control Approved" unless otherwise noted herein.

RENEWAL of this NOA shall be considered after a renewal application has been filed and there has been no change in the applicable building code negatively affecting the performance of this product.

TERMINATION of this NOA will occur after the expiration date or if there has been a revision or change in the materials, use, and/or manufacture of the product or process. Misuse of this NOA as an endorsement of any product, for sales, advertising or any other purposes shall automatically terminate this NOA. Failure to comply with any section of this NOA shall be cause for termination and removal of NOA.

ADVERTISEMENT: The NOA number preceded by the words Miami-Dade County, Florida, and followed by the expiration date may be displayed in advertising literature. If any portion of the NOA is displayed, then it shall be done in its entirety.

INSPECTION: A copy of this entire NOA shall be provided to the user by the manufacturer or its distributors and shall be available for inspection at the job site at the request of the Building Official.

This NOA revises NOA No. 11-0630.02 and consists of this page 1, evidence pages E-1, E-2 and E-3, as well as approval document mentioned above.

The submitted documentation was reviewed by Jaime D. Gascon, P. E.





NOA No. 11–1114.04 Expiration Date: December 21, 2016 Approval Date: February 16, 2012 Page 1

NOTICE OF ACCEPTANCE: EVIDENCE SUBMITTED

A. DRAWINGS

- 1. Manufacturer's die drawings and sections.
 - (Submitted under NOA's No.'s 07–0815.09 and 06–0405.06)

H

2. Drawing No. 4127-10, titled "Alum. Horizontal Roller Window, Impact", sheets 1 through 11 of 11, dated 02/28/2006 with the latest revision "E" dated 10/17/2011, prepared by PGT Industries, Inc., dated 02/01/2012, signed and sealed by Anthony Lynn Miller, P. E.

B. TESTS

1. Test reports on: 1) Large Missile Impact Test per FBC, TAS 201–94

2) Cyclic Wind Pressure Loading per FBC, TAS 203-94

Along with marked-up drawings and installation diagram of XOX aluminum horizontal sliding window, prepared by Fenestration Testing Laboratory, Inc., Test Report No. FTL-5330, dated 07/18/2007, signed and sealed by Carlos S. Rionda P. E.

(Submitted under NOA No. 07-0815.09)

- 2. Test reports on: 1) Air Infiltration Test, per FBC, TAS 202–94
 - 2) Uniform Static Air Pressure Test, Loading per FBC TAS 202-94

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- 3) Water Resistance Test, per FBC, TAS 202-94
- 4) Large Missile Impact Test per FBC, TAS 201-94
- 5) Cyclic Wind Pressure Loading per FBC, TAS 203-94
- 6) Forced Entry Test, Type "C" sliding window, Grade 10,

per FBC 2411 3.2.1, TAS 202-94 and per ASTM F 842-04

Along with marked-up drawings and installation diagram of XOX aluminum horizontal sliding window, prepared by Fenestration Testing Laboratory, Inc., Test Report No. FTL-4858, dated 03/08/2006, signed and sealed by Edmundo Largaespada, P. E.

(Submitted under NOA No. 06-0405.06)

3. Test reports on: 1) Air Infiltration Test, per FBC, TAS 202-94

2) Uniform Static Air Pressure Test, Loading per FBC TAS 202-94

3) Water Resistance Test, per FBC, TAS 202-94

4) Large Missile Impact Test per FBC, TAS 201-94

- 5) Cyclic Wind Pressure Loading per FBC, TAS 203-94
- 6) Forced Entry Test, Type "C" sliding window, Grade 10,

per FBC 2411 3.2.1, TAS 202-94 and per ASTM F 842-04

Along with marked-up drawings and installation diagram of XOX aluminum horizontal sliding window, prepared by Fenestration Testing Laboratory, Inc., Test Report No. FTL-4859, dated 03/08/2006, signed and sealed by Edmundo Largaespada, P. E.

(Submitted under NOA No. 06-0405.06)

Jaime D. Gascoh, P. E. Product Control Section Supervisor NOA No. 11--1114.04 Expiration Date: December 21, 2016 Approval Date: February 16, 2012

 $\mathbf{E} - \mathbf{1}$

PGT Industries, Inc.

NOTICE OF ACCEPTANCE: EVIDENCE SUBMITTED

C. CALCULATIONS

1. Anchor verification calculations and structural analysis, complying with FBC, prepared by PGT Industries, Inc., dated 10/26/06, signed and sealed by Robert L. Clark, P. E.

(Submitted under previous NOA No. 07–0815.09)

2. Complies with ASTM E1300-98/04

D. QUALITY ASSURANCE

1. Miami-Dade Department of Permitting, Environment, and Regulatory Affairs (PERA)

E. MATERIAL CERTIFICATIONS

- 1. Notice of Acceptance No. 11-0624.01 issued to E.I. DuPont DeNemours & Co., Inc. for their "DuPont Butacite® PVB Interlayer" dated 09/08/11, expiring on 12/11/16.
- 2. Notice of Acceptance No. 08-0206.01 issued to Solutia Inc. for their "Saflex HP Glass Interlayer" dated 04/17/2008, expiring on 04/17/2013.

F. STATEMENTS

- 1. Statement letter of conformance and compliance with the FBC-2007 (with the 2009 supplement) and FBC-2010, dated 10/25/11, signed and sealed by Anthony Lynn Miller, P. E.
- 2. Statement letter of no financial interest and independence, dated 10/25/11, signed and sealed by Anthony Lynn Miller, P. E.
- 3. Letter of Adoption of as his Own, the Work of another Engineer per Section 61G15-27.001 of the F.B.P.E., dated 10/07/11 signed and sealed by Anthony Lynn Miller, P. E.
- 4. Statement letter of no financial interest, conformance and compliance with the FBC-2007, dated 06/29/2011, signed and sealed by Robert L. Clark, P. E. (Submitted under previous NOA No. 11-0630.02)
- 5. Laboratory compliance letter for Test Report No. FTL-5330, issued by Fenestration Testing Laboratory, Inc., dated 07/18/2007, signed and sealed by Carlos S. Rionda, P.E.

(Submitted under previous NOA No. 07-0815.09)

Jaime D. Gascon, P. E. Product Control Section Supervisor NOA No. 11–1114.04 Expiration Date: December 21, 2016 Approval Date: February 16, 2012

NOTICE OF ACCEPTANCE: EVIDENCE SUBMITTED

F. STATEMENTS (CONTINUED)

6. Laboratory compliance letter for Test Reports No.'s FTL-4858 and FTL-4859, issued by Fenestration Testing Laboratory, Inc., dated 03/08/2006, signed and sealed by Edmundo Largaespada, P. E. (Submitted under NOA No. 06-0405.06)


G. OTHERS


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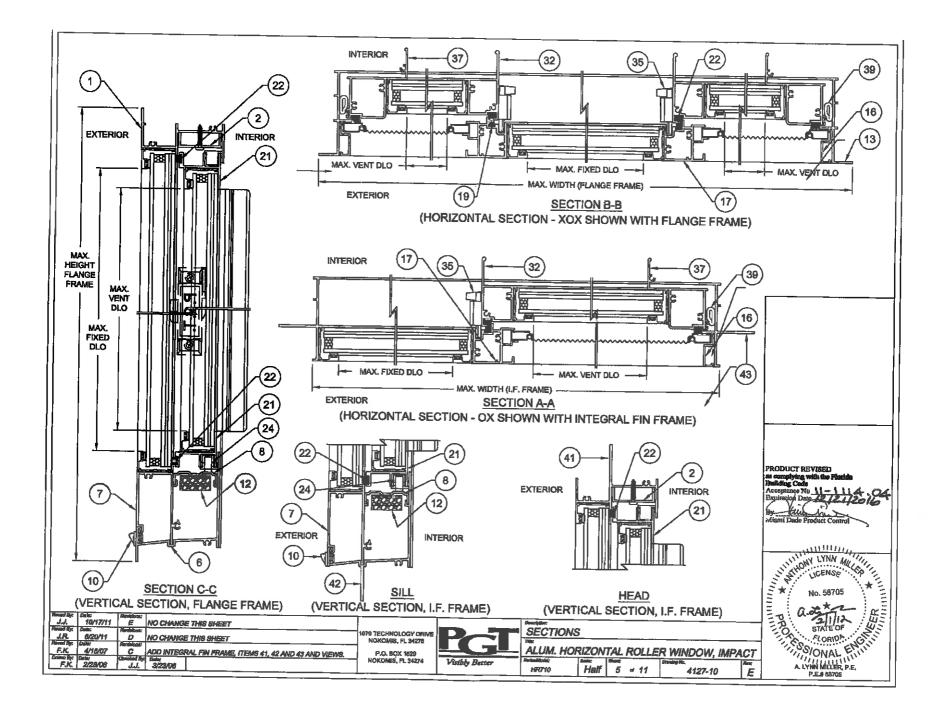
1. Notice of Acceptance No. 11–0630.02, issued to PGT Industries, Inc. for their Series "HR–710 Aluminum Horizontal Roller Window – L.M.I.", approved on 08/18/2011 and expiring on 12/21/2016.


Jaime D. Gascon, P. E. Product Control Section Supervisor NOA No. 11–1114.04 Expiration Date: December 21, 2016 Approval Date: February 16, 2012


GENERAL NOTES: IMPACT HORIZONTAL ROLLER FLANGED AND INTEGRAL FIN WINDOW	
1. GLAZING OPTIONS: (SEE DETAILS ON SHEET 2). FOR INSTALLATION ABOVE 30 FT, GLASS TYPES G THRU L MUST HAVE A TEMPERED GLASS CAP.	
A. 5/16" LAMI CONSISTING OF (2) LITES OF 1/8" ANNEALED GLASS WITH A .090 DUPONT BUTACITE OR SAFLEX/KEEPSAFE MAXIMUM PVB INTERLAYER.	
B. 518" LAMI CONSISTING OF (1) LITE OF 1/8" ANNEALED GLASS AND (1) LITE OF 1/8" HEAT STRENGTHENED GLASS WITH A .090 DUPONT BUTACITE OR SAFLEX/KEEPSAFE MAXIMUM PVB INTERLAYER.	
C. 5/16" LAMI CONSISTING OF (2) LITES OF 1/8" HEAT STRENGTHENED GLASS WITH AN .090 DUPONT BUTACITE OR SAFLEX/KEEPSAFE MAXIMUM PVB INTERLAYER.	
D. 7/16" LAMI CONSISTING OF (2) LITES OF 3/16" ANNEALED GLASS WITH AN .090 DUPONT BUTACITE OR SAFLEX/KEEPSAFE MAXIMUM PVB INTERLAYER.	
E. 716" LAMI CONSISTING OF (1) LITE OF 3/16" ANNEALED GLASS AND (1) LITE OF 3/16" HEAT STRENGTHENED GLASS WITH AN .090 DUPONT BUTACITE OR SAFLEX/KEEPSAFE MAXIMUM PVB INTERLAYER.	
F. 7/16" LAMI CONSISTING OF (2) LITES OF 3/16" HEAT STRENGTHENED GLASS WITH AN .090 DUPONT BUTACITE OR SAFLEX/KEEPSAFE MAXIMUM PVB INTERLAYER.	SHEET GENERAL NOTES
G. 13/16" LAMI IG: (1) LITE OF 1/8" OR 3/16" ANNEALED (MIN.) GLASS, 5/16" OR 3/8" AIR SPACE AND 5/16" LAMI CONSISTING OF (2) LITES OF 1/8" ANNEALED GLASS WITH A	GLAZING DETAILS
H. 13/16" LAMI IG: (1) LITE OF 1/8" OR 3/16" ANNEALED (MIN.) GLASS, 5/16" OR 3/8" AIR SPACE AND 5/16" LAMI CONSISTING OF (1) LITE OF 1/8" ANNEALED GLASS AND (1) LITE OF 1/8" HEAT STRENGTHENED GLASS WITH A .080 DUPONT BUTACITE OR SAFLEX/KEEPSAFE MAXIMUM PVB INTERLAYER.	VERT. SECTIONS
I. 13/16" LAMI IG: (1) LITE OF 1/8" OR 3/16" ANNEALED (MIN.) GLASS, 5/16" OR 3/8" AIR SPACE AND 5/16" LAMI CONSISTING OF (2) LITES OF 1/8" HEAT STRENGTHENED GLASS WITH AN .090 DUPONT BUTACITE OR SAFLEX/KEEPSAFE MAXIMUM PVB INTERLAYER.	EXTRUSIONS
J. 13/16" LAMI IG: (1) LITE OF 1/8" OR 3/16" ANNEALED (MIN.) GLASS, 3/16" OR 1/4" AIR SPACE AND 7/16" LAMI CONSISTING OF (2) LITES OF 3/16" ANNEALED GLASS WITH AN	
K. 13/16" LAMI IG: (1) LITE OF 1/8" OR 3/16" ANNEALED (MIN.) GLASS, 3/16" OR 1/4" AIR SPACE AND 716" LAMI CONSISTING OF (1) LITE OF 3/16" ANNEALED GLASS AND (1) LITE OF 3/16" HEAT STRENGTHENED GLASS WITH AN .090 DUPONT BUTACITE OR SAFLEX/KEEPSAFE MAXIMUM (PVB INTERLAYER.	
L, 13/16" LAMI IG: (1) LITE OF 1/8" OR 3/18" ANNEALED (MIN.) GLASS, 3/16" OR 1/4" AIR SPACE AND 7/16" LAMI CONSISTING OF (2) LITES OF 3/16" HEAT STRENGTHENED GLASS WITH AN .090 DUPONT BUTACITE OR SAFLEX/KEEPSAFE MAXIMUM PVB INTERLAYER.	
2. CONFIGURATIONS: OX, XO, XOX	
3. DESIGN PRESSURES: (SEE TABLES, SHEET 3)	
A. NEGATIVE DESIGN LOADS BASED ON TESTED PRESSURE AND GLASS TABLES ASTM E 1300-02.	
B. POSITIVE DESIGN LOADS BASED ON WATER TEST PRESSURE AND GLASS TABLES ASTM E 1300-02.	
4. ANCHORAGE: THE 33 1/3% STRESS INCREASE HAS NOT BEEN USED IN THE DESIGN OF THIS PRODUCT. SEE SHEETS 8 THROUGH 11 FOR ANCHORAGE DETAILS.	PRODUCT REVISED
6. SHUTTERS ARE NOT REQUIRED.	as complying with the Florida Building Code
6. FRAME AND PANEL CORNERS SEALED WITH NARROW JOINT SEALANT OR GASKET.	Acceptance No
7. REFERENCES: TEST REPORTS FTL-4858, FTL-4859 AND FTL-5330. ELCO TEXTRON NOA: 04-0721.01, 03-0225.05 ANSI/AF&PA NDS-2005 FOR WOOD CONSTRUCTION ADM-2005 ALUMINUM DESIGN MANUAL	By fills in the second
8. THIS PRODUCT HAS BEEN DESIGNED & TESTED TO COMPLY WITH THE REQUIREMENTS OF THE FLORIDA BUILDING CODE, INCLUDING THE HIGH VELOCITY	T ALIYON ALIYIN ALIYIN LYNN ALIYIN CENSE No. 58705 ALIYIN
9. FOR INSTALLATION IN THE HVHZ ABOVE 30 FT, GLASS TYPES G - L SHALL HAVE A TEMPERED I.G. GLASS CAP. BOTH THE DP AND ANCHOR QUANTITY REMAIN UNCHANGED.	No. 58705
JJ. 10/17/11 E FBC 2010 CODE CHANGE	
	FLORIDA ON
months in the second day basis for the second day basis in the second day basi	T ALYNNMILLER PE
HR710 NTS 1 = 11 4127-10 E	P.E.# 58705




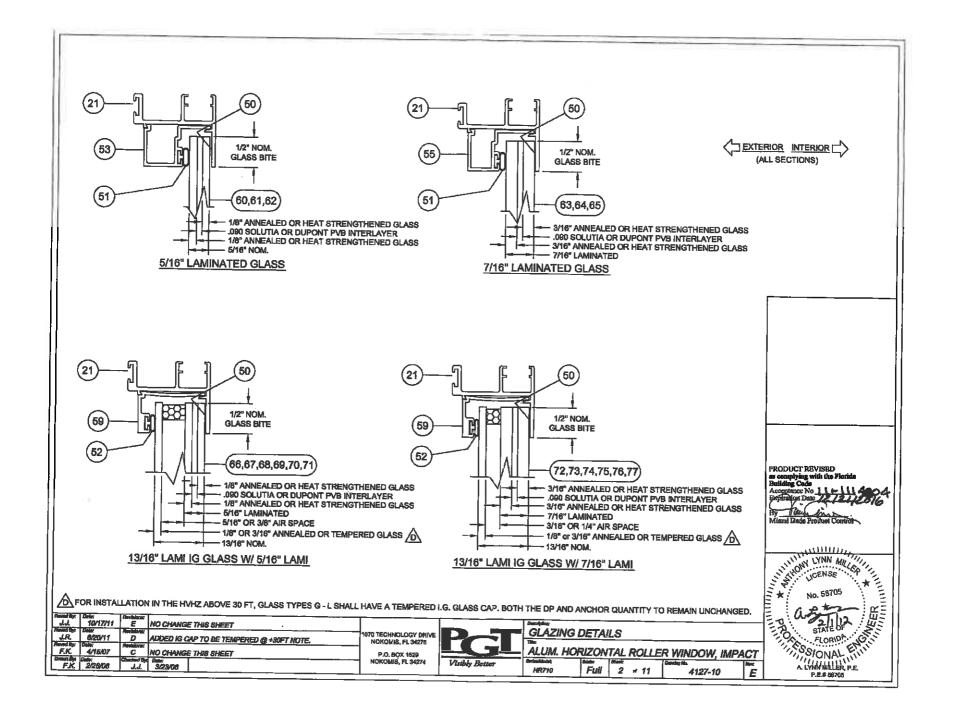

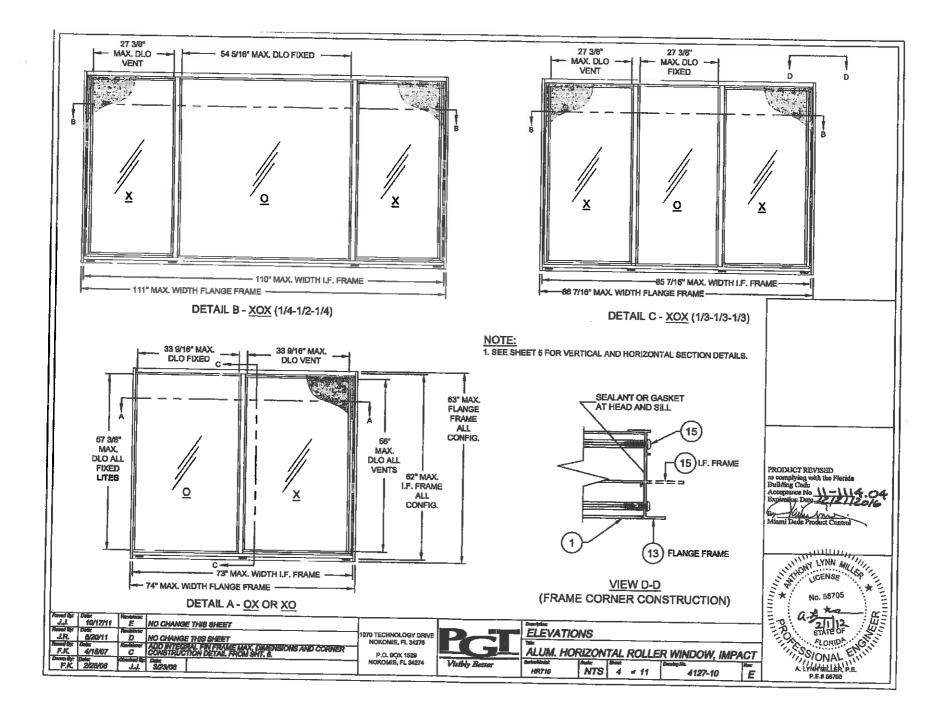

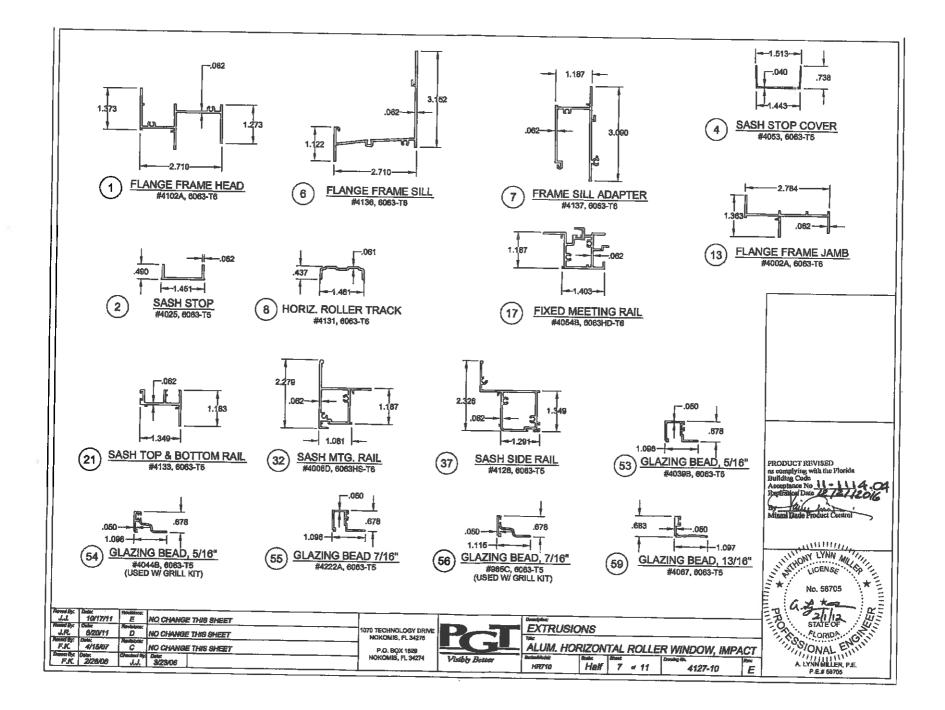

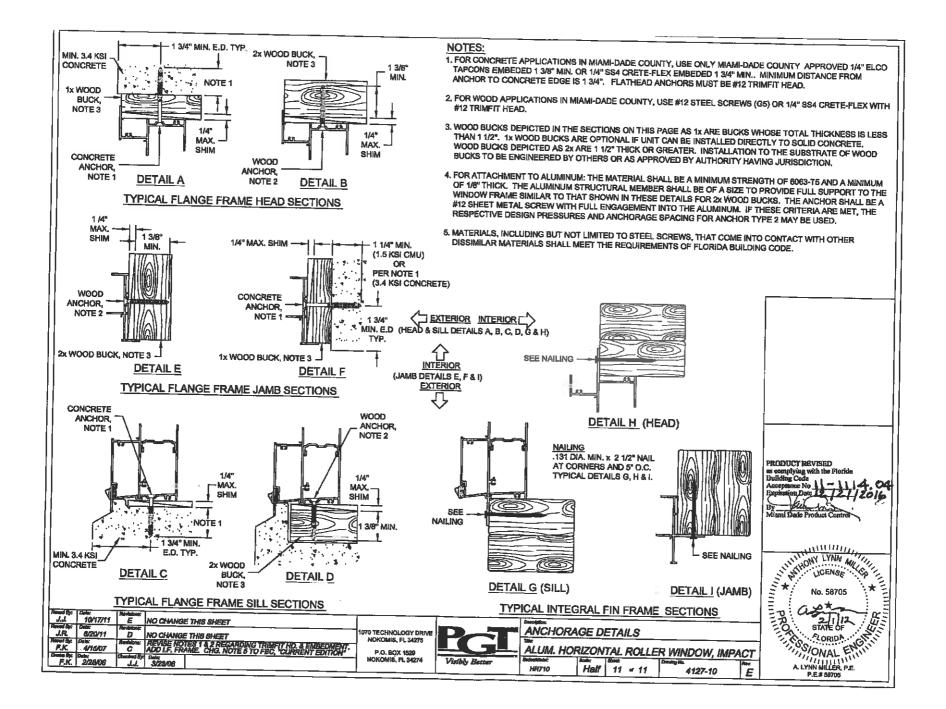

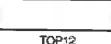



Design 12



--- GARAGE SECTIONAL / PANEL DOORS:

IT IS THE ARCHITECTURAL DESIGN INTENT TO SPECIFY A 8'-0" HIGH X 8'-0" WIDE, INSULATED STEEL FRAME, GARAGE SECTIONAL / PANEL DOOR, MANUFACTURE BY CLOPAY / GRAND HARBOR COLLECTION SERIES / DESIGN #12, WITH TOP WINDOW SECTIONS USING LIGHT GREEN TINTED GLASS. THESE DOORS ARE LARGE AND SMALL MISSILE IMPACT RESISTANT WITH A NOTICE OF ACCEPTANCE (NOA) FROM MIAMI-DADE COUNTY.

THEY WILL BE PAINTED TO MATCH THE EXTERIOR BUILDING WALL PANELS USING THE SELECTED COLOR FROM BENJAMIN MOORE / #751 / 1B / SEA ISLE, AS THE EXTERIOR FINISH PAINT, WITH RAISED VERTICAL AND HORIZONTAL BATTENS PAINTED WHITE (See Attached Illustrations and Specifications).



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TRUMAN WATERFRONT PARK The City of Key West HARC SUBMITTAL July 01, 2014

HORSE STABLE FACILITIES GARAGE SECTIONAL / PANEL DOORS






STORM READY™ – NO POSTS, PINS OR EXTRA SETUP. JUST CLOSE AND LOCK YOUR DOOR.

BENEFITS OF CLOPAY WINDCODE®

- No attachments to the floor or structure required
- No extra posts, pins, parts or setup necessary
- Storm ready, simply close and lock your door

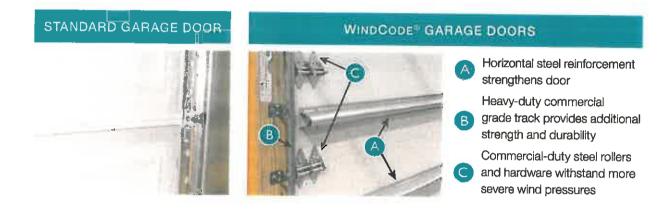

CLOPAY'S WINDCODE® GARAGE DOORS

Clopay's WINDCODE[®] garage doors are designed to help withstand high winds resulting from tropical storms and other strong wind-related weather events. This user-friendly system assists you in selecting the right garage door for your area and building structure.

DESIGN OPTIONS

Clopay's WINDCODE[®] product offering has the widest range of panel styles, colors and window designs available today. Accent the design of your home while providing the protection you need against strong winds. Choose from various panel designs and Designer or Decorative windows for that extra curb appeal. Impact-resistant windows are available in many different colors and wind load levels.

DESIGNED AND TESTED TO WITHSTAND STRONG WINDS

All Clopay's WINDCODE® doors have been designed and tested to meet various code requirements. Additional interior horizontal steel reinforcement along with increased hardware and springing components are installed so your door is ready when a storm hits. No posts or pins are required to secure your door if you are not there. Just lock your door.



WARMER. QUIETER. STRONGER.

Garage doors featuring Intellicore® insulation technology represent the ultimate smart choice for homeowners. Clopay's Intellicore is a proprietary polyurethane foam that is injected into a garage door, expanding to fill the entire structure. The result is a door with incredible strength and durability. Its dense insulation also produces a quieter door, while its industry-leading R-values (up to 20.4) provide



year-round comfort and improved energy efficiency.

Look for the Intellicore[®] icon throughout this brochure on select door models, WARMER Energy efficiency provides year-round comfort

1

QUIETER Dense insulation reduces noise by up to 16 decibels

STRONGER Enhanced strength resists everyday wear and tear

4



DETERMINE YOUR WINDCODE® RATING

Clopay assigns a WINDCODE® "W" rating to our doors based on code requirements determined by wind speed in miles per hour (MPH), home exposure and home structural type.

STEP 1:

 Determine the minimum wind speed (MPH) your door must meet or exceed from the map below, or go to www.atcouncil.org/windspeed. Determine if wind-borne debris is applicable. See map below.

WIND-BORNE DEBRIS

The wind-borne debris region is also known as those areas that require the large missile impact rated windows. In Florida, being farther south and closer to the shoreline, it is more likely a home or building will be in the wind-borne debris region.

Miami-Dade and Broward Counties require all garage doors meet the large missile impact rating, regardless if the garage door has windows or not. Standard windows are not available in Miami-Dade and Broward Counties.

ties WIND-BORNE DEBRIS REGIONS: WIND-BORNE DEBRIS REGIONS: Designated areas where the basic wind speed is 140 MPH or greater. T not. able in ties. 130 MPH and within 1 mile of the coast. 160 170

160


Insurance companies sometimes give discounts for garage doors and other exterior building products that exceed the local building code, including meeting wind-borne debris requirements not mandated. This means that installing a new garage door with the large missile impact rating may reduce your insurance premiums. Please check with your insurance agent for details.


STEP 2:


- Determine if your home is in an Exposure B, Exposure C or Exposure D region.
- Exposure B is defined as urban and suburban areas, wooded areas or other terrain with numerous closely spaced obstructions.
- Exposure C is defined as open terrain with scattered obstructions including flat open ground and grasslands. All of Miami-Dade and Broward Countles is Exposure C, unless it meets Exposure D definition.
- Exposure D is defined as being within 600 ft. of the ocean front or other large body of water measuring at least 5,000 feet across. Contact building code official or DASMA Technical Data Sheet #155t for design pressures.


STEP 3:

Determine the structural type of your home.

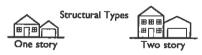

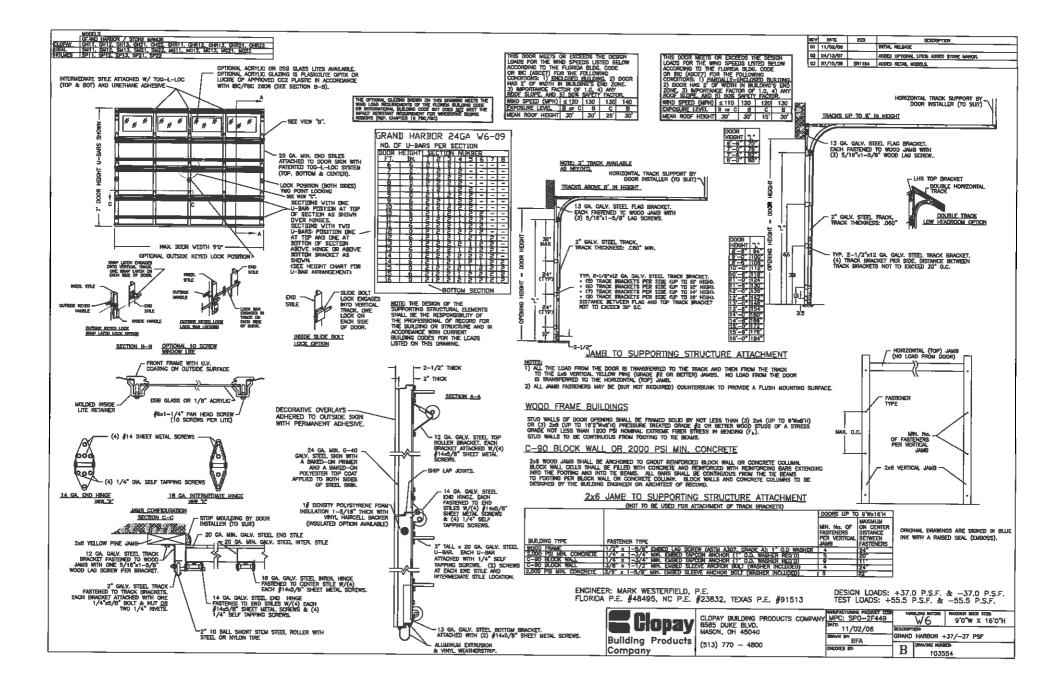

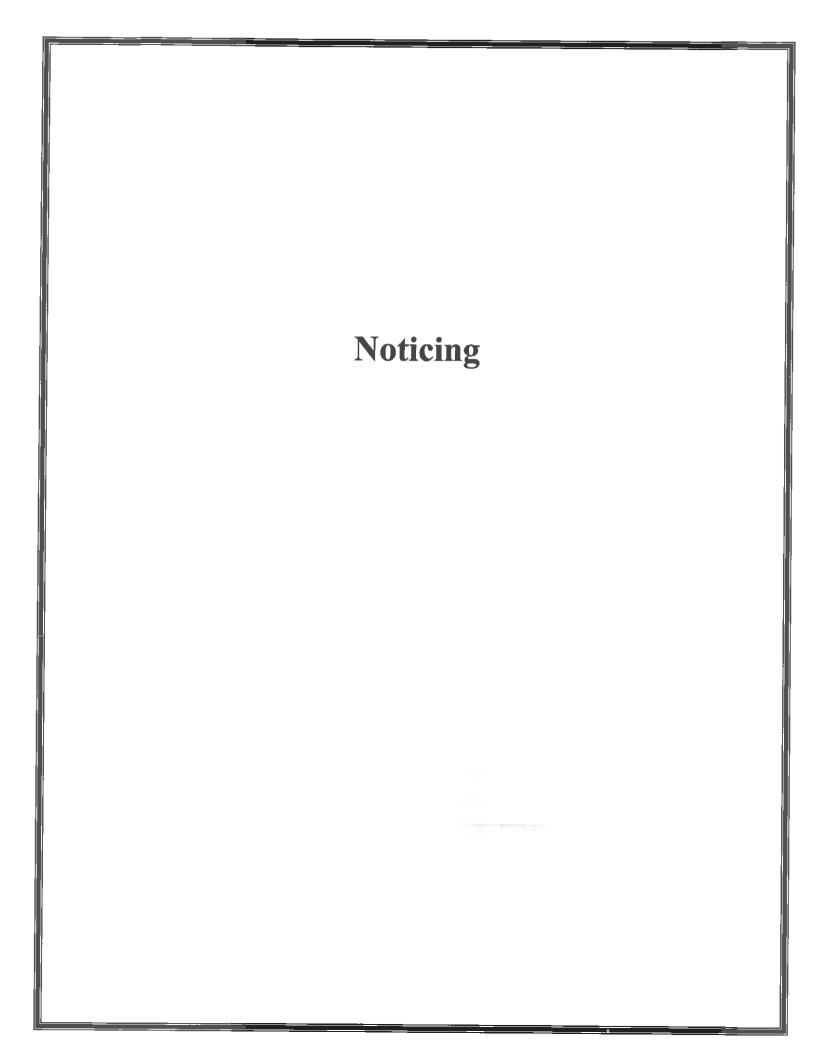

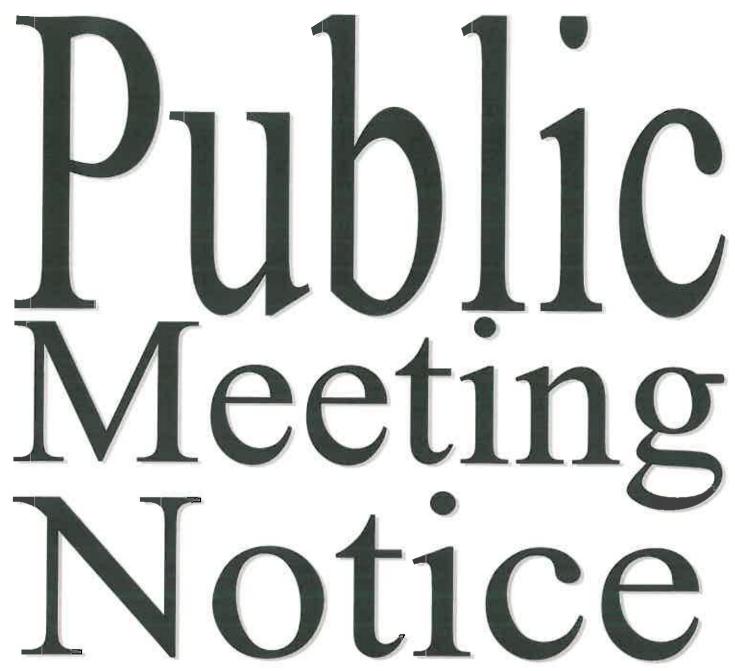

The Historic Architectural Review Commission will hold a public hearing <u>at 5:30 p.m., August 27, 2014 at Old</u> <u>City Hall, 510 Greene Street</u>, Key West, Florida. The purpose of the hearing will be to consider a request for:

NEW PRE-FABRICATED HORSE STABLES FACILITIES. FOR- SOUTHWEST CORNER OF TRUMAN WATERFRONT PARK

Applicant-City of Key West/ Bermello Ajamil Application # H14-01-1100

If you wish to see the application or have any questions, you may visit the Planning Department during regular office hours at 3140 Flagler Avenue, call 809-3973 or visit our website at <u>www.keywestcity.com</u>.

THIS NOTICE CAN NOT BE REMOVED FROM THE SITE UNTIL HARC FINAL DETERMINATION