## UNITED STREET IMPROVEMENTS



DATE: MAY 2014
PROJECT NUMBER 141015

PROJECT NAME: UNITED ST. IMPROVEMENTS
PREPARED BY: PEREZ ENGINEERING & DEVELOPMENT

PREPARED FOR: CITY OF KEY WEST, ENGINEERING SERVICES

SHEET TITLE

KEY WEST OFFICE


1010 EAST KENNEDY DRIVE, SUITE 201
KEY WEST, FLORIDA 33040

SHEET NUMBER

PLANS DESCRIPTION:

# CONSTRUCTION DRAWINGS UNITED STREET, FROM WHITE TO LEON STREETS KEY WEST, FLORIDA 33040



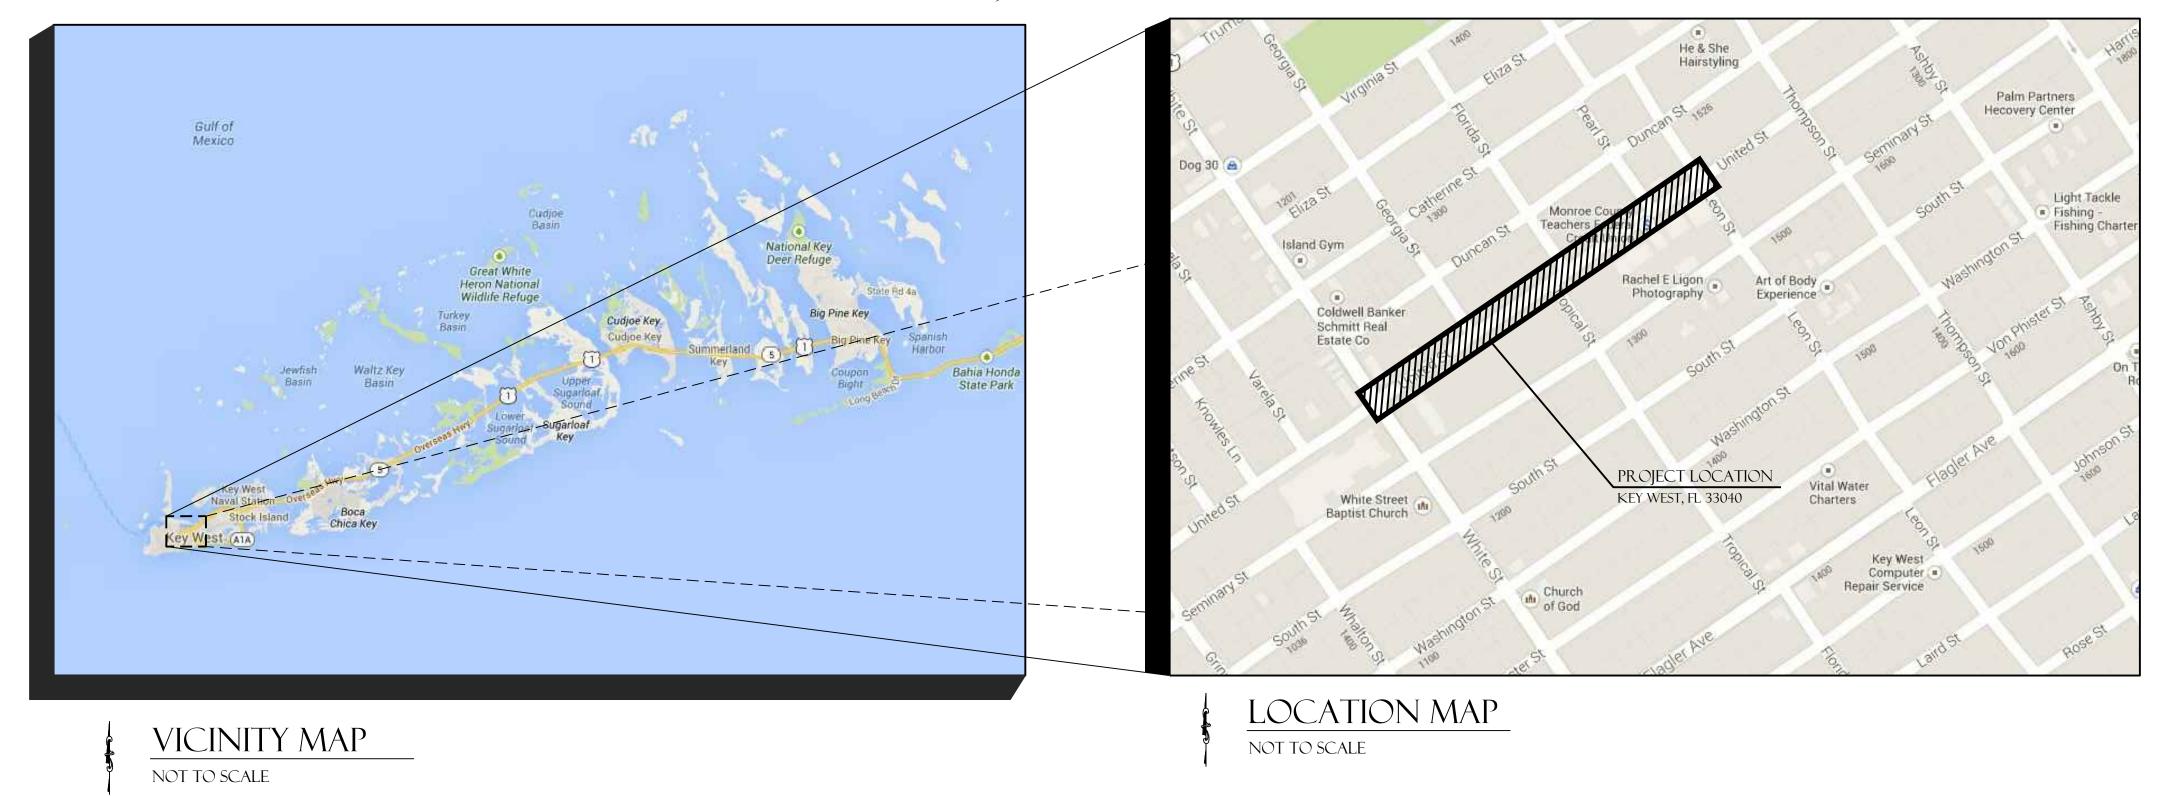

PREPARED FOR:

## CITY OF KEY WEST

P.O. BOX 1409
KEY WEST, FL 33041

REVISIONS:	DATE
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CIVIL ENGINEERING • REGULATORY PERMI	TTING • CONSTRUCTION MANAGEMENT
PEREZ ENGINEERING	KEY WEST OFFICE
	KET WEST OFFICE
& DEVELOPMENT, INC	1010 East Kennedy Drive, Suite 201
a develorment, inc	Key West, Florida 33040
CERTIFICATE OF AUTHORIZATION NO. 8579	TEL: (305) 293-9440 Fax: (305) 296-0243

PE	<u>NUMBER</u>	STATUS

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CIVIL

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DETAILS

ALLEN E. PEREZ, P.E.

NO. 51468

(SEAL)

DATE

#### **GENERAL NOTES**

- 1. THE CONTRACTOR SHALL REVIEW ALL DRAWINGS AND SPECIFICATIONS AND ADVISE THE ENGINEER OF ANY CONFLICTS OF REPRESENTATION BETWEEN DRAWINGS AND/OR SPECIFICATIONS PRIOR TO COMMENCING WITH CONSTRUCTION.
- 2. THE CONTRACTOR SHALL FIELD-VERIFY EXISTING CONDITIONS PRIOR TO PERFORMING ANY WORK UNDER THIS CONTRACT AND NOTIFY THE ENGINEER IN WRITING OF ANY DIFFERENCES BEFORE COMMENCING WITH ANY CONSTRUCTION.
- 3. HORIZONTAL COORDINATES ARE BASED ON FLORIDA STATE PLANE COORDINATE SYSTEM. VERTICAL ELEVATIONS ARE BASED ON NGVD 1929 DATUM.
- 4. THE LOCATIONS, SIZES, AND ELEVATIONS OF EXISTING UTILITIES AS SHOWN ARE APPROXIMATE. THE CONTRACTOR SHALL COORDINATE WITH THE ENGINEER TO OBTAIN ANY AVAILABLE RECORD DRAWINGS AND SHALL DETERMINE THE EXACT LOCATION AND ELEVATION IN THE FIELD. THE CONTRACTOR SHALL ANTICIPATE THAT SCANNING AND EXCAVATION USING LIGHT EQUIPMENT AND HAND METHODS WILL BE NECESSARY IN AREAS NEAR EXISTING UTILITIES AND STRUCTURES TO AVOID DAMAGING THESE FACILITIES. THE CONTRACTOR SHALL CONTACT BELLSOUTH, THE LOCAL TELEPHONE COMPANY AND COMCAST, THE LOCAL CABLE TV PROVIDER TO VERIFY THE LOCATION OF BURIED TELEPHONE AND CABLE TV UTILITIES. NONE HAVE BEEN INDICATED ON THE DRAWINGS. CALL 1-800-432-4770 BEFORE DIGGING OR TRENCHING OPERATIONS BEGIN. CONTRACTOR SHALL ALSO CONTACT KEYS ENERGY TO LOCATE SECONDARY ELECTRIC LINES.
- 5. THE CONTRACTOR SHALL DETERMINE THE EXACT LOCATION AND ELEVATION IN THE FIELD PRIOR TO INSTALLING ANY NEW WORK THAT CROSSES OR CONNECTS TO EXISTING UTILITY SYSTEMS. LOCATIONS OF NEW UTILITIES SHALL BE ADJUSTED IN A MANNER APPROVED BY THE ENGINEER TO AVOID CONFLICTS. DAMAGES TO UTILITIES RESULTING FROM THE CONTRACTOR'S OPERATIONS SHALL BE REPAIRED BY THE CONTRACTOR AT NO COST TO THE CLIENT.
- 6. ALL EXCAVATION, TRENCHING, SHEETING, SHORING AND BRACING SHALL BE INSTALLED AS REQUIRED IN ACCORDANCE WITH LOCAL, STATE, AND FEDERAL REGULATIONS, INCLUDING OSHA (29 CFR 1926).
- 7. ALL ITEMS INDICATED TO BE REMOVED OR DEMOLISHED SHALL BE REVIEWED WITH THE DEVELOPER TO DETERMINE IF THE ITEM IS TO BE PROPERTY OF THE CONTRACTOR. ALL ITMES SHALL BE REMOVED AND DISPOSED OF IN ACCORDANCE WITH ALL LOCAL, STATE, AND FEDERAL REGULATIONS, UNLESS OTHERWISE NOTED. NO SALVAGE VALUE IS EXPRESSED OR IMPLIED BY THESE CONTRACT DOCUMENTS FOR ANY ITEMS TO BE REMOVED OR DEMOLISHED.
- 8. THE CONTRACTOR SHALL BE RESPONSIBLE FOR THE SECURITY OF THE CONTRACTOR'S EQUIPMENT, MATERIALS, AND PERSONNEL, AND SHALL PROVIDE ADEQUATE BARRIERS TO PREVENT RISK TO OTHERS FROM THE CONTRACTOR'S ACTIVITIES.
- 9. WHERE ACTUAL DIMENSIONS AND SIZES ARE PROVIDED IN THE DRAWINGS, THEY SHALL TAKE PRECEDENCE OVER SCALED DIMENSIONS. LARGE SCALE DRAWINGS SHALL TAKE PRECEDENCE OVER SMALL SCALE DRAWINGS.
- 10. THE CONTRACTOR SHALL SEQUENCE HIS OPERATIONS SUCH THAT ORANGE MESH SAFETY FENCING IS PROVIDED ALONG ALL AREAS BEING TRENCHED AND NO TRENCH IS LEFT OPEN AT THE END OF THE WORK DAY.
- 11. NO CONNECTIONS FOR THE PURPOSE OF OBTAINING WATER SUPPLY DURING CONSTRUCTION SHALL BE MADE TO ANY FIRE HYDRANT OR BLOW-OFF STRUCTURE WITH OUT FIRST OBTAINING A CONSTRUCTION METER FROM THE FLORIDA KEYS AQUEDUCT AUTHORITY.
- 12. IF UNSATISFACTORY MATERIAL FOR ADEQUATE BEARING IS ENCOUNTERED AT THE NORMAL SUBGRADE, THE UNSATISFACTORY MATERIAL SHALL BE REMOVED AND REPLACED WITH SUITABLE FOUNDATION STABILIZATION MATERIAL AS SPECIFIED.
- 13. IN GENERAL, EXISTING STRUCTURES AND UTILITIES ARE NOTED AS EXISTING AND/OR SHOWN IN LIGHT LINE WEIGHT. NEW CONSTRUCTION IS SHOWN IN HEAVY LINE WEIGHT.
- 14. ALL FIELD LAYOUT AND SURVEYING FOR CONSTRUCTION OF THIS PROJECT SHALL BE PROVIDED BY THE CONTRACTOR AT HIS EXPENSE, UNDER THE DIRECTION OF A FLORIDA LICENSED PROFESSIONAL LAND SURVEYOR.

#### **NEW CONSTRUCTION NOTES**

- 1. IT IS THE CONTRACTOR'S RESPONSIBILITY DURING CONSTRUCTION OF NEW UTILITIES TO ANTICIPATE AND PLAN FOR CROSSINGS OF NEW AND EXISTING UTILITIES AND SUBSURFACE FEATURES. UTILITY LINES SHALL HAVE PRIORITIES AS FOLLOWS:

  A. GRAVITY SANITARY SEWER LINES SHALL BE CONSTRUCTED TO GRADES AS
- A. GRAVITY SANITARY SEWER LINES SHALL BE CONSTRUCTED TO GRADES AS INDICATED.
- B. ANY GRAVITY UTILITY DISCOVERED TO CONFLICT WITH GRADES FOR NEW SANITARY SEWER LINES SHALL BE IMMEDIATELY BROUGHT TO THE ATTENTION OF THE ENGINEER WITH POSSIBLE SOLUTIONS FOR HORIZONTAL AND VERTICAL ADJUSTMENT.
- C. POTABLE WATER LINES, ELECTRICAL, COMMUNICATION, AND CABLE TV DISTRIBUTIONS WILL REQUIRE RELOCATION AS NECESSARY TO ACCOMMODATE NEW SANITARY SEWER LINES. THE CONTRACTOR SHALL DETERMINE, PRIOR TO INSTALLATION, THE METHOD BY WHICH THESE LINES SHALL BE REROUTED ABOVE OR BELOW NEW SANITARY SEWER LINES. THE CONTRACTOR SHALL REFER TO THE CONSTRUCTION DRAWINGS AND SPECIFICATIONS FOR SEPARATION REQUIREMENTS BETWEEN INDIVIDUAL UTILITY LINES, BOTH HORIZONTALLY AND THE CONTRACTOR SHALL INCLUDE IN THE VERTICALLY, AND SPECIAL TREATMENT REQUIREMENTS. BID PRICE ANY SPECIAL TREATMENT REQUIRED FOR UTILITY INSTALLATION, INCLUDING ADJUSTMENTS OF EXISTING UTILITIES.
- 2. NEW SLABS SHALL BE GRADED TO POSITIVELY DRAIN WITHOUT ANY STORMWATER PONDING.
- 3. PROVIDE CONTRACTION JOINTS AT 12' O,C. MAX. JOINT PATTERNS IN PAVEMENTS AND SIDEWALKS SHALL BE GENERALLY SQUARE. AT CURBS PROVIDE FULL DEPTH EXPANSION JOINTS AT 100 FT. O.C. MAX, AND AT LOCATIONS WHERE STRAIGHT CURB RUNS CHAGE DIRECTIONS. AT SIDEWALKS PROVIDE WEAKENED PLANE CONTRACTION JOINTS NOT MORE THAN 5'=0" MAX. AND EXPANSION JOINTS AT 20-FT. O.C. MAX (TOOL ALL EDGES). INSTALL SELF-LEVELING SEALENT AT ALL ISOLATION/ EXPANSION JOINTS.

#### **EROSION CONTROL NOTES**

- 1. EROSION, SEDIMENT, AND TURBIDITY CONTROL MEASURES SHALL BE PROVIDED THROUGHOUT CONSTRUCTION. THE CONTRACTOR IS RESPONSIBLE FOR MAINTAINING AND REPAIRING ALL SLOPES AND SURFACES THROUGHOUT CONSTRUCTION AND UNTIL A STABLE SURFACE CONDITION EXISTS. THE CONTRACTOR SHALL MINIMIZE THE EXPOSED AREA AT ANY POINT DURING CONSTRUCTION AS MUCH AS PRACTICAL.
- FILTER FABRIC SILT FENCE SHALL BE IN CONFORMANCE WITH SECTION 985, FDOT SPECIFICATION.
- 3. CONTRACTOR SHALL INSTALL EROSION CONTROLS NOTED ON DRAWINGS AND APPLICABLE PERMITS, EROSION CONTROLS SHALL BE MAINTAINED UNTIL A PERMANENT STAND OF GRASS IS PLANTED ONSITE.
- 4. BALED HAY OR STRAW BARRIERS SHALL BE CONSTRUCTED AND MAINTAINED IN CONFORMANCE WITH FOOT INDEX NO. 103.
- 5. SILT FENCE LOCATIONS SHOWN HEREON ARE FOR CLARITY ONLY AND SHOULD BE CONSTRUCTED WITHIN PROPERTY LINES.
- 6. PROVIDE EROSION CONTROL MEASURES CONSISTING OF STAKED SILT FENCES AND HAY BALES ALONG THE PROPOSED LIMITS OF CONSTRUCTION AS INDICATED ON THE DRAWINGS. PROVIDE ADDITIONAL MEASURES AS NECESSARY TO AVOID ADVERSE IMPACTS TO JURISDICTIONAL AREAS (WETLANDS OR WATER BODIES) AND OFF-SITE LANDS AND WATERBODIES. MAINTAIN THESE MEASURED DAILY UNTIL CONSTRUCTION ACCEPTANCE BY THE OWNER AND THEN REMOVE AND LEGALLY DISPOSE OF SAID MEASURES.
- 7. EROSION CONTROL SHALL MAINTAINED WITHIN CONSTRUCTION AREA BY QUICKLY STABILIZING DISTURBED AREA TO PREVENT THE RELEASE OF SEDIMENT. THIS SHALL BE ACCOMPLISHED USING GRASS COVER, HAY BALES AND OTHER MEANS ACCEPTABLE TO OWNER, ENGINEER AND REGULATORY AGENCIES.
- 8. DURING CONSTRUCTION, THE CONTRACTOR SHALL, AT THE REQUEST OF THE OWNER OR AS NECESSARY MODIFY, RELOCATE THE ENVIRO-FENCE AND/OR SILT FENCE TO ALLOW FOR ACCESS AND TO COMPLETE CONSTRUCTION. IT IS THE CONTRACTOR'S RESPONSIBILITY TO MAINTAIN ADEQUATE EROSION CONTROL AT ALL TIMES.
- 9. DURING CONSTRUCTION, THE CONTRACTOR WILL PROVIDE TEMPORARY SEEDING AND MULCHING FOR AREA THAT HAVE BEEN CLEARED AND NOT REWORKED WITHIN 7 CALENDAR DAYS DURING THE WET SEASON (APRIL THROUGH SEPTEMBER AND 14 CALENDAR DAYS DURING THE DRY SEASON (OCTOBER THROUGH MARCH). ALSO, ALL SIDE SLOPES SHALL BE SODDED OR SEEDED AND MULCHED WITHIN 7 DAYS DURING WET SEASON AND 14 DAYS DURING THE DRY SEASON.
- 10. ALL SURFACE WATER DISCHARGE FROM SITE, INCLUDING DEWATERING DISCHARGE SHALL MEET STATE WATER QUALITY STANDARDS (LESS THAN 29 NTU ABOVE BACKGROUND) PRIOR TO REACHING ANY WATERS OF THE STATE INCLUDING WETLAND.
- 11. IN THE EVENT THAT THE EROSION PREVENTION AND CONTROL DEVICES SHOWN IN THESE PLANS PROVE NOT TO BE EFFECTIVE. ALTERNATE METHODS FOR MAINTAINING STATE WATER QUALITY STANDARDS FOR DISCHARGE FROM THE CONSTRUCTION SITE WILL BE REQUIRED. ANY ALTERNATE EROSION PREVENTION AND CONTROL DEVICES MUST BE APPROVED BY MONROE COUNTY AND SFWMD COMPLIANCE PERSONNEL PRIOR TO PLACEMENT.

#### **LEGEND**


#### **GENERAL**

TL 1500 TAX LOT NUMBER

CONTRACTOR'S SURVEY REFERENCE

5 KEY NOTE MARKER

(9) (ON SITE PLAN) # OF PARKING SPACES

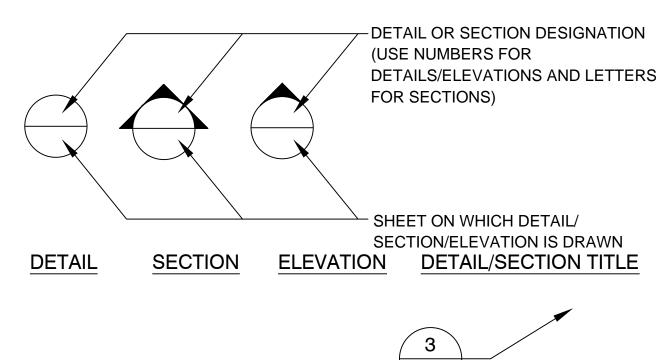

DETAIL REFERENCE BUBBLE

DETAIL TITLE BUBBLE SINGLE REFERENCE 3 SAMPLE DETAIL
SCALE: NTS

BUBBLE SYMBOLS

REVENIENT REPORT OF THE PROPERTY OF THE PROPER

JOB NO. \_\_\_\_\_\_141015 DRAWN \_\_\_\_\_\_\_BGO DESIGNED \_\_\_\_\_AEP CHECKED \_\_\_\_\_AEP

OF

SHEET

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