

### **Staff Report for Item 6b**

**To:** Chairman Michael Miller and Historic Architectural Review

**Commission Members** 

**From:** Kelly Perkins

HARC Assistant Planner

Meeting Date: April 28, 2015

**Applicant:** McKendry Builders

**Application Number:** H15-01-0349

Address: #921 Center Street

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### **Description of Work:**

Demolition of shed.

### **Site Facts:**

#921 Center Street is a condominium development constructed after 1962 and is listed as a non-contributing resource in the survey. According to the Property Appraiser's Office, it was built in 1980. The shed in question is a frame structure that serves as storage and a laundry room. It is not visible from the public right-of-way.

### **Ordinance Cited in Review:**

Sec. 102-217 (2): Demolition of non-historic or non-contributing buildings, Sec. 102-218: Criteria for demolitions, and Sec. 102-125: Historic architectural review commission findings precedent to issuance in the Land Development Regulations.

### **Staff Analysis**

This Certificate of Appropriateness proposes the demolition of a frame structure that serves as a laundry room and a storage room. It is not historic and not visible at all. Staff believes it does not meet any of the criteria listed in Sec.102-125, and therefore it can be considered for demolition. As it is not historic, only one reading is required for demolition.

### APPLICATION

### COMBINATION APPLICATION: FLOODPLAIN, CONSTRUCTION AND HARC

\$50.00 APPLICATION FEE NON-REFUNDABLE



### City of Key West

3140 FLAGLER AVENUE KEY WEST, FLORIDA 33040

HARC PERMIT N		BUILDING PER	884	INITIAL & DATE	
FLOODPLAIN PE	RMIT			REVISION #	
FLOOD ZONE	PANEL#	ELEV. L. FL.	SUBSTANTIAL	. IMPROVEMENT	


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ADDRESS OF PROPOSED PROJEC	T: 921 Cente	r St. Key (	nest	# OF UNITS	
RE#OR ALTERNATE KEY:					و [
NAME ON DEED:	Jens Nies	en	PHONE NUMBE	954-540-1117	1/
OWNER'S MAILING ADDRESS:	921 Center	(1)	EMAIL \ De	sen9545401117@Gmo	cor
				Colonial Colonial	
CONTRACTOR COMPANY NAME:	McKendy B	DULIGETS INC	PHONE NUMBE	5-304-7937	1 ,
CONTRACTOR'S CONTACT PERSO	DN: Brian Mc	Kenday	EMAIL	moulderine concest.	er
ARCHITECT / ENGINEER'S NAME:			PHONE NUMBE	RDECETARES	3
ARCHITECT / ENGINEER'S ADDRES	SS:		EMAIL	MAD 1 a coas	
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PART B:


### SUPPLEMENTARY PROJECT DETAILS TO AVOID DELAYS / CALL-BACKS

	PROPERTY STRUCTURES AFFECTED BY PROJECT:MAIN STRUCTUREACCESSORY STRUCTURESITE
	ACCESSORY STRUCTURES:GARAGE / CARPORTDECKFENCEOUTBUILDING / SHED
	FENCE STRUCTURES:4 FT6 FT. SOLID6 FT. / TOP 2 FT. 50% OPEN
	POOLS: INGROUND ABOVE GROUND SPA / HOT TUB PRIVATE PUBLIC
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į.	POLE WALL PROJECTING AWNING HANGING WINDOW
- 7	SQ. FT. OF EACH SIGN FACE:
	SUBCONTRACTORS / SPECIALTY CONTRACTORS SUPPLEMENTARY INFORMATION:
	MECHANICAL:DUCTWORKCOMMERCIAL EXH. HOOD INTAKE / EXH. FANS LPG TANKS
3	A/C:COMPLETE SYSTEM AIR HANDLER CONDENSER MINI-SPLIT
	ELECTRICAL: LIGHTING LECEPTACLES HOOK-UP EQUIPMENT LOW VOLTAGE
2	SERVICE:OVERHEADUNDERGROUND1 PHASE3 PHASE AMPS
	PLUMBING:ONE SEWER LATERAL PER BLDGINGROUND GREASE INTCPTRSLPG TANKS
	RESTROOMS: MEN'S WOMEN'S UNISEX ACCESSIBLE
	PART C: HARC APPLICATION FOR A CERTIFICATE OF APPROPRIATENESS
	APPLICATION FEES: PAINTING SINGLE FAMILY: \$10 STAFF APPROVAL: \$50 COMMISSION REVIEW \$100
	PLEASE ATTACH APPROPRIATE VARIANCES / RESOLUTIONS FROM HARC, PLANNING BOARD OR TREE COMMISSION.
	ATTENTION: NO BUILDING PERMITS WILL BE ISSUED PRIOR TO HARC APPROVAL.
	SI EACE CEND SI ECTRONIC CURNICCIONO TO ANNA COME OF THE CONTRACT OF THE CONTR
	PLEASE SEND ELECTRONIC SUBMISSIONS TO: <a href="https://harc@cityofkeywest-fl.gov">https://harc@cityofkeywest-fl.gov</a> NDICATE TYPE OF CERTIFICATE. OF APPROPRIATENESS:GENERALDEMOLITIONSIGNPAINTING OTHER
_	ADDITIONAL INFORMATION:
	PROJECT SPECIFICATIONS: PLEASE PROVIDE PHOTOS OF EXISTING CONDITIONS, PLANS, PRODUCT SAMPLES, TECHNICAL DATA  INCHITECTURAL FEATURES TO BE ALTERED:  IPROPOSED MATERIAL:  IPROPOSED MATERIAL:
	RCHITECTURAL FEATURES TO BE ALTERED: ORIGINAL MATERIAL: PROPOSED MATERIAL:
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1	
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- 1	DEMOLITION: PLEASE FILL OUT THE HARC APPENDIX FOR PROPOSED DEMOLITION.
	DEMOLITION OF HISTORIC STRUCTURES IS NOT ENCOURAGED BY THE HISTORIC ARCHITECTURAL REVIEW COMMISSION.
	IGNAGE: (SEE PART B) BUSINESS SIGN BRAND SIGN OTHER: Oper: KEYWBLD Type: BP Drawer: 1
	2015 1000349
E	SUSINESS LICENSE # IF FAÇADE MOUNTED, SQ. FT. OF FAÇADE # RIFLDING PERMITS-NEW
	1.06 \$50.00 Trans number: 3043717
	CX CHECK 3113 \$50.88
	Frans date: 3/23/15 Fime: 16:59:35
	ALIENTA SERVICE

	·	SIGN SPECIFICATION		
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OFFICIAL USE ONLY	: H	ARC STAFF OR COMMISSION	REVIEW	
APPROVED _	NOT APPROVED	_DEFERRED FOR FUTURE C	ONSIDERATION	_TABLED FOR ADD'L. INFO.
HARC MEETING DATE:		HARC MEETING DATE:	н	ARC MEETING DATE:
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IARC PLANNER SIGNATL	RE AND DATE:	HARC CH	AIRPERSON SIGNATURE A	MAR 1 0 2015
PART D:	STATE OF FLOR	IDA OFFICIAL NOTIF	ICATIONS AND	BY: Me 8 :35 WARNINGS
LORIDA STATUTE 713.13				RESULT IN YOUR PAYING TWICE FOR
				ORDER AND A COPY POSTED ON THE JOB SITE
				RHEY BEFORE RECORDING A NOTICE.
				CTION APPLIED FOR IN THIS APPLICATION, IT TO DEMOLISH / REMOVE ASBESTOS.
ADDITION TO THE REQ	UIREMENTS OF THIS PERMIT AF	PPLICATION, THERE MAY BE DEED	RESTRICTIONS AND / OR /	ADDITIONAL RESTRICTIONS APPLICABLE TO THIS
				ERMIT'S REQUIRED FROM OTHER GOVERNMENT
		OR OTHER STATE AGENCIES; ARI		
EDERAL LAW REQUIRES	LEAD PAINT ABATEMENT PER	THE STANDARDS OF THE USDEP	ON STRUCTURES BUILT P	RIOR TO 1978.
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1962 Sanborn Map

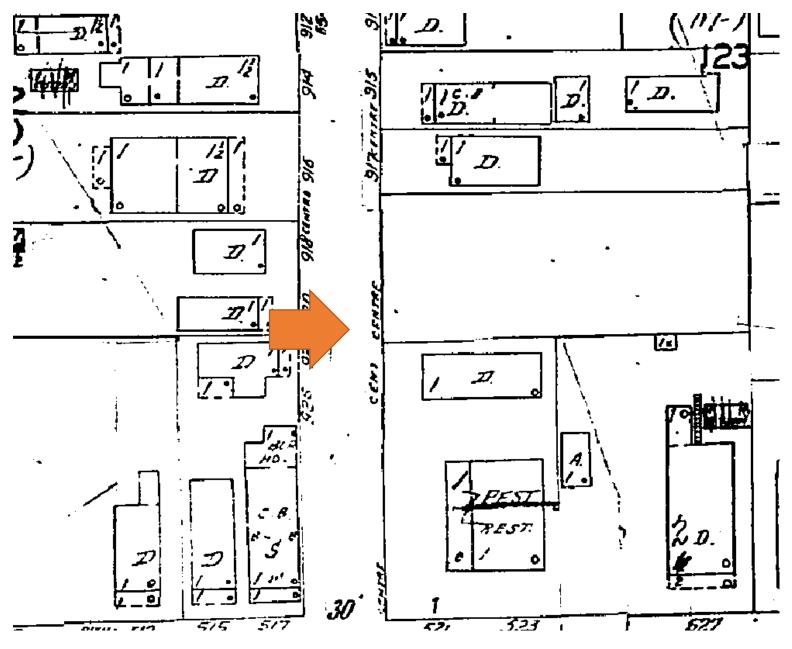


2011 Google Earth Aerial

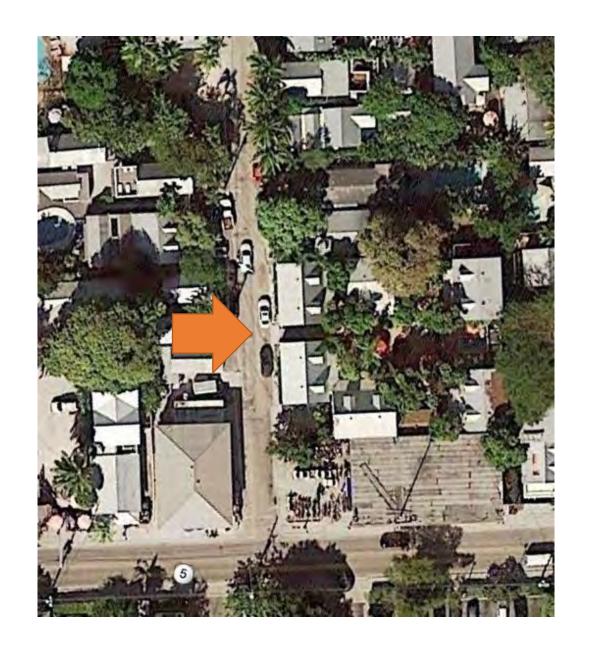
## PROJECT PHOTOS




921 Center Street today.

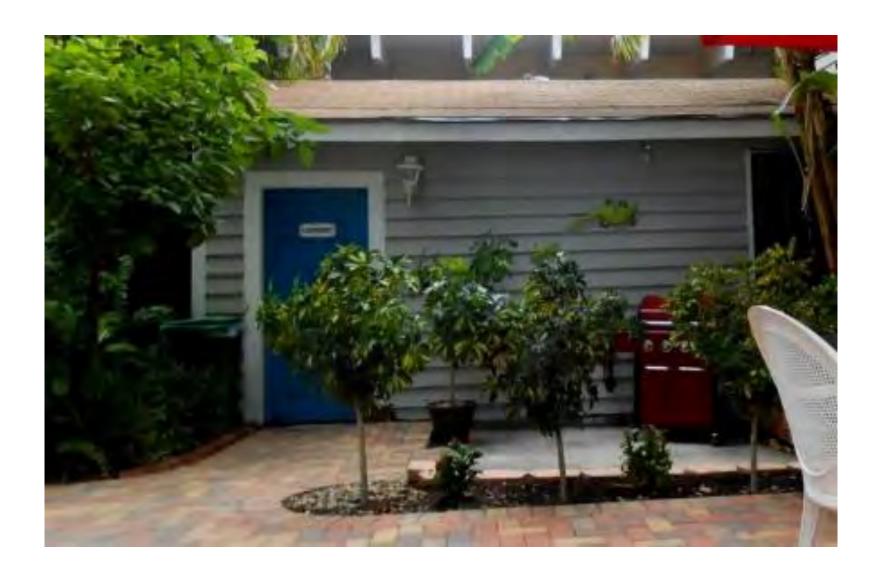




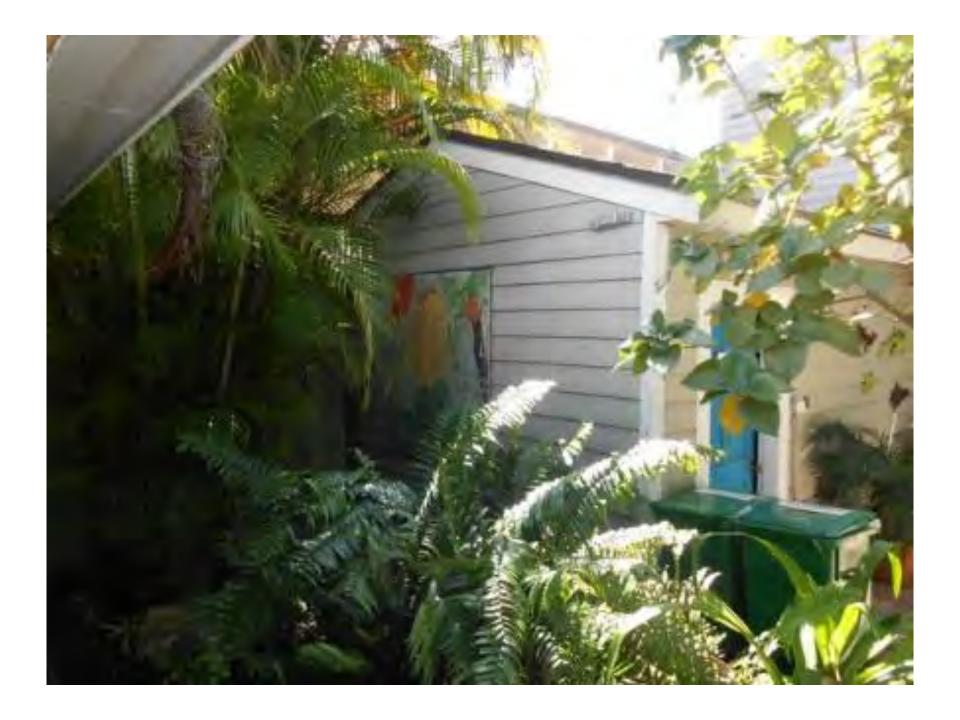

### Boundary Survey Map of main Common Area OLD TOWN GARDEN VILLAS LEGEND © Found . (2" For rod (1) in adobte) Set 1/2" in right in 1988) a Sol ( a Spin (4582) (ii) MadaLinii Care As (March Manager) & English TIN Tyre of Joy E. Communication of Strain Strain. 8 3 3 W. 44 P.S. representation that Tuestory Transa<sub>7,0</sub> Truman Ave. riga. Prosifika Planta 193.99" (6) 19.500 (41) Material ing,; Center 35" (11:40) St 2 of the Sheets J. LYNN O'FLYNN, Inc. Profession 1 Surveyer & Maprice Man To Comp Man of the State of the R Comp Respect

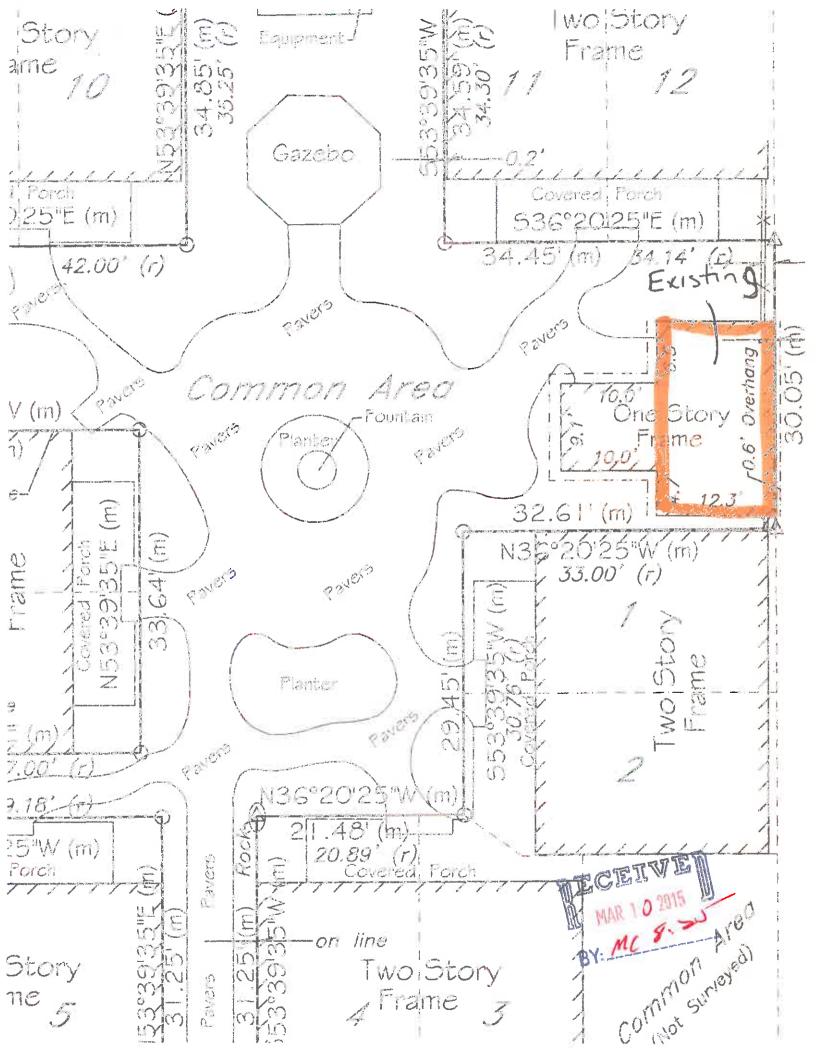

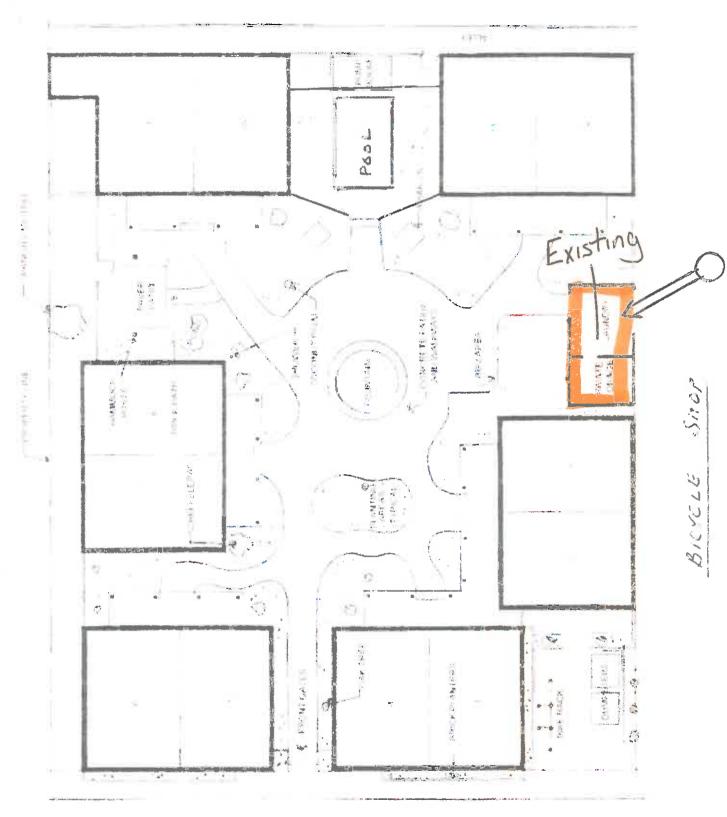

### CENTER STREET





1 ages

### 180 mph (ult) - Standard Wood Shed Master Plan

### GENERAL NOTES:

- 1. THIS STRUCTURE WAS DESIGNED IN ACCORDANCE WITH THE 2009 IBC BUILDING CODE \$ 2010 FLORIDA BUILDING CODE. WIND LOADING DESIGNED IN ACCORDANCE WITH THE ASCE - 7-10.
- 2. ALL MATERIALS AND LABOR SHALL BE IN ACCORDANCE WITH THE ABOVE CODE AND ALL OTHER APPLICABLE LOCAL CODES AT THE TIME OF
- 3. WRITTEN DIMENSIONS SHALL TAKE PRECEDENCE OVER SCALED DIMENSION.
- OUTSIDE OVERALL DIMENSIONS CAN VARY BETWEEN LIMITS SHOWN BUT MEMBER SPACING SHALL NOT EXCEED LIMITS AS INDICATED.
- LUMBER USED FOR CONSTRUCTION SHALL BE AS FOLLOWS: S.Y.P. 2x's #2-(12-15% MOISTURE CONTENT) FLOOR JOISTS: 2x4 5.Y.P. #2-(12-15% MOISTURE CONTENT) WALL STUDS: S.Y.P. 2x's #2-(12-15% MOISTURE CONTENT) ROOF RAFTERS: COLLAR TIES-2x4 S.Y.P. #2-(12-15% MOISTURE CONTENT) 2x4 5.Y.P. #2-(12-15% MOISTURE CONTENT) WINDOW SILLS-WHEN S.Y.P. #2 IS USED. THE FRAMING MUST BE SPACED AT 18" O.C., MAX. WITHIN 3'-0" FROM EACH SIDE OF EACH CORNER, THE REST OF THE FRAMING MAY BE SPACED AT 16" O.C., MAX.
- ALL OF THE FOLLOWING LUMBER SHALL BE PRESSURE TREATED: SKIDS. FLOOR JOISTS AND 3/4" T&G FLOOR SHEATHING
- TRUSS DESIGNED TO SUPPORT D.L.+L.L.=30 P.S.F.
- HANDICAP ACCESS TO BUILDING IS FIELD INSTALLED BY OTHERS AND SUBJECT TO LOCAL JURISDICTION APPROVAL.
- ALL ALUMINUM TO BE 3005-3105 ALLOY WITH 32,000 PSI MINIMUM YIELD STRENGTH.
- 10. ROOF SLOPE SHALL BE 3:12 WHEN SHINGLES ARE APPLIED, SEE FBC 1507.2 FOR SHINGLE REQUIREMENTS. ROOF SLOPE FOR METAL ROOFS SHALL MEET MANUFACTURER'S RECOMMENDATIONS
- 11. ROOF RAFTERS SHALL HAVE THE SAME SPACING AS THE WALL STUDS AND SHALL BE LOCATED DIRECTLY OVER THE WALL STUD.
- 12. ROOF SLOPES BETWEEN 2:12 AND 4:12 SHALL HAVE A DOUBLE UNDERLAYMENT APPLICATION IN ACCORDANCE WITH SECTION 1507,2,8 OF THE F.B.C. 2010
- 13. WHEN ROOFING PANELS ARE PLACED VERTICALLY DADO IN 1x4's AT 24" O.C., MAX. FASTEN TO EACH RAFTER W/ (3) - O.131"x 21/4" LONG GUN NAILS OR 3"x1-1/4" x16 Ga. HAT CHANNEL PURLINS ARE REQUIRED. WITH A MAX SPACING OF 4' O.C.
- 14. ANCHORS SHALL MEET THE REQUIREMENTS OF ALL APPLICABLE LOCAL CODES AND THIS IS NOT A FOUNDATION DESIGN.
- 15. ALUMINUM WINDOWS TYPE, SIZE, QUANTITY, AND LOCATION MAY VARY.
- 16. ALL FASTENERS INTO P.T. WOOD SHALL BE HOT DIPPED GALVANIZED FASTENERS.
- 17. MANUFACTURER INSTALLATION STANDARDS SHALL BE FOLLOWED IN ORDER FOR THESE DESIGN DRAWINGS TO ACCURATELY REFLECT FIELD PERFORMANCE CONDITIONS.
- 18. THESE STRUCTURES SHALL NOT BE USED FOR COMBUSTIBLE OR HAZARDOUS MATERIAL

### Amazon Sheds & Gazebos Inc.

10311 Bonita Beach Road Bonita Springs, FL 34135

	Sheet Index
S1.0	Cover - General & Design Notes
S1.1	Electrical & General Floor Plan
S1.2	Skids & Floor Framing Plan
S1.3	Skid and Floor Framing Details
S1.4	Openings Schedule & Framing
S1.5	Roof Framing & Schedule
S1.6	Typical Frame Section Details
S1.7	End Wall Frame Options

### GENERAL NOTES CONTINUED:

- 19. OPTIONAL EXTERIOR WALL COVERINGS INCLUDE CORRUGATED ALUMINUM, MASA ALUMINUM, 4" LAP ALUMINUM, 5/8" P.T. TI-II SIDING, VINYL SIDING WITH ENERGY BRACE BACKER. HARDI BOARD, STEEL SIDING AND "PLEKO" STUCCO ON 5/8" DENSE GLASS GOLD.
- 20. ALL DOORS SHALL BE ABLE TO BE OPENED FROM THE EGRESS SIDE WITHOUT THE USE OF A KEY.
- 21. DOOR SHALL BE 2 1/4" x 11/16" ALUMINUM EXTRUDED FRAME WITH AN ALUMINUM PANEL INSERT, ALUMINUM TRIM AND ALUMINUM PIANO HINGE ATTACHED WITH ALUMINUM RIVETS. DOOR ATTACHED TO VERTICAL 2x4.
- 22. OPTIONAL DOORS INCLUDE DOUBLE ALUMINUM DOORS, GARAGE DOORS, 60" x 72" ALUMINUM DOOR, 32" AND 48" SINGLE DOORS, AND PRE HUNG STEEL DOORS, TYPE, SIZE, QUANTITY, AND LOCATION MAY VARY.
- 23. PREMANUFACTURED DOORS THAT MEET APPLICABLE CODES MAY BE USED INSTEAD OF DOORS LISTEL ABOVE
- 24. MAXIMUM WALL HEIGHT TO BE 8'-0", STUD AND RAFTER SPACING SHALL BE 16" O.C., Max. FOR ANY WALL HEIGHT ABOVE 7'-0", WALLS UNDER 7'-0" IN HEIGHT MAY HAVE FRAMING SPACED AT 24" O.C., Max.
- 25. ALL BRAND MATERIALS SPECIFIED MAY BE SUBSTITUTED FOR EQUIVALENT OR GREATER PRODUCT.
- 26. ALL BUILDINGS (EXCEPT THOSE IN USE AS AN ACCESSORY BUILDING FOR A ONE OR TWO FAMILY DWELLING UNDER 4005g.ft.) MUST HAVE ATLEAST (1) 32"x80" (MIN.) DOOR.

### **DESIGN PARAMETERS:**

IWIND DESIGN PER ASCE 7-10, SEISMIC DESIGN PER AISC 341-05]

- WIND VELOCITY: 180mph (ULTIMATE) WIND IMPORTANCE FACTOR:
- WIND EXPOSURE: INT. PRESSURE COEFFICIENT: 0.18 ±
- ENCLOSURE CLASSIFICATION: ENCLOSED
- COMPONENTS AND CLADDING:
- -GABLE LOAD (ZONE #1): +26.5/-54.2 PSF -GABLE LOAD (ZONE #2): +26.5/-76.3 PSF -GABLE LOAD (ZONE #3): +26.5/-120.5 PSF
- -HIP ROOF LOAD (ZONE #1): +26.5/-54.1 PSF -HIP ROOF LOAD (ZONE #2): +26.5/-76.3 PSF
- -HIP ROOF LOAD (ZONE #3): +26.5/-76.3 PSF -WALL LOAD (ZONE #4): +57.6/-63.1 PSF -WALL LOAD (ZONE #5): +58.6/-74.1 PSF
- -WALL LOAD (ZONE #4##5): +58.1/-68.6 PSF 7. FLOOR DESIGN LIVE LOAD: 125 PSF
- FLOOR DESIGN DEAD LOAD: 12 PSF
- ROOF DESIGN LIVE LOAD: 10. ROOF DESIGN DEAD LOAD:
- II. WALL DESIGN LOAD:
- 12. COMBINATION LOADS:
- 13. SEISMIC USE GROUP:
- 14. BUILDING CATEGORY: 15. BUILDING OCCUPANCY:
- 16. CONSTRUCTION TYPE:
- 17. ALLOWABLE FLOORS:
- 18. EXTERIOR WALL FIRE RATING:
- 19. DESIGN OVERHANG: 8 INCH
- 20. DESIGN MEETS INTERNATIONAL BUILDING CODE 2009 \$ FLORIDA **BUILDING CODE 2010**

20 PSF

8 PSF

SELF WEIGHT

AS PER ASCE 7-10

Residential Lawn Storage

- 21. THE CONTRACTOR/MANUFACTURER MUST COMPLEW THE THE FOLLOWING CODES:
  - -2010 FLORIDA BUILDING CODE -2010 FLORIDA MECHANICAL CODE
  - -2010 FLORIDA PLUMBING CODE
  - -2012 FLORIDA ACCESSIBILITY CODE BY: MC

CODE IN ACCORDANCE WITH 101.5.2

-2009 INTERNATIONAL BUILDING CODE THESE BUILDINGS ARE EXEMPT FROM THE THE 2010 FBC ENERGY

### SITE INSTALLED ITEMS:

- THE COMPLETE FOUNDATION SUPPORT AND TIE-DOWN SYSTEM.
- RAMPS, STAIRS AND GENERAL ACCESS TO THE BUILDING.
- ELECTRICAL SERVICE HOOKUP (INCLUDING FEEDERS) TO THE
- ROOF DRAINAGE SHALL COMPLY WITH F.B.C. 2010 1503 AND R318.6

NOTE: THIS LIST DOES NOT NECESSARILY LIMIT THE ITEMS OF WORK AND MATERIALS THAT MAY BE REQUIRED FOR A COMPLETE INSTALLATION. ALL SITE RELATED ITEMS ARE SUBJECT TO LOCAL JURISDICTION APPROVAL

REVISED Storndari Richard L. Bullock Modular Building Plans Examiner Florida Certificate 2015 fieled seat plans on file at NDI headquarters Working as agent for DRPR These Prints comply with the Florida Manufactured 81d. Act and adopted Codes and Adhere to the following Criteria: Construction Type\_ Occupancy Allowable # Hoors\_ Fire Reting or Ext. Walls (2) Plan & Standard AROW. Floor Load 125 Approval Date 9/19/12 Mais ameson Approval of this Document does no Authorize or Approve any Deviation From the requirements of applicate State Laws

Approval Stamps:

NDI "APPROVED"

08/23/12



These Plans Were Designed in Accordance with the 2010 Flordia Building Code for a Ultimate Wind Speed up to 180 m.p.h.

### Standard Wood Shed Master Plan

Amazon Sheds & Gazebos Inc. 10311 Bonita Beach Road Bonita Springs, FL 34135

Designed By: Project No. 12EN782 O.R.H.


Checked By: C.L.A.

Date: 08/23/12 Sheet Number:

### **ELECTRICAL NOTES:**

- 1. WHEN AIR CONDITIONING IS INSTALLED IN THIS BUILDING, IT SHALL BE THE RESPONSIBILITY OF THE HVAC CONTRACTOR AND ELECTRICAL CONTRACTOR TO VERIFY WIRE AND BREAKER SIZES FOR ACTUAL HVAC UNIT(S) INSTALLED ALL WIRING TO BE IN ACCORDANCE WITH THE NATIONAL ELECTRIC CODE LATEST EDITION AS WELL AS THE F.B.C. ENERGY CODE LATEST EDITION.
- 2. FLEXIBLE CONDUIT FOR LIGHT FIXTURES.
- 3. EACH CIRCUIT IS TO HAVE CONTINUOUS SOLID COPPER INSULATED GROUND WIRE CONNECTED TO EQUIPMENT GROUND BAR IN THE MAIN DISTRIBUTION PANEL.
- 4. EQUIPMENT GROUND BAR IN MAIN DISTRIBUTION PANEL IS TO BE GROUNDED TO MINIMUM 10'-0" COPPER CLAD EARTH DRIVEN ROD WITH GROUNDING CLAMP APPROVED FOR DIRECT BURIAL.
- 5. ALL CONDUIT TERMINATION'S OF I" OR LARGER ARE TO HAVE PLASTIC INSULATED BUSHINGS.
- ALL ELECTRICAL WORK IS TO BE IN ACCORDANCE WITH THE NATIONAL ELECTRICAL CODE (NEC), LIFE SAFETY CODE (NFPA 101), LATEST EDITIONS.
- HVAC EQUIPMENT SHALL BE PROVIDED WITH READILY ACCESSIBLE DISCONNECTS ADJACENT TO THE EQUIPMENT SERVED. A UNIT SWITCH WITH A MARKED "OFF" POSITION THAT IS PART OF THE HVAC EQUIPMENT SHALL BE PERMITTED AS THE DISCONNECTING MEANS ONLY WHERE OTHER DISCONNECTING MEANS ARE ALSO PROVIDED BY A READILY ACCESSIBLE CIRCUIT BREAKER.
- 8. PRIOR TO ENERGIZING THE ELECTRICAL SYSTEM THE INTERRUPTING RATING OF THE MAIN BREAKER MUST BE DESIGNED AND VERIFIED AS BEING IN COMPLIANCE WITH SEC. 110-9 OF THE NEC BY A LOCAL ELECTRICAL CONSULTANT.
- THE MAIN ELECTRICAL PANEL, FEEDERS, POWER HOOKUP TO BUILDING (INCLUDING ALL DISCONNECTS, OVER CURRENT DEVICES, PANELS, GROUNDING, ETC.) IS DESIGNED BY OTHERS, SITE INSTALLED, SUBJECT TO LOCAL JURISDICTION APPROVAL.
- 10. ALL WIRES TO SWITCHES AND OUTLETS TO BE #12 AWG THHN AND WILL MEET THE COLOR CODE REQUIREMENTS SET FORTH IN THE NFPA 70. NATIONAL ELECTRICAL CODE.
- 1). ALL ELECTRICAL OUTLETS SHALL BE GFCI IN ACCORDANCE WITH ARTICLE 1210.8(A)(2) NEC-08.

	Electrical Symbol Key
ф	GFCI Duplex Receptacle 120V 1Ø
ф-	Incandescent Light w/ (1)-60w Bulb
J	Junction Box
\$	Switch
WP	Weatherproof
\$R	Switch w/ Receptacle Outlet 120v 1Ø

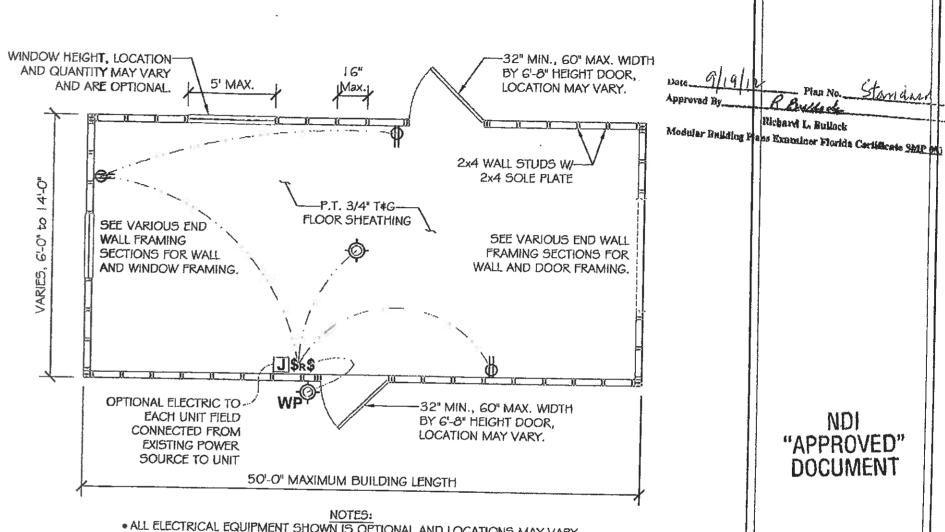

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Approval Stamps:

Richard L. Bullock

Stander

• ALL ELECTRICAL EQUIPMENT SHOWN IS OPTIONAL AND LOCATIONS MAY VARY. • ADVANTECH FLOORING OF EQUAL OR GREATER THICKNESS MAY BE SUBSTITUDED FOR P.T. PLYWOOD FLOOR SHEATHING

> Typical Floor Plan SCALE: 1/4"= 1'-0"



These Plans Were Designed in Accordance with the 2010 Flordia Building Code for a Ultimate Wind Speed up to 180 m.p.h.

### Standard Wood Shed Master Plan

Amazon Sheds & Gazebos Inc. 10311 Bonita Beach Road Bonita Springs, FL 34135

Designed By: Project No. O.R.H.

12EN782

Checked By: C.L.A.

Date: 08/23/12 Sheet Number:


### SKID LAYOUT AND FLOOR FRAMING SCHEDULE


### 125 psf Live Load

	,			
Width	Joist Size&Spacing	Α	В	С
6'-0"	2x4's @ 16" O.C., Max.	12"	48"	N/A
7'-0"	2x6's @ 16" O.C., Max.	16"	52"	N/A
8'-0"	2x6's @ 16" O.C., Max.	16"	64"	N/A
1 <b>0'</b> -0"	2x6's @ 16" O.C., Max.	18"	84"	N/A
11'-0"	2x6's @ 16" O.C., Max.	12"	72"	18"
12'-0"	2x8's @ 16" O.C., Max.	12"	72"	24"
13'-0"	2x8's @ 16" O.C., Max.	18"	78"	21"
14'-0"	2x8's @ 16" O.C., Max.	18"	78"	27"

### NOTES:

- FASTENERS WILL MEET THE MINIMUM REQUIREMENTS FOR ALL STRUCTURAL COMPONENTS AS SET FORTH UNDER FBC 2304.9.1 AND TABLE 2304.9.1 UNLESS OTHERWISE SPECIFIED.
- ALL SKIDS ARE P.T.-4x6 S.Y.P. #2 or (2)-P.T.-2x6 S.Y.P. #2
- ALL JOISTS ARE TO BE P.T.-5.Y.P. #2
- ADVANTECH FLOORING MAY BE SUBSTITUTED FOR P.T. PLYWOOD

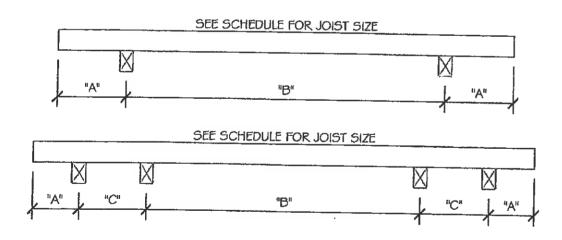

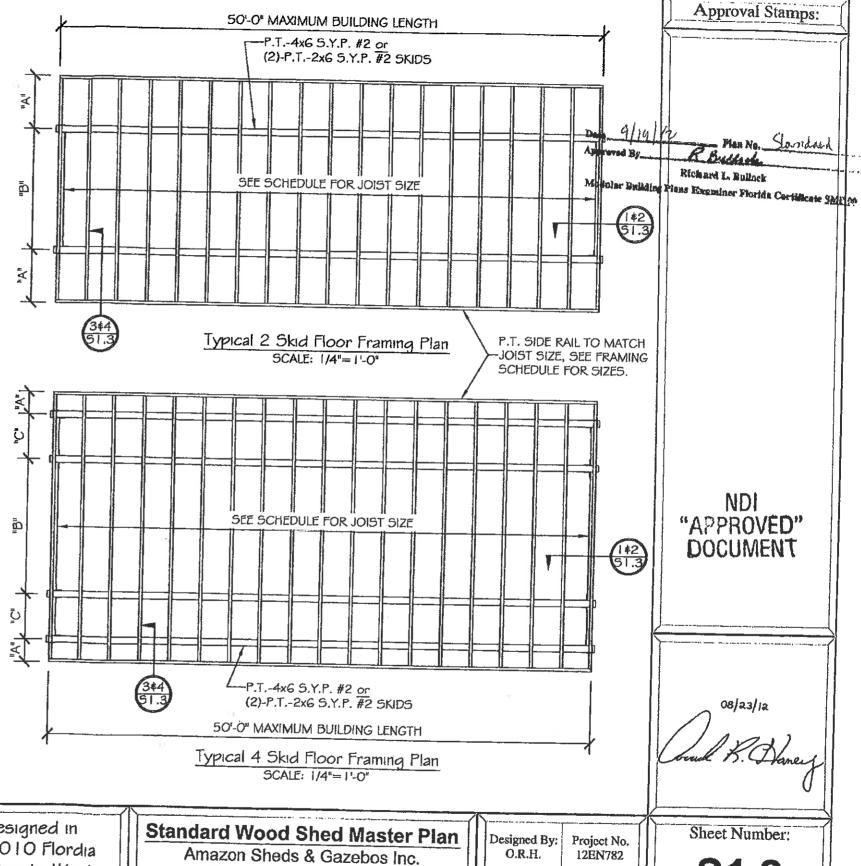




These Plans Were Designed in Accordance with the 2010 Flordia Building Code for a Ultimate Wind Speed up to 180 m.p.h.


10311 Bonita Beach Road Bonita Springs, FL 34135

Date:

08/23/12

Checked By: C.L.A.

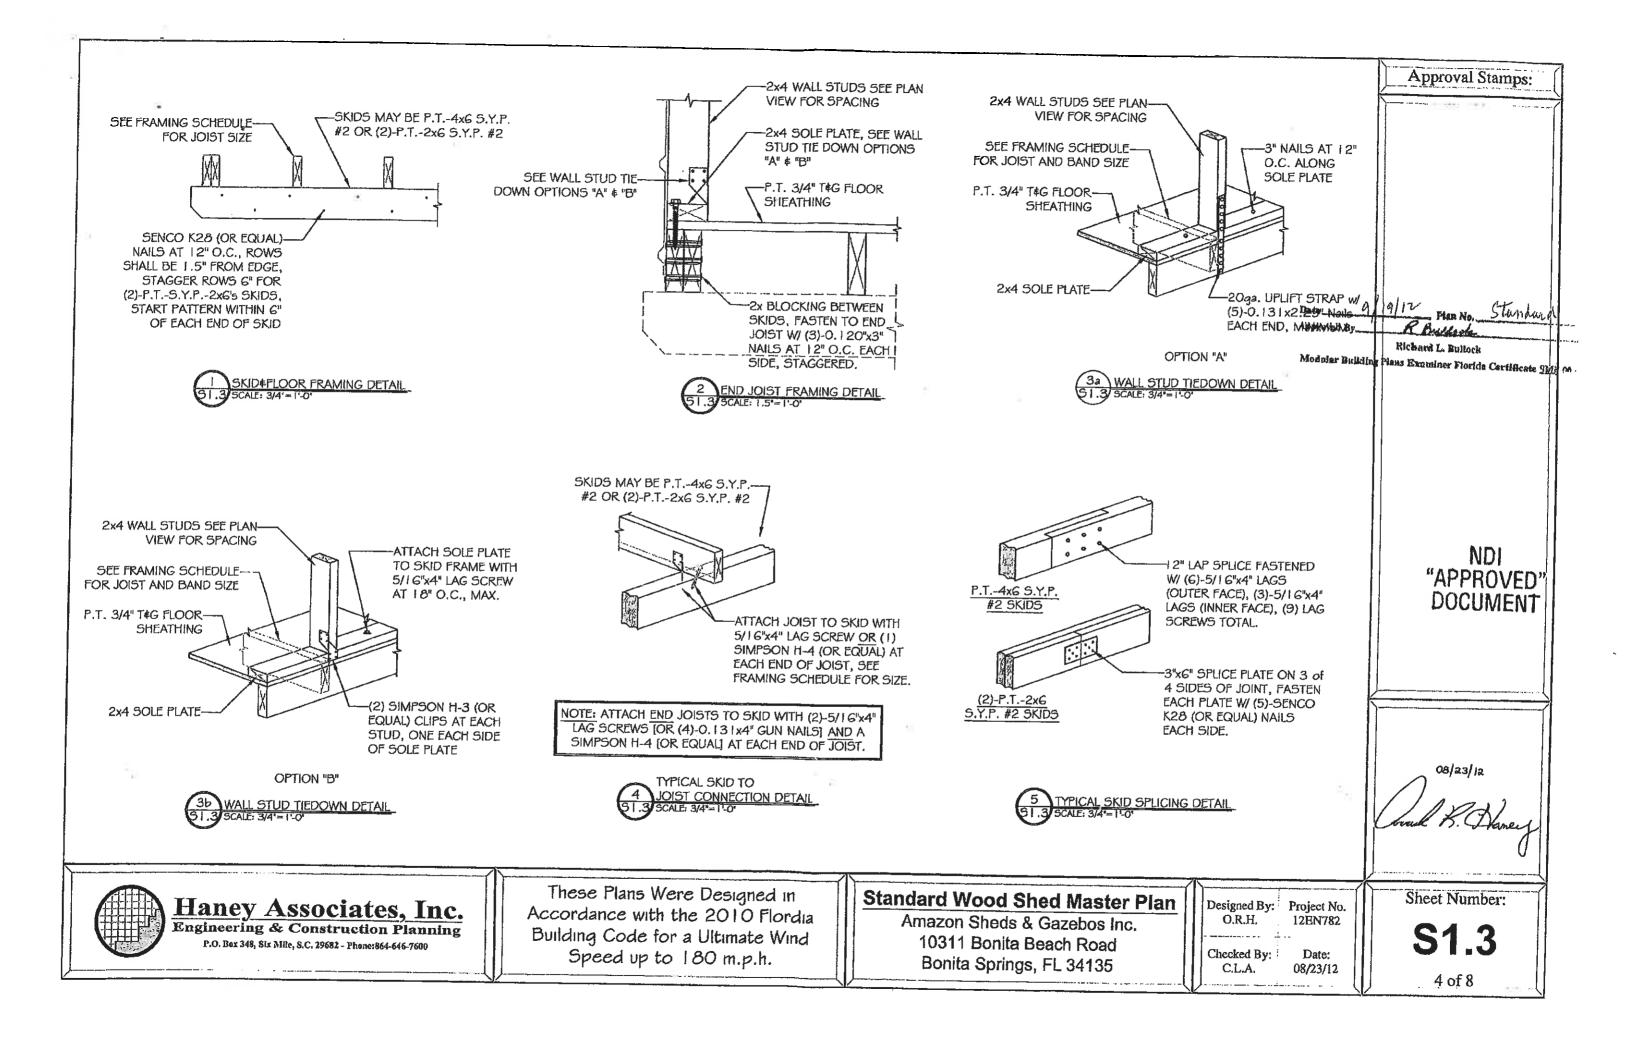

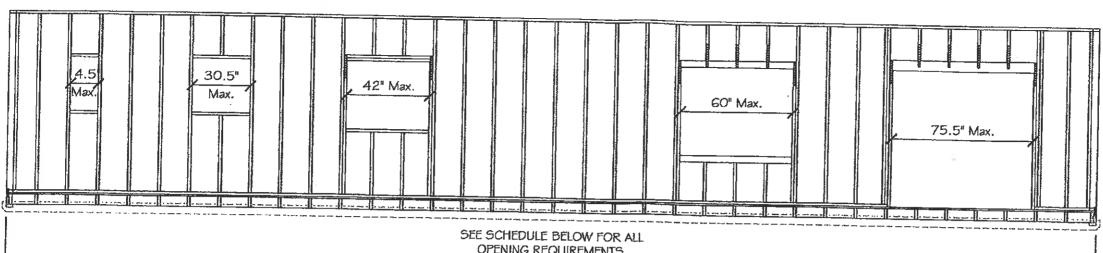

OPENING REQUIREMENTS.

50'-0" MAXIMUM BUILDING LENGTH

Typical Side Wall Openings Framing SCALE: 1/4"=1'-0"

	ā	_	WALL O	PENINGS	FRAMING SCHEDULE			<del></del>
Max. Opening	Header/Sill Type	Header Fasteners (Each End)	Sill Fasteners (Each End)	King/Jack Studs		Option B: Stud to Band Joist Clips		Option B:
14.5"	1/1	(4)-16d Nails	(2)-16d Nails	1/0	None Required	None Required	(N/A)	and the same of the same of the same
22.5"	1/1	(5)-16d Nails	(2)-16d Nails	1/0	None Required	None Required	· · · · · · · · · · · · · · · · · · ·	(N / A)
30.5*	2/1	(7)-16d Nails	(4)-16d Nails	1/0	None Required	AND THE PROPERTY AND THE PARTY	(N / A)	(N / A)
42"	2/2	(8)-16d Nails	(5)-16d Nails		(2)-20ga. w/ (5)-0.131x2.25" Nails	None Required	(N / A)	(N / A)
60"	2/2	(10)-16d Nails	(7)-16d Nails		The state of the s		5	5
	- 2 M PS/Marksperson Parksperson	The state of the s	The state of the s	1/1	(2)-20ga. w/ (5)-0.131x2.25" Nails	(2) Simpson H-3	7	5
63"	3/3	(10)-16d Nails	(9)-16d Nails	2/1	(3)-20ga. w/ (7)-0.131x2.25" Nails			
75.5"	3	(13)-16d Nails	(N/A)	The second living the second l	(3)-20ga. w/ (7)-0.131x2.25" Nails	Land of the land o	8	6
96"	3	(13)-16d Nails	The same of the sa				10	7
20	J	(10)-100 Nails	(N / A)	2/1	(3)-20ga. w/ (9)-0.131x2.25" Nails	(3) Simpson H-3	11	12

### NOTES:

- ALL HEADERS AND SILLS SHALL BE CONSTRUCTED FROM S.Y.P. #2
- STRAPS, CLIPS AND ANCHORING LAGS STATED ARE FOR EACH SIDE OF OPENINGS
- · STRAPPING MAY WRAP BAND JOIST IF NEEDED TO INSTALL REQUIRED # OF FASTENERS
- ANCHORING LAGS SHALL BE I" FROM STUD AND SPACED I" O.C. CENTERED ON BAND JOIST
- REFER TO CLIP MANUFACTURER FOR CLIP FASTENING REQUIREMENTS
- SIMPSON CS I G STRAPS (OR EQUAL) REQUIRED TO TIE HEADER TO JACK STUD FOR ALL OPENINGS 42" OR GREATER, STRAPS ARE ALSO REQUIRED FOR ALL INTERUPTED STUDS ON OPENINGS 60" OR GREATER



(1)-2x4 5.Y.P.



(2)-2x4 5.Y.P. w/ 1/2" PLYWOOD SPACER or (1)-4x4 S.Y.P.

(2)-2x6 S.Y.P. w/ 1/2" PLYWOOD SPACER

Header/Sill Type 3 SCALE: 1.5"=1'-0"

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Approval Stamps:

Standard

08/23/12

Header/Sill Type 1 SCALE: 1.5"=1'-0"

Header/Sill Type 2 SCALE: 1.5"=1'-0"



Haney Associates, Inc. Engineering & Construction Planning P.O. Box 348, Six Mile, S.C. 29682 - Phone:864-646-7600

These Plans Were Designed in Accordance with the 2010 Flordia Building Code for a Ultimate Wind Speed up to 180 m.p.h.

### **Standard Wood Shed Master Plan**

Amazon Sheds & Gazebos Inc. 10311 Bonita Beach Road Bonita Springs, FL 34135

Designed By: Project No.

O.R.H. 12EN782

Checked By: C.L.A.

Date: 08/23/12

9/19/12

Blobard L. Bullock Modular Building Plans Expuniner Florida Cardificate Sing of

Sheet Number:


### **ROOF FRAMING SCHEDULE**


Wall Framing at 16" o.c., Max.

	R		
Width	Rafter Size	Required # of Strap Nails	
6'-0"	S.Y.P 2x4's	5 (ea. end)	
7'-0"	S.Y.P 2x4's	5 (ea. end)	
8'-0"	S.Y.P 2x4's	5 (ea. end)	
10'-0"	S.Y.P 2x4's	6 (ea. end)	
11'-0"	S.Y.P 2x4's	8 (ea. end)	
12'-0"	S.Y.P 2x4's	8 (ea. end)	
13'-0"	*S.Y.P 2x6's*	8 (ea. end)	
14'-0"	*S.Y.P 2x6's*	9 (ea. end)	

### SCHEDULE AND ROOF FRAMING NOTES:

- ROOF FRAMING SHALL BE SPACED TO LINE UP DIRECTLY OVER THE WALL STUDS FOR PROPER LOAD TRANSFER AND STRAPPING.
- RAFTER TO STUD STRAPPING SHALL BE 20ga. x 1 1/2" WIDE AND FASTENED WITH 0.131x2.25" NAILS.
- ROOF DRAINAGE SHALL COMPLY WITH F.B.C. 2010 1503 AND R318.6
- ROOF FRAME TO WALL FRAME STRAPPING MAY BE INSTALLED ON THE INNER OR OUTER FACE OF THE FRAMING
- FASTENERS WILL MEET THE MINIMUM REQUIREMENTS FOR ALL STRUCTURAL COMPONENTS AS SET FORTH UNDER FBC 2304.9.1 AND TABLE 2304.9.1 UNLESS OTHERWISE SPECIFIED.
- MARKED RAFTERS MAY BE 2x4'5 IF LARGER COLLAR TIES ARE USED, SEE DETAIL 1/51.6 FOR SIZES.
- FOR 150mph WIND ZONES FRAMING MAY BE SPACED AT 24" O.C. MAX. FOR WALL HEIGHTS 7'-6" AND UNDER.
- LUMBER GRADES: WHEN S.Y.P. #2 IS USED, THE FRAMING MUST BE SPACED AT 18" O.C., MAX. WITHIN 3'-O" FROM EACH SIDE OF EACH CORNER, THE REST OF THE FRAMING MAY BE SPACED AT 16" O.C., MAX.

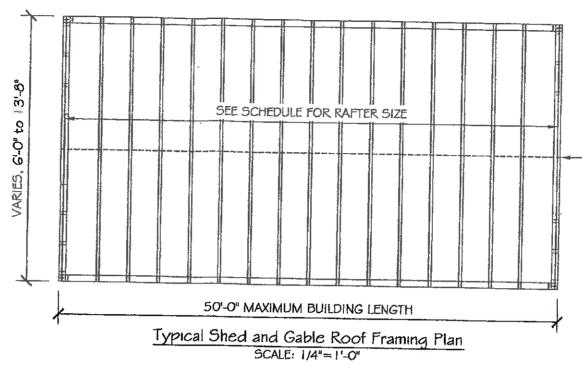

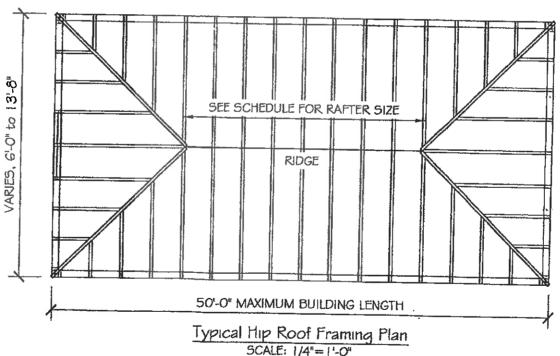

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Approval Stamps:

Standars

08/23/12

Soul K. Daney

Haney Associates, Inc.
Engineering & Construction Planning
P.O. Box 348, Six MHe, S.C. 29682 - Phone:864-646-7600

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### **Standard Wood Shed Master Plan**

Amazon Sheds & Gazebos Inc. 10311 Bonita Beach Road Bonita Springs, FL 34135 Designed By: Project No. 12EN782

RIDGE WHEN ROOF

9/19/12

Richard L. Bullock


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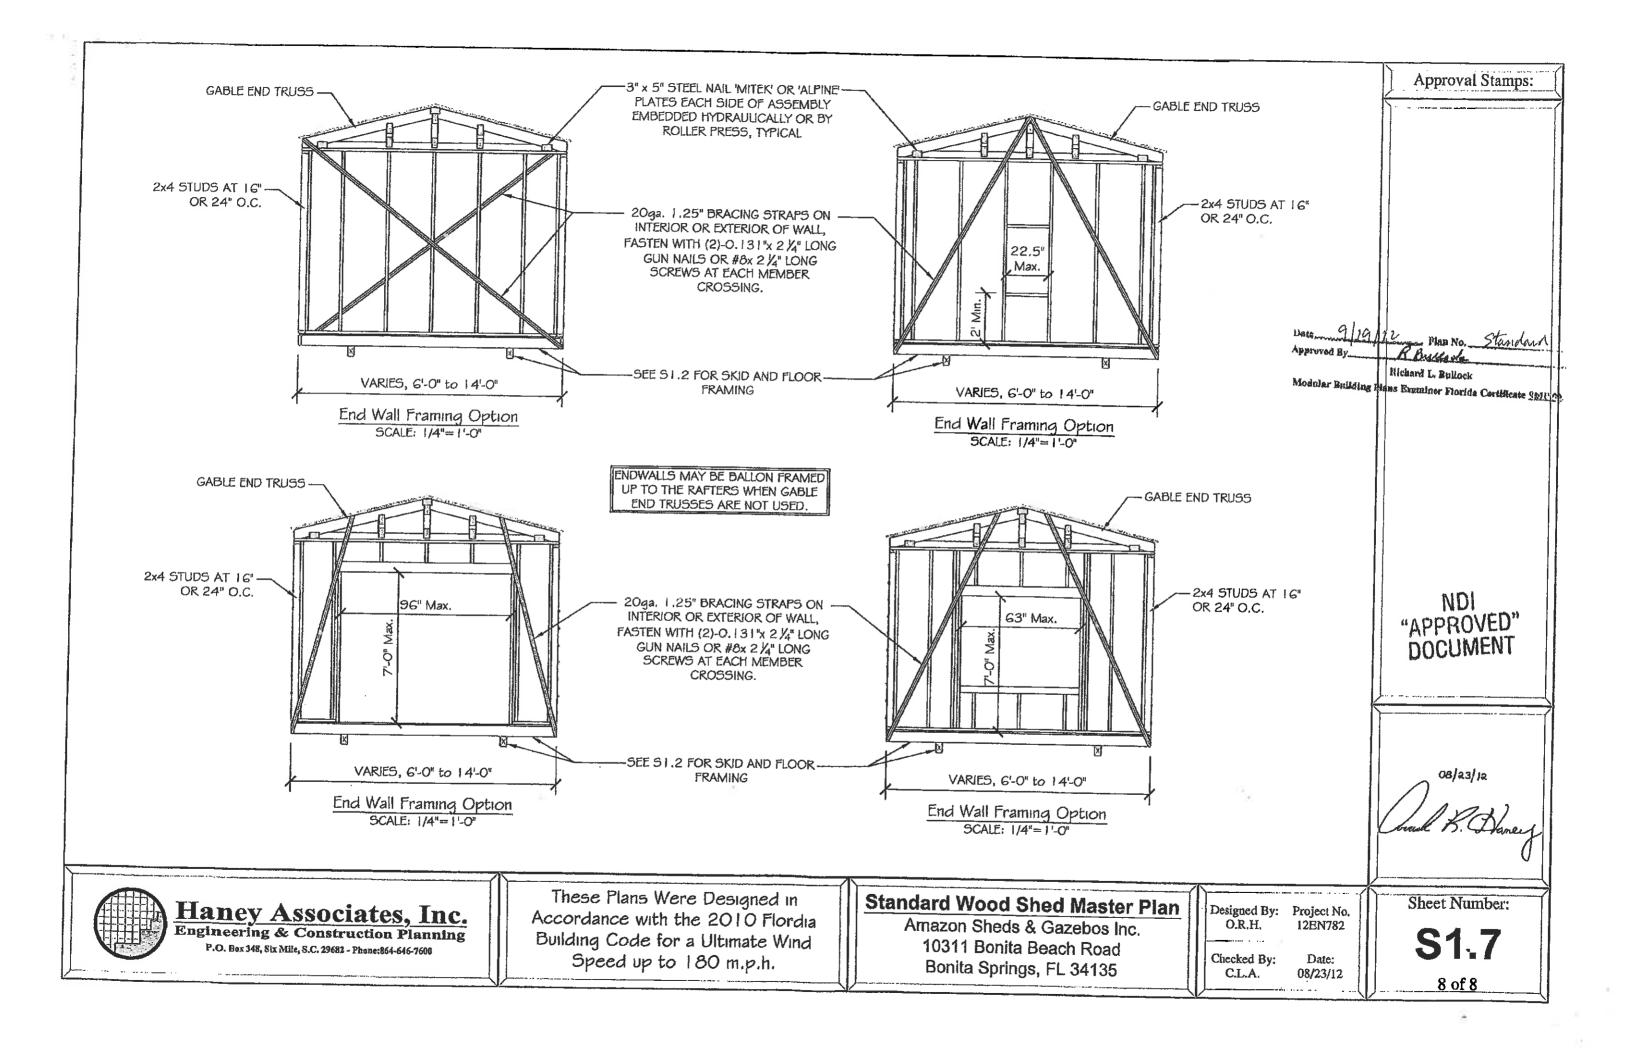
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Checked By: Date: 08/23/12

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	6'-0"	8'-0"	7'-6"	_	4		2	2	
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	6'-0"	12'-0"	7'-6"		4		2	2	_
	8'-0"	8'-0"	7'-6"	_	4		2	2	
	8'-0"	10'-0"	7'-6"	_	4		2	2	
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er .	4'-0"	32'-0"	6'-6"	~	28		-	6	
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	4'-0"	38'-0"	6'-6"		32	6		6	
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### DESIGN PARAMETERS


WIND DESIGN PER ASCE 7-10

- 2. DESIGN WIND SPEED: 180mph (ULTIMATE)
- 3. ULTIMATE WIND EXPOSURE CATEGORIES: 180mph: B, C 150mph: B.C & D
- 4. WIND IMPORTANCE FACTOR: 1.0
- 5. ENCLOSURE CLASSIFICATION: ENCLOSED
- 6. DESIGN MEETS INTERNATIONAL BUILDING CODE 2009 & FLORIDA BUILDING CODE 2010

### **GENERAL NOTES**

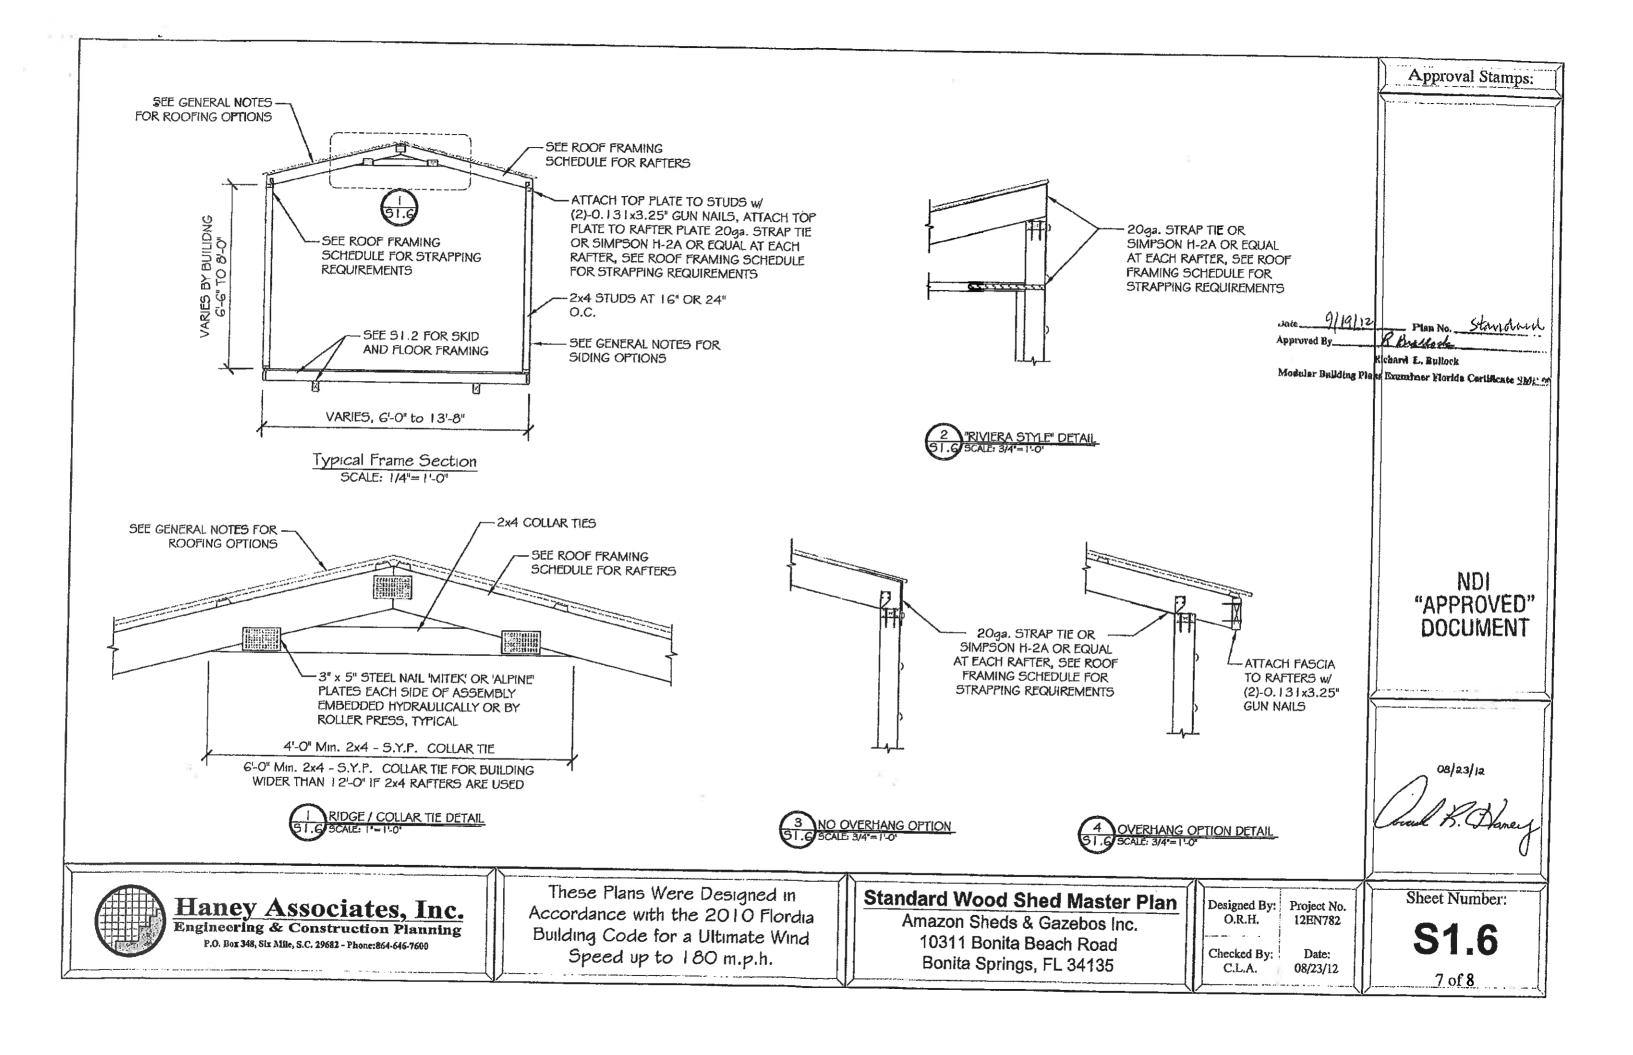- 1. DESIGN FOR MIN 2,500 PSI CONCRETE 2. ALL HELIX ANCHORS MUST MEET THE MINIMUM WORKING LOAD OF 3150 lbs. AND AN ULTIMATE LOAD OF 4725 lbs.
- 3. ANCHORS MUST BE INSTALLED TO MANUFACTURERS RECOMMENDATIONS. ANY BENDING OR DAMAGE CAUSED UPON INSTALLATION WILL VOID ANCHOR AND MUST BE DISCARDED.
- 4. CONTRACTOR SHALL VISIT THE SITE AND THOROUGHLY FAMILIARIZE THEMSELF WITH EXISTING CONDITIONS. CONTRACTOR IS RESPONSIBLE FOR MEETING SOIL CLASSIFICATION FOR SIZING HELICAL ANCHORS PER MANUFACTURER'S REQUIREMENTS.
- ONE ANCHOR SHALL BE PLACED AT EACH BUILDING CORNER WITHIN 12" OF CORNER
- 6. ANY REQUIRED INTERMEDIATE ANCHORS SHALL BE PLACED EQUAL DISTANCES APART FROM EACH OTHER.
- THE ANCHOR MUST BE IN THE SITE SOIL CLASS IN WHICH THE LOAD REQUIREMENTS
- 8. USE TIE -DOWN ENGINEERING (OR COMPARABLE) 1/2" X 30" GROUND ANCHOR WITH SINGLE 4" HELIX OR 5/8" DIA. X 40" AND 48" GROUND ANCHOR WITH SINGLE 6" HELIX
- INSTALLATION OF THE ANCHORS MUST MEET ALL AT REQUIREMENTS AS SPECIFIED BY TIE DOWN ENGINEERING, INC TO INCLUDE REQUIREMENTSING FOR SPACING AND SITE SPECIFIC SOIL CONDITIONS
- 10. MAXIMUM STRUCTURE HEIGHT IS 12 FEET II. NUMBER OF ANCHORS LISTED IN ANCHOR SCHEDULE ARE THE MINIMUM REQUIRED NUMBER OF ANCHORS TO RUN DOWN EACH SIDE WALL (THE TOTAL NUMBER OF ANCHORS REQUIRED PER BUILDING WOULD BE 2X THE NUMBER LISTED IN THE

### Typical Details for Concrete Installations

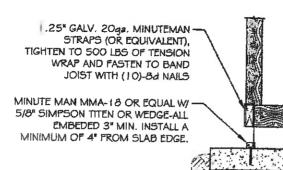

SIMPOSN SPH4 (OR EQUAL) @ 16"-O.C. (24" FOR 150mph) AND (1) 1/2"x4" LAG BOLT THRU BASE PLATE


5/8" DIA. THRU BOLT WITH 2" WASHER. A449 GALVANIZED OR EQUIVALENT


5/8" DIA. X 48" GROUND ANCHOR WITH SINGLE 6" HELIX (MODEL #59065)

DBI. 2x6 BLOCKING REQUIRED FOR THRU **BOLT ATTACHMENT** 

NOTE: INSTALL ANCHORS PER MANUFACTURER'S REQUIREMENTS

### Typical Details for Masonry Block Installations

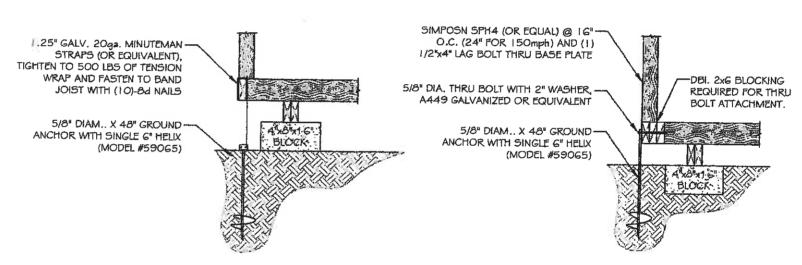

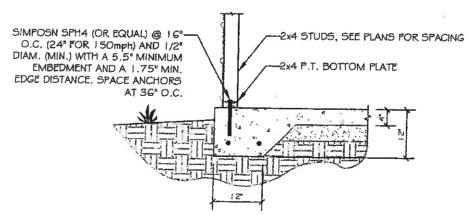

Typical Anchoring of a Floorless Buildings to Concrete Slab Detail

Approval Stamps:

### Haney Associates, Inc. Engineering & Construction Planning

P.O. Box 348, Six Mile, S.C. 29682 - Phone:864-646-7600

These Plans Were Designed in Accordance with the 2010 Flordia Building Code for a Ultimate Wind Speed up to 180 m.p.h.

### **Foundation Anchoring Plans**

Amazon Sheds & Gazebos Inc. 10311 Bonita Beach Road Bonita Springs, FL 34135

Designed By:	Project No.
O.R.H.	12EN782
Checked By:	Date:

05/31/12

C.L.A.

Sheet Number:

F1.0



The Historic Architectural Review Commission will hold a public hearing at 5:30 p.m., April 28, 2015 at Old City Hall, 510 Greene Street, Key West, Florida. The purpose of the hearing will be to consider a request for:

### NEW PRE-FABRICATED SHED IN REAR OF PROPERTY. DEMOLITION OF SHED.

### FOR-#921 CENTER STREET

**Applicant – McKendry Builders** 

**Application # H15-01-0349** 

If you wish to see the application or have any questions, you may visit the Planning Department during regular office hours at 3140 Flagler Avenue, call 809-3975 or visit our website at <a href="https://www.cityofkeywest-fl.gov">www.cityofkeywest-fl.gov</a>.

THIS NOTICE CAN NOT BE REMOVED FROM THE SITE UNTIL HARC FINAL DETERMINATION

### HARC POSTING AFFIDAVIT

### STATE OF FLORIDA: COUNTY OF MONROE:

<b>BEFORE ME</b> , the undersigned authority, personally appeared
oath, depose and says that the following statements are true and correct to the best of his/her knowledge and belief:
<ol> <li>That a legal notice for Public Notice of Hearing of the Historic Architectura Review Commission (HARC) was placed on the following address:</li> </ol>
921 CENTER ST or the 21 day of APRIL , 2015.
This legal notice(s) contained an area of at least 8.5"x11".
The property was posted to notice a public hearing before the Key West Historic Architectural Review Commission to be held or 170016 28 , 20/5.
The legal notice(s) is/are clearly visible from the public street adjacent to the property.
The Certificate of Appropriateness number for this legal notice is SEC 96-143
2. A photograph of that legal notice posted in the property is attached hereto.  Signed Name of Affiant:  Date: 4-2(-2015)
Address: <u>G2/ COUTER SF</u> City: <u>KG7 WG5F</u> State, Zip: <u>F2 33640</u>
The forgoing instrument was acknowledged before me on this $\frac{2/5t}{4}$ day of $\frac{20/5}{1}$ .
By (Print name of Affiant) $\underline{Jens\ M.\ Nie   Sen}$ who is personally known to me or has produced $\underline{FL\ Driver License + 2ND\ D}$ as identification and who did take an oath.
NOTARY PUBLIC  Sign Name:  Drint Name:  Notary Public - State of Florida (seal)  Notary Public - State of Florida (seal)  My Commission Expires:  Ob/27/2015  LISA M. MCCARTHY  Notary Public - State of Florida  My Comm. Expires Jun 27, 2015  Commission # EE 106776  Bonded Through National Notary Assn.





# PROPERTY APPRAISER INFORMATION



Key West (305) 292-3420 Marathon (305) 289-2550 Plantation Key (305) 852-7130

### **Property Record Card -**

Maps are now launching the new map application version.

Alternate Key: 8761937 Parcel ID: 00017720-000500

### **Ownership Details**

**Mailing Address:** 

All Owners:

SCHILPEROORT INA **DUINDISTEL 79** 

SCHILPEROORT INA, VAN RUITENBURG PIETER W/H

2202 DE NOORDWIJK, ZUID-HOLLAND 2202 DE **NETHERLANDS** 

### **Property Details**

PC Code: 07 - COMPOUNDS

Millage Group: 10KW Affordable No Housing:

Section-Township-Range: 06-68-25


Property Location: 921 CENTER ST UNIT: 5 KEY WEST

Legal Description: UNIT 5 OLD TOWN GARDEN VILLAS KW PT LOT 3 SQR 8 TR 4 OR1063-2201/2225DEC OR1063-2185/86

OR1446-1838/39 OR1452-850/53-C OR1552-65/67 OR1596-1128/29 OR1794-706/09 OR2673-1800/01

Click Map Image to open interactive viewer

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### **Land Details**

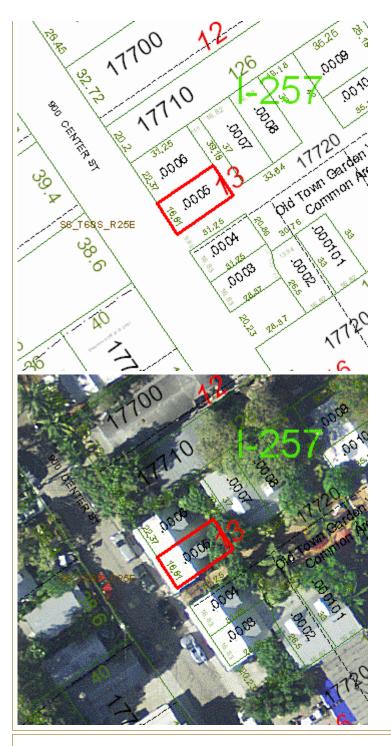Land Use Code	Frontage	Depth	Land Area
010D - RESIDENTIAL DRY	17	31	525.00 SF

### **Building Summary**

Number of Buildings: 1
Number of Commercial Buildings: 0
Total Living Area: 731
Year Built: 1980

Tour Dunit 1000

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### **Building 1 Details**

**Building Type R1 Condition** A **Quality Grade** 550 Effective Age 19 Perimeter 154 **Depreciation % 26** Year Built 1980 Special Arch K **Grnd Floor Area** 731

Functional Obs 0 **Economic Obs** 0


Inclusions: R1 includes 1 3-fixture bath and 1 kitchen.

> Roof Type GABLE/HIP Roof Cover METAL Foundation WD CONC PADS Heat 1 NONE Heat 2 NONE **Bedrooms** 1

Heat Src 1 NONE Heat Src 2 NONE

**Extra Features:** 

2 Fix Bath 0 Vacuum 3 Fix Bath 0 **Garbage Disposal** 4 Fix Bath 0 Compactor 5 Fix Bath 0 Security 6 Fix Bath 0 Intercom 7 Fix Bath 0 Fireplaces 0 Extra Fix 0 Dishwasher 0

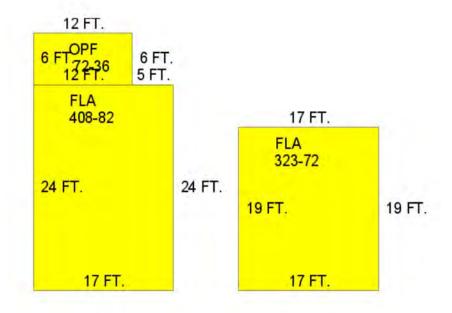

### Sections:

Nbr	Туре	Ext Wall	# Stories	Year Built	Attic	A/C	Basement %	Finished Basement %	Area
1	FLA	12:ABOVE AVERAGE WOOD	1	1980	N	N	0.00	0.00	408
2	OPF		1	1980			0.00	0.00	72
3	FLA	12:ABOVE AVERAGE WOOD	1	1980	N	N	0.00	0.00	323

### **Misc Improvement Details**

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Nbr	Туре	# Units	Length	Width	Year Built	Roll Year	Grade	Life
1	AC2:WALL AIR COND	2 UT	0	0	1984	1985	1	20

### **Building Permits**

Bldg	Number	Date Issued	Date Completed	Amount	Description	Notes
	03/4121	12/08/2003	07/28/2004	5,000	Residential	R&R 18 WINDOWS

### **Parcel Value History**

Certified Roll Values.

View Taxes for this Parcel.

Roll Year	Total Bldg Value	Total Misc Improvement Value	Total Land Value	Total Just (Market) Value	Total Assessed Value	School Exempt Value	School Taxable Value
2014	154,333	320	157,523	312,176	221,923	0	312,176
2013	89,195	320	155,921	245,436	201,749	0	245,436
2012	93,675	320	138,300	232,295	183,409	0	232,295
2011	105,353	320	117,475	223,148	166,736	0	223,148
2010	106,729	320	44,530	151,579	151,579	0	151,579
2009	120,077	320	74,130	194,527	194,527	0	194,527
2008	110,430	320	174,999	285,749	285,749	0	285,749
2007	111,699	320	344,050	456,069	456,069	0	456,069
2006	267,036	320	250,100	517,456	517,456	0	517,456
2005	256,960	320	150,100	407,380	407,380	0	407,380
2004	188,102	320	102,600	291,022	291,022	0	291,022
2003	149,718	320	31,431	181,469	181,469	0	181,469
2002	92,013	320	31,431	123,764	123,764	0	123,764
2001	92,013	320	31,431	123,764	123,764	0	123,764
2000	103,499	320	31,181	135,000	135,000	0	135,000
1999	73,357	576	31,181	105,114	105,114	0	105,114
1998	81,220	576	31,181	112,977	112,977	0	112,977
1997	72,195	512	29,179	101,886	101,886	0	101,886
1996	58,659	468	29,179	88,306	88,306	0	88,306
1995	55,500	492	26,176	82,168	82,168	0	82,168
1994	45,122	440	26,176	71,738	71,738	0	71,738
1993	45,122	480	26,176	71,778	71,778	0	71,778
1992	45,122	520	26,176	71,818	71,818	0	71,818
1991	65,347	700	25,025	91,072	91,072	0	91,072
1990	0	0	20,270	20,270	20,270	0	20,270

### **Parcel Sales History**

NOTE: Sales do not generally show up in our computer system until about two to three months after the date of sale. If a recent sale does not show up in this list, please allow more time for the sale record to be processed.

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Thank you for your patience and understanding.

Sale Date	Official Records Book/Page	Price	Instrument	Qualification
2/28/2014	2673 / 1800	400,000	WD	02
6/13/2002	1794 / 0706	200,000	WD	Q
9/2/1999	1596 / 1128	138,000	WD	Q
12/8/1998	1552 / 0065	125,000	WD	Q
8/1/1988	1063 / 2185	112,500	WD	U

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Monroe County Property Appraiser Scott P. Russell, CFA P.O. Box 1176 Key West, FL 33041-1176