

Historic Architectural Review Commission Staff Report for Item 8

То:	Chairman Bryan Green and Historic Architectural Review Commission Members	
From:	Enid Torregrosa, MSHP Historic Preservation Planner	
Meeting Date:	October 25, 2016	
Applicant:	Carlos Huembes, Architect	
Application Number:	H16-03-0070	
Address:	#724 Truman Avenue	

Description of Work

Major Development Plan- New metal replacement building for gym.

Site Facts

In August 2016, the Chief Building Officer condemned a metal pre-fabricated structure over CMU walls that was used as the gym and cafeteria for St. Mary's School. The structure was installed in 1984 and was recently demolished due to severe state of deterioration. In August 18, 2016, the Planning Board approved the Major Development Plan for the replacement of the structure. Since this is a Major Development Plan in a historic zoning district, it will require City Commission approval.

Guidelines Cited on Review

• Guidelines for new construction (pages 36-38a)- older version.

Staff Analysis

The Certificate of Appropriateness in review is for the construction of a replacement structure for the gym and cafeteria for St. Mary's School. The applicant has reviewed and changed the color patter that was previously presented and has submitted color samples and material samples.

The new proposed structure will be a pre-fabricated metal building that will have a reduce height and mass than the previous structure, but will have the same ground footprint. The building will be located on the same area as the previous one; on the southwest corner of the lot, which is the rear yard of the parcel. The building will be visible from Amelia Street, and will be setback from the street approximately 23'.

The structure will have a maximum height of 36'- 3 5/16" on its maximum point and 135'-4" wide by 110'-0" of depth. The previous building's height was 37'-0". The metal structure will have galvanized painted panels walls and it is proposed to have two colors with a different trim color. The building will have a smaller mass and scale than the previous gym as the profile of the roof had been change and reduced. The existing CMU wall facing Amelia Street will not be removed.

Consistency with Guidelines


It is staff's opinion that the proposed design does not meet the regulations for mass, scale proportions, and materials as stipulated in the guidelines for new construction. The structure will be taller and massive than existing surrounding structures. The guidelines do not make a distinction regardless the use and type of building, thus the zoning regulations includes light industry, which will permit larger structures in parts of the existing urban block.

Nevertheless, the use of the building requires specific dimensions that the previous and now its replacement building have. The proposed building meets the minimum requirements for its use as a gymnasium. The proposed building has reduced the scale and roofline if compare to the previous structure. The fenestrations on the upper portion of the walls as well as the use of more than one color helps in reducing the mass of the building, while comparing it with the previous gym. There is only one building listed as a contributing structure within the immediate surrounding area, 706 Amelia Street, built circa 1943; a one-story frame structure; the rest of the adjacent surrounding buildings are not-contributing or non-historic. On that same block, at the corner of Amelia and Simonton Streets and across the Old Gato building, there is a metal structure used for light industry. That structure has a similar vertical metal siding as the one proposed in the new structure. It is staff's opinion that the replacement building is less massive and its facades have much more fenestrations, which helps in lowering the scale and volume of the structure.

APPROVED DESIGN

Basilica of Saint Mary Star of the Sea THE BASILICA SCHOOL of Saint Mary Star of the Sea **Proposed Gymnasium Building**

HARC Submittal October 25, 2016

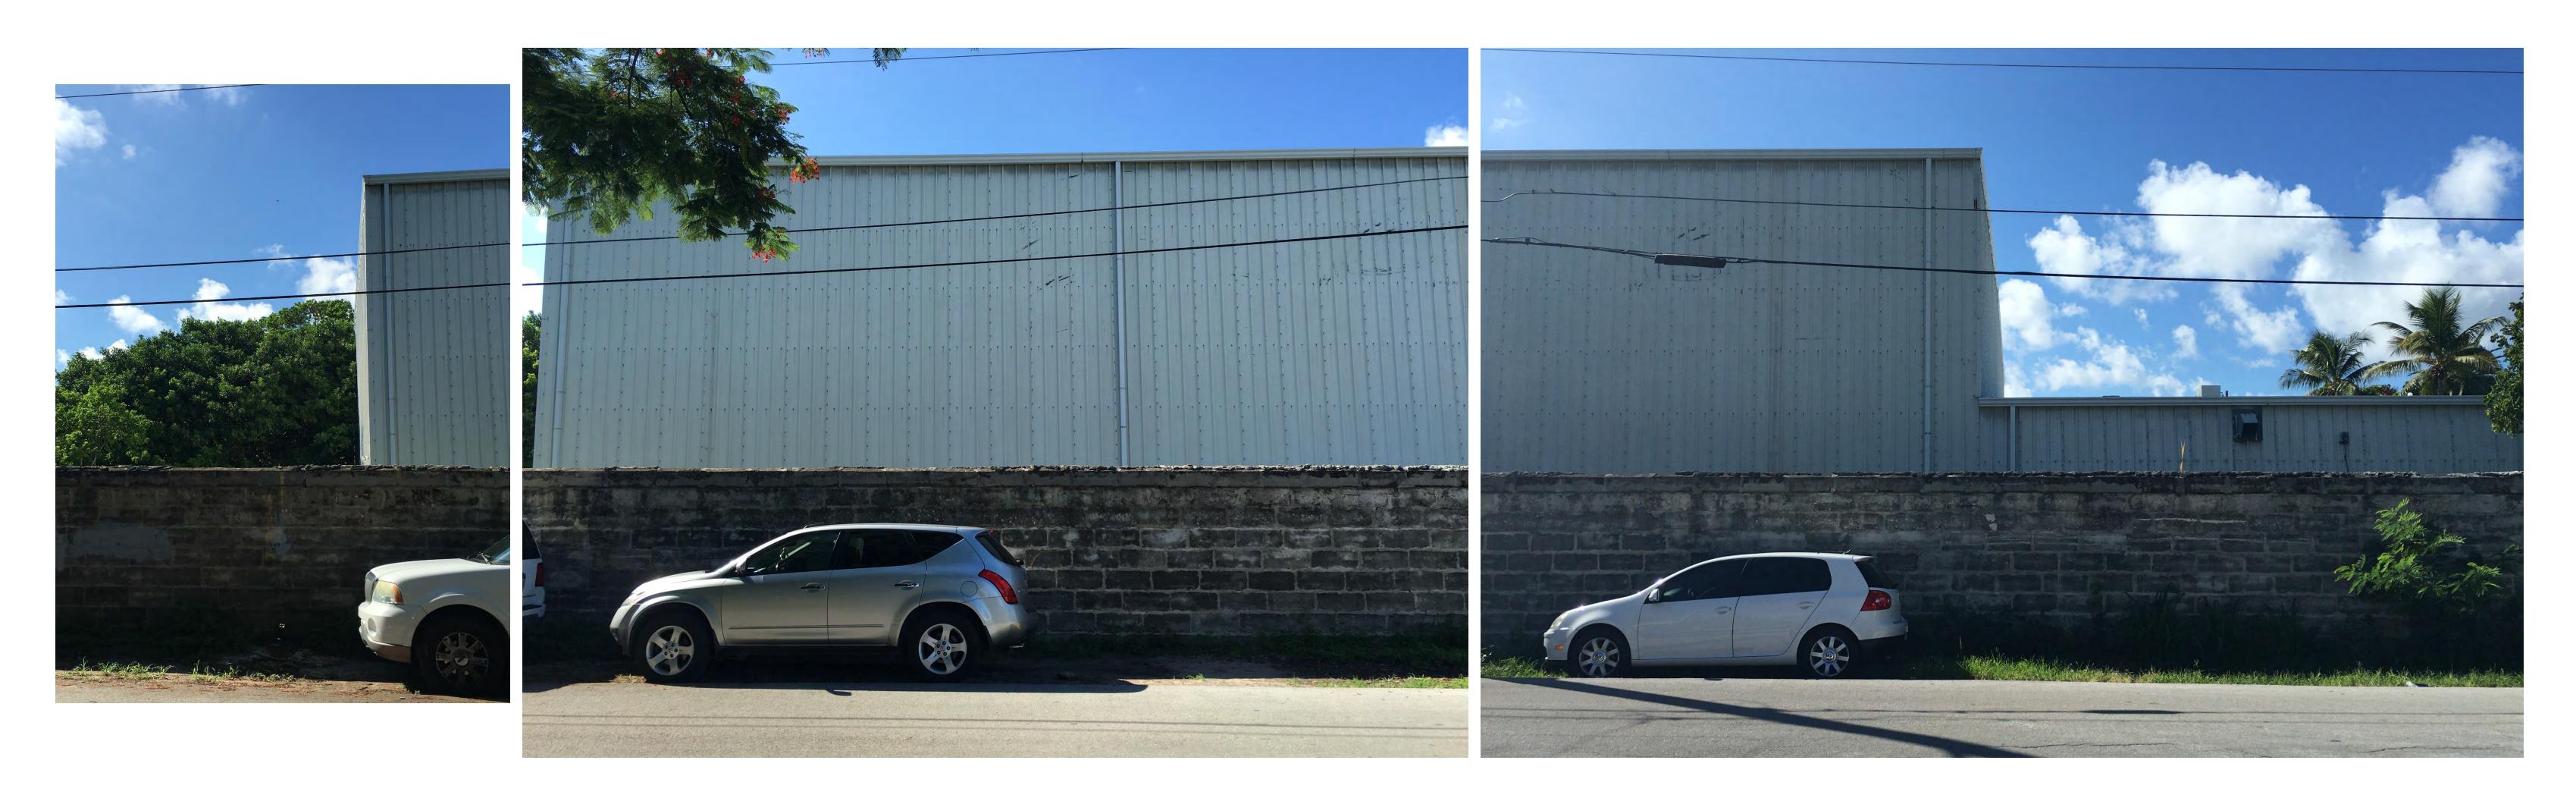


Old Gymnasium / Cafeteria Building – Condemned & Demolished










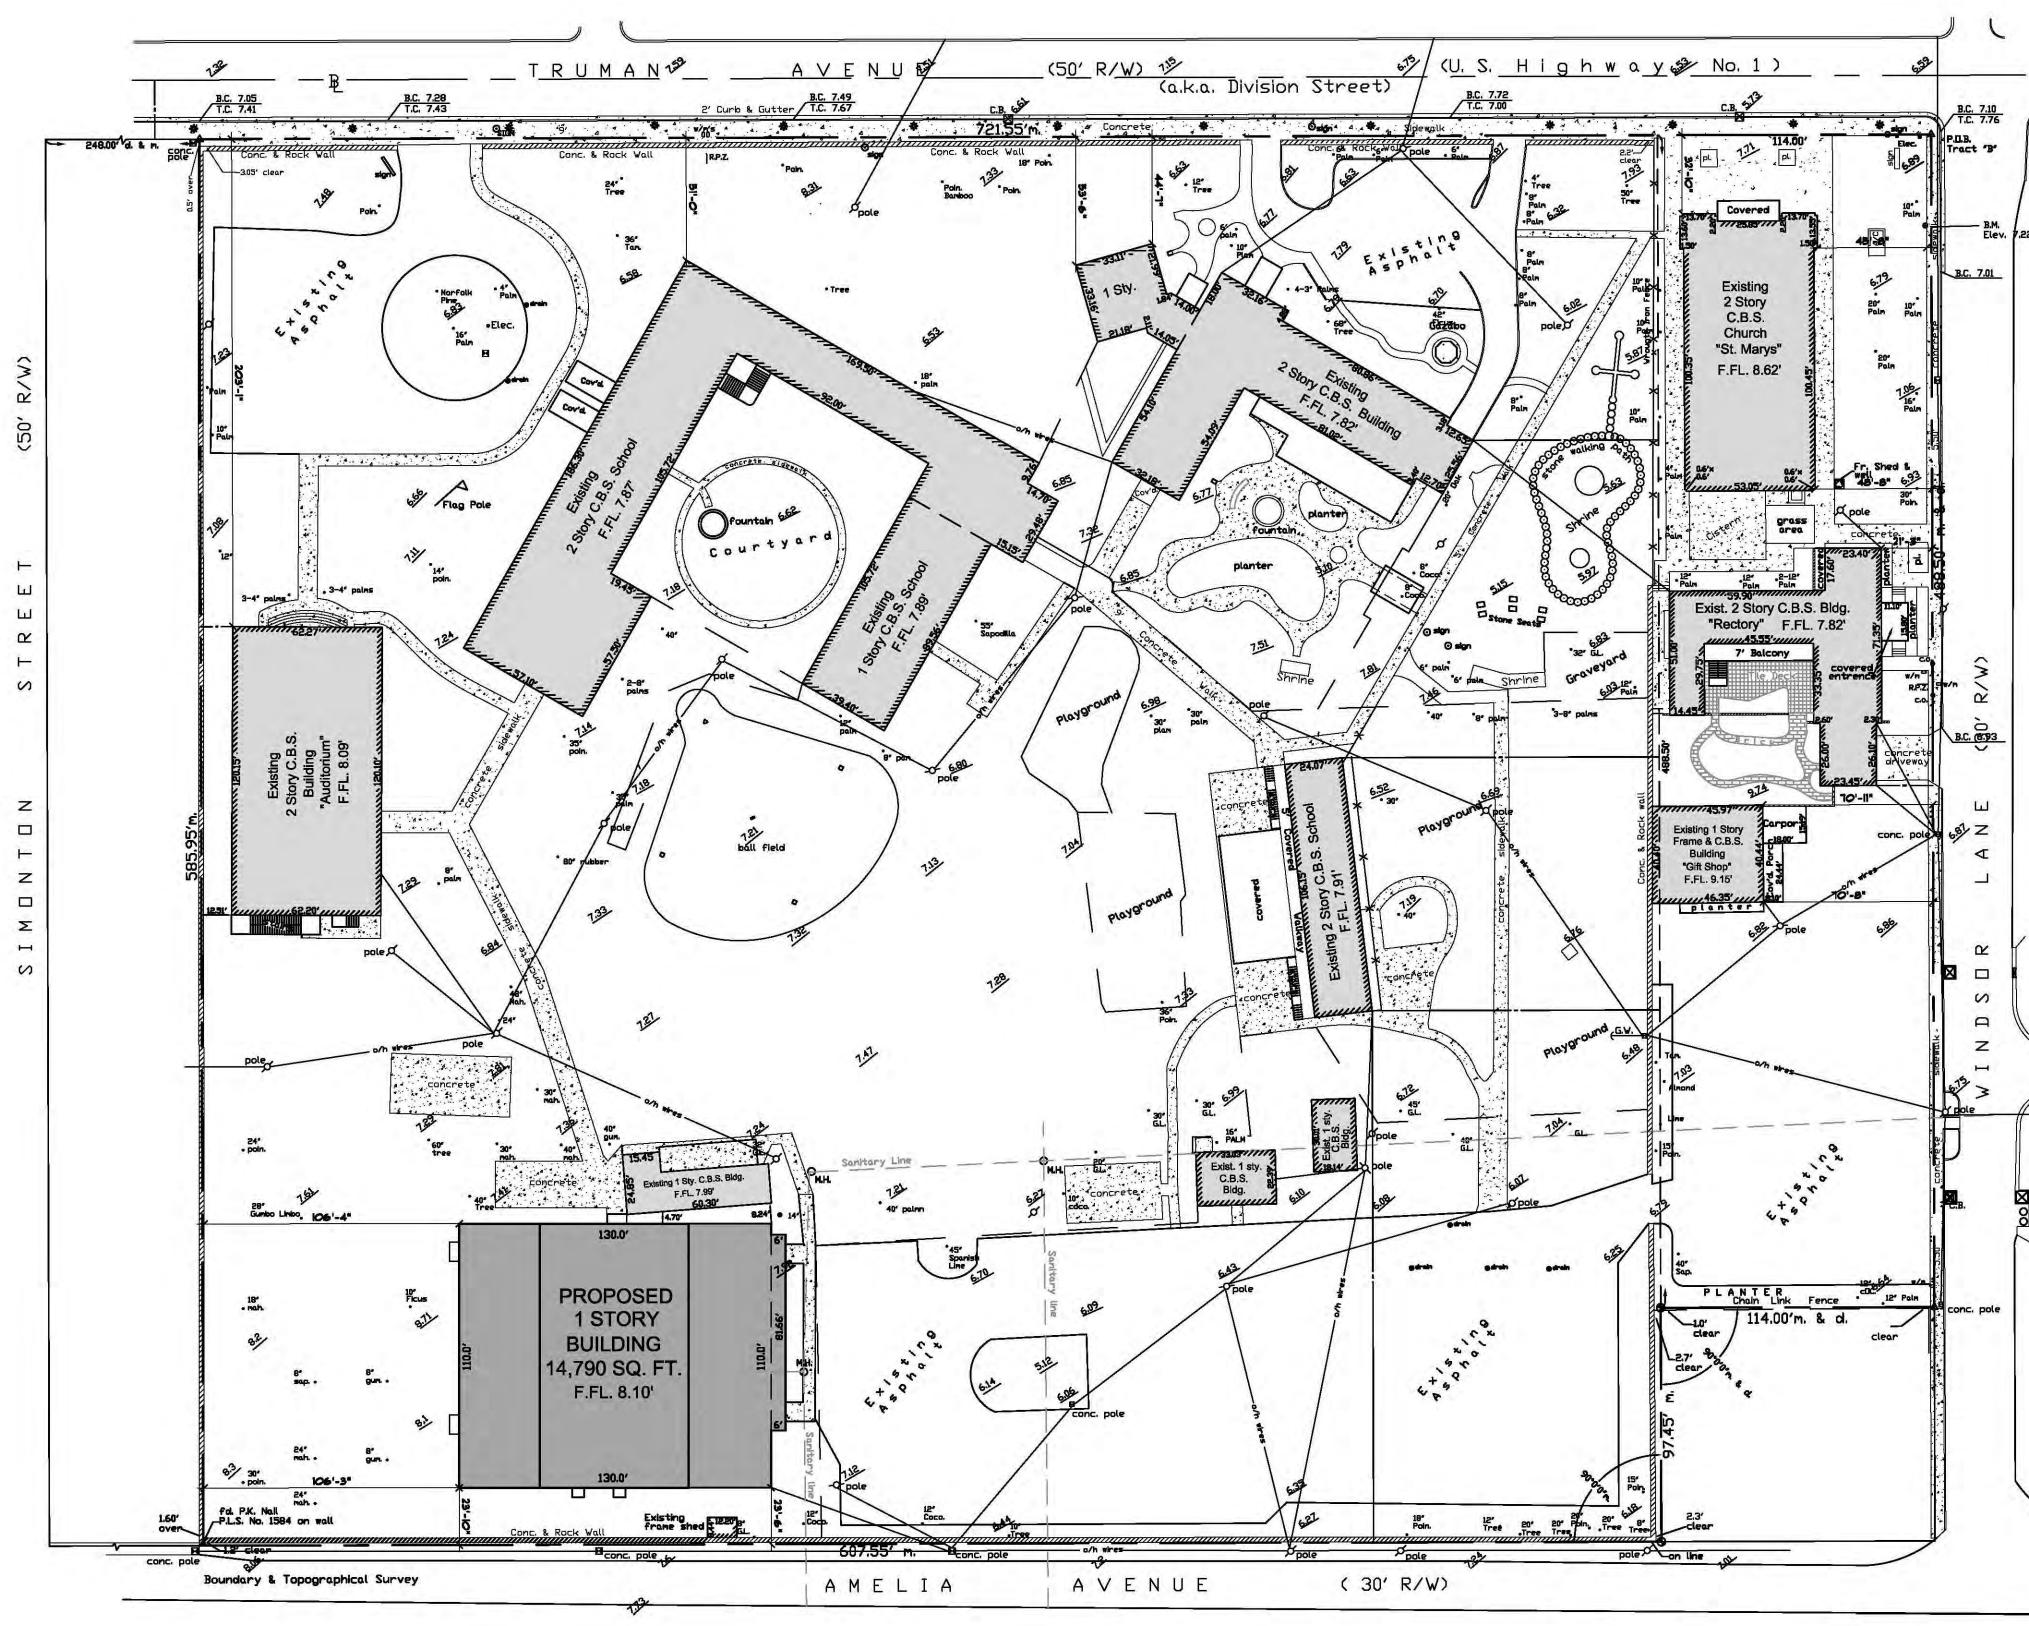



Abbreviations	
 ■ = Concrete Utility Pole Ø = Wood utility Pole ←Ø = Wood Utility Pole with Guy wire ØF.W= Fire Well ●M.W= Montering Well ○ = Water Meter ⋈ = Water Valve ○ = Electric Metele 	□E.= Electric Utility Vault O M.H. = Man Hole San.= Sanitary ⊠C.B.= Storm Water Catch Basin Inv= Invert B.P.Z.= Backflow Prevention Valve P.V.C.= Polyvinyl Pipe R.C.P.= Reniforced Concrete pipe + = Fire Hydrant
OE. = Electric Manhole Sty. = Story R/W = Right-of-Way fd. = Found p. = Plat m. = Measured d. = Deed D.R. = Official Records N.T.S. = Not to Scale Q = Centerline B = Baseline Elev.= Elevation B.M. = Bench Mark	<pre>* = Light @ = sign o/h = Dverhead u/g = Underground F.FL.= Finish Floor Elevation conc= concrete I.P. = Iron Pipe I.B. = Iron Bar B_ = Baseline C.B. = Concrete Block C.B.S.= Concrete Block Stucco cov'd= Covered</pre>
P.O.C. = Point of Commence P.O.B. = Point of Beginning P.B. = Plat Book pg. = page Elec= Electric Tel. = Telephone	P.I. = Point of Intersection wd. = Wood w.m. = Water Meter Bal. = Balcony Pl. = Planter Hydt . Fire Hydrant
Ench= Encroachment D.L. = Dn Line	F.W. = Fire Well A/C = Air Conditioner

C.L.F.= Chain Link Fence




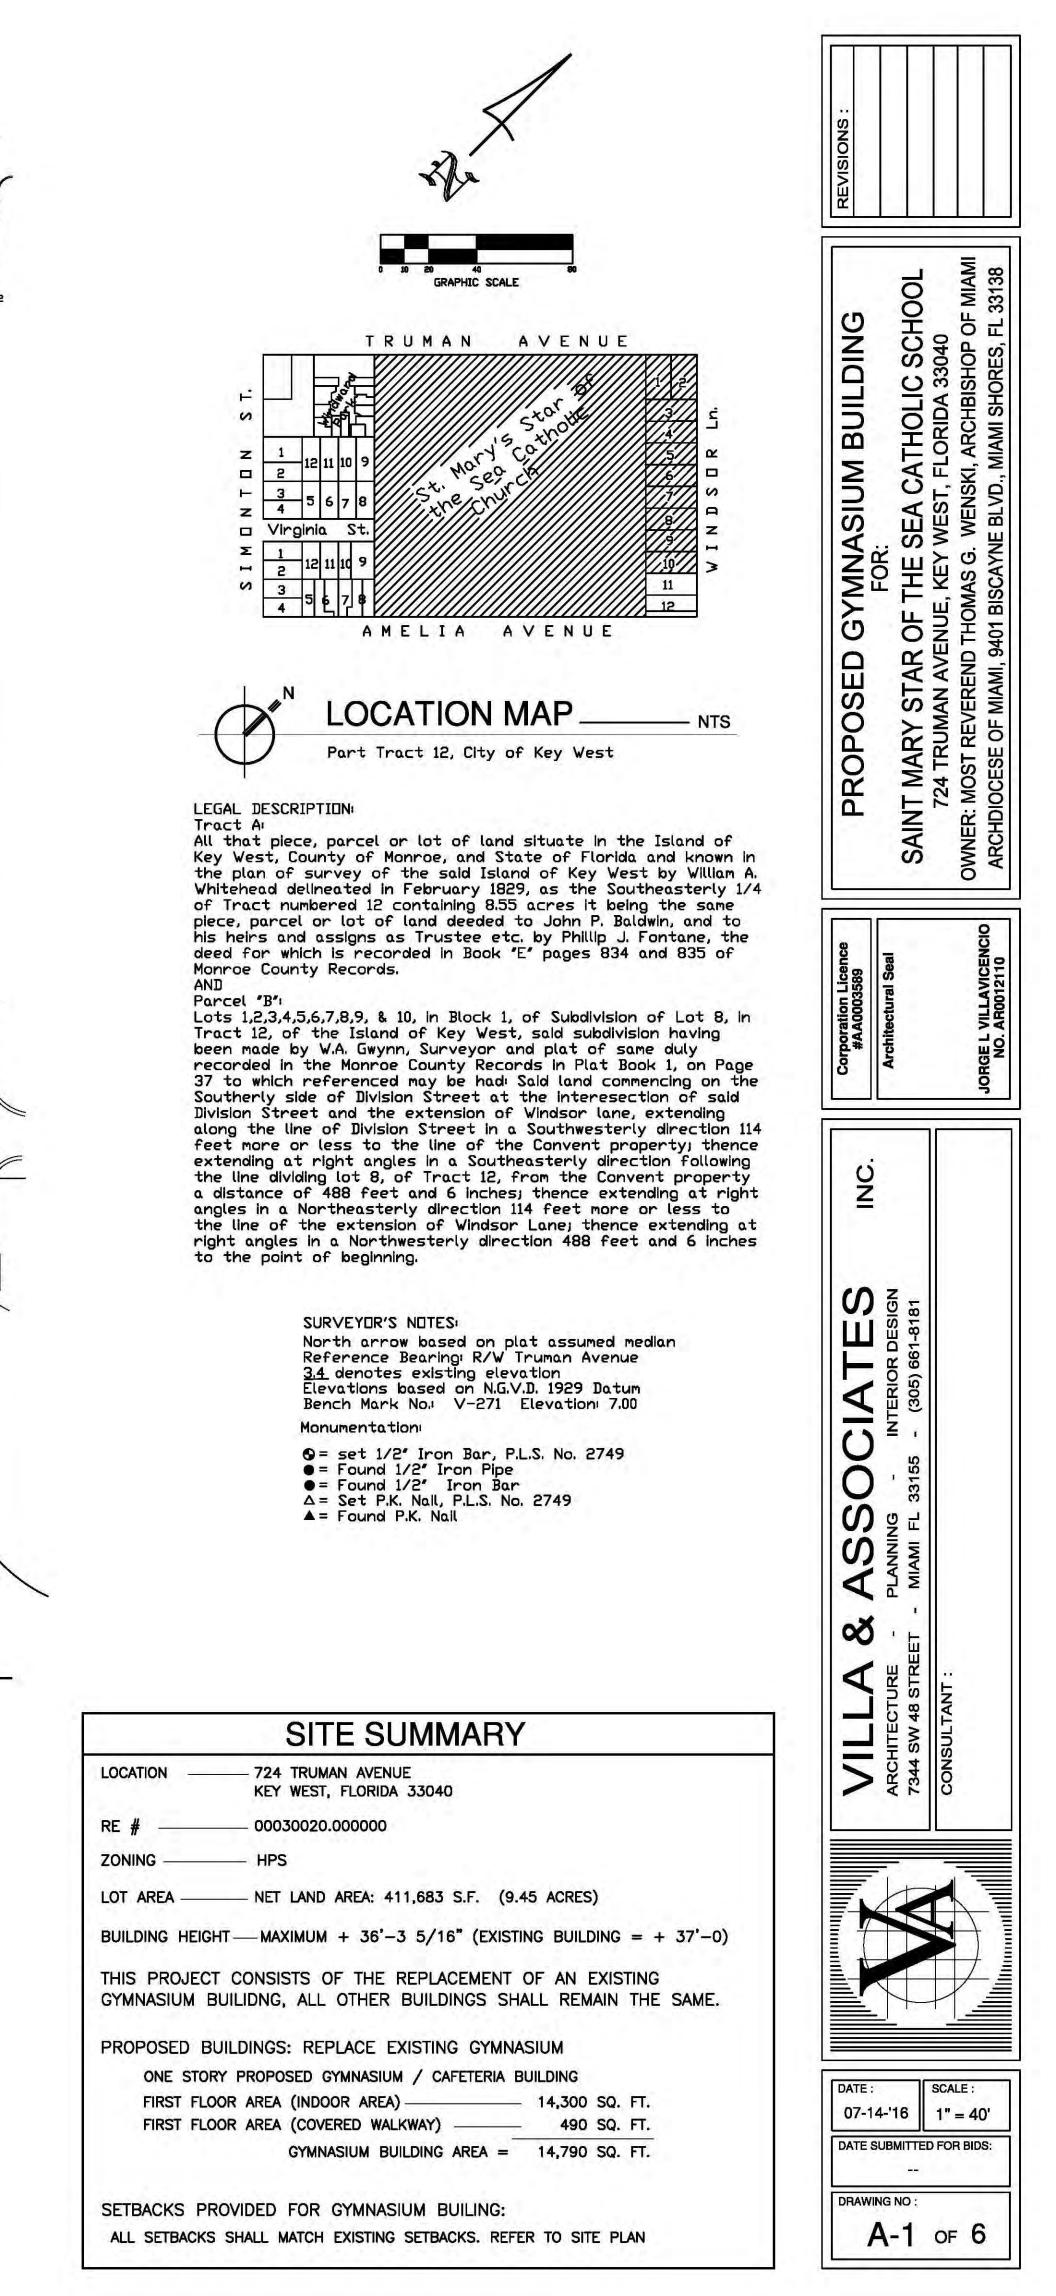

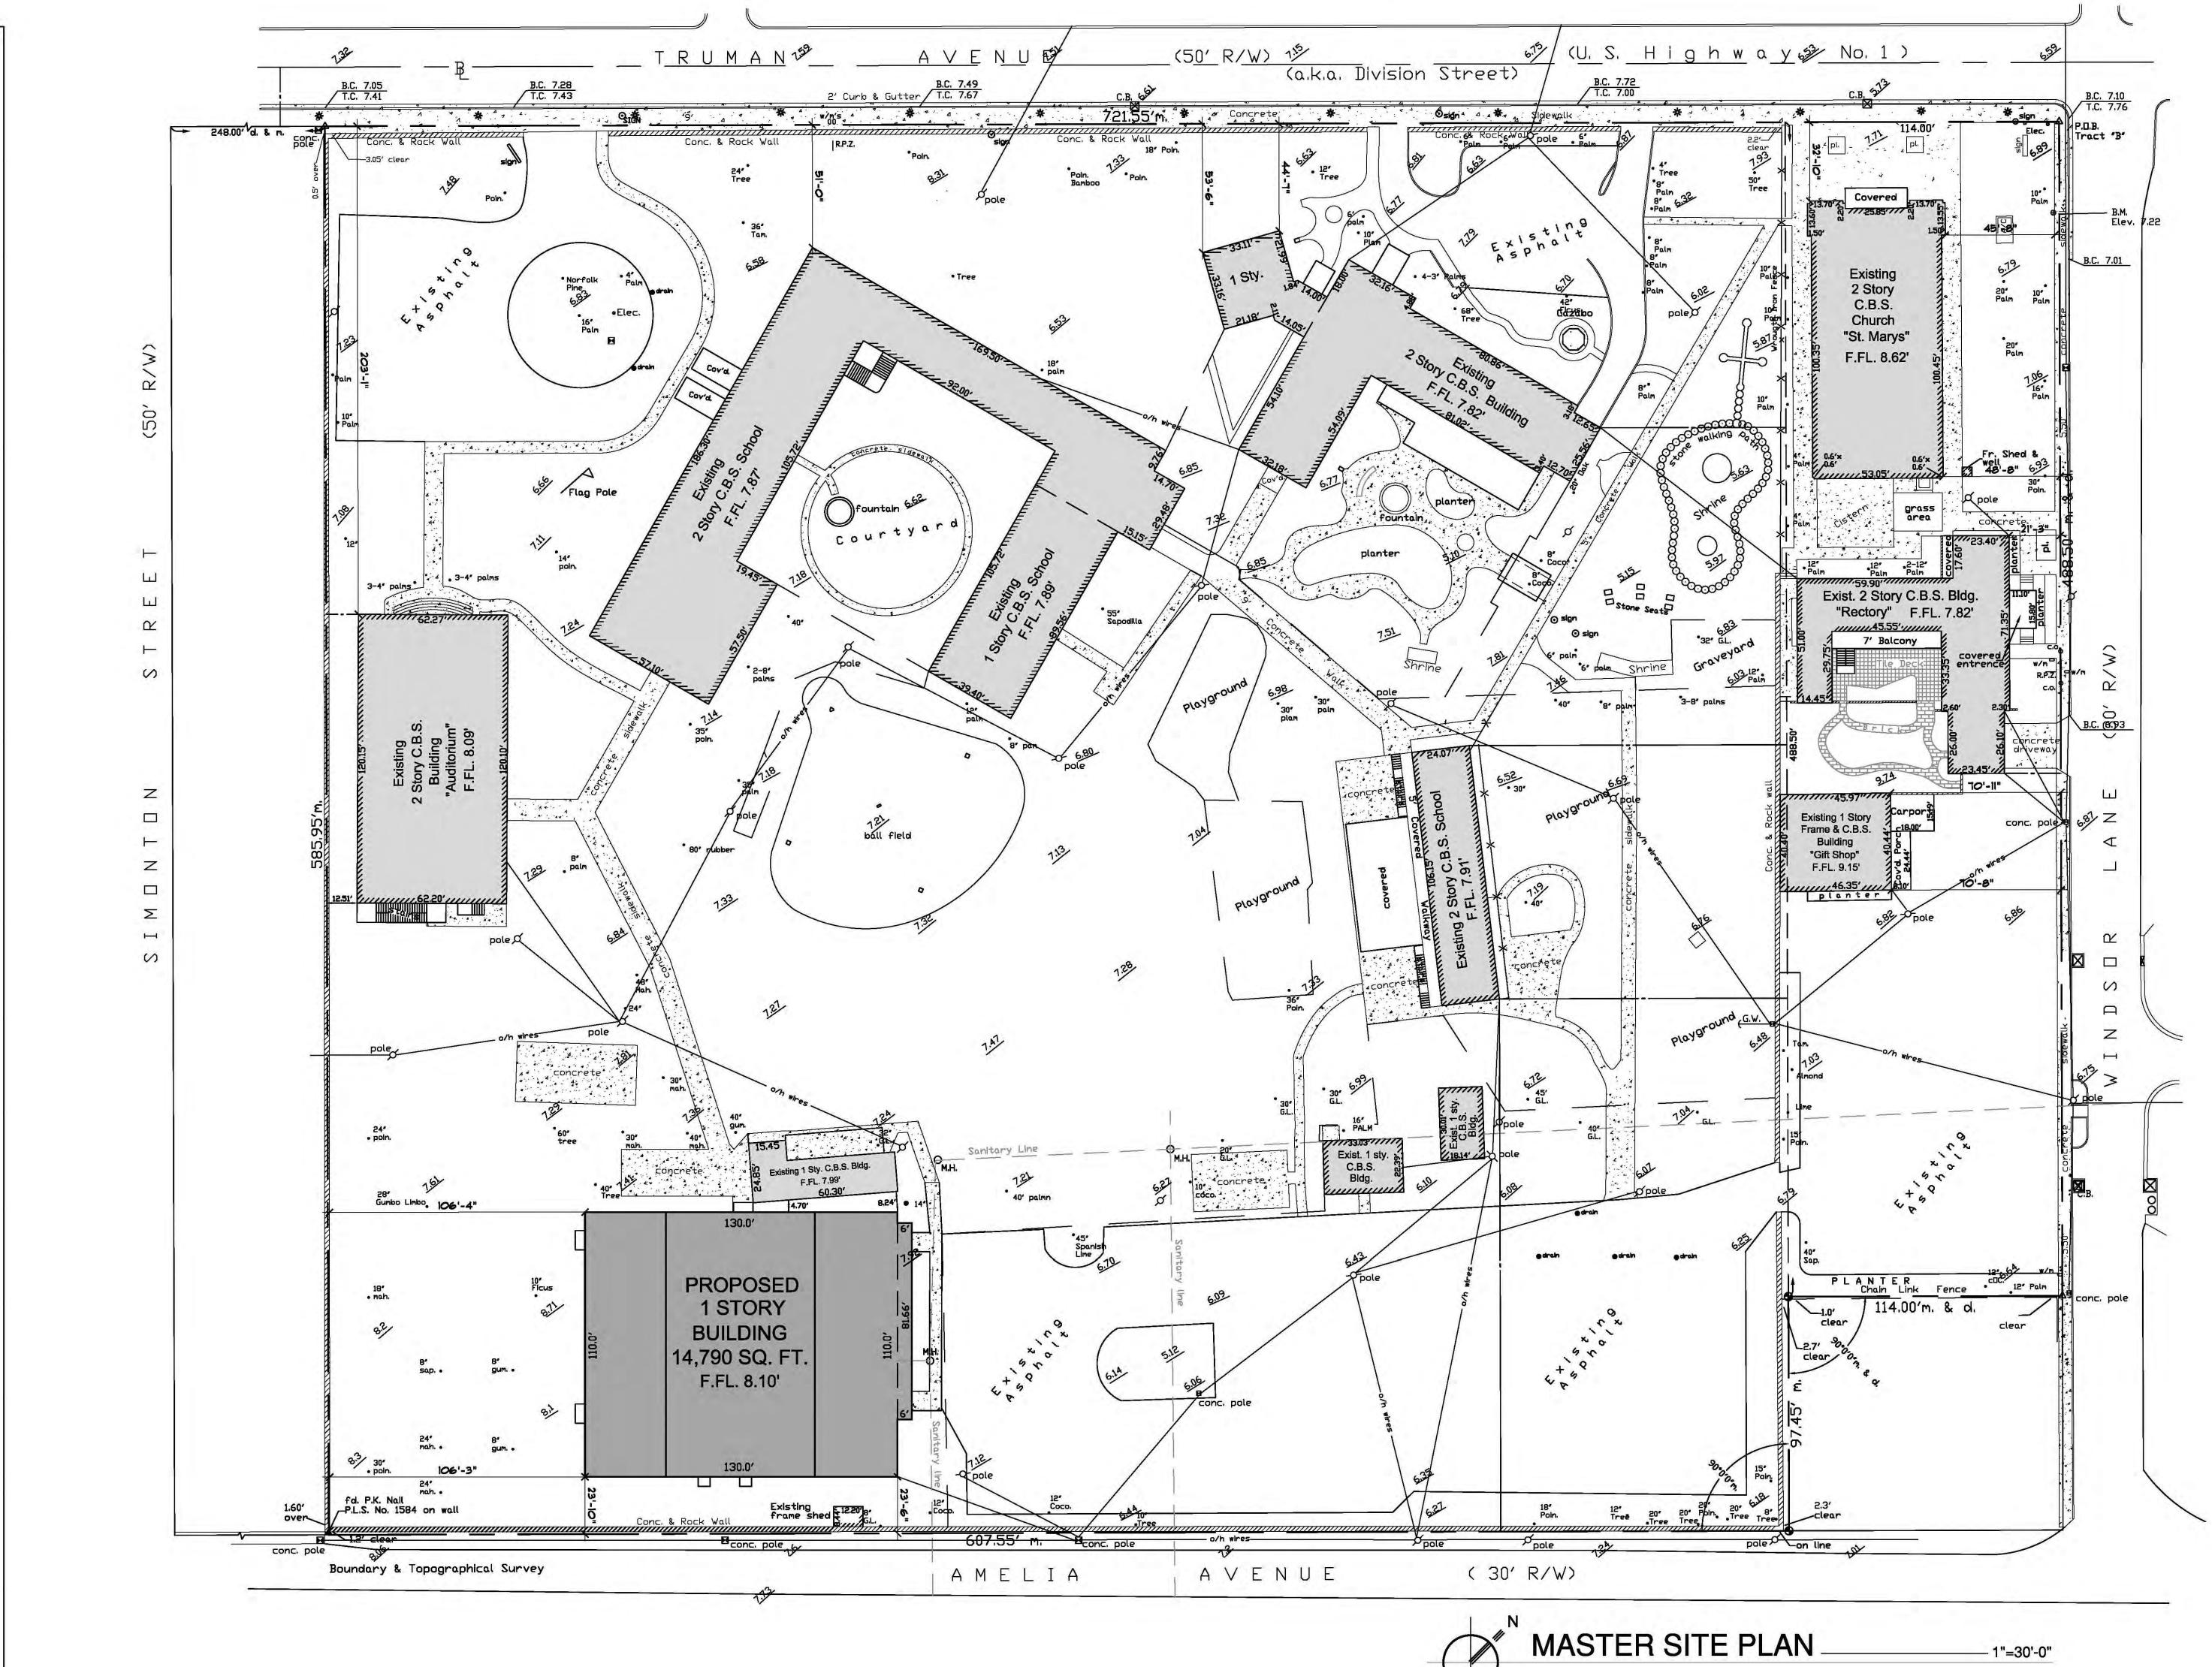

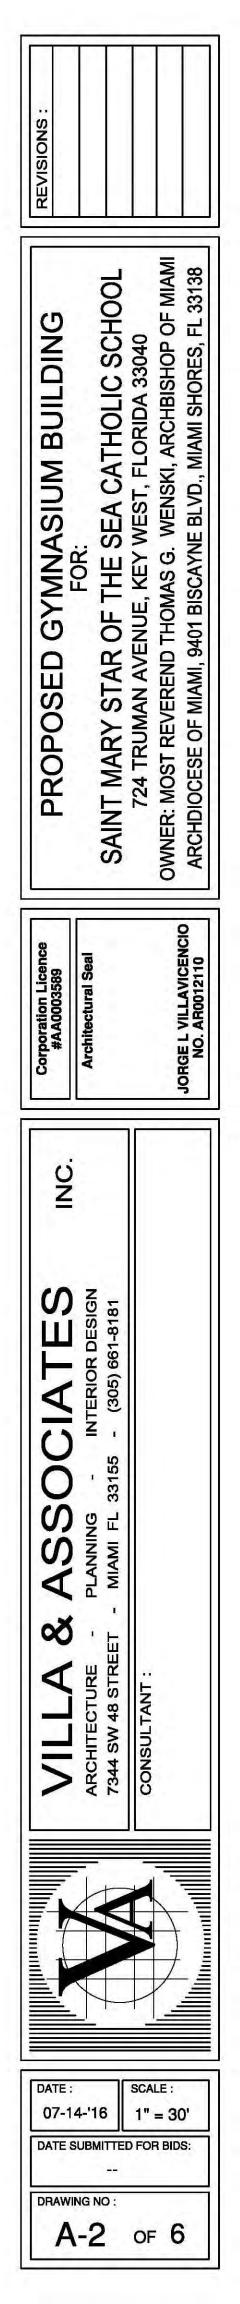




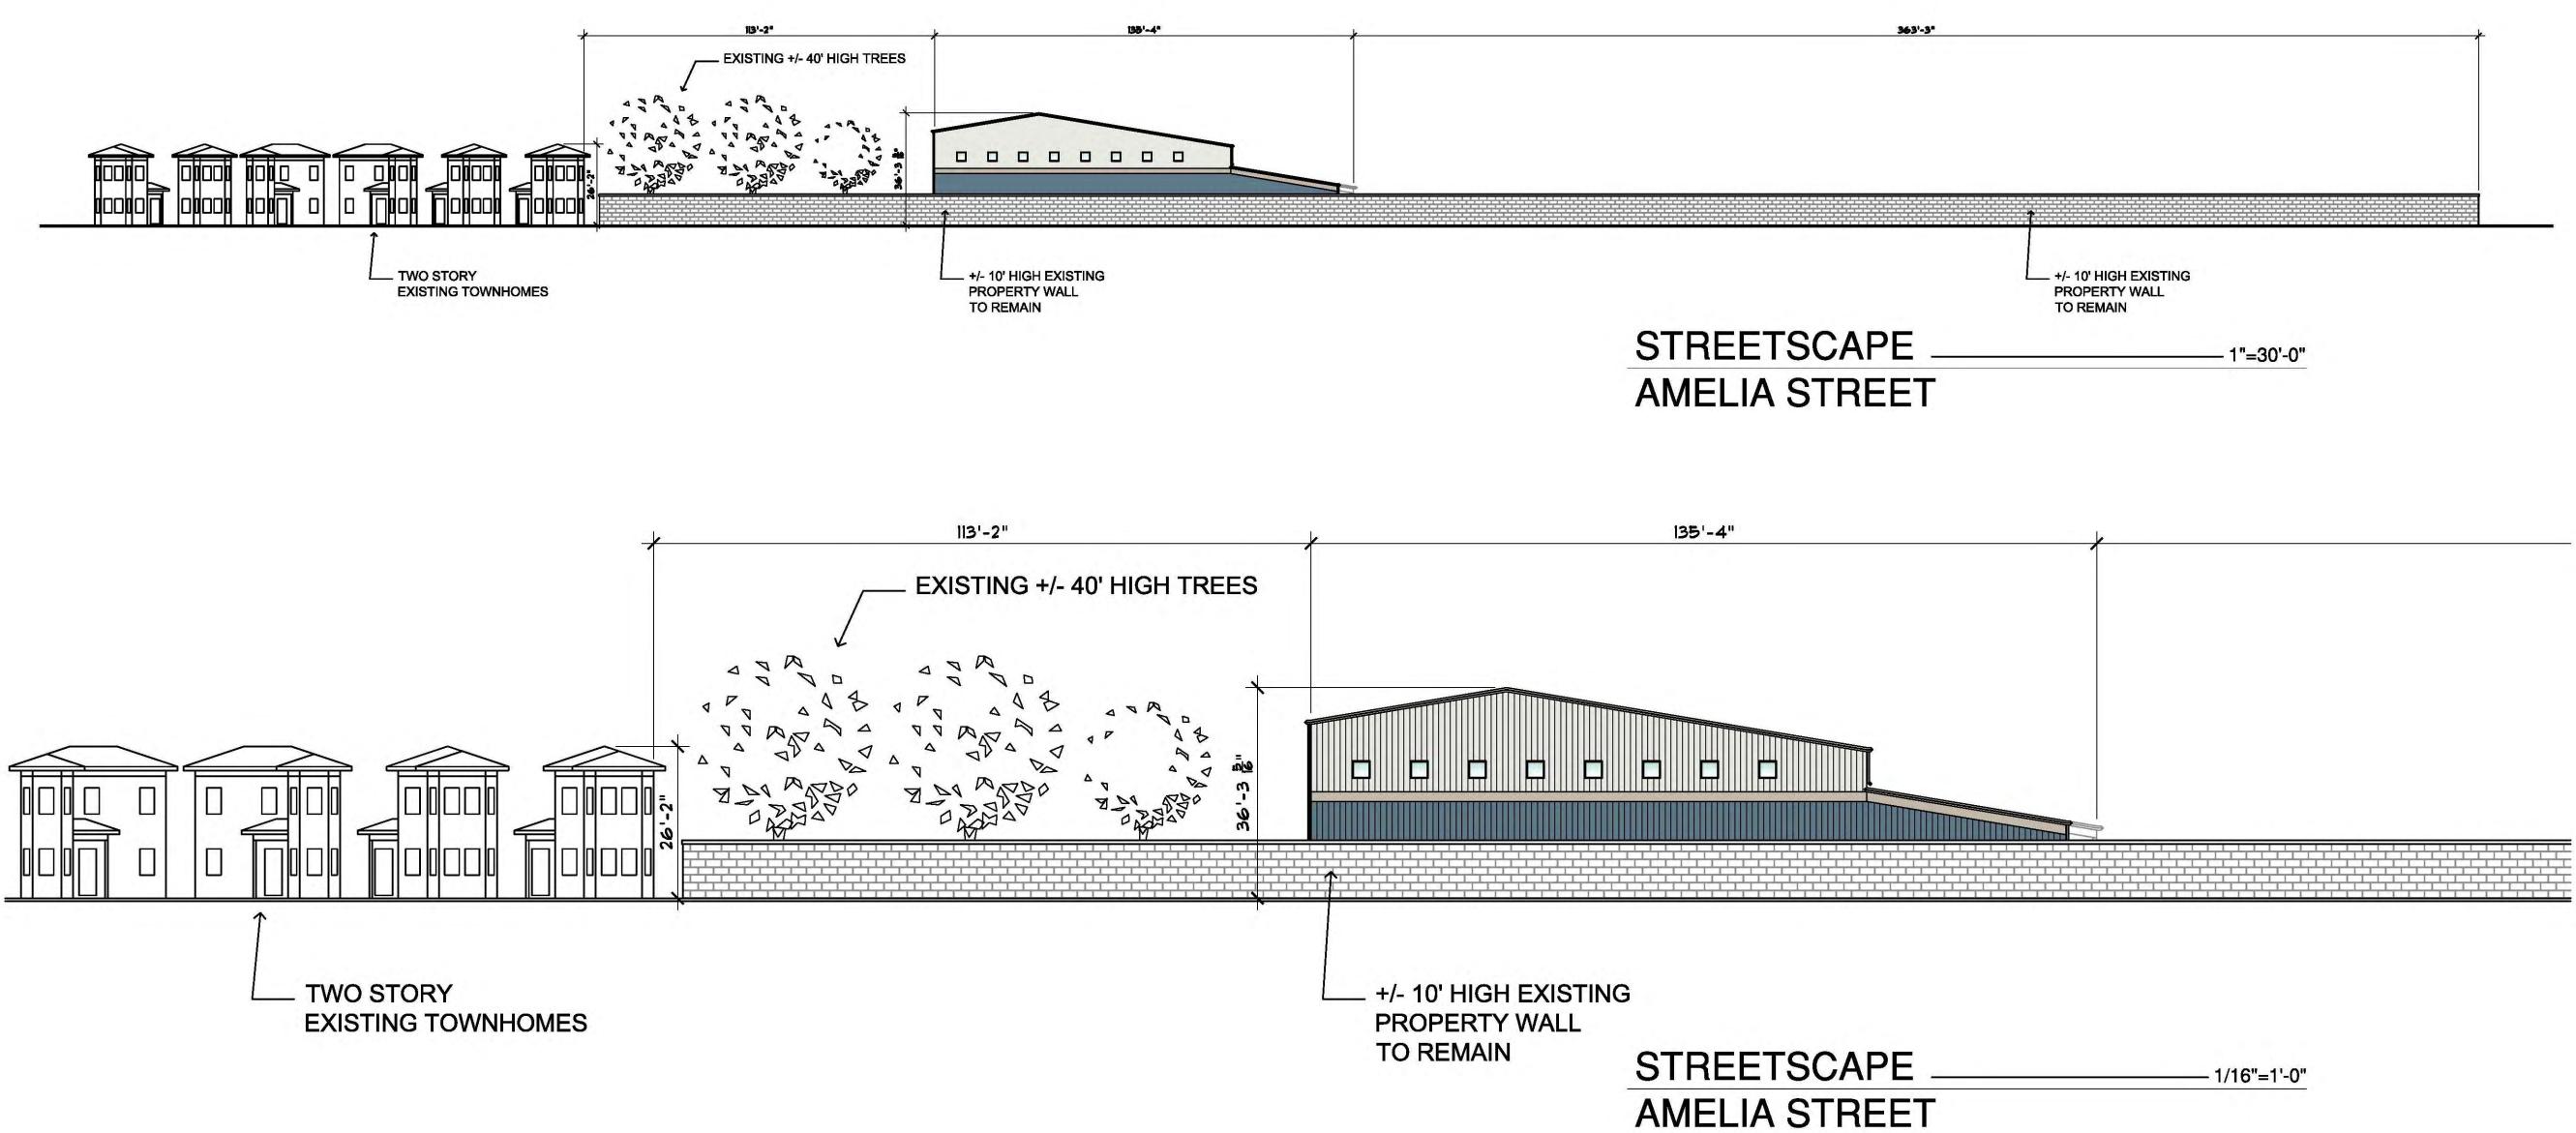



= MIAN 33138 **IM BUILDING** PROP SAINT GE L VILLAVICENC NO. AR0012110 Ŷ ASSOCIATES PLANNING - INTERIOR DESIGN - MIAMI FL 33155 - (305) 661-8181 Š VILL ARCHITECT 7344 SW 48 CONSULTAI DATE : SCALE : 07-14-'16 1" = 30' DATE SUBMITTED FOR BIDS: ---DRAWING NO :

A-2.1 OF 6

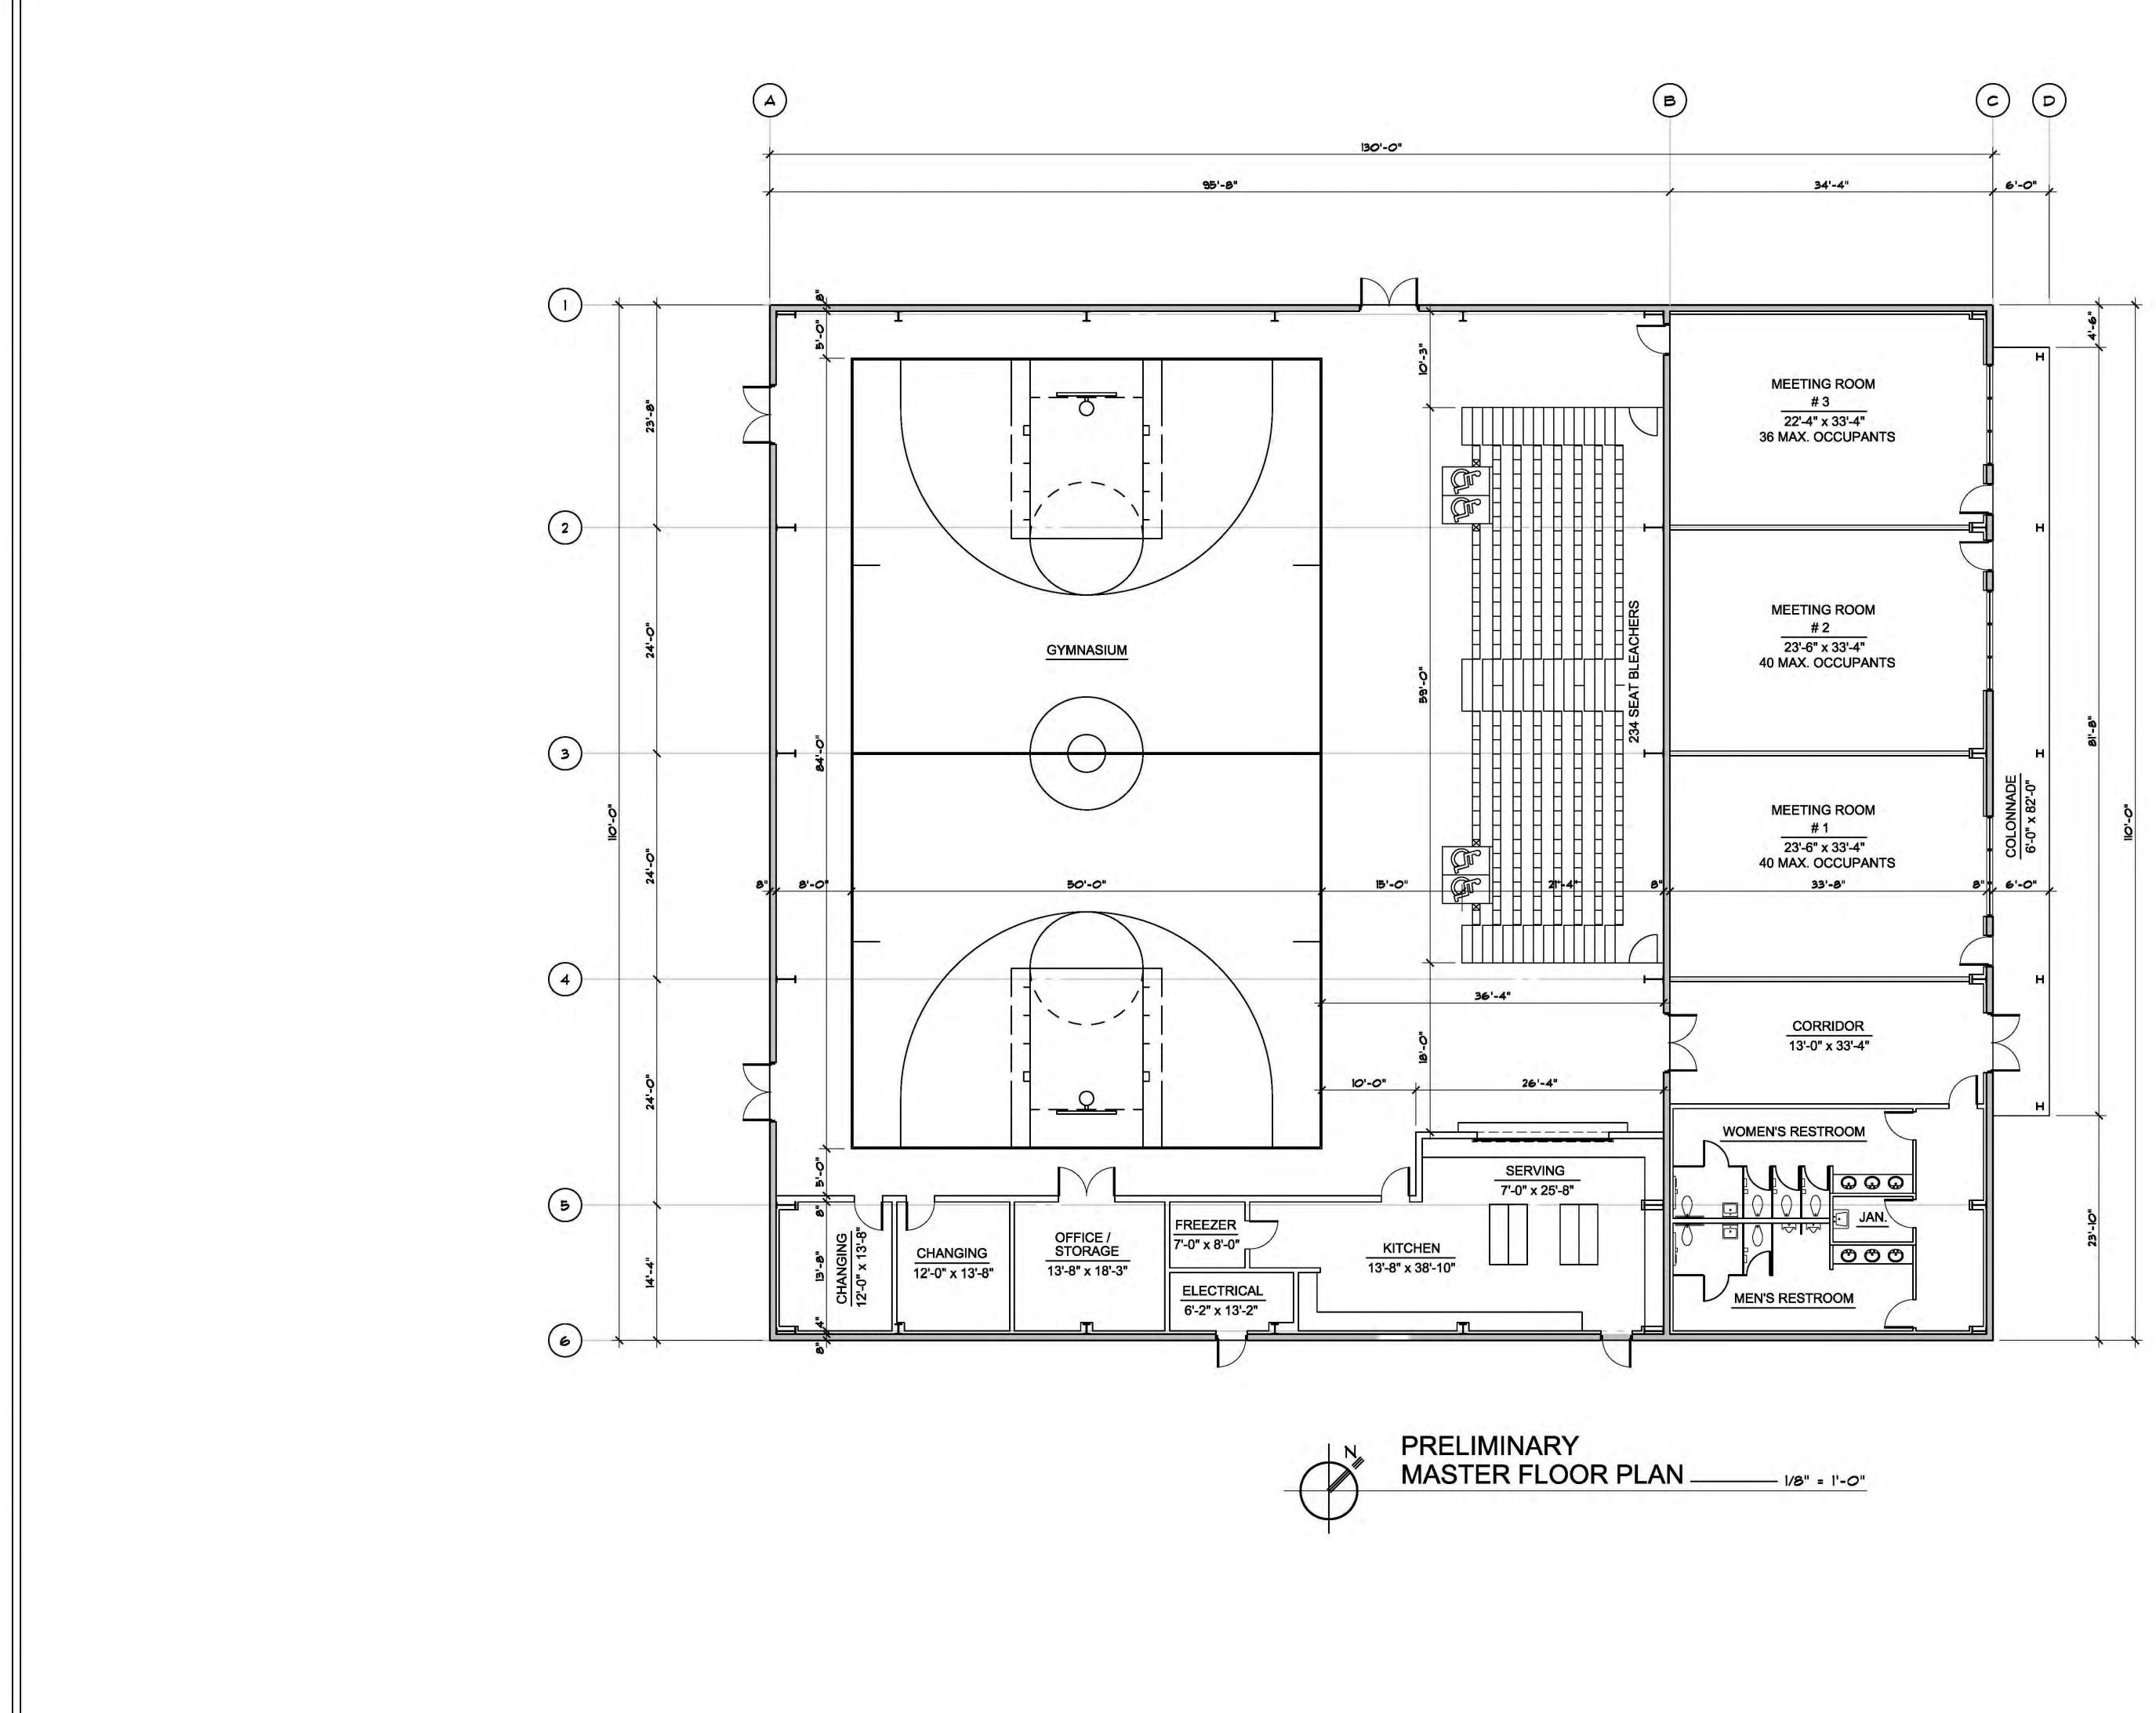




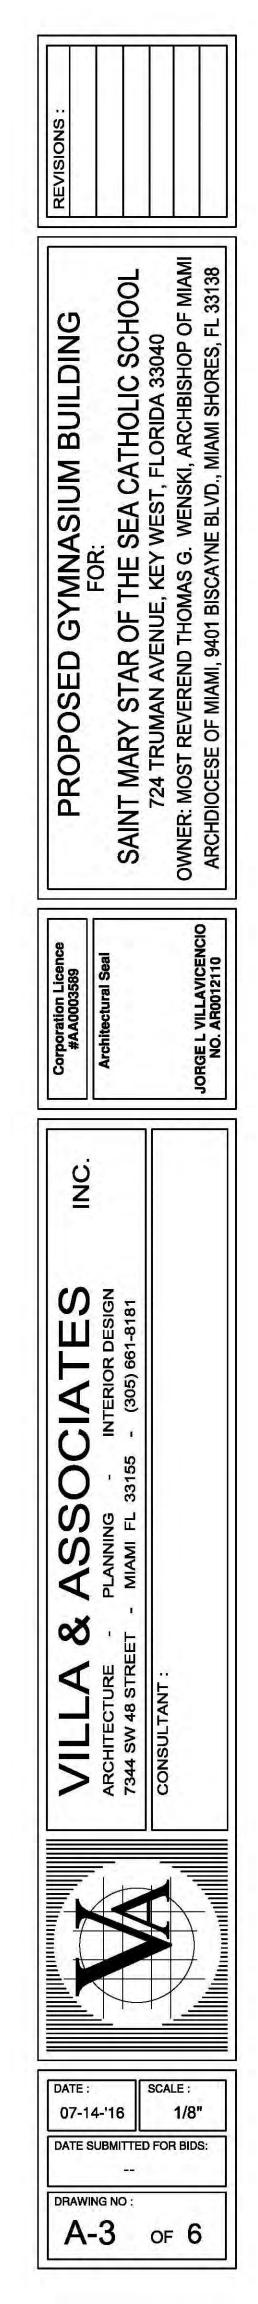

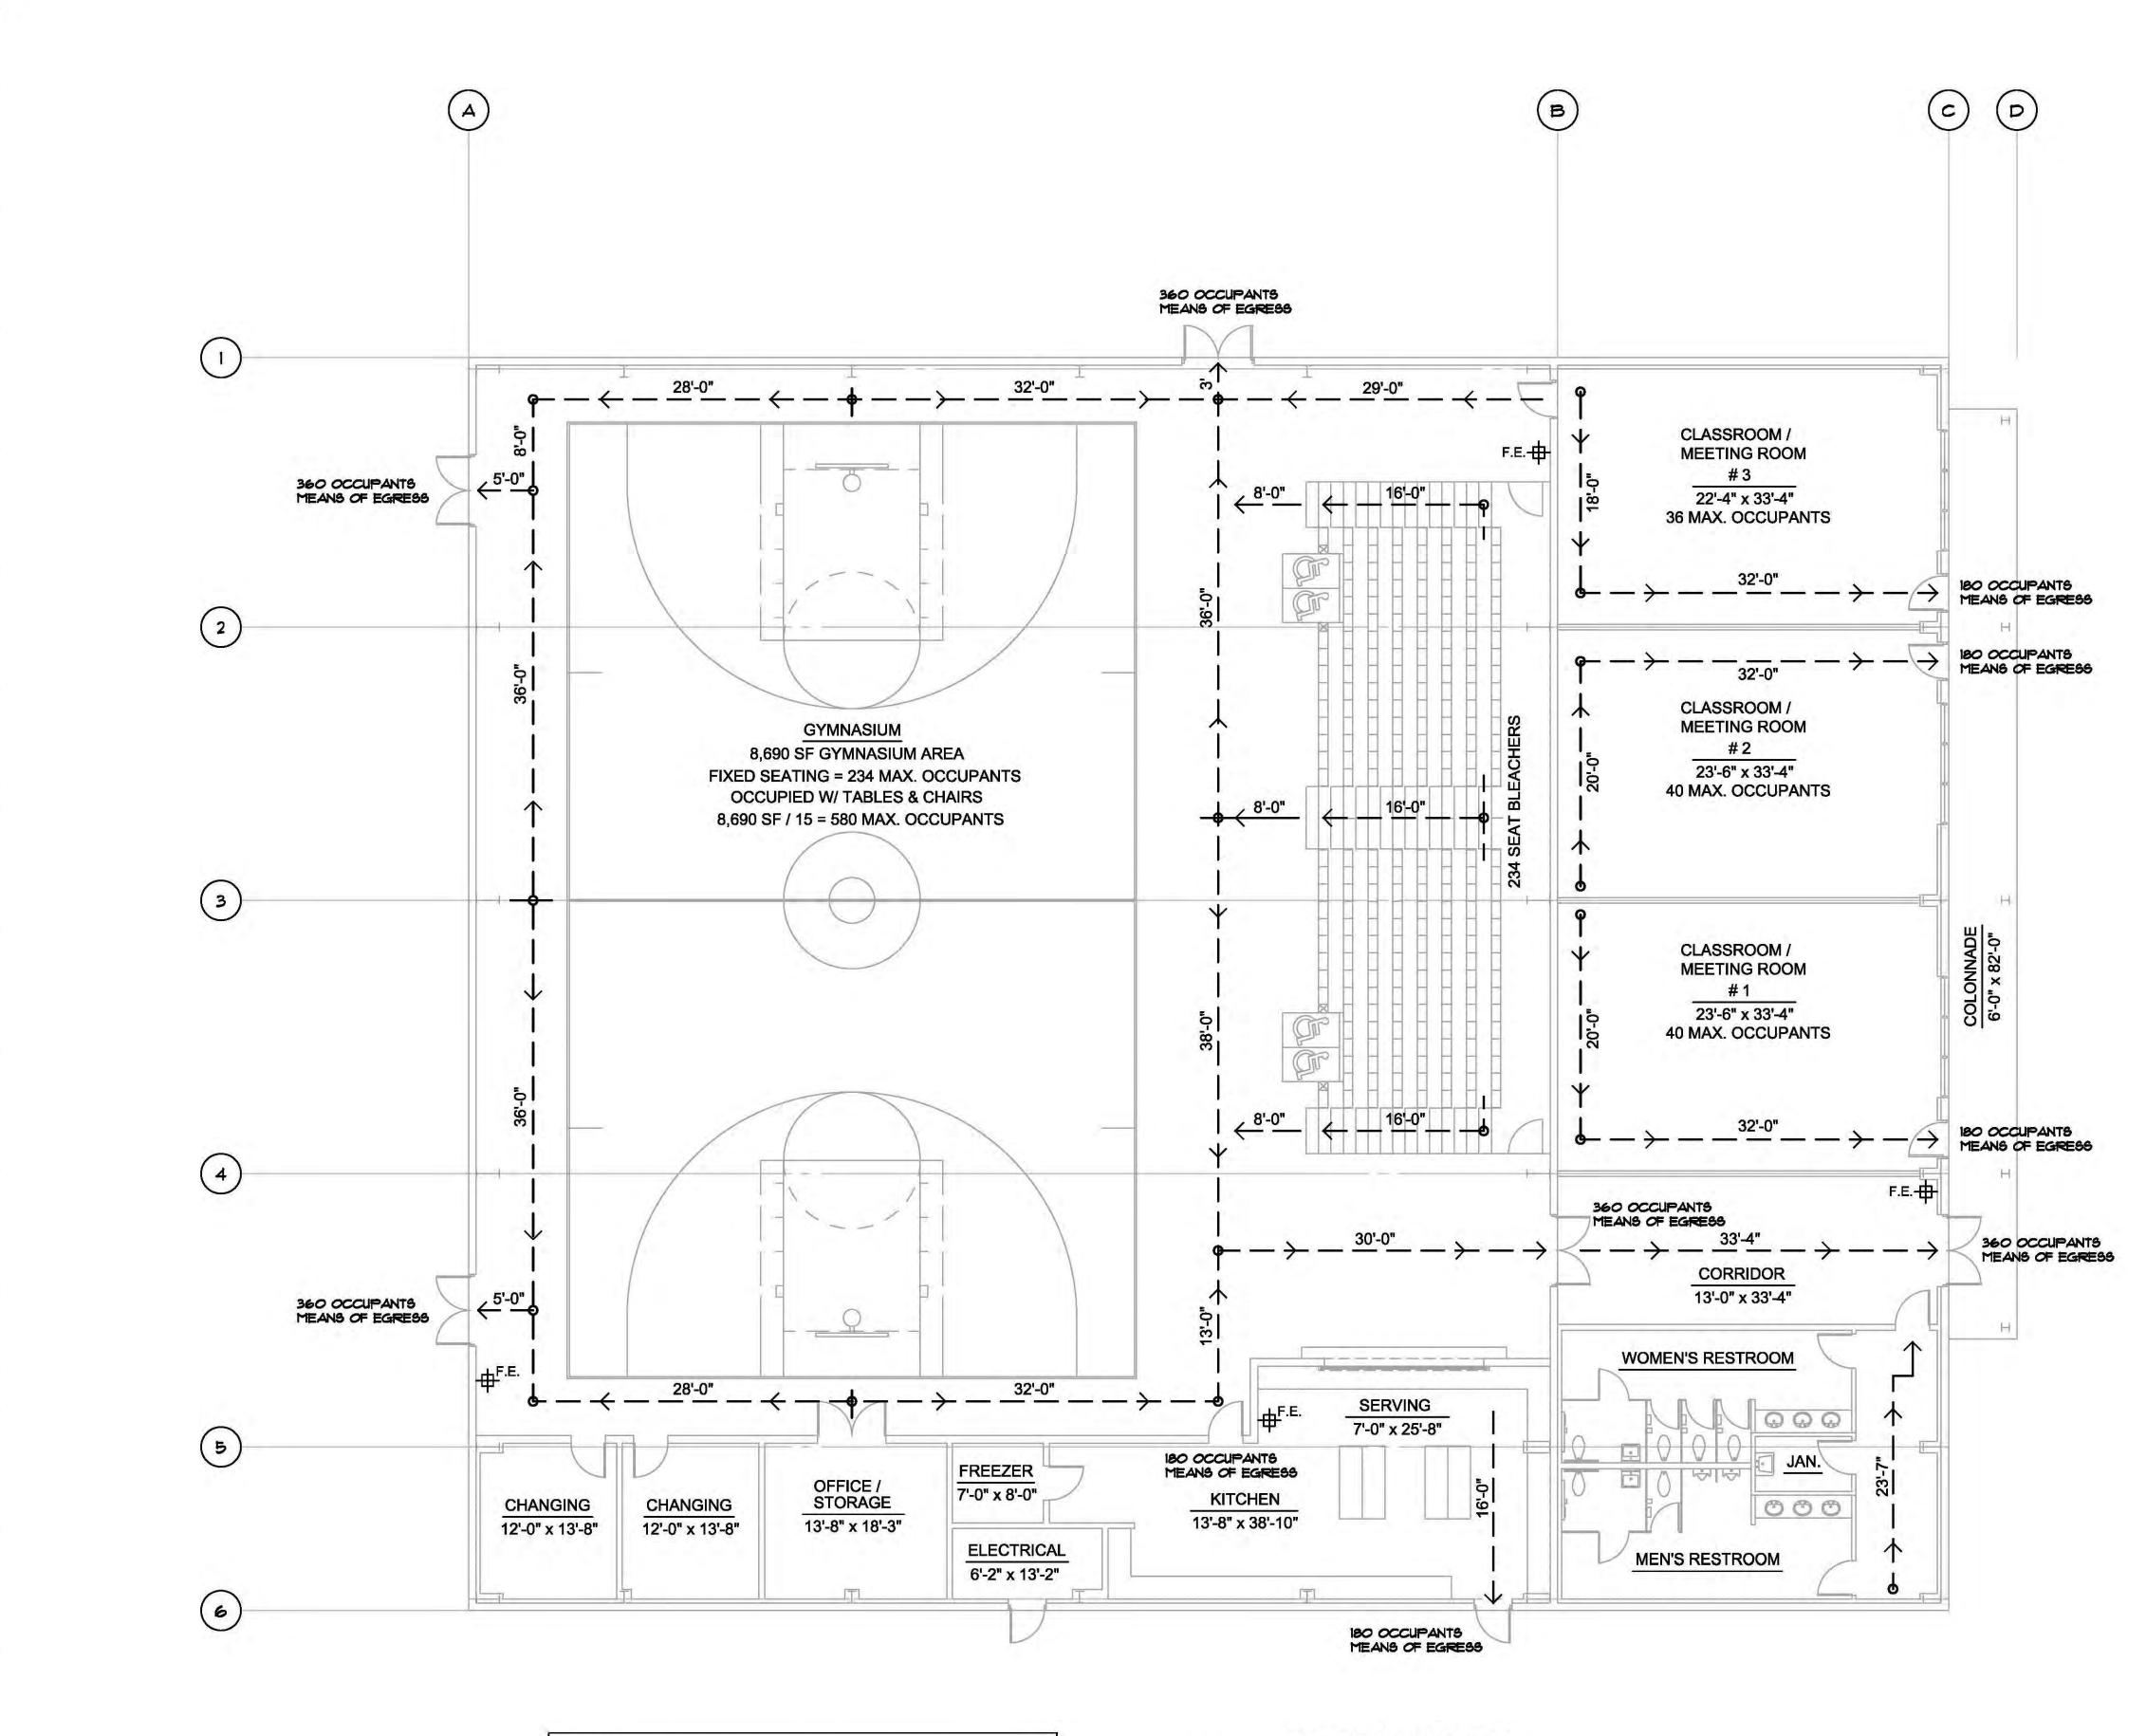


NOTE: ALL FIXED SEATING SHALL BE PURCHASED BY OWNER DIRECT FROM MANUFACTURER AND INSTALLED BY MANUF. MANUFACTURER SHALL SUBMIT SHOP DRAWINGS FOR APPROVAL. CONTRACTOR SHALL COORDINATE SCHEDULE OF INSTALLATION W/ FURNITURE MANUFACTURER.

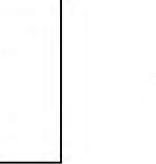



PRELIMINARY LIFE SAFETY FLOOR PLAN ____ 1/8" = 1'-0"

NOTES: 1. BUILDING SHALL BE EQUIPPED WITH A MONITORED FIRE ALARM SYSTEM IN ACCORDANCE WITH FFPC 2014 AND TIED TO THE SCHOOL FIRE ALARM SYSTEM.

2. BUILDING SHALL BE EQUIPPED WITH A MONITORED FIRE SPRINKLER PROTECTION SYSTEM IN ACCORDANCE WITH FFPC 2014

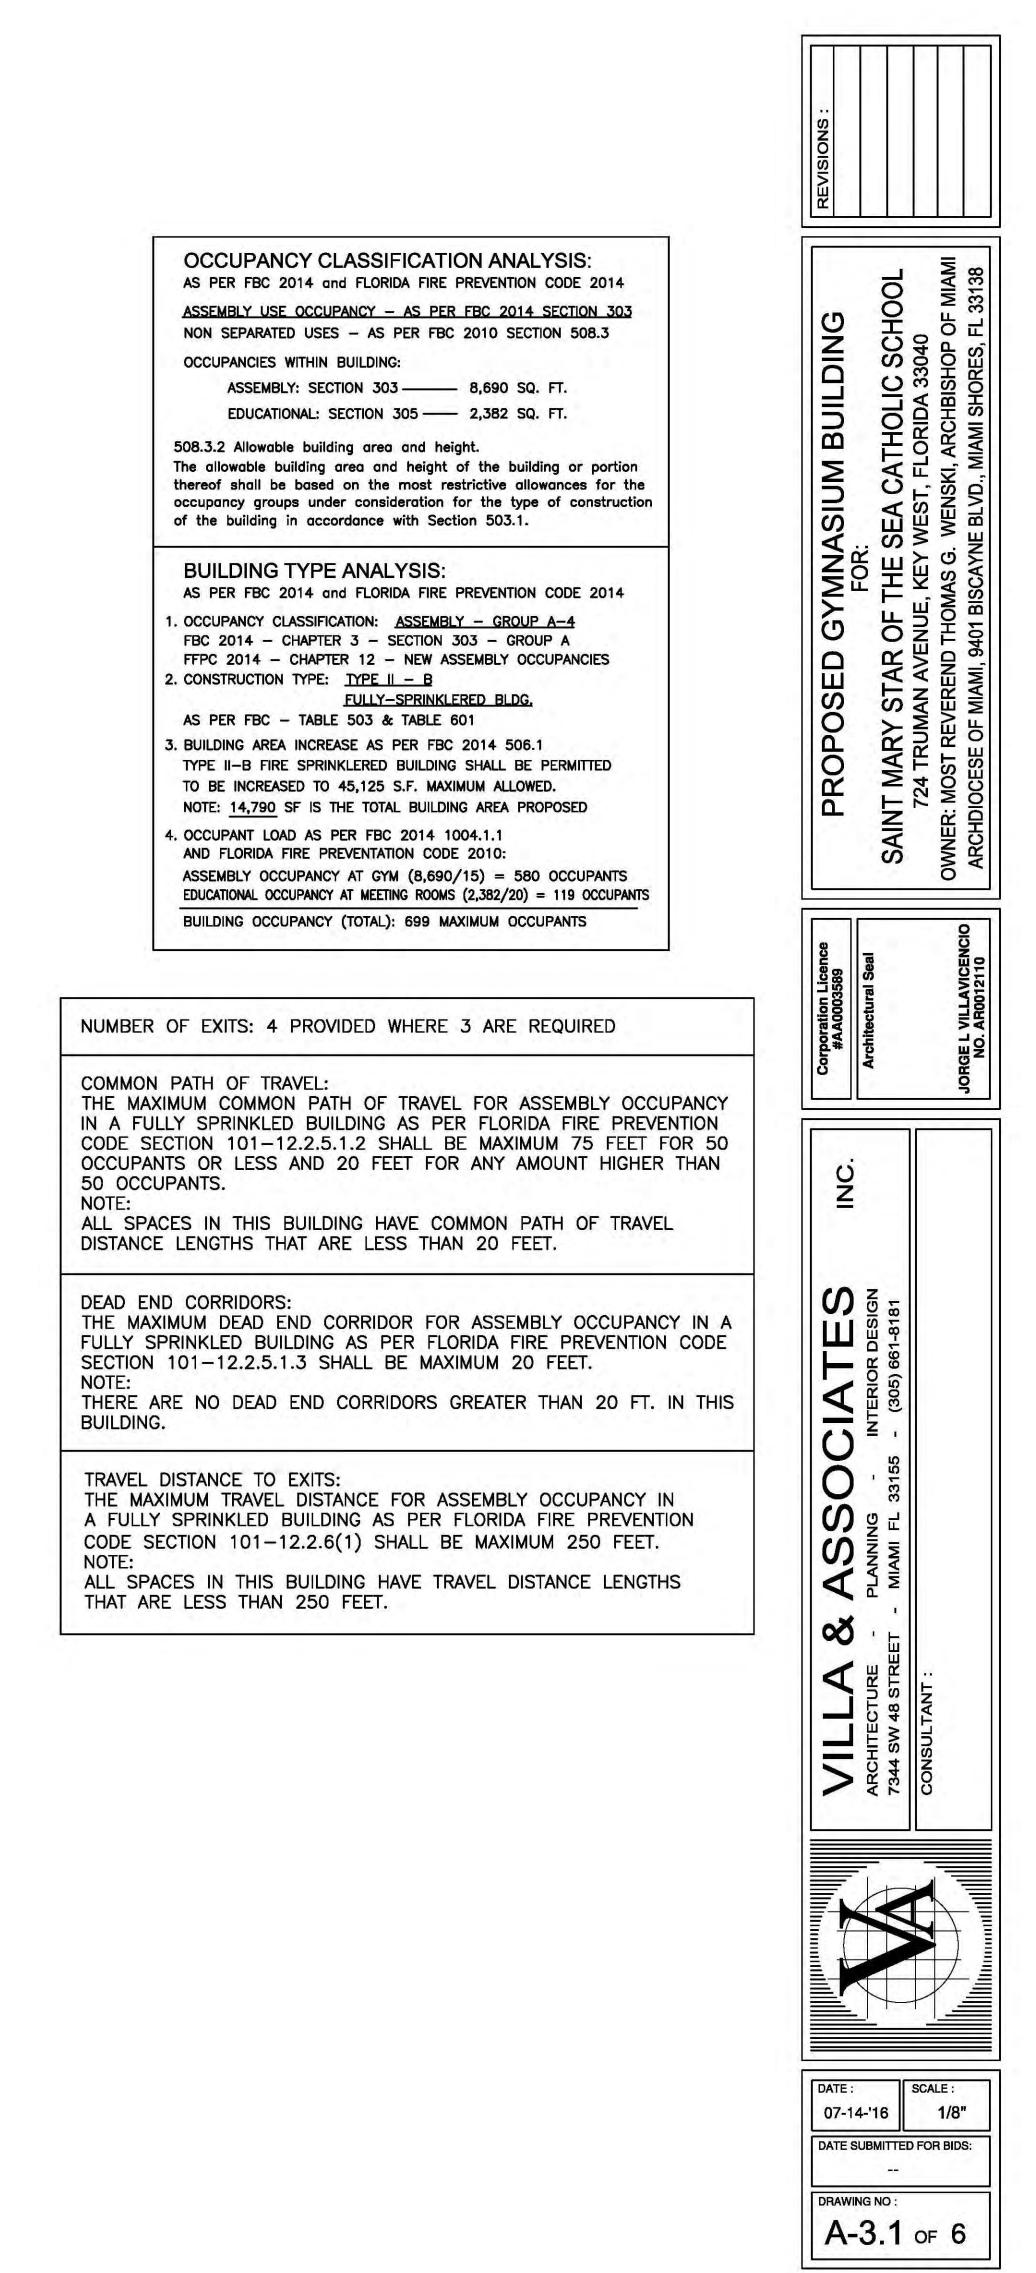

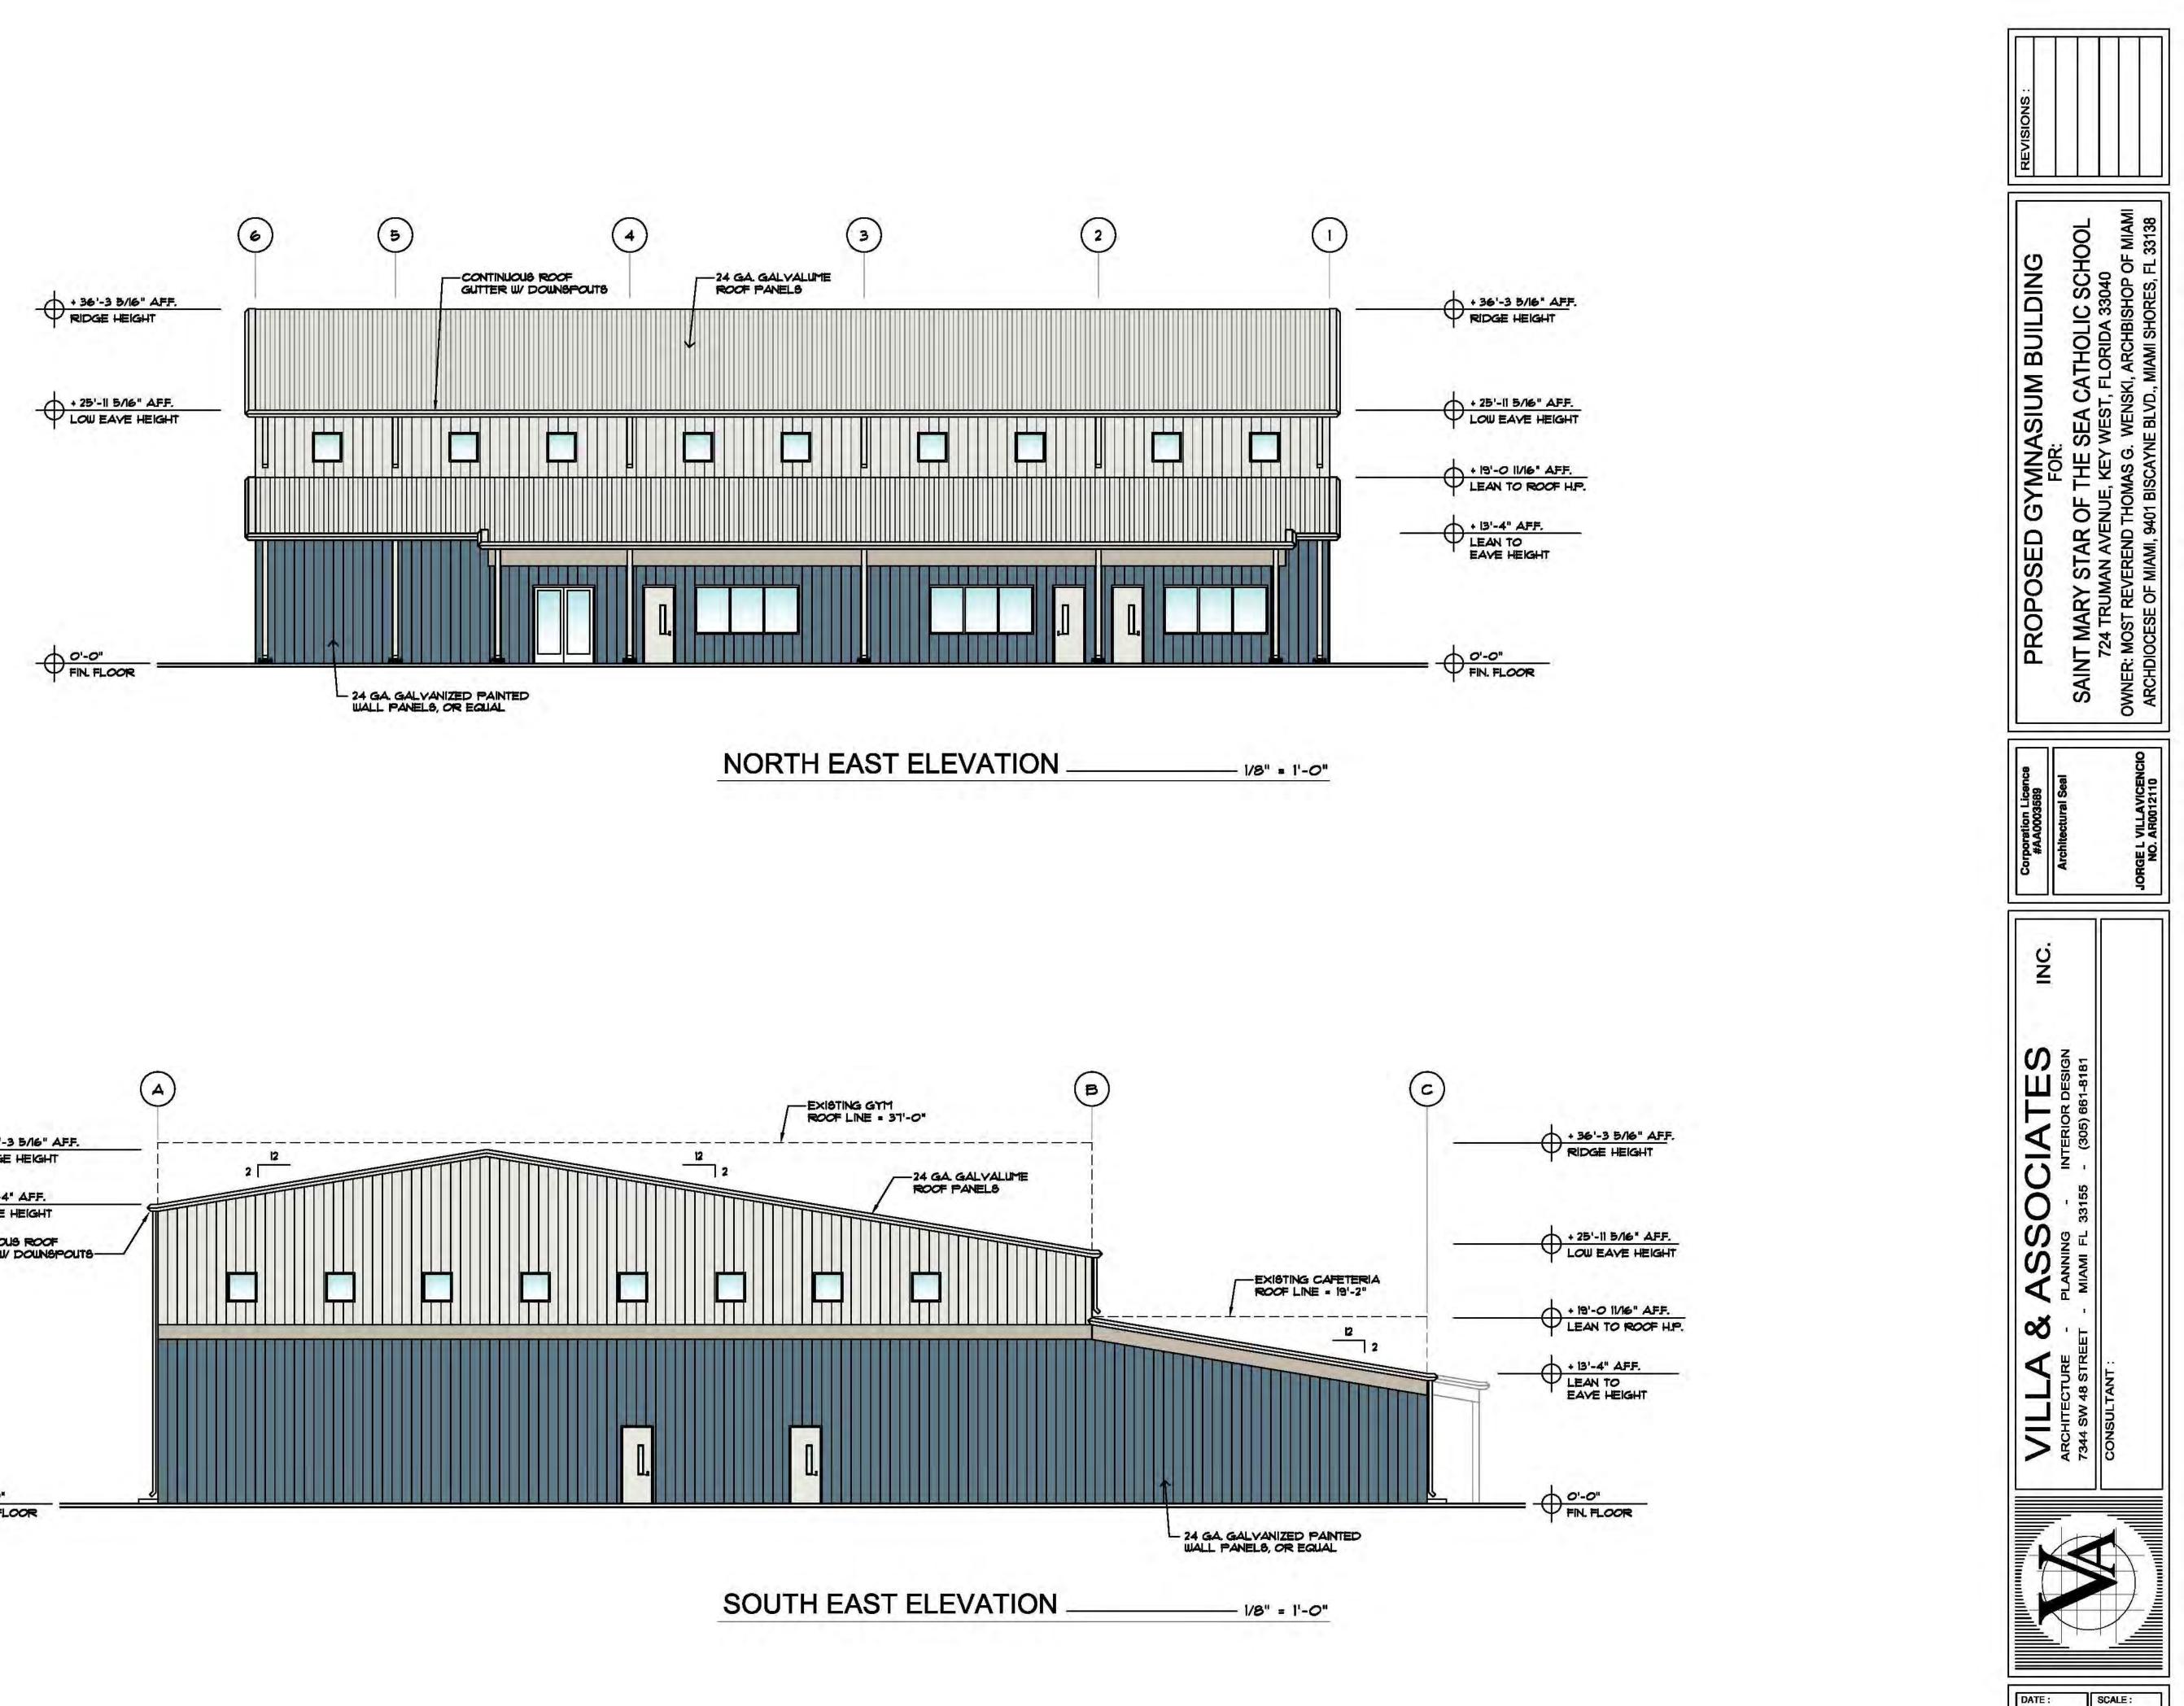

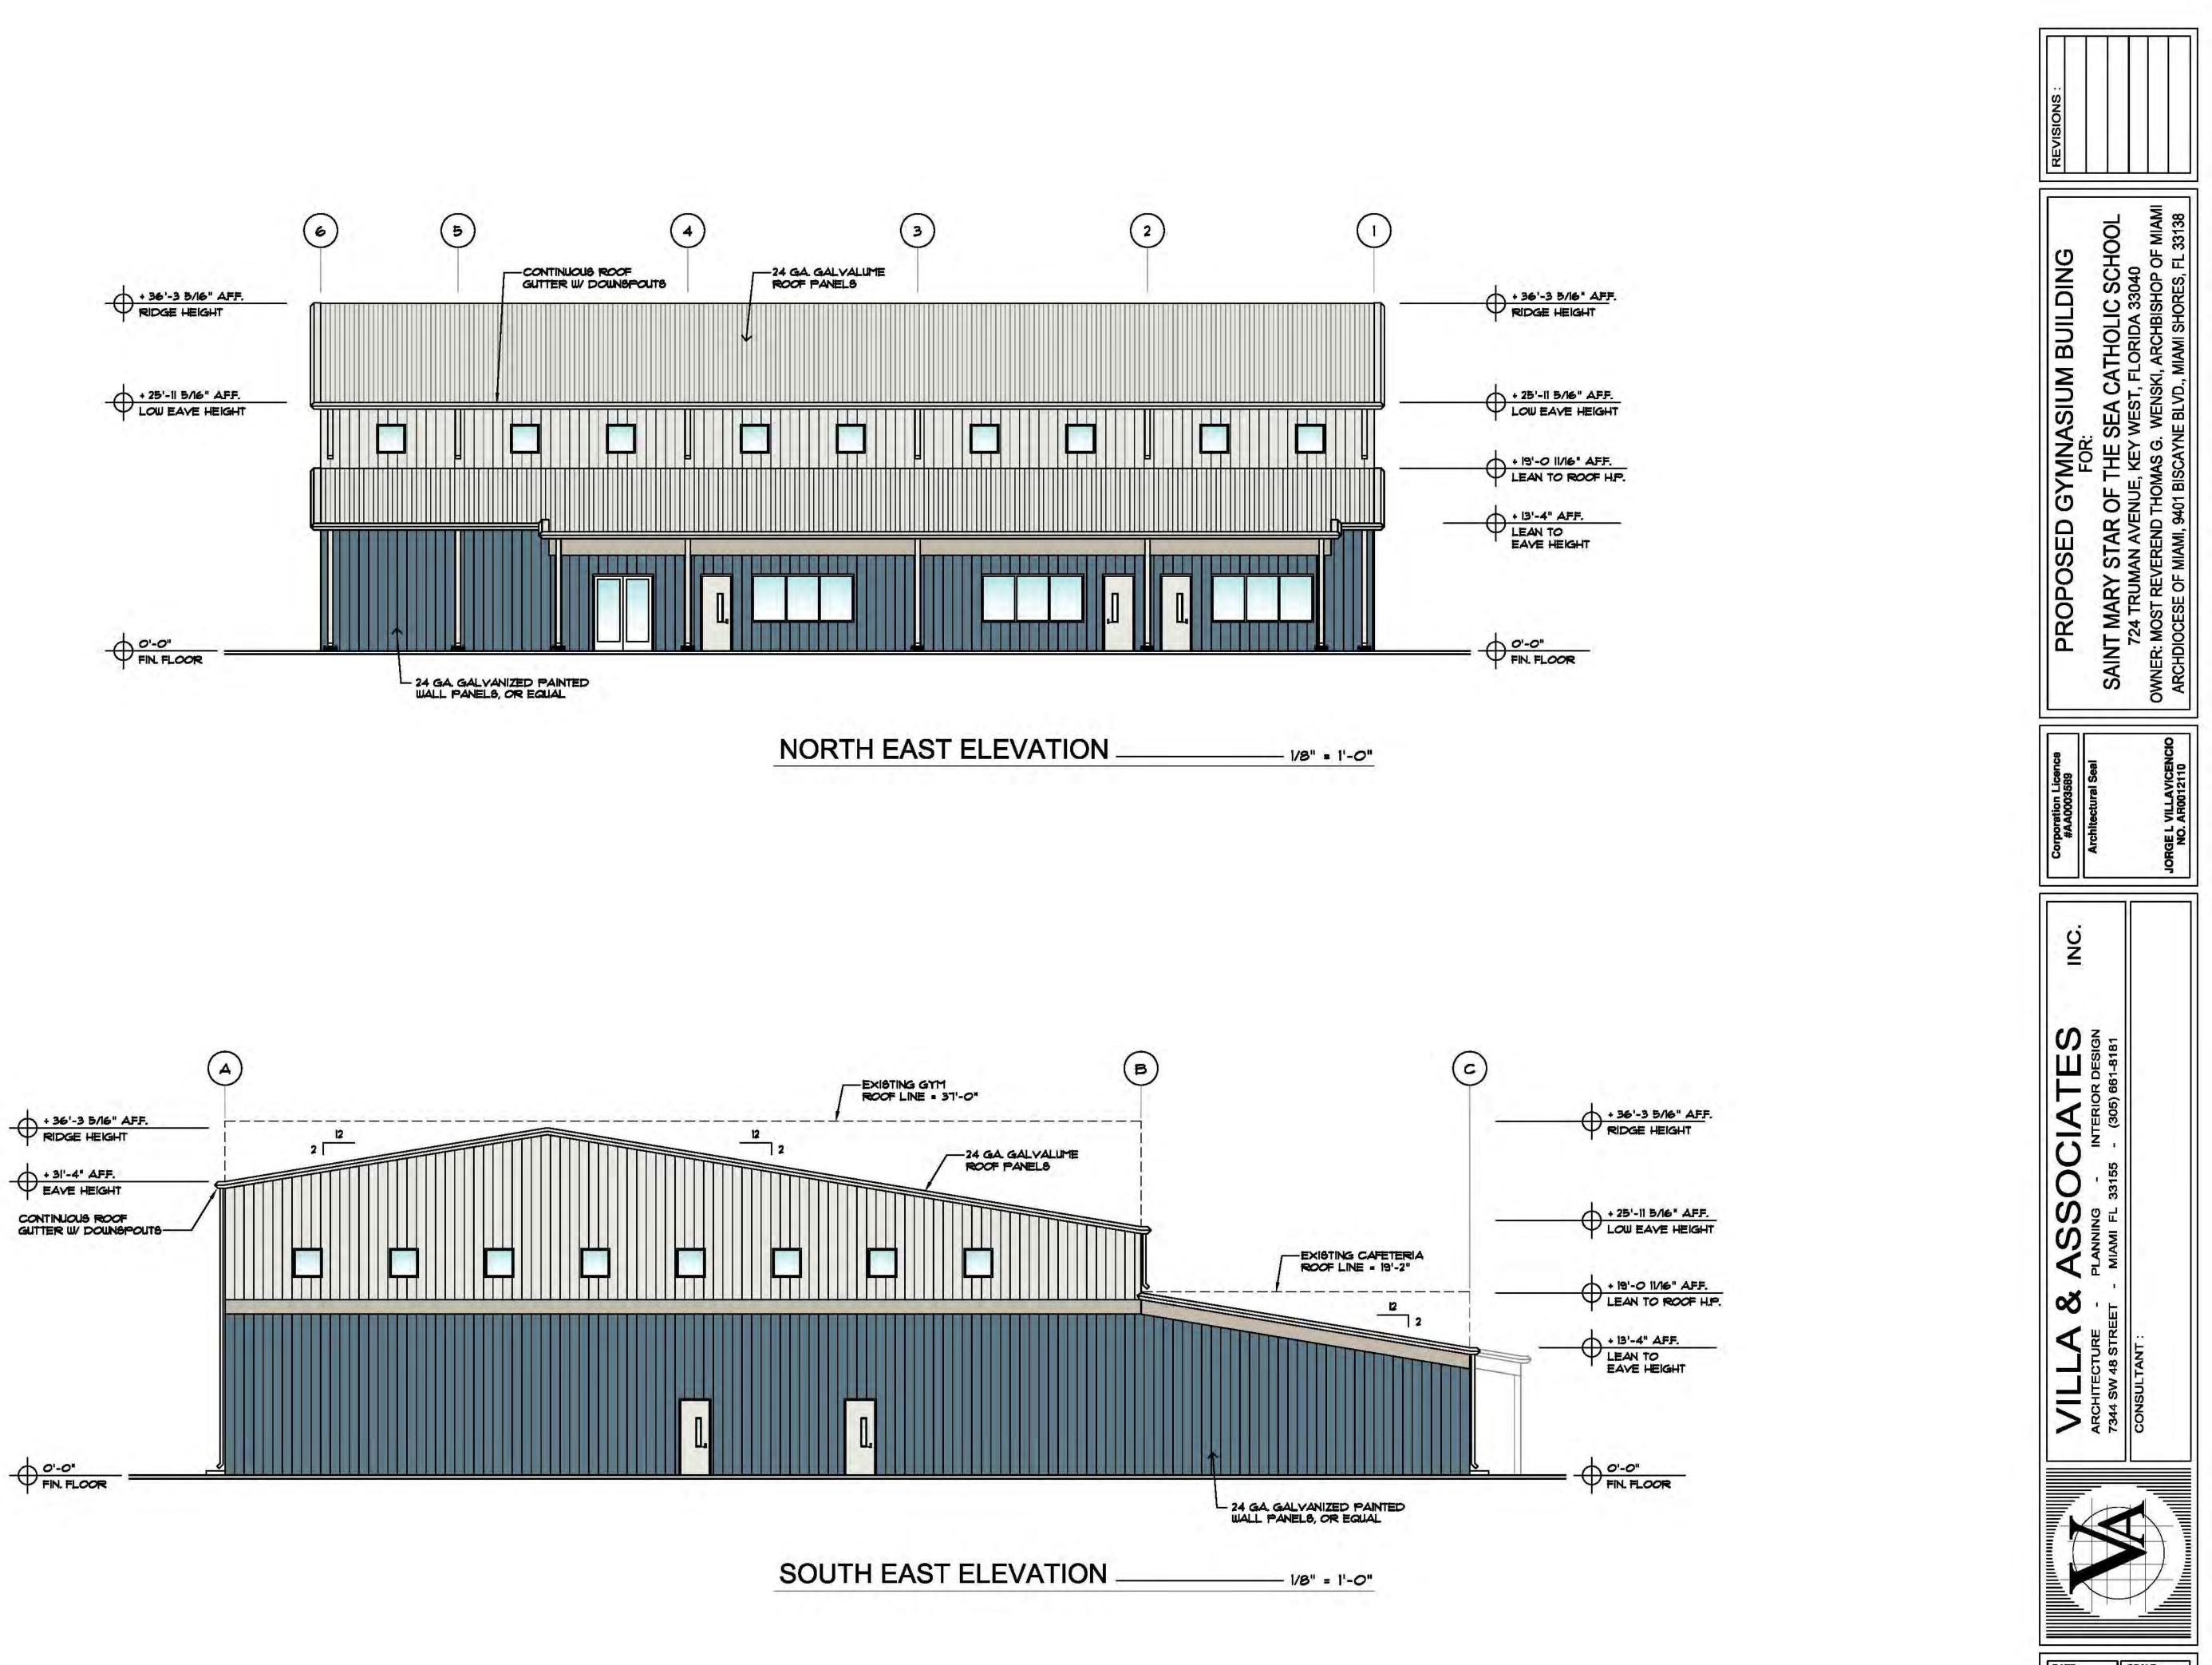


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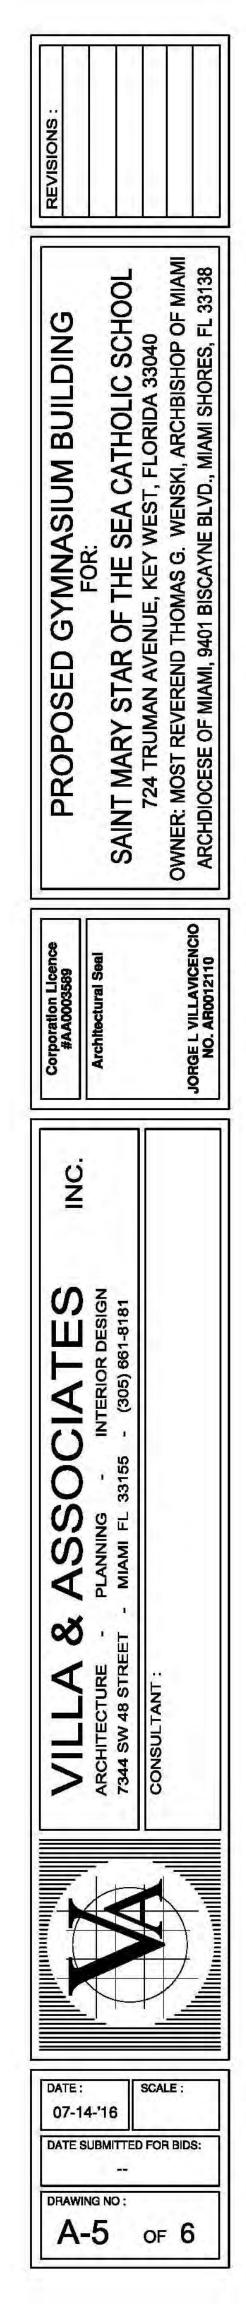
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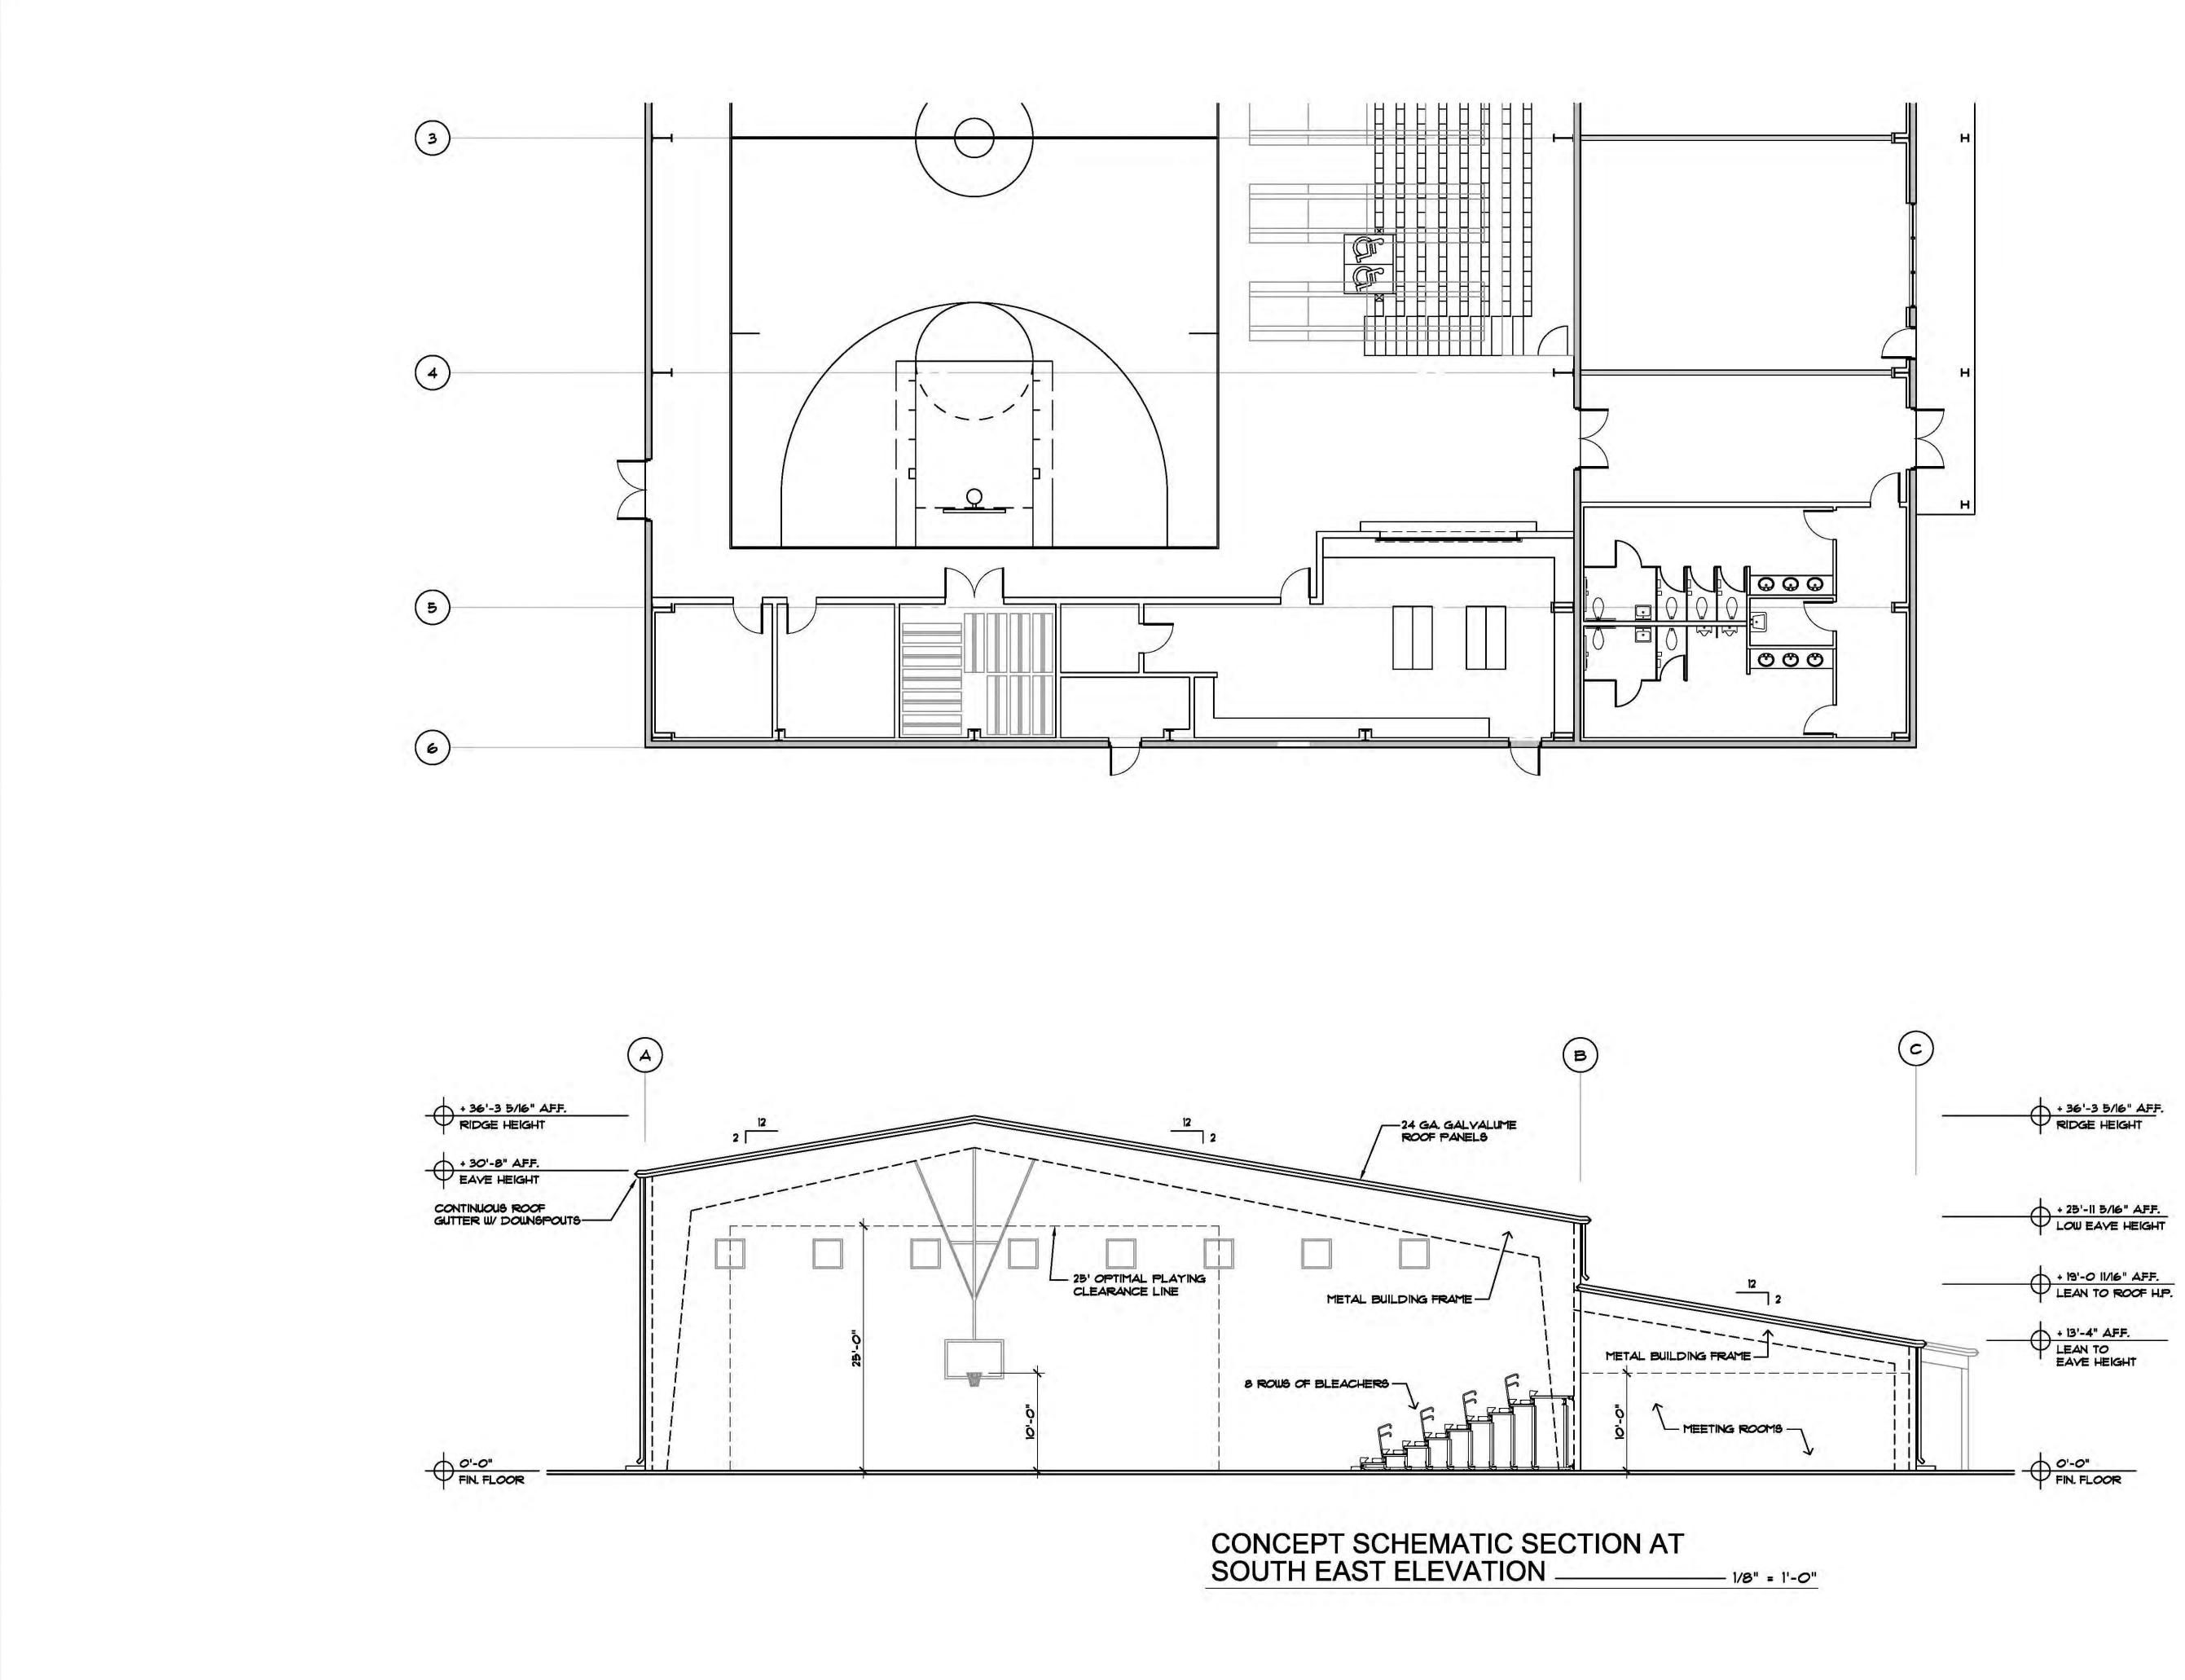
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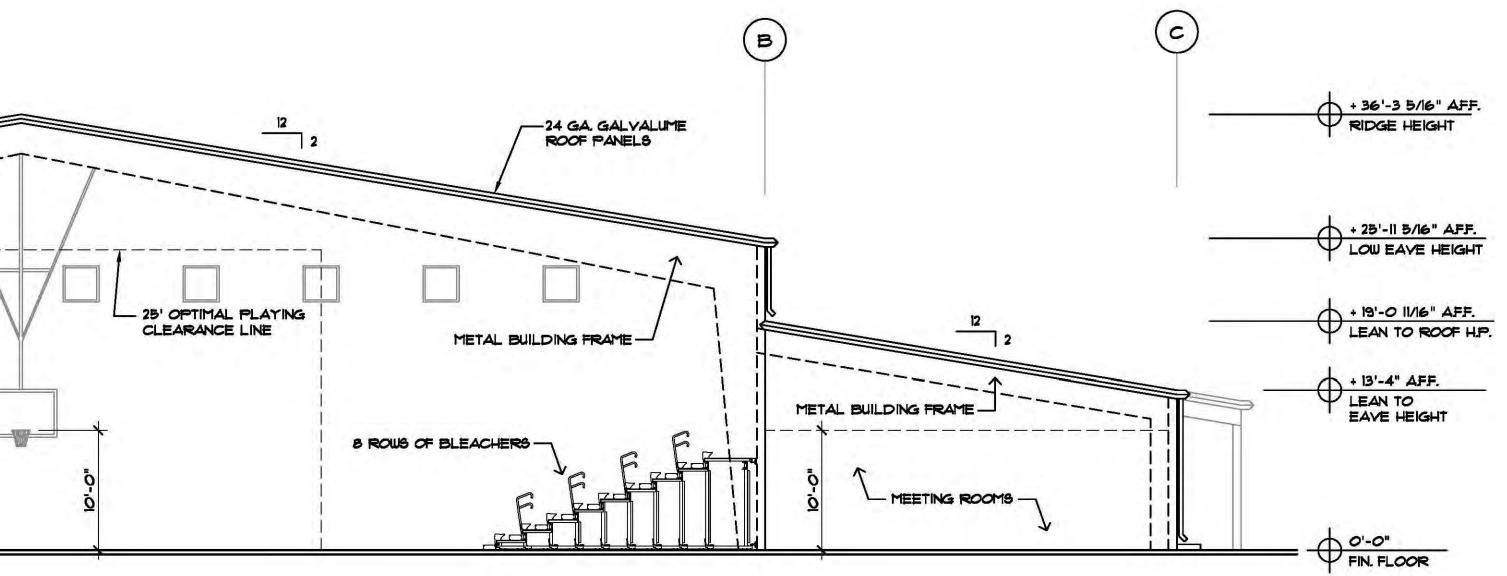
A-4 OF 6

1/8"







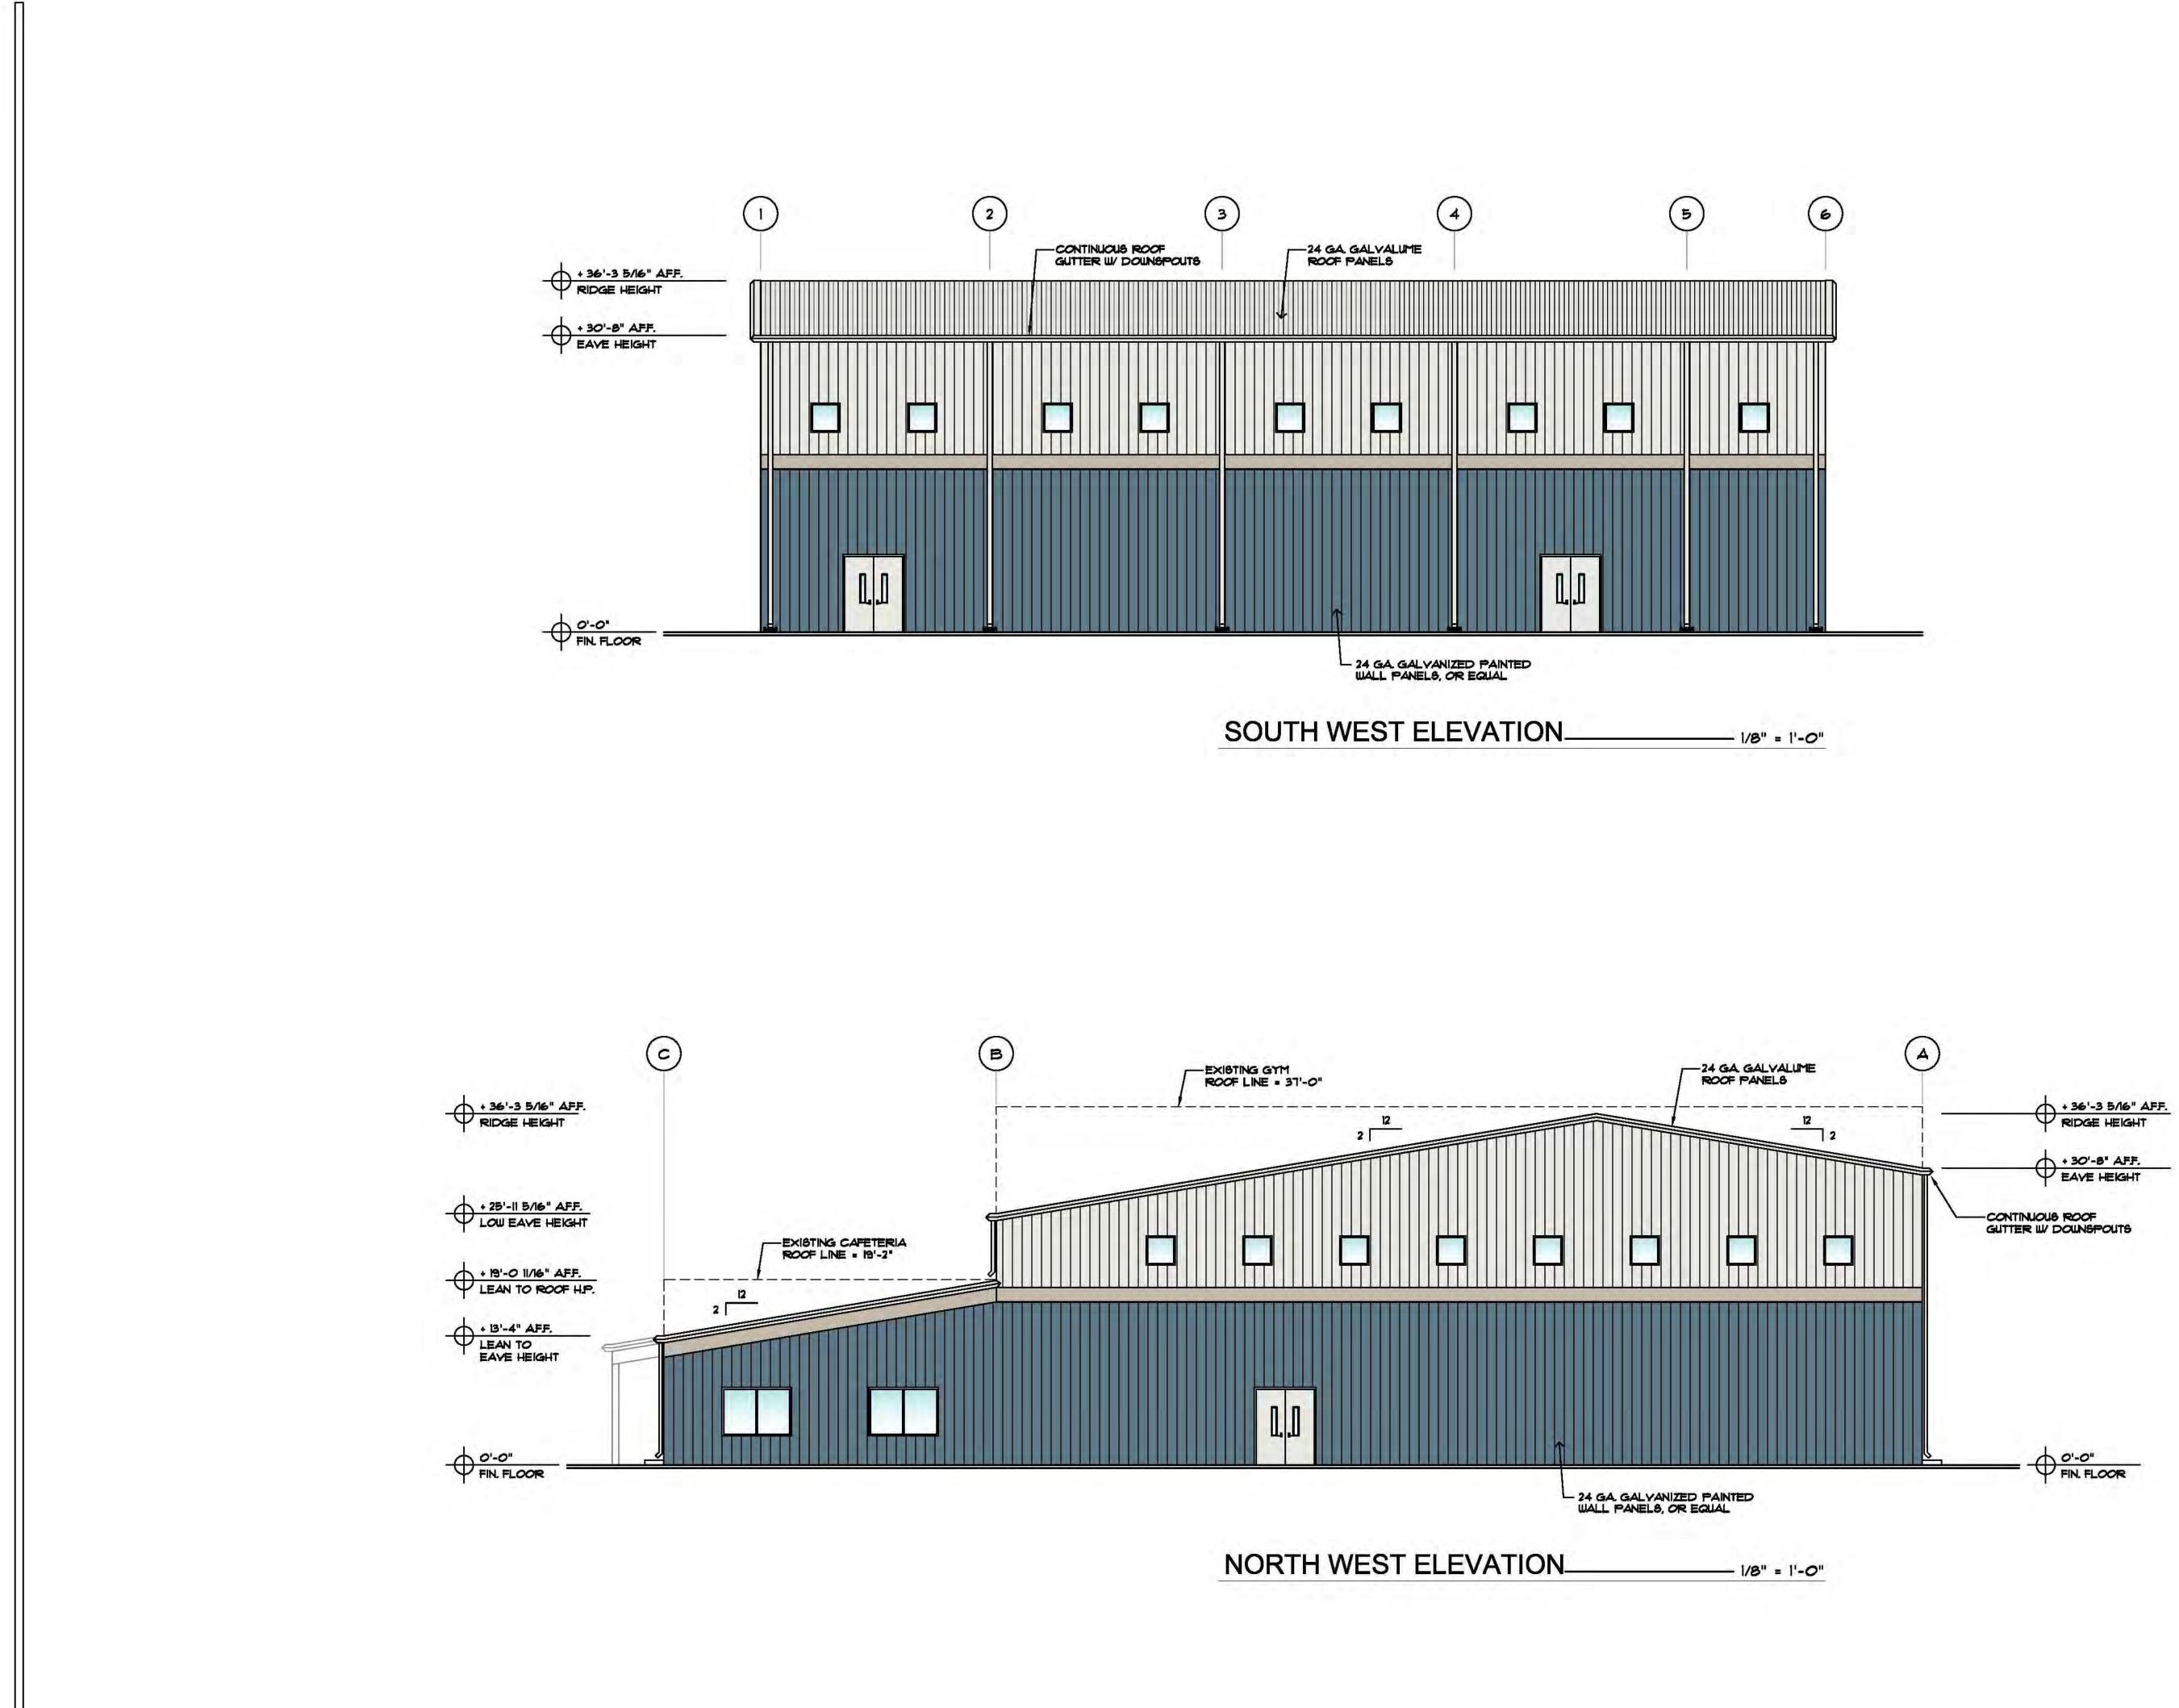

REVISIONS :				
PROPOSED GYMNASIUM BUILDING	SAINT MARY STAR OF THE SEA CATHOLIC SCHOOL	724 TRUMAN AVENUE, KEY WEST, FLORIDA 33040 OWNER: MOST REVEREND THOMAS G. WENSKI, ARCHBISHOP OF MIAMI ARCHDIOCESE OF MIAMI, 9401 BISCAYNE BLVD., MIAMI SHORES, FL 33138		
Corporation Licence #AA0003589	Architectural Seal	JORGE L VILLAVICENCIO NO. AR0012110		
INC.				
VILLA & ASSOCIATES ARCHITECTURE - PLANNING - INTERIOR DESIGN 7344 SW 48 STREET - MIAMI FL 33155 - (305) 661-8181 CONSULTANT :				
DATE : 07-14 DATE S	4-'16	scale : 1/8"		







OPTION 3 NORTH EAST ELEVATION

COLOR OPTIONS

Ranking	Roof	Top Section with Windows	Horizontal Band	Bottom Section with Doors
1	Snow White	Snow White	Almond	Harbor Blue
2	Snow White	Almond	Snow White	Slate Grey
3	Snow White	Snow White	Almond	Slate Grey









BUILDING ON CAROLINE STREET













Historic Seaport

Conch Republic Seafood Company

631 Greene Street Key West, FL 33040 305-294-4403

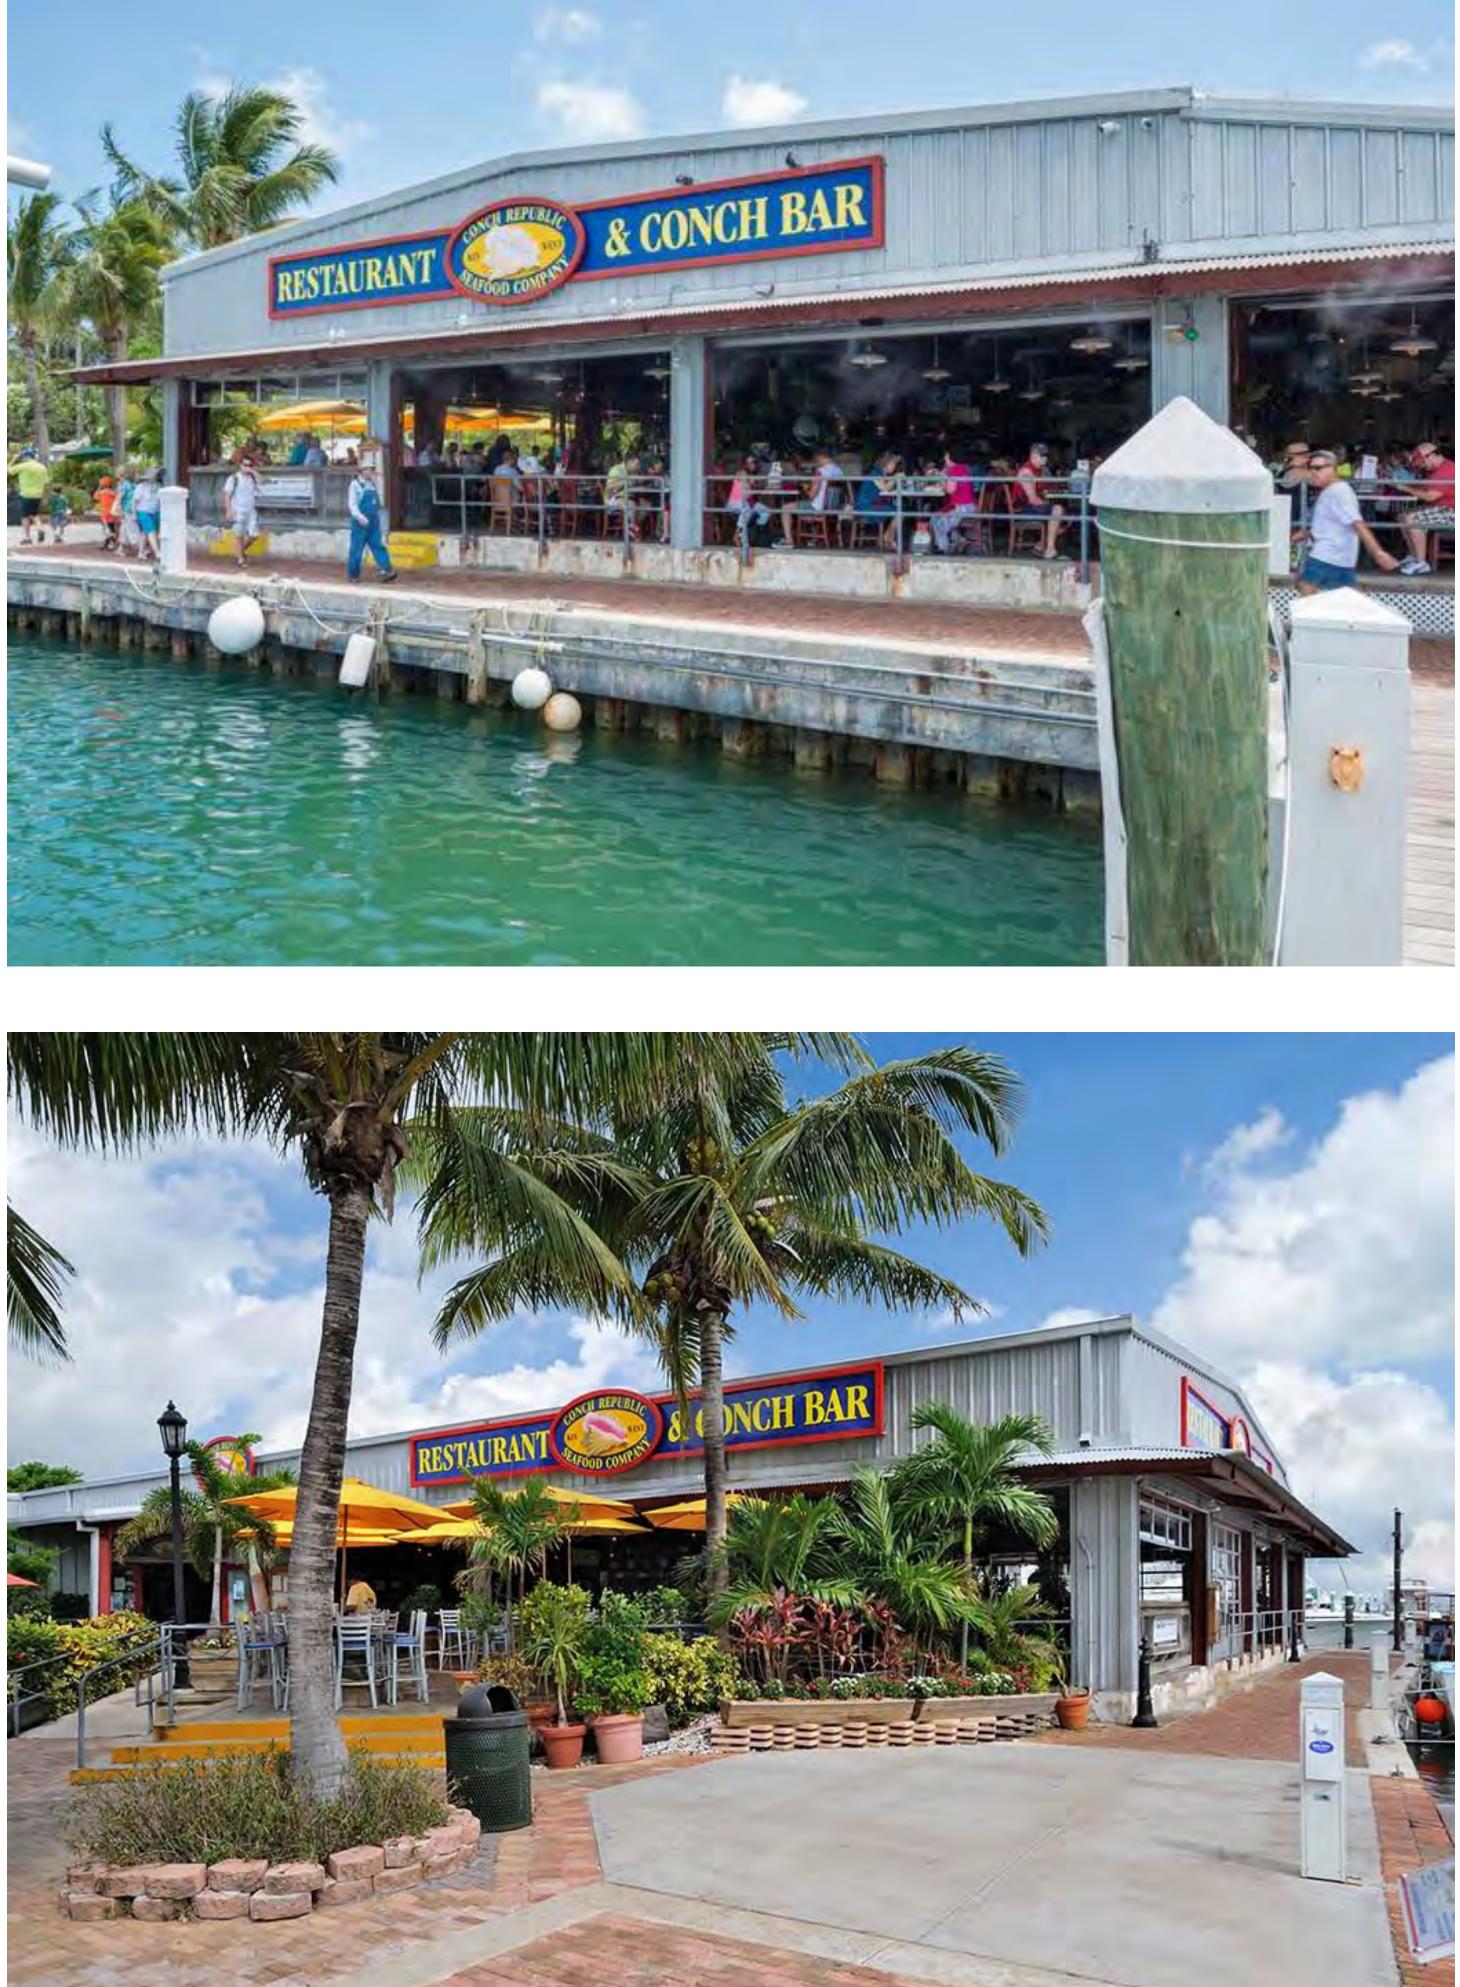

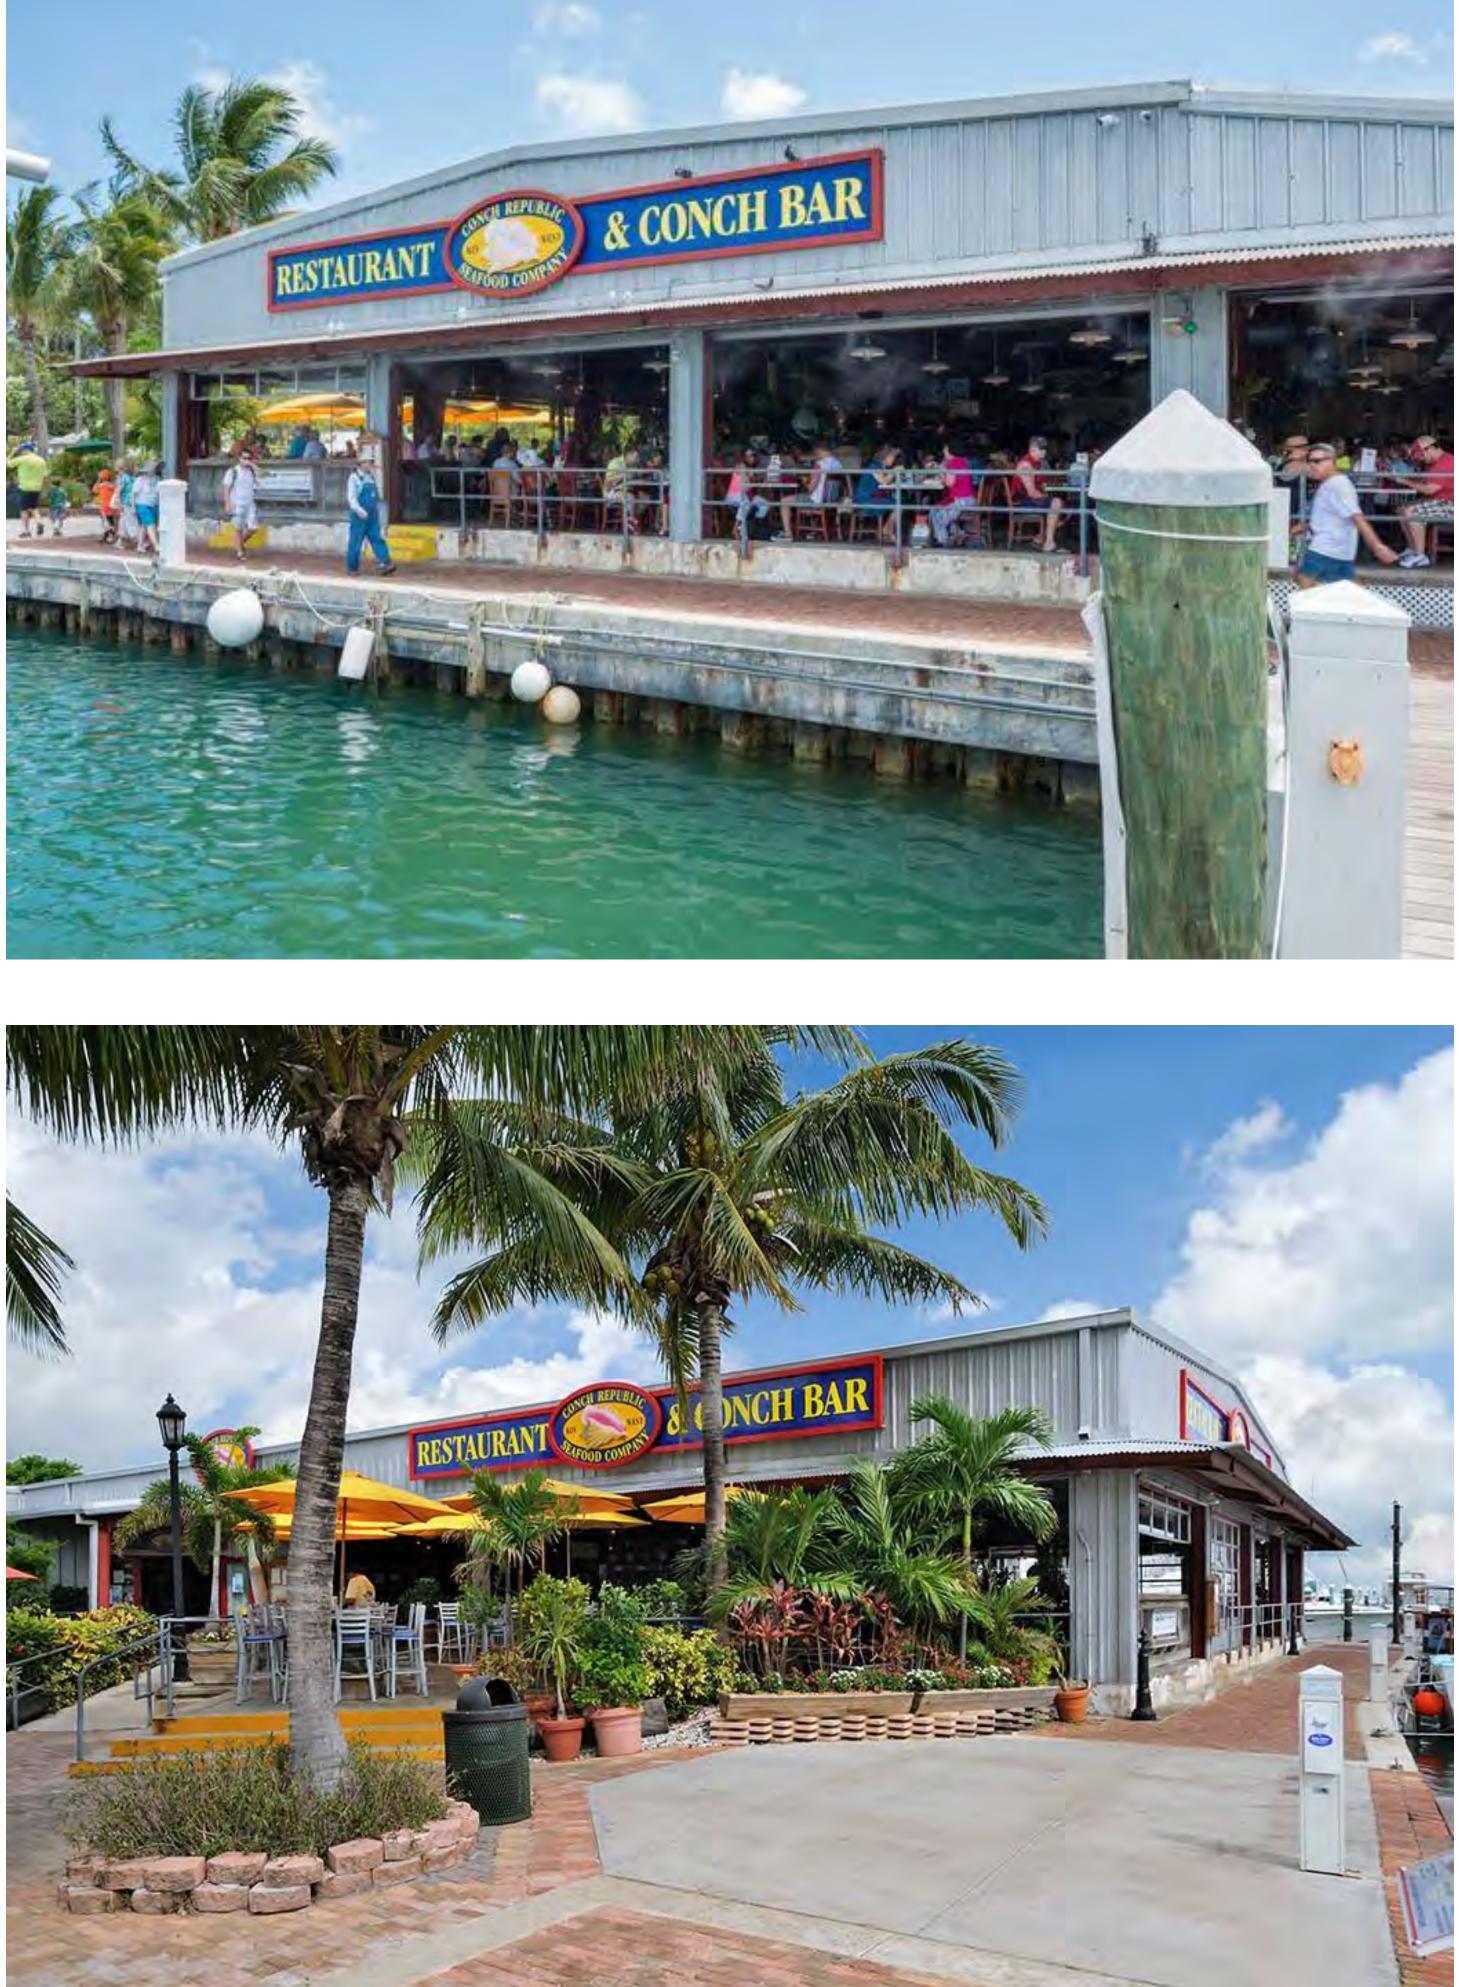



THE BASILICA SCHOOL of Saint Mary Star of the Sea Proposed Gymnasium Building



