



Historic Architectural Review Commission Staff Report for Item 7

To: Chairman Haven Burkee and Historic Architectural Review
Commission Members

From: Daniela Salume, MFA
Historic Architectural Preservationist

Meeting Date: May 27, 2025

Applicant: Sandbar Design Studio, Inc

Application Number: C2025-0036

Address: 1222 Seminary Street

Description of Work:

Demolition of historic one-story wood-frame residential structure, decks, walkways, and pool.

Site Facts:

The building under review is a historic and contributing structure to the historic district, built circa 1940. It is currently a multi-family home. However, staff has found evidence that the house was built prior to 1940 as it shows on the 1926 Sanborn Map but as a smaller structure. The site includes the main one-story frame structure, a covered wood deck at the rear, a pool with surrounding decking, and walkways. Currently the house sits on concrete footers and is located within an X flood zone.



Photo of property under review. Property Appraisers website 12/13/21.



Photo of property under review. Property Appraisers website 04/07/25.



1042765
4/7/2025

Photo of property under review. Property Appraisers website 04/07/25.




Photo of property under review.



Photo of property under review.



Photo of property under review. Florida Master Site File Nov 2004.

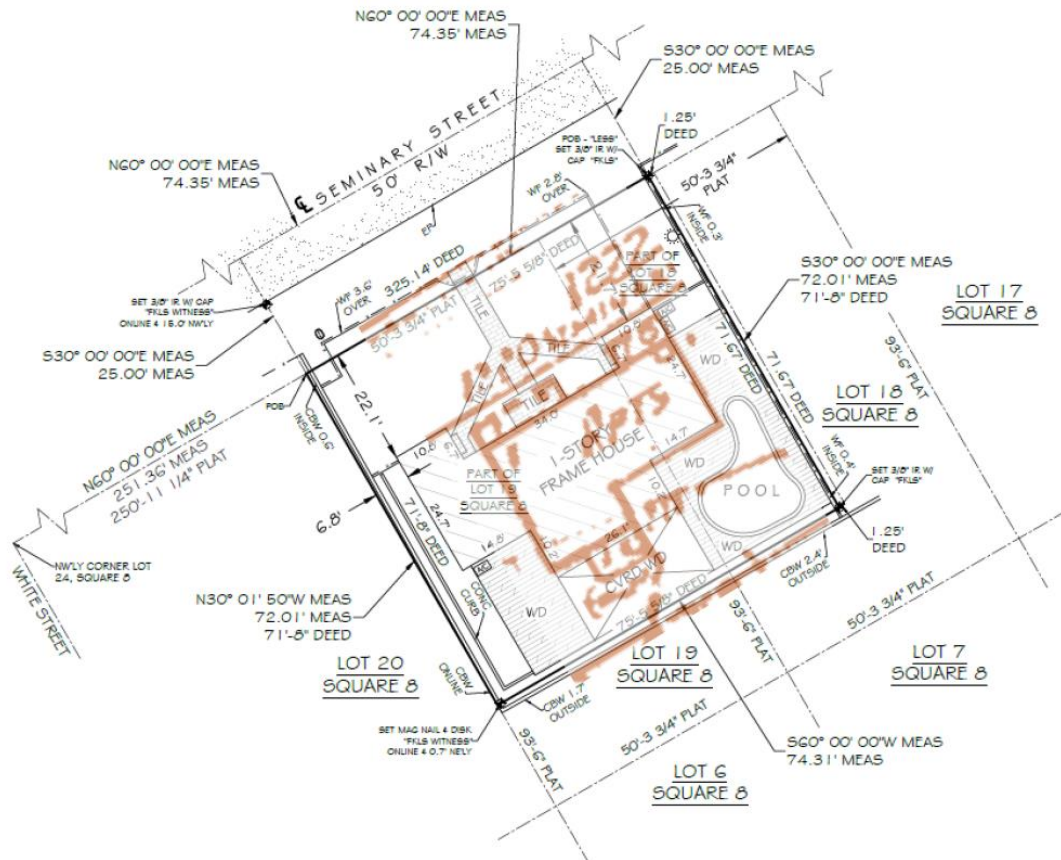


1962 Sanborn Map and current survey.

Ordinance Cited on Review:

- Section 102-217 (4), demolition for contributing and historic structures of the Land Development Regulations.
- Section 102-218 - Criteria for Demolition of the Land Development Regulations.

The Certificate of Appropriateness proposes the demolition of a one-story historic wood-frame house, along with the existing decks, walkways, and pool, as shown on the site plan. This will clear the property for new construction. Additionally, the structure has significant deterioration, including termite damage, rot, and a lack of a proper foundation.

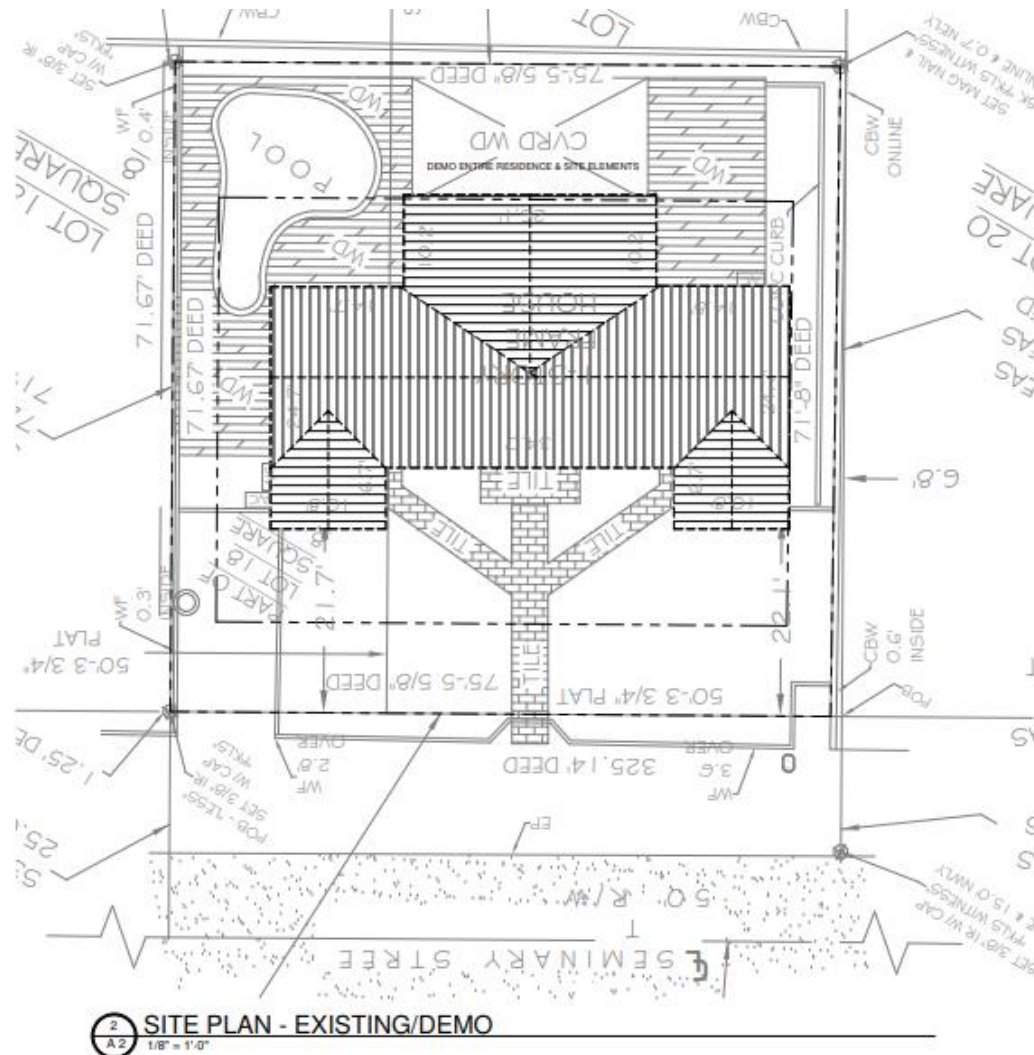

Existing Site Plan/Demo Plan.



Photo of house under review showing deterioration.

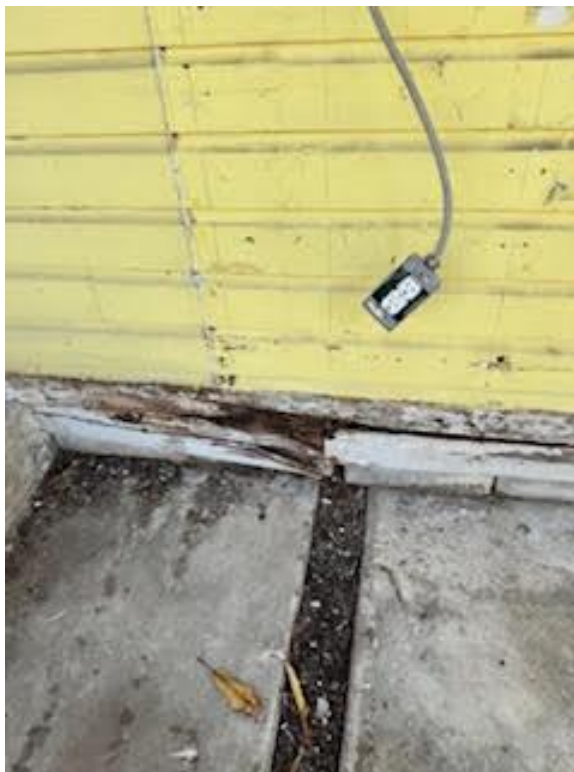


Photo of house under review showing deterioration.



Photo of house under review showing deterioration.



Photo of house under review showing deterioration.

It is staff's opinion that the request for this demolition shall be based on the demolition criteria of Chapter 102 Section 218 (a) of the LDR's. The criteria for demolition of historic structures state the following:

(a) The historic architectural review commission shall issue a certificate of appropriateness for an application for demolition:

- (1) If the subject of the application is a contributing or historic building or structure, then it should not be demolished unless its condition is irrevocably compromised by extreme deterioration, or it does not meet any of the criteria of section 102-125(1) through (9).*

Elements proposed for demolition are considered contributing, however, the structure has significant deterioration such as termite damage, rot and lack of a proper foundation.

The following is the criteria of section 102-125:

- 1 Embodies no distinctive characteristics of a type, period, or method of construction of aesthetic or historic significance in the city and is not a significant and distinguishable building entity whose components may lack individual distinction.*

Staff opines that the historic structure has no distinctive characteristics of a type, period or method of construction.

- 2 Is not specifically associated with events that have made a significant contribution to local, state, or national history.*

It is staff understanding that no significant events have ever happened on the site relevant to local, state, or national history.

- 3 Has no significant character, interest, or value as part of the development, heritage, or cultural characteristics of the city, state, or nation, and is not associated with the life of a person significant in the past.*

It is staff's understanding that the elements under review have no significant character and are not associated with the life of a significant person in the past.

- 4 Is not the site of a historic event with a significant effect upon society.*

It is staff's understanding that the site is not associated with any significant event.

- 5 *Does not exemplify the cultural, political, economic, social, or historic heritage of the city.*

It is staff's understanding that the elements under review do not exemplify the cultural, political, economic, social or historic heritage of the city.

- 6 *Does not portray the environment in an era of history characterized by a distinctive architectural style.*

Staff believes that the existing building does not portray an era of history characterized by a distinctive architectural style.

- 7 *If a part of or related to a square, park, or other distinctive area, nevertheless should not be developed, or preserved according to a plan based on the area's historic, cultural, natural, or architectural motif.*

This is not the case.

- 8 *Does not have a unique location or singular physical characteristic which represents an established and familiar visual feature of its neighborhood or of the city, and does not exemplify the best remaining architectural type in a neighborhood; and*

The elements under review do not have a unique location or physical characteristics which represent an established and familiar visual feature of its neighborhood or of the city.

- 9 *Has not yielded, and is not likely to yield, information important in history.*

Staff believes that the elements under review do not yield important information in history.

It is staff's opinion that the request for demolition may be considered, as the structures under review meet the criteria for demolition. The building shows significant deterioration, including termite damage, rot, and the lack of a proper foundation. If approved, the demolition will require two readings, as required for contributing structures within the historic district. Staff will review submitted construction plans for demolition and design to ensure consistency with submitted drawings.

APPLICATION

HARC MAJOR PROJECTS CERTIFICATE OF APPROPRIATENESS



City of Key West

1300 White Street
Key West, Florida 33040

| | | |
|------------|-----------------|----------------|
| HARC COA # | REVISION # | INITIAL & DATE |
| FLOOD ZONE | ZONING DISTRICT | BLDG PERMIT # |
| X-ZONW | HMDR | |

A PRE-APPLICATION MEETING WITH HARC STAFF IS REQUIRED PRIOR TO SUBMITTAL

| | | |
|------------------------------|--------------------------------|---------------------------------------|
| ADDRESS OF PROPOSED PROJECT: | 1222 Seminary Street | |
| NAME ON DEED: | FC Real Estate Investments LLC | PHONE NUMBER 843-290-8895 |
| OWNER'S MAILING ADDRESS: | 221 Simonton Street | EMAIL skyfly11@gmail.com |
| | Key West, FL 33040 | |
| APPLICANT NAME: | Sandbar Design Studio, Inc | PHONE NUMBER 847-903-5854 |
| APPLICANT'S ADDRESS: | 29183 Camellia Lane | EMAIL INFO@SANDBARDESIGNSTUDIO.COM |
| | Big Pine Key, FL 33043 | |
| APPLICANT'S SIGNATURE: | <i>Erica Poole</i> | DATE 04/22/2025 |

ANY PERSON THAT MAKES CHANGES TO AN APPROVED CERTIFICATE OF APPROPRIATENESS MUST SUBMIT A NEW APPLICATION.

FLORIDA STATUTE 837.06: WHOEVER KNOWINGLY MAKES A FALSE STATEMENT IN WRITING AND WITH THE INTENT TO MISLEAD A PUBLIC SERVANT IN THE PERFORMANCE OF HIS OR HER OFFICIAL DUTY SHALL BE GUILTY OF A MISDEMEANOR OF THE SECOND-DEGREE PUNISHABLE PER SECTION 775.082 OR 775.083. THE APPLICANT FURTHER HEREBY ACKNOWLEDGES THAT THE SCOPE OF WORK AS DESCRIBED IN THE APPLICATION SHALL BE THE SCOPE OF WORK THAT IS CONTEMPLATED BY THE APPLICANT AND THE CITY. THE APPLICANT FURTHER STIPULATES THAT SHOULD FURTHER ACTION BE TAKEN BY THE CITY FOR EXCEEDING THE SCOPE OF THE DESCRIPTION OF WORK, AS DESCRIBED HEREIN, AND IF THERE IS CONFLICTING INFORMATION BETWEEN THE DESCRIPTION OF WORK AND THE SUBMITTED PLANS, THE AFOREMENTIONED DESCRIPTION OF WORK SHALL BE CONTROLLING.

PROJECT INCLUDES: REPLACEMENT OF WINDOWS___ RELOCATION OF A STRUCTURE___ ELEVATION OF A STRUCTURE___
 PROJECT INVOLVES A CONTRIBUTING STRUCTURE: YES X NO___ INVOLVES A HISTORIC STRUCTURE: YES___ NO X
 PROJECT INVOLVES A STRUCTURE THAT IS INDIVIDUALLY LISTED ON THE NATIONAL REGISTER: YES___ NO X

| DETAILED PROJECT DESCRIPTION INCLUDING MATERIALS, HEIGHT, DIMENSIONS, SQUARE FOOTAGE, LOCATION, ETC. |
|---|
| GENERAL: |
| CONSTRUCTION OF A NEW SINGLE FAMILY RESIDENCE PER PLAN. HARDI SIDING, ALUMINUM IMPACT WINDOWS/DOORS, 5V CRIMP METAL ROOF. REFER TO PLANS FOR HEIGHT, DIMENSIONS, SQUARE FOOTAGES. |
| MAIN BUILDING: |
| |
| |
| |
| DEMOLITION (PLEASE FILL OUT AND ATTACH DEMOLITION APPENDIX): |
| DEMO OF THE EXISTING TRIPLEX. THERE IS AN ACTIVE EXPLORATORY DEMO PERMIT ON THE PROPERTY. FLOORS AND WALLS DETERIORATED. |
| |

APPLICATIONS MUST BE SUBMITTED IN PERSON WITH HARD COPIES BY 3PM ON THE SCHEDULED DEADLINE
PLEASE SEND AN ELECTRONIC COPY OF ALL DOCUMENTS CITY_HARC@CITYOFKEYWEST-FL.GOV

| | |
|---|---|
| ACCESSORY STRUCTURE(S): | |
| FUTURE POOL PER PLAN | |
| | |
| | |
| PAVERS: | FENCES: |
| FRONT BRICK PAVER PATH PER PLAN DRIVEWAY TO BE PEAROCK | REPLACE EXISTING FRONT PICKET FENCE TO MATCH EXISTING |
| DECKS: | PAINTING: |
| PT WOOD FRAME FRONT PORCH & FUTURE PT WOOD POOL DECK | PAINT COLOR TBD, WITH HARC APPROVAL, DURING CONSTRUCTION |
| SITE (INCLUDING GRADING, FILL, TREES, ETC): | POOLS (INCLUDING EQUIPMENT): |
| | FUTURE POOL PER PLAN, IN REAR YARD |
| | |
| ACCESSORY EQUIPMENT (GAS, A/C, VENTS, ETC): | OTHER: |
| AC UNITS, CONCEALED ON SIDE OF HOUSE | |
| POOL EQUIPMENT, CONCEALED ON SIDE OF HOUSE | |

| OFFICIAL USE ONLY: | HARC COMMISSION REVIEW | EXPIRES ON: |
|--------------------------------|--|-------------|
| MEETING DATE: | <input type="checkbox"/> APPROVED <input type="checkbox"/> NOT APPROVED <input type="checkbox"/> DEFERRED FOR FUTURE CONSIDERATION | INITIAL: |
| MEETING DATE: | <input type="checkbox"/> APPROVED <input type="checkbox"/> NOT APPROVED <input type="checkbox"/> DEFERRED FOR FUTURE CONSIDERATION | INITIAL: |
| MEETING DATE: | <input type="checkbox"/> APPROVED <input type="checkbox"/> NOT APPROVED <input type="checkbox"/> DEFERRED FOR FUTURE CONSIDERATION | INITIAL: |
| REASONS OR CONDITIONS: | | |
| | | |
| | | |
| STAFF REVIEW COMMENTS: | | |
| | | |
| | | |
| FIRST READING FOR DEMO: | SECOND READING FOR DEMO: | |
| HARC STAFF SIGNATURE AND DATE: | HARC CHAIRPERSON SIGNATURE AND DATE: | |

THIS APPLICATION MAY BE REVIEWED BY PLANNING DEPARTMENT STAFF.

HARC CERTIFICATE OF APPROPRIATENESS: DEMOLITION APPENDIX




City of Key West

1300 White Street
Key West, Florida 33040

| | |
|-----------------|----------------|
| HARC COA # | INITIAL & DATE |
| ZONING DISTRICT | BLDG PERMIT # |

| | |
|------------------------------|--------------------------------|
| ADDRESS OF PROPOSED PROJECT: | 1222 Seminary Street |
| PROPERTY OWNER'S NAME: | FC Real Estate Investments LLC |
| APPLICANT NAME: | Sandbar Design Studio, Inc |

I hereby certify I am the owner of record and that the work shall conform to all applicable laws of this jurisdiction. By receiving a Certificate of Appropriateness, I realize that this project will require a Building Permit approval **PRIOR** to proceeding with the work outlined above and that a final inspection is required under this application. I also understand that **any changes to an approved Certificate of Appropriateness must be submitted for review.**
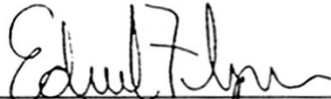
| | | | |
|----------------------------|---|----------------------|---------------------|
| PROPERTY OWNER'S SIGNATURE |  | Edward Flynn 4/21/25 | DATE AND PRINT NAME |
|----------------------------|---|----------------------|---------------------|

DETAILED PROJECT DESCRIPTION OF DEMOLITION

DEMO OF EXISTING TRIPLEX. EXPLORATORY DEMO PERMIT ON FILE. SEE PHOTOS FOR DEGREE OF TERMITE/ROT DECAY, AND LACK OF FOUNDATION. DEMO WILL BE TO A CLEAR SITE.

CRITERIA FOR DEMOLITION OF CONTRIBUTING OR HISTORIC STRUCTURES:

Before any Certificate of Appropriateness may be issued for a demolition request, the Historic Architectural Review Commission must find that the following requirements are met (please review and comment on each criterion that applies):

(1) If the subject of the application is a contributing or historic building or structure, then it should not be demolished unless its condition is irrevocably compromised by extreme deterioration or it does not meet any of the following criteria:

(a) The existing condition of the building or structure is irrevocably compromised by extreme deterioration.

THE CONDITION OF THE STRUCTURE IS COMPROMISED DUE TO TERMITE DAMAGE AND ROT. PLEASE SEE PHOTOS FILE.

(2) Or explain how the building or structure meets the criteria below:

(a) Embodies no distinctive characteristics of a type, period, or method of construction of aesthetic or historic significance in the city and is not a significant and distinguishable building entity whose components may lack individual distinction.

THE EXISTING STRUCTURE IS NOT ARCHITECTURALLY HISTORICALLY SIGNIFICANT.

Nothing in this application is intended to alter the authority of the Building Official to condemn for demolition dangerous buildings, as provided in Section 102-218 of the Land Development Regulations and Chapter 14 of the Code of Ordinances.

(b) Is not specifically associated with events that have made a significant contribution to local, state, or national history.

THE RESIDENCE HAS NOT BEEN ASSOCIATED WITH SIGNIFICANT EVENTS.

(c) Has no significant character, interest, or value as part of the development, heritage, or cultural characteristics of the city, state or nation, and is not associated with the life of a person significant in the past.

THE RESIDENCE DOES NOT HOLD SIGNIFICANT CHARACTER, AND IS NOT ASSOCIATED WITH THE LIFE OF A SIGNIFICANT HISTORICAL FIGURE.

(d) Is not the site of a historic event with significant effect upon society.

THE SITE HAS NO HISTORIC EVENTS ASSOCIATED WITH IT.

(e) Does not exemplify the cultural, political, economic, social, or historic heritage of the city.

THE RESIDENCE DOES NOT EXEMPLIFY THE CULTURAL, POLITICAL, ECONOMIC, SOCIAL, OR HISTORIC HERITAGE OF THE CITY.

(f) Does not portray the environment in an era of history characterized by a distinctive architectural style.

THE RESIDENCE DOES NOT PORTRAY THE ENVIRONMENT IN AN ERA OF HISTORY CHARACTERIZED BY A DISTINCTIVE ARCHITECTURAL STYLE. THE HOME HAS CHANGED CONFIGURATION OVER THE YEARS.

(g) If a part of or related to a square, park, or other distinctive area, nevertheless should not be developed or preserved according to a plan based on the area's historic, cultural, natural, or architectural motif.

THE SITE IS NOT RELATED TO A PARK/SQUARE OR SIGNIFICANT AREA

(h) Does not have a unique location or singular physical characteristic which represents an established and familiar visual feature of its neighborhood or of the city, and does not exemplify the best remaining architectural type in a neighborhood.

THE RESIDENCE AND SITE DO NOT CONTAIN UNIQUE/SINGULAR CHARACTERISTICS.

Nothing in this application is intended to alter the authority of the Building Official to condemn for demolition dangerous buildings, as provided in Section 102-218 of the Land Development Regulations and Chapter 14 of the Code of Ordinances.

(i) Has not yielded, and is not likely to yield, information important in history,

THE RESIDENCE AND SITE HAVE NOT YIELDED AND ARE NOT LIKELY TO YIELD INFORMATION IMPORTANT TO HISTORY.

CRITERIA FOR DEMOLITION OF NON-CONTRIBUTING OR NON-HISTORIC STRUCTURES:

The following criteria will also be reviewed by the Historic Architectural Review Commission for proposed demolitions. The Commission shall not issue a Certificate of Appropriateness that would result in the following conditions (please review and comment on each criterion that applies):

(1) Removing buildings or structure that are important in defining the overall historic character of a district or neighborhood so that the character is diminished.

(2) Removing historic buildings or structures and thus destroying the historic relationship between buildings or structures and open space.

(3) Removing an historic building or structure in a complex; or removing a building façade; or removing a significant later addition that is important in defining the historic character of a site or the surrounding district or neighborhood.

(4) Removing buildings or structures that would otherwise qualify as contributing.

U.S. DEPARTMENT OF HOMELAND SECURITY
Federal Emergency Management Agency
National Flood Insurance Program

OMB Control No. 1660-0008
Expiration Date: 06/30/2026

ELEVATION CERTIFICATE

IMPORTANT: MUST FOLLOW THE INSTRUCTIONS ON INSTRUCTION PAGES 1-11

Copy all pages of this Elevation Certificate and all attachments for (1) community official, (2) insurance agent/company, and (3) building

| SECTION A – PROPERTY INFORMATION | | FOR INSURANCE COMPANY USE |
|---|----------------------|---|
| A1. Building Owner's Name: <u>FC REAL ESTATE INVESTMENTS LLC</u> | | Policy Number: _____ |
| A2. Building Street Address (including Apt., Unit, Suite, and/or Bldg. No.) or P.O. Route and Box No.: <u>1222 SEMINARY STREET</u> | | Company NAIC Number: _____ |
| City: <u>KEY WEST</u> State: <u>FL</u> ZIP Code: <u>33040</u> | | |
| A3. Property Description (e.g., Lot and Block Numbers or Legal Description) and/or Tax Parcel Number: <u>MONROE COUNTY PROPERTY APPRAISER PARCEL ID: 000042120-000000</u> | | |
| A4. Building Use (e.g., Residential, Non-Residential, Addition, Accessory, etc.): <u>RESIDENTAL</u> | | |
| A5. Latitude/Longitude: Lat. <u>24°33'11.20"</u> Long. <u>-081°47'15.90"</u> Horiz. Datum: <input type="checkbox"/> NAD 1927 <input type="checkbox"/> NAD 1983 <input checked="" type="checkbox"/> WGS 84 | | |
| A6. Attach at least two and when possible four clear color photographs (one for each side) of the building (see Form pages 7 and 8). | | |
| A7. Building Diagram Number: <u>1B</u> | | |
| A8. For a building with a crawlspace or enclosure(s): | | |
| a) Square footage of crawlspace or enclosure(s): <u>N/A</u> sq. ft. | | |
| b) Is there at least one permanent flood opening on two different sides of each enclosed area? <input type="checkbox"/> Yes <input type="checkbox"/> No <input checked="" type="checkbox"/> N/A | | |
| c) Enter number of permanent flood openings in the crawlspace or enclosure(s) within 1.0 foot above adjacent grade: Non-engineered flood openings: <u>N/A</u> Engineered flood openings: <u>N/A</u> | | |
| d) Total net open area of non-engineered flood openings in A8.c: <u>N/A</u> sq. in. | | |
| e) Total rated area of engineered flood openings in A8.c (attach documentation – see Instructions): <u>N/A</u> sq. ft. | | |
| f) Sum of A8.d and A8.e rated area (if applicable – see Instructions): <u>N/A</u> sq. ft. | | |
| A9. For a building with an attached garage: | | |
| a) Square footage of attached garage: <u>N/A</u> sq. ft. | | |
| b) Is there at least one permanent flood opening on two different sides of the attached garage? <input type="checkbox"/> Yes <input type="checkbox"/> No <input checked="" type="checkbox"/> N/A | | |
| c) Enter number of permanent flood openings in the attached garage within 1.0 foot above adjacent grade: Non-engineered flood openings: <u>N/A</u> Engineered flood openings: <u>N/A</u> | | |
| d) Total net open area of non-engineered flood openings in A9.c: <u>N/A</u> sq. in. | | |
| e) Total rated area of engineered flood openings in A9.c (attach documentation – see Instructions): <u>N/A</u> sq. ft. | | |
| f) Sum of A9.d and A9.e rated area (if applicable – see Instructions): <u>N/A</u> sq. ft. | | |
| SECTION B – FLOOD INSURANCE RATE MAP (FIRM) INFORMATION | | |
| B1.a. NFIP Community Name: <u>CITY OF KEY WEST</u> | | B1.b. NFIP Community Identification Number: <u>120168</u> |
| B2. County Name: <u>MONROE</u> | B3. State: <u>FL</u> | B4. Map/Panel No.: <u>12087C1516</u> |
| B5. Suffix: <u>K</u> | | |
| B6. FIRM Index Date: <u>02/18/2005</u> | | B7. FIRM Panel Effective/Revised Date: <u>02/18/2005</u> |
| B8. Flood Zone(s): <u>X-SHADED</u> | | B9. Base Flood Elevation(s) (BFE) (Zone AO, use Base Flood Depth): <u>N/A</u> |
| B10. Indicate the source of the BFE data or Base Flood Depth entered in Item B9: <input type="checkbox"/> FIS <input checked="" type="checkbox"/> FIRM <input type="checkbox"/> Community Determined <input type="checkbox"/> Other: _____ | | |
| B11. Indicate elevation datum used for BFE in Item B9: <input checked="" type="checkbox"/> NGVD 1929 <input type="checkbox"/> NAVD 1988 <input type="checkbox"/> Other/Source: _____ | | |
| B12. Is the building located in a Coastal Barrier Resources System (CBRS) area or Otherwise Protected Area (OPA)? <input type="checkbox"/> Yes <input checked="" type="checkbox"/> No Designation Date: _____ <input type="checkbox"/> CBRS <input type="checkbox"/> OPA | | |
| B13. Is the building located seaward of the Limit of Moderate Wave Action (LiMWA)? <input type="checkbox"/> Yes <input checked="" type="checkbox"/> No | | |

ELEVATION CERTIFICATE

IMPORTANT: MUST FOLLOW THE INSTRUCTIONS ON INSTRUCTION PAGES 1-11

Building Street Address (including Apt., Unit, Suite, and/or Bldg. No.) or P.O. Route and Box No.:

1222 SEMINARY STREET

City: KEY WEST

State: FL

ZIP Code: 33040

FOR INSURANCE COMPANY USE

Policy Number: _____

Company NAIC Number: _____

SECTION C – BUILDING ELEVATION INFORMATION (SURVEY REQUIRED)

C1. Building elevations are based on: ☐ Construction Drawings* ☐ Building Under Construction* ☒ Finished Construction

*A new Elevation Certificate will be required when construction of the building is complete.

C2. Elevations – Zones A1–A30, AE, AH, AO, A (with BFE), VE, V1–V30, V (with BFE), AR, AR/A, AR/AE, AR/A1–A30, AR/AH, AR/AO, A99. Complete Items C2.a–h below according to the Building Diagram specified in Item A7. In Puerto Rico only, enter meters.

Benchmark Utilized: AA1653

Vertical Datum: NGVD29

Indicate elevation datum used for the elevations in items a) through h) below.

☒ NGVD 1929 ☐ NAVD 1988 ☐ Other: _____

Datum used for building elevations must be the same as that used for the BFE. Conversion factor used?

☒ Yes ☐ No

If Yes, describe the source of the conversion factor in the Section D Comments area.

Check the measurement used:

a) Top of bottom floor (including basement, crawlspace, or enclosure floor):

7.8

☒ feet ☐ meters

b) Top of the next higher floor (see Instructions):

N/A

☐ feet ☐ meters

c) Bottom of the lowest horizontal structural member (see Instructions):

N/A

☐ feet ☐ meters

d) Attached garage (top of slab):

N/A

☐ feet ☐ meters

e) Lowest elevation of Machinery and Equipment (M&E) servicing the building (describe type of M&E and location in Section D Comments area):

7.5

☒ feet ☐ meters

f) Lowest Adjacent Grade (LAG) next to building: ☒ Natural ☐ Finished

6.8

☒ feet ☐ meters

g) Highest Adjacent Grade (HAG) next to building: ☒ Natural ☐ Finished

7.1

☒ feet ☐ meters

h) Finished LAG at lowest elevation of attached deck or stairs, including structural support:

6.8

☒ feet ☐ meters

SECTION D – SURVEYOR, ENGINEER, OR ARCHITECT CERTIFICATION

This certification is to be signed and sealed by a land surveyor, engineer, or architect authorized by state law to certify elevation information. I certify that the information on this Certificate represents my best efforts to interpret the data available. I understand that any false statement may be punishable by fine or imprisonment under 18 U.S. Code, Section 1001.

Were latitude and longitude in Section A provided by a licensed land surveyor? ☒ Yes ☐ No

☐ Check here if attachments and describe in the Comments area.

Certifier's Name: ERIC ISAACS

License Number: PSM 6783

Title: SURVEYOR AND MAPPER

Company Name: FLORIDA KEYS LAND SURVEYING

Address: 21460 OVERSEAS HWY, SUITE 4

City: CUDJOE KEY

State: FL

ZIP Code: 33042


Telephone: (305) 394-3690

Ext.: _____

Email: FKLSEMAIL@GMAIL.COM

Signature: _____

Date: 12/20/2024

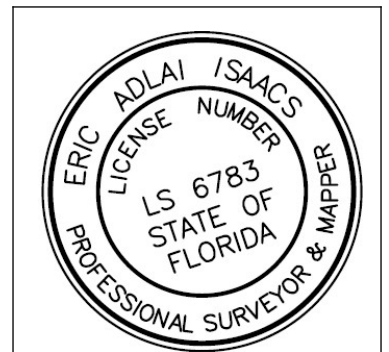

Copy all pages of this Elevation Certificate and all attachments for (1) community official, (2) insurance agent/company, and (3) building

Comments (including source of conversion factor in C2; type of equipment and location per C2.e; and description of any attachments):
THE BUILDING=A 1 STORY HOUSE ON A RAISED CONCRETE SLAB FOUNDATION. C2e=THE ELEVATION OF THE BOTTOM OF AN A/C COMPRESSOR. THE LATITUDE AND LONGITUDE WERE DETERMINED BY USING GOOGLE EARTH.

ELEVATION CERTIFICATE

IMPORTANT: MUST FOLLOW THE INSTRUCTIONS ON INSTRUCTION PAGES 1-11

Building Street Address (including Apt., Unit, Suite, and/or Bldg. No.) or P.O. Route and Box No.:

1222 SEMINARY STREET

City: KEY WEST

State: FL

ZIP Code: 33040

FOR INSURANCE COMPANY USE

Policy Number: _____

Company NAIC Number: _____

SECTION E – BUILDING MEASUREMENT INFORMATION (SURVEY NOT REQUIRED) FOR ZONE AO, ZONE AR/AO, AND ZONE A (WITHOUT BFE)

For Zones AO, AR/AO, and A (without BFE), complete Items E1–E5. For Items E1–E4, use natural grade, if available. If the Certificate is intended to support a Letter of Map Change request, complete Sections A, B, and C. Check the measurement used. In Puerto Rico only, enter meters.

Building measurements are based on: ☐ Construction Drawings* ☐ Building Under Construction* ☐ Finished Construction

*A new Elevation Certificate will be required when construction of the building is complete.

E1. Provide measurements (C.2.a in applicable Building Diagram) for the following and check the appropriate boxes to show whether the measurement is above or below the natural HAG and the LAG.

a) Top of bottom floor (including basement, crawlspace, or enclosure) is: _____ ☐ feet ☐ meters ☐ above or ☐ below the HAG.

b) Top of bottom floor (including basement, crawlspace, or enclosure) is: _____ ☐ feet ☐ meters ☐ above or ☐ below the LAG.

E2. For Building Diagrams 6–9 with permanent flood openings provided in Section A Items 8 and/or 9 (see pages 1–2 of Instructions), the next higher floor (C2.b in applicable Building Diagram) of the building is: _____ ☐ feet ☐ meters ☐ above or ☐ below the HAG.

E3. Attached garage (top of slab) is: _____ ☐ feet ☐ meters ☐ above or ☐ below the HAG.

E4. Top of platform of machinery and/or equipment servicing the building is: _____ ☐ feet ☐ meters ☐ above or ☐ below the HAG.

E5. Zone AO only: If no flood depth number is available, is the top of the bottom floor elevated in accordance with the community's floodplain management ordinance? ☐ Yes ☐ No ☐ Unknown The local official must certify this information in Section G.

SECTION F – PROPERTY OWNER (OR OWNER'S AUTHORIZED REPRESENTATIVE) CERTIFICATION

The property owner or owner's authorized representative who completes Sections A, B, and E for Zone A (without BFE) or Zone AO must sign here. *The statements in Sections A, B, and E are correct to the best of my knowledge*

☐ Check here if attachments and describe in the Comments area.

Property Owner or Owner's Authorized Representative Name: _____

Address: _____

City: _____ State: _____ ZIP Code: _____

Telephone: _____ Ext.: _____ Email: _____

Signature: _____ Date: _____

Comments:

ELEVATION CERTIFICATE

IMPORTANT: MUST FOLLOW THE INSTRUCTIONS ON INSTRUCTION PAGES 1-11

Building Street Address (including Apt., Unit, Suite, and/or Bldg. No.) or P.O. Route and Box No.:

1222 SEMINARY STREET

City: KEY WEST

State: FL

ZIP Code: 33040

FOR INSURANCE COMPANY USE

Policy Number: _____

Company NAIC Number: _____

SECTION G – COMMUNITY INFORMATION (RECOMMENDED FOR COMMUNITY OFFICIAL COMPLETION)

The local official who is authorized by law or ordinance to administer the community's floodplain management ordinance can complete Section A, B, C, E, G, or H of this Elevation Certificate. Complete the applicable item(s) and sign below when:

- G1. ☐ The information in Section C was taken from other documentation that has been signed and sealed by a licensed surveyor, engineer, or architect who is authorized by state law to certify elevation information. (Indicate the source and date of the elevation data in the Comments area below.)
- G2.a. ☐ A local official completed Section E for a building located in Zone A (without a BFE), Zone AO, or Zone AR/AO, or when item E5 is completed for a building located in Zone AO.
- G2.b. ☐ A local official completed Section H for insurance purposes.
- G3. ☐ In the Comments area of Section G, the local official describes specific corrections to the information in Sections A, B, E and H.
- G4. ☐ The following information (Items G5–G11) is provided for community floodplain management purposes.
- G5. Permit Number: _____ G6. Date Permit Issued: _____
- G7. Date Certificate of Compliance/Occupancy Issued: _____
- G8. This permit has been issued for: ☐ New Construction ☐ Substantial Improvement
- G9.a. Elevation of as-built lowest floor (including basement) of the building: _____ ☐ feet ☐ meters Datum: _____
- G9.b. Elevation of bottom of as-built lowest horizontal structural member: _____ ☐ feet ☐ meters Datum: _____
- G10.a. BFE (or depth in Zone AO) of flooding at the building site: _____ ☐ feet ☐ meters Datum: _____
- G10.b. Community's minimum elevation (or depth in Zone AO) requirement for the lowest floor or lowest horizontal structural member: _____ ☐ feet ☐ meters Datum: _____
- G11. Variance issued? ☐ Yes ☐ No If yes, attach documentation and describe in the Comments area.

The local official who provides information in Section G must sign here. *I have completed the information in Section G and certify that it is correct to the best of my knowledge. If applicable, I have also provided specific corrections in the Comments area of this section.*

Local Official's Name: _____ Title: _____

NFIP Community Name: _____

Telephone: _____ Ext.: _____ Email: _____

Address: _____

City: _____ State: _____ ZIP Code: _____

Signature: _____ Date: _____

Comments (including type of equipment and location, per C2.e; description of any attachments; and corrections to specific information in Sections A, B, D, E, or H):

ELEVATION CERTIFICATE

IMPORTANT: MUST FOLLOW THE INSTRUCTIONS ON INSTRUCTION PAGES 1-11

Building Street Address (including Apt., Unit, Suite, and/or Bldg. No.) or P.O. Route and Box No.:

1222 SEMINARY STREET

City: KEY WEST

State: FL

ZIP Code: 33040

FOR INSURANCE COMPANY USE

Policy Number: _____

Company NAIC Number: _____

SECTION H – BUILDING'S FIRST FLOOR HEIGHT INFORMATION FOR ALL ZONES (SURVEY NOT REQUIRED) (FOR INSURANCE PURPOSES ONLY)

The property owner, owner's authorized representative, or local floodplain management official may complete Section H for all flood zones to determine the building's first floor height for insurance purposes. Sections A, B, and I must also be completed. Enter heights to the nearest tenth of a foot (nearest tenth of a meter in Puerto Rico). **Reference the Foundation Type Diagrams (at the end of Section H Instructions) and the appropriate Building Diagrams (at the end of Section I Instructions) to complete this section.**

H1. Provide the height of the top of the floor (as indicated in Foundation Type Diagrams) above the Lowest Adjacent Grade (LAG):

a) **For Building Diagrams 1A, 1B, 3, and 5–8.** Top of bottom _____ ☐ feet ☐ meters ☐ above the LAG floor (include above-grade floors only for buildings with crawlspaces or enclosure floors) is:

b) **For Building Diagrams 2A, 2B, 4, and 6–9.** Top of next _____ ☐ feet ☐ meters ☐ above the LAG higher floor (i.e., the floor above basement, crawlspace, or enclosure floor) is:

H2. Is **all** Machinery and Equipment servicing the building (as listed in Item H2 instructions) elevated to or above the floor indicated by the H2 arrow (shown in the Foundation Type Diagrams at end of Section H instructions) for the appropriate Building Diagram?

☐ Yes ☐ No

SECTION I – PROPERTY OWNER (OR OWNER'S AUTHORIZED REPRESENTATIVE) CERTIFICATION

The property owner or owner's authorized representative who completes Sections A, B, and H must sign here. *The statements in Sections A, B, and H are correct to the best of my knowledge.* **Note:** If the local floodplain management official completed Section H, they should indicate in Item G2.b and sign Section G.

☐ Check here if attachments are provided (including required photos) and describe each attachment in the Comments area.

Property Owner or Owner's Authorized Representative Name: _____

Address: _____

City: _____ State: _____ ZIP Code: _____

Telephone: _____ Ext.: _____ Email: _____

Signature: _____ Date: _____

Comments:

ELEVATION CERTIFICATE
IMPORTANT: MUST FOLLOW THE INSTRUCTIONS ON INSTRUCTION PAGES 1-11
BUILDING PHOTOGRAPHS

See Instructions for Item A6.

Building Street Address (including Apt., Unit, Suite, and/or Bldg. No.) or P.O. Route and Box No.:
1222 SEMINARY STREET

City: KEY WEST State: FL ZIP Code: 33040

FOR INSURANCE COMPANY USE

Policy Number: _____

Company NAIC Number: _____

Instructions: Insert below at least two and when possible four photographs showing each side of the building (for example, may only be able to take front and back pictures of townhouses/rowhouses). Identify all photographs with the date taken and "Front View," "Rear View," "Right Side View," or "Left Side View." Photographs must show the foundation. When flood openings are present, include at least one close-up photograph of representative flood openings or vents, as indicated in Sections A8 and A9.



Photo One

Photo One Caption: FRONT VIEW - 12/19/2024

Clear Photo One



Photo Two

Photo Two Caption: REAR VIEW - 12/19/2024

Clear Photo Two

ELEVATION CERTIFICATE
IMPORTANT: MUST FOLLOW THE INSTRUCTIONS ON INSTRUCTION PAGES 1-11
BUILDING PHOTOGRAPHS

Continuation Page

Building Street Address (including Apt., Unit, Suite, and/or Bldg. No.) or P.O. Route and Box No.:
1222 SEMINARY STREET

City: KEY WEST State: FL ZIP Code: 33040

FOR INSURANCE COMPANY USE

Policy Number: _____

Company NAIC Number: _____

Insert the third and fourth photographs below. Identify all photographs with the date taken and "Front View," "Rear View," "Right Side View," or "Left Side View." When flood openings are present, include at least one close-up photograph of representative flood openings or vents, as indicated in Sections A8 and A9.



Photo Three

Photo Three Caption: SIDE VIEW -12/19/2024

Clear Photo Three


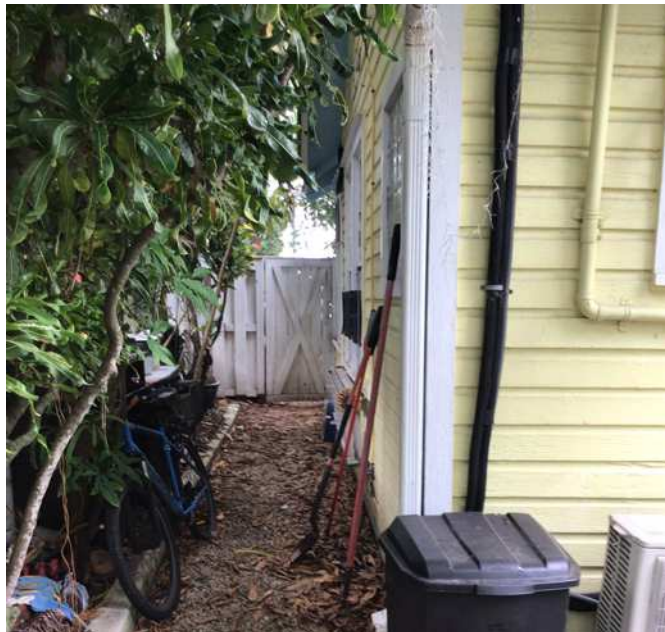



Photo Four

Photo Four Caption: SIDE VIEW - 12/19/2024


Clear Photo Four

SANBORN MAPS

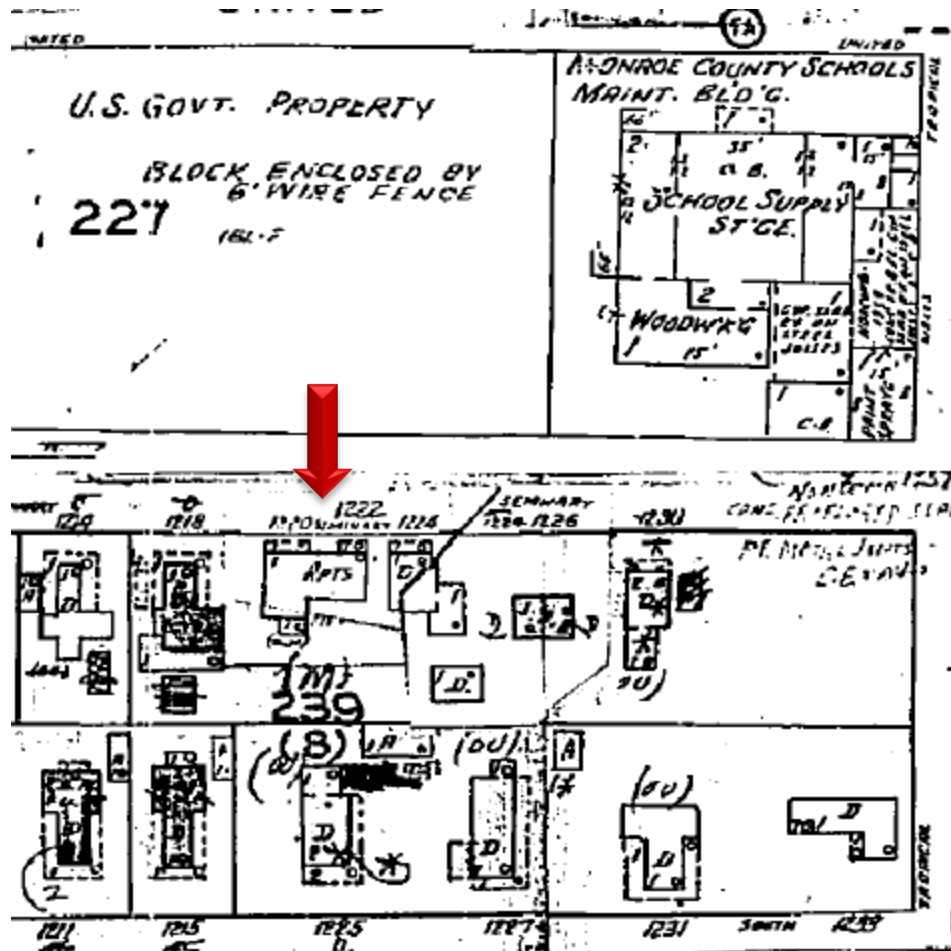

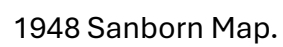

1948 Sanborn Map.

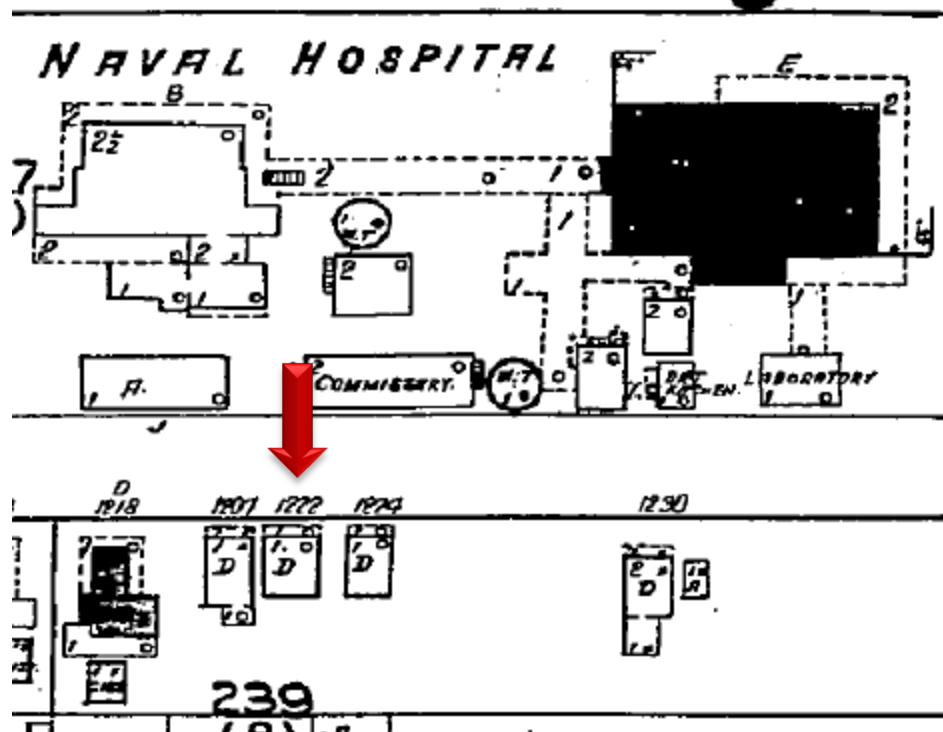

1926 Sanborn Map.

PROJECT PHOTOS

PHOTOS OF RESIDENCE















SURVEY

BEARING BASE:
ALL BEARINGS ARE BASED
ON N60°00'00"E ASSUMED
ALONG THE CENTERLINE OF
SEMINARY STREET .


ALL ANGLES DEPICTED
ARE 90 DEGREES UNLESS
OTHERWISE INDICATED

ALL UNITS ARE SHOWN IN
U.S. SURVEY FEET


ADDRESS:
1222 SEMINARY STREET,
KEY WEST, FL 33040

COMMUNITY NO.: 120168
MAP NO.: 12087C-1516K
MAP DATE: 02-18-2005
FLOOD ZONE: X-SHADED & AE
BASE ELEVATION: N/A & AE-G


MAP OF BOUNDARY SURVEY

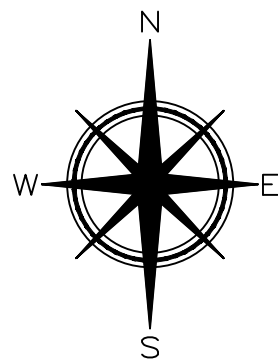

ASSUMED

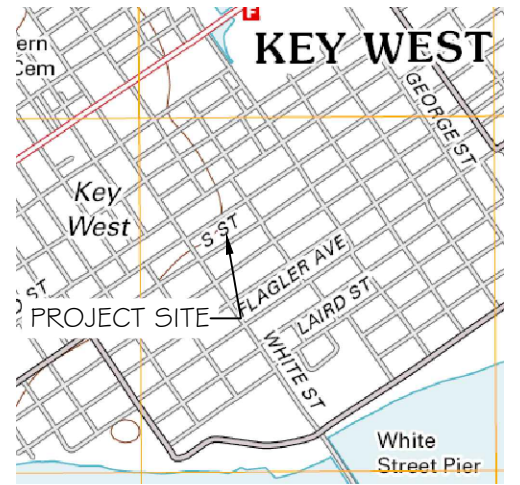

LOCATION MAP - NTS
SEC. 05-T685-R25E

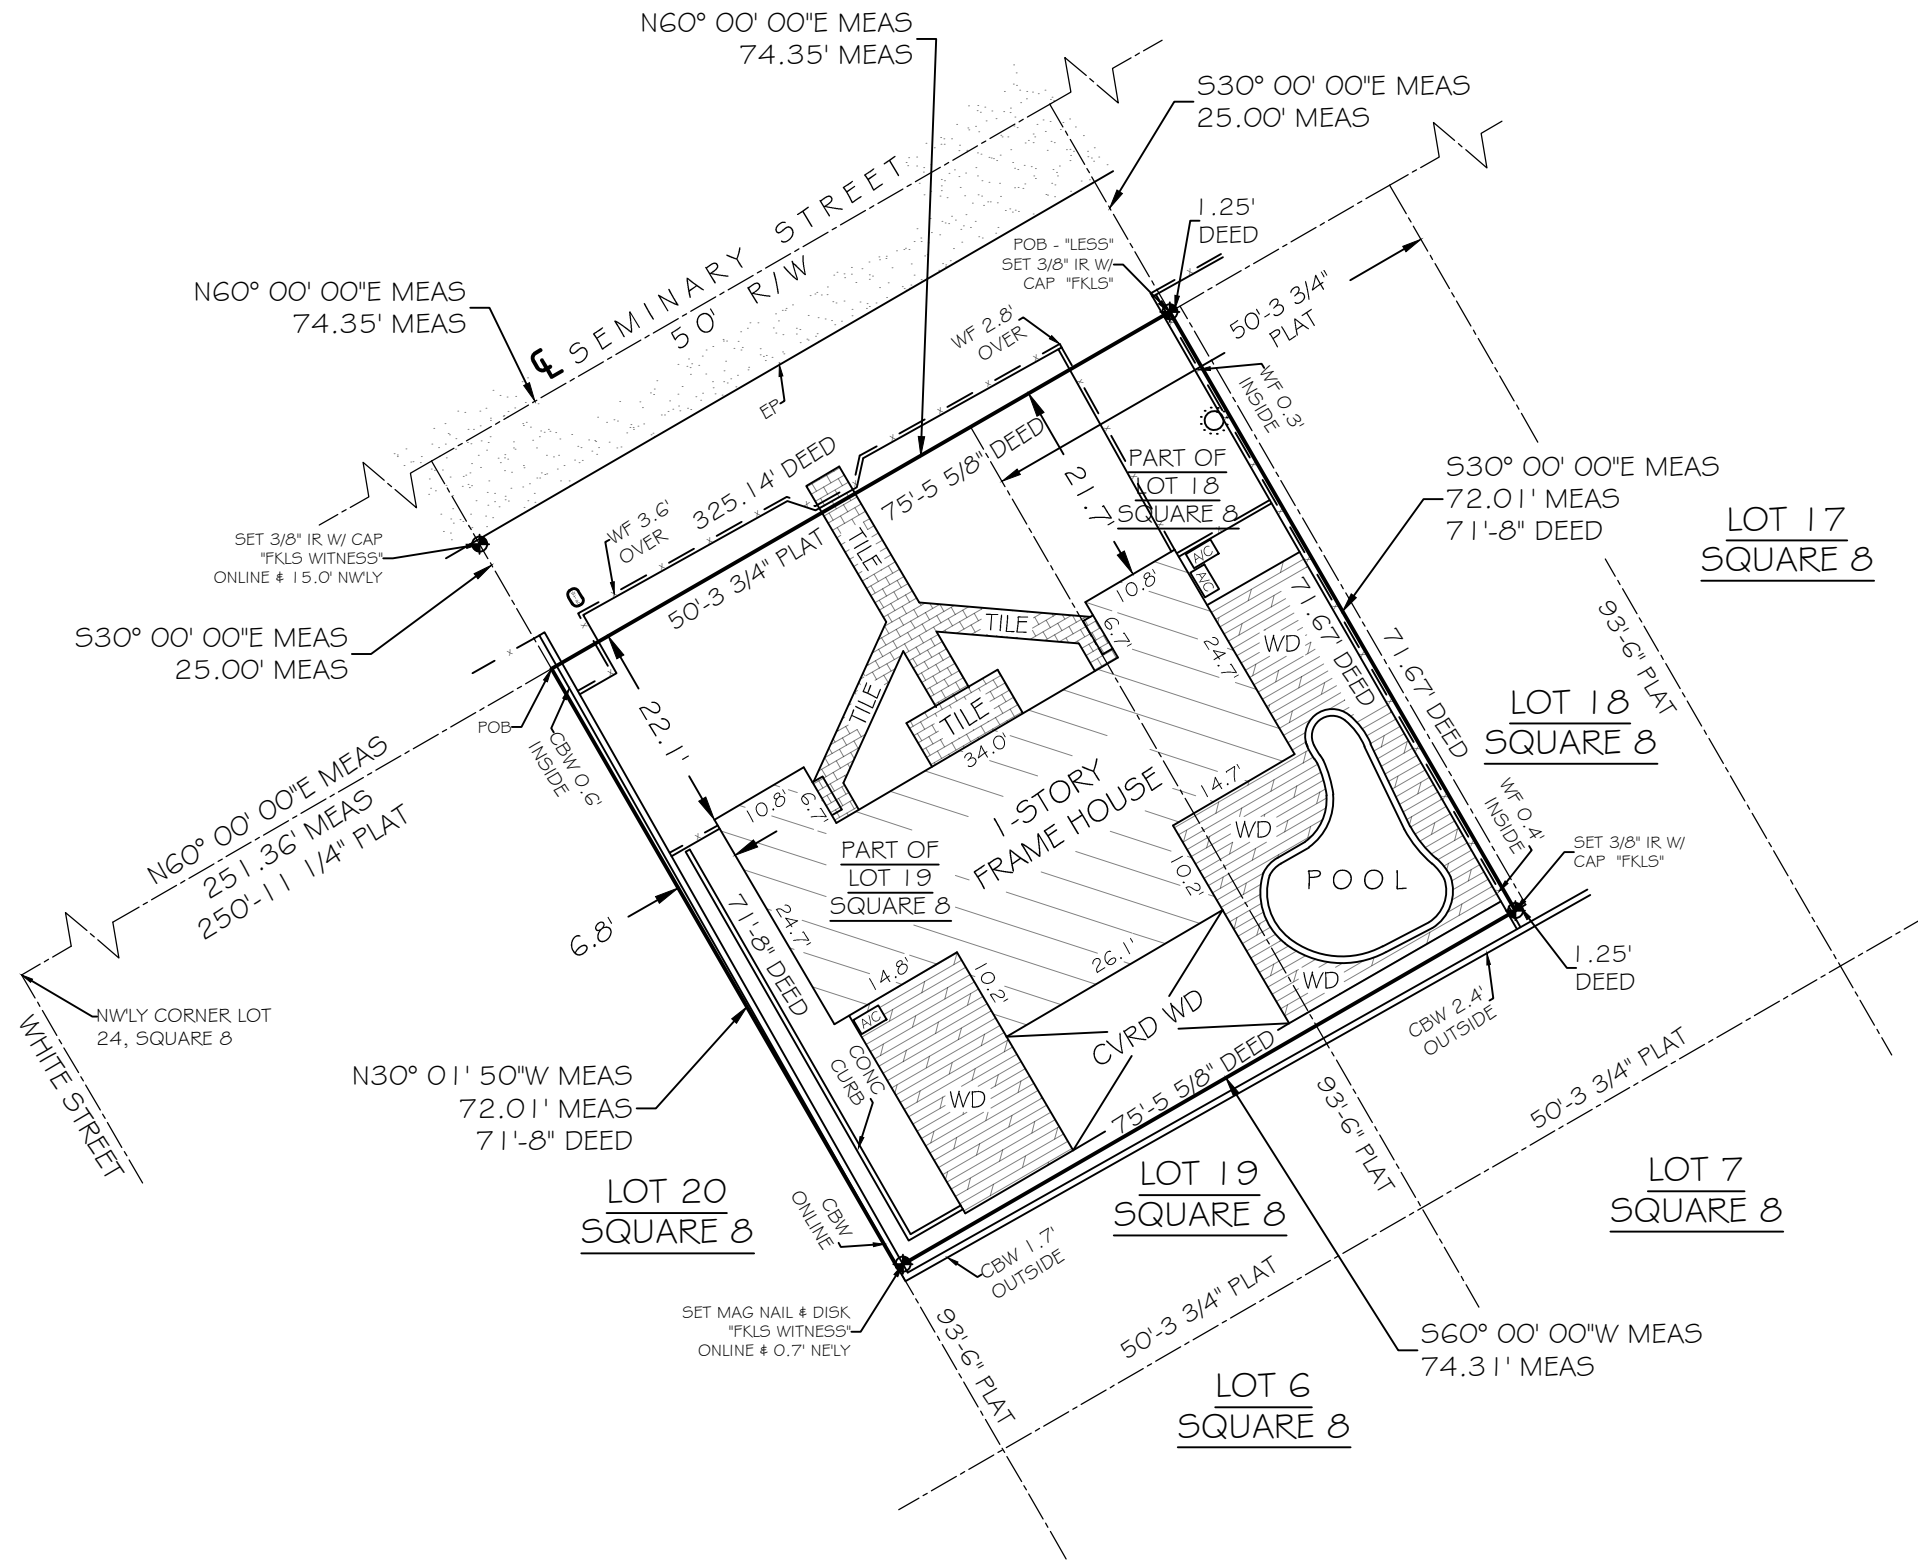


SURVEYOR NOTES:

- THIS SURVEY WAS PERFORMED FOR THE SOLE AND EXCLUSIVE BENEFIT OF THE PARTIES LISTED HEREIN AND SHALL NOT BE RELIED UPON BY ANY OTHER ENTITY OR INDIVIDUAL WHOMSOEVER. LIKEWISE, ANY REUSE OF THIS SURVEY FOR ANY PURPOSE OTHER THAN WHICH WAS ORIGINALLY INTENDED, WITHOUT THE WRITTEN PERMISSION OF THE UNDERSIGNED SURVEYOR & MAPPER, WILL BE DONE SO AT THE RISK OF THE REUSING PARTY AND WITHOUT ANY LIABILITY TO THE UNDERSIGNED SURVEYOR & MAPPER.
- THIS SURVEY DOES NOT PURPORT TO SHOW OWNERSHIP OF WALLS OR FENCES ALONG PROPERTY LINES.
- REVISION (1) - 01/29/2025 - REVISED "LESS" DESCRIPTION VERBIAGE PER CLIENTS REPRESENTATIVE.

LEGEND

- 0 - WATER METER
- - SANITARY SEWER CLEAN OUT
- - MAILBOX
- ⊙ - WOOD POWER POLE
- ☒ - CONCRETE POWER POLE

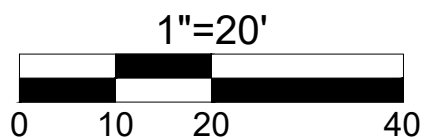

TOTAL AREA = 5,352.27 SQFT ±

CERTIFIED TO -

FC Real Estate Investments LLC, a Florida limited liability company;
Spottswood, Spottswood, Spottswood & Spottswood, PLLC;
Chicago Title Insurance Company;

NOTE: FOUNDATIONS BENEATH THE SURFACE ARE NOT SHOWN. MEASURED DIMENSIONS EQUAL PLATTED OR DESCRIBED DIMENSIONS UNLESS INDICATED OTHERWISE.
THE FOLLOWING IS A LIST OF ABBREVIATIONS THAT MAY BE FOUND ON THIS SHEET.

| | | |
|-----------------------------------|--|--------------------------------------|
| BFP = BACK-FLOW PREVENTER | GOV = GUY WIRE | POC = POINT OF COMMENCEMENT |
| BO = BLOW OUT | IP = IRON PIPE | PRC = POINT OF REVERSE CURVE |
| C 4 G = 2" CONCRETE CURB & GUTTER | R = IRON ROD | PRM = PERMANENT REFERENCE MONUMENT |
| CB = CONCRETE BLOCK | L = ARC LENGTH | PT = POINT OF TANGENT |
| CBW = CONCRETE BLOCK WALL | LS = LANDSCAPING | R = RADIUS |
| CL = CENTERLINE | MB = MAILBOX | R/W = RIGHT OF WAY LINE |
| CLF = CHAINLINK FENCE | MEAS = MEASURED | SSCO = SANITARY SEWER CLEAN-OUT |
| CM = CONCRETE MONUMENT | MF = METAL FENCE | SW = SIDE WALK |
| CONC = CONCRETE | MHWL = MEAN HIGH WATER LINE | TBM = TEMPORARY BENCHMARK |
| CVP = CONCRETE POWER POLE | (SEE NOTE) | TOB = TOP OF BANK |
| CPV = COVERED | NGVD = NATIONAL GEODETIC VERTICAL DATUM (1929) | TOS = TOP OF SLOPE |
| DELT = CENTRAL ANGLE | NITS = NOT TO SCALE | TS = TRAFFIC SIGN |
| DEASE = DRAINAGE EASEMENT | OH = ROOF OVERHANG | TYP = TYPICAL |
| EL = ELEVATION | OWH = OVERHEAD WIRES | UE = UTILITY EASEMENT |
| ENCL = ENCLOSURE | PC = POINT OF CURVE | WD = WOOD DECK |
| EP = EDGE OF PAVEMENT | PM = PARKING METER | WF = WOOD FENCE |
| FF = FINISHED FLOOR ELEVATION | PCG = POINT OF COMPOUND CURVE | WL = WOOD LANDING |
| FI = FIRE HYDRANT | PCP = PERMANENT CONTROL POINT | WM = WATER METER |
| FI = FENCE INSIDE | PK = PARKER KALON NAIL | WPP = WOOD POWER POLE |
| FND = FOUND | POB = POINT OF BEGINNING | WRACK LINE = LINE OF DEBRIS ON SHORE |
| FO = FENCE OUTSIDE | PI = POINT OF INTERSECTION | WV = WATER VALVE |
| FOL = FENCE ON LINE | | |

LEGAL DESCRIPTION -

The Southwest one-half (1/2) of Lot Eighteen (18) of all of Lot Nineteen (19), Square Eight (8), Tract Nineteen (19), according to a diagram made by William A. Gwynn, Surveyor, recorded in Plat Book 1, page 34, Public Records of Monroe County, Florida; more particularly described by metes and bounds as follows: Beginning at a point on the Southeast side of Seminary Street 250 feet, 11-1/4 inches in a Northeasterly direction, from the Southeast corner of Seminary and White Street; running thence in a Northeasterly direction along the Southeast side of Seminary Street 75 feet, 5-5/8 inches; thence at right angles in a Southeasterly direction 71 feet, 8 inches; thence at right angles in a Southwesterly direction 75 feet, 5-5/8 inches; thence at right angles in a Northwesterly direction 71 feet, 8 inches to Seminary Street, the Place of Beginning. LESS

A 1.25 foot x 71.67 foot parcel of land on the Island of Key West and being a part of Lot 18, Square 8, Tract 19, according to a diagram made by William A. Gwynn, Surveyor, recorded in Plat Book 1, at page 34, of the Public Records of Monroe County, Florida, and being more particularly described as follows: Beginning at a point on the Southeastly right-of-way line of Seminary Street 325.14 feet, in a Northeasterly direction from the Southeast corner of Seminary and White Streets; thence continuing in a Northeasterly direction along the said Southeastly right-of-way line of Seminary Street for 1.25 feet; thence at right angles and Southeasterly for 71.67 feet; thence at right angles and Southwesterly for 1.25 feet; thence at right angles and Northwesterly for 71.67 feet to the said Southeastly right-of-way line of Seminary Street and the Point of Beginning.

| | |
|-----------------|------------|
| SCALE: | 1"=20' |
| FIELD WORK DATE | 12/09/2024 |
| MAP DATE | 12/16/2024 |
| REVISION DATE | 01/29/2025 |
| SHEET | 1 OF 1 |
| DRAWN BY: | IDG |
| JOB NO.: | 24-264 |

SIGNED

ERIC A. ISAAC, FLSM #6783, PROFESSIONAL SURVEYOR AND MAPPER, LB# 7847

NOT VALID WITHOUT THE
SIGNATURE AND THE RAISED
SEAL OF A FLORIDA
SURVEYOR AND MAPPER



FLORIDA KEYS
LAND SURVEYING

21460 OVERSEAS HIGHWAY, SUITE 4
CUDJOE KEY, FL 33042
PHONE: (305) 394-3690
FAX: (305) 509-7373
EMAIL: FKL5email@Gmail.com

PROPOSED DESIGN

LOCATION MAP



BUILDING DATA

1222 SEMINARY STREET
KEY WEST, FL 33040

BUILDING SQUARE FOOTAGE:
EXISTING: 1,414 SF
PROPOSED: 1,738 SF

CONTRACTOR GENERAL NOTES:
- ALL WORK TO BE IN ACCORDANCE WITH APPLICABLE CODES.
- WORKMANSHIP TO MEET OR EXCEED ACCEPTED STANDARDS OF RESPECTIVE TRADES.
- VERIFY ALL DIMENSIONS, ELEVATIONS, AND FIELD CONDITIONS BEFORE START OF CONSTRUCTION. NOTIFY ARCHITECT IF ANY CONFLICTS EXIST PRIOR TO COMMENCEMENT OF WORK.
- FOR ANY TYPE I OR TYPE II CONSTRUCTION PROJECTS FIRE RETARDANT TREATED WOOD (EXTERIOR OR INTERIOR GRADE) MUST BE USED IN ALL WOOD CONSTRUCTION MATERIALS.
- FOR ALL WALL SYSTEMS WITH EIFS USE EXTERIOR GRADE GLASS MATT SHEATHING OR CEMENTITIOUS BOARD ONLY.

FIRE EXTINGUISHERS WILL BE PROVIDED AS REQUIRED BY AUTHORITY HAVING JURISDICTION OR AS DIRECTED BY THE LOCAL FIRE DEPARTMENT.

WALL R-VALUE (CONTINUOUS) = 6
WALL R-VALUE (CAVITY) = 13
ROOF R-VALUE = 39

CONTRACTOR TO PROVIDE ESR REPORTS FOR CLOSED-CELL SPRAY FOAM SELECTED FOR REVIEW BY DESIGN PROFESSIONAL.

SCOPE OF WORK:

DEMO OF AN EXISTING 1,414 SF TRIPLEX AND ASSOCIATED DECK/POOL.
CONSTRUCTION OF A NEW 1,738 SF SINGLE FAMILY RESIDENCE. WOOD FRAME CONSTRUCTION ON CONC. FOUNDATION. IMPACT WINDOWS & DOORS. HARDI SIDING. METAL ROOF. PT WOOD FRAME DECK PER PLAN.

GENERAL NOTES

- THESE PLANS ARE FOR THE CONSTRUCTION OF THE BUILDING AT THE LOCATION SO DESIGNATED HERE IN.
- NO CHANGES IN THE PLANS SHALL BE MADE WITHOUT PRIOR APPROVAL OF THE DESIGN PROFESSIONAL.
- THE CONTRACTOR SHALL CHECK AND VERIFY ALL DIMENSIONS AND CONDITIONS OF THE JOB SITE AND REPORT ANY DISCREPANCIES OR UNSATISFACTORY CONDITIONS TO THE ARCHITECT BEFORE PROCEEDING WITH THE WORK.
- THE CONTRACTOR SHALL PROVIDE FOR THE SAFETY, PREVENTION OF INJURY, OR LOSS AT THE JOB SITE TO ALL PERSONS EMPLOYED TO DO WORK, PERSONS VISITING THE SITE AND THE GENERAL PUBLIC. CONTRACTOR SHALL ALSO BE RESPONSIBLE FOR THE PREVENTION OF DAMAGE TO MATERIALS OR EQUIPMENT AND OTHER PROPERTY AT THE SITE OR ADJACENT THERETO.
- THE CONTRACTOR SHALL DO ALL THE WORK IN STRICT CONFORMANCE TO THE PLAN, 2023 FLORIDA BUILDING CODE, 8TH EDITION; LOCAL CODES AND ORDINANCES; MANUFACTURING'S RECOMMENDATIONS AND ACCEPTABLE TRADE PRACTICES. THE MOST STRINGENT REQUIREMENTS SHALL GOVERN WHEN CONDITIONS CONFLICT, HOWEVER THE ARCHITECT SHALL BE NOTIFIED OF ALL CONFLICTS.
- SHOP DRAWINGS OF ALL PREFABRICATED STRUCTURAL SYSTEMS SHALL HAVE THE SEAL OF A REGISTERED FLORIDA ENGINEER AS REQUIRED BY BUILDING CODE AND SHALL BE SUBMITTED TO THE ARCHITECT/ENGINEER BY THE CONTRACTOR FOR REVIEW PRIOR TO CONSTRUCTION.
- CONTRACTOR SHALL NOT SCALE DRAWINGS. ANY INFORMATION THAT HE CANNOT OBTAIN FROM DIMENSIONS, DETAILS, OR SCHEDULES, HE SHALL NOTIFY THE ARCHITECT.
- CONTRACTOR SHALL CHECK AND COORDINATE WORK OF VARIOUS TRADES TO PREVENT CONFLICTS.
- CONTRACTOR SHALL FURNISH SUBCONTRACTORS WITH A COMPLETE SET OF PLANS.
- PLUMBING AND A/C SHALL CONFORM TO THE STATE OF FLORIDA ENERGY CODE.
- ALL ELECTRICAL WORK SHALL CONFORM TO THE NATIONAL ELECTRIC CODE AND FLORIDA BUILDING CODE.
- PORTABLE REST ROOM FACILITIES SHALL BE PROVIDED AT SITE BY CONTRACTOR.
- COMPLETE HOT AND COLD WATER SYSTEMS, VENTS, WASTE AND DRAIN SYSTEMS TO SEPTIC TO CODE, SHALL BE FURNISHED.
- PROVIDE PLASTIC SLEEVES IN MASONRY, PARTITIONS, FOUNDATIONS, ETC., AS REQUIRED FOR UTILITY SERVICE.
- ALL BOLTS, CLIPS, HANGERS, ETC., SHALL BE GALVANIZED OR STAINLESS.
- NO PIPES, CONDUITS OR JUNCTION BOXES ARE TO BE PLACED IN SLABS OR COLUMNS, UNLESS SPECIFICALLY SHOWN ON STRUCTURAL DRAWINGS.
- CONTRACTOR IS RESPONSIBLE FOR THE PROPER REMOVAL OF ALL DEBRIS.
- ALL ELEVATIONS ARE MEASURED FROM NGVD 1929.

SITE DATA:
ZONING HMDR

LEGAL DESCRIPTION:
The Southwest one-half (1/2) of Lot Eighteen (18) of all of Lot Nineteen (19), Square Eight (8), Tract Nineteen (19), according to a diagram made by William A. Gwynn, Surveyor, recorded in Plat Book 1, page 34, Public Records of Monroe County, Florida; more particularly described by metes and bounds as follows: Beginning at a point on the Southeast side of Seminary Street 250 feet, 11-1/4 inches in a Northeasterly direction, from the Southeast corner of Seminary and White Street; running thence in a Northeasterly direction along the Southeast side of Seminary Street 75 feet, 5-5/8 inches; thence at right angles in a Southeasterly direction 71 feet, 8 inches; thence at right angles in a Southwesterly direction 75 feet, 5-5/8 inches; thence at right angles in a Northwesterly direction 71 feet, 8 inches to Seminary Street, the Place of Beginning.
LESS
A 1.25 feet x 71.67 feet parcel of land on the Island of Key West and being a part of Lot 18, Square 8, Tract 19, according to a diagram made by William A. Gwynn, Surveyor, recorded in Plat Book 1, at page 34, of the Public Records of Monroe County, Florida, and being more particularly described as follows: Beginning at a point on the Southeasterly right-of-way line of Seminary Street 325.14 feet, in a Northeasterly direction from the Southeast corner of Seminary and White Streets; thence continuing in a Northeasterly direction along the said Southeasterly right-of-way line of Seminary Street for 1.25 feet; thence at right angles and Southeasterly for 71.67 feet; thence at right angles and Southwesterly for 1.25 feet; thence at right angles and Northwesterly for 71.67 feet to the said Southeasterly right-of-way line of Seminary Street and the Point of Beginning.

RE #: 00042120-000000

SUBDIVISION: TROPICAL BUILDING AND INVESTMENT CO

MAX BUILDING HEIGHT = 30' FROM COR OR LAG, WHICHEVER IS LOWER.
LAG IS LOWER THAN COR.

OCCUPANCY: R3
TYPE OF CONSTRUCTION: VB

FLOOD DESIGN CRITERIA: ASCE12-24

COMMUNITY NUMBER: 120168
MAP NUMBER: 12087C-1516K
MAP DATE: 02-18-2005
FLOOD ZONE: X-ZONE
DESIGN FLOOD ELEVATION: X-ZONE

CODE INFORMATION

BUILDING CODE: 2023 FLORIDA BUILDING CODE, 8TH EDITION
MECHANICAL CODE: 2023 FLORIDA MECHANICAL CODE
PLUMBING CODE: 2023 FLORIDA PLUMBING CODE
ELECTRICAL CODE: 2020 NATIONAL ELECTRIC CODE (NEC) NFPA
FUEL GAS CODE: 2023 FLORIDA FUEL GAS CODE
ENERGY CODE: 2023 FLORIDA ENERGY CONSERVATION CODE ASCE 7-22
STANDARD LOAD DESIGN CRITERIA

LOCAL BUILDING REQUIREMENTS:
FEMA REQUIREMENTS:
DESIGN FLOOD ELEVATION: HMDR
CURRENT ZONING: 30' FROM COR/LAG
USE GROUP: R3

ALL ELEVATIONS PROVIDED IN NGVD 1929.

ABBREVIATIONS

| | |
|--------|--|
| AFF | ABOVE FINISHED FLOOR |
| AHU | AIR HANDLING UNIT |
| A/V | AUDIO VISUAL |
| BO | BOTTOM OF |
| CL | CENTERLINE |
| CLG | CEILING |
| CMU | CONCRETE MASONRY UNIT |
| CO | CLEAN OUT |
| CONC | CONCRETE |
| D | DRYER |
| DIA | DIAMETER |
| DTLS | DETAILS |
| DW | DISHWASHER |
| E | ELECTRICAL METER |
| FBC | FLORIDA BUILDING CODE |
| FEC | FIRE EXTINGUISHER CABINET |
| GA | GAUGE |
| GAL | GALLON |
| GFI | GROUND FLOOR IMPACT |
| GWB | GYP SUM WALL BOARD |
| HB | HOSE BIB |
| HVAC | HEATING, VENTILATION, & AIR CONDITIONING |
| LHM | LOWEST HORIZONTAL MEMBER |
| MAX | MAXIMUM |
| MEP | MECHANICAL, ELECTRICAL, PLUMBING |
| MIN | MINIMUM |
| NIC | NOT IN CONTRACT |
| NTS | NOT TO SCALE |
| O.C. | ON CENTER |
| PSI | POUNDS PER SQUARE INCH |
| PT | PRESSURE TREATED |
| RCP | REFLECTED CEILING PLAN |
| RE | REFERENCE |
| REF | REFRIGERATOR |
| REQ'D | REQUIRED |
| RO | ROUGH OPENING |
| STL | STEEL |
| THK | THICK |
| TO | TOP OF |
| TOP | TOP OF PILE |
| TOW | TOP OF WALL |
| TYP | TYPICAL |
| U.N.O. | UNLESS OTHERWISE NOTES |
| VTR | VENT TO ROOF |
| W | WASHER |
| WC | WATER CLOSET |
| WD | WOOD |
| W/D | WASHER/DRYER |
| WP | WATERPROOF |
| WH | WATER HEATER |

SYMBOLS

| | | |
|--|--------------------------------------|----------------------------------|
| | ROOM IDENTIFICATION TAG | ROOM NAME ROOM NUMBER |
| | ELEVATION TAG | ELEVATION NUMBER SHEET NUMBER |
| | DETAIL TAG | DETAIL NUMBER SHEET NUMBER |
| | INTERIOR ELEVATION TAG | ELEVATION NUMBER SHEET NUMBER |
| | SECTION TAG | SECTIONNUMBER SHEET NUMBER |
| | DOOR TAG. REFER TO DOOR SCHEDULE | |
| | WINDOW TAG. REFER TO WINDOW SCHEDULE | |
| | WALL TAG. REFER TO WALL TYPES. | |
| | BREAK LINE | |
| | GRAPHIC SCALE | |
| | NORTH ARROW | |
| | DRAWING TITLE | DETAIL NUMBER SHEET NUMBER |
| | SCALE: ? | TITLE SCALE |

DRAWING INDEX

| | |
|-----|-------------|
| A 0 | COVER SHEET |
| A 2 | SITE PLAN |
| A 3 | FLOOR PLANS |
| A 4 | ELEVATIONS |
| A 5 | ELEVATIONS |

HARC NOTES:
-EXTERIOR SIDING TO BE HARDI BOARD.
-ROOFING TO BE 5V CRIMP, MILL FINISH.
-EXTERIOR SOFFITS TO BE HARDI BOARD.
-EXTERIOR WINDOW/DOOR TRIM TO BE 1X4 HARDI.
-EXTERIOR FASCIA TO BE HARDI.
-ROOFING DRIP EDGE TO MATCH FINISH OF METAL ROOF.
-GUTTERS, IF PROVIDED, TO MATCH FINISH OF DRIP EDGE & ROOFING.
-EXTERIOR WINDOWS TO HAVE MUNTIN PATTERN APPROVED BY CITY OF KEY WEST HARC STAFF.
-CONTRACTOR TO RECEIVE APPROVAL FOR FINAL PAINT COLOR SELECTIONS.
-EXTERIOR SHUTTERS TO BE WOOD, PTD. AS APPROVED BY CITY OF KEY WEST HARC STAFF.

DATE: 2025.04.22

REV. SET DESCRIPTION
HARC SUBMITTAL SET

Single Family Residence

1222 Seminary Street
Key West, FL 33040

SEAL:

NOT FOR CONSTRUCTION

NOT VALID FOR CONSTRUCTION UNLESS
SIGNED/SEALED IN THIS BLOCK

ERICA HELEN POOLE - ARCHITECT
#AR98525

SANDBAR DESIGN STUDIO
20185 CAMELLIA LANE
BIG PINE KEY, FL 33043
WWW.SANDBARDESIGNSTUDIO.COM
84719035854

COVER SHEET


SHEET TITLE

A 0


PROJECT NO:
HHB2025

DRAWN BY:
Author

APPROVED BY:
Checker

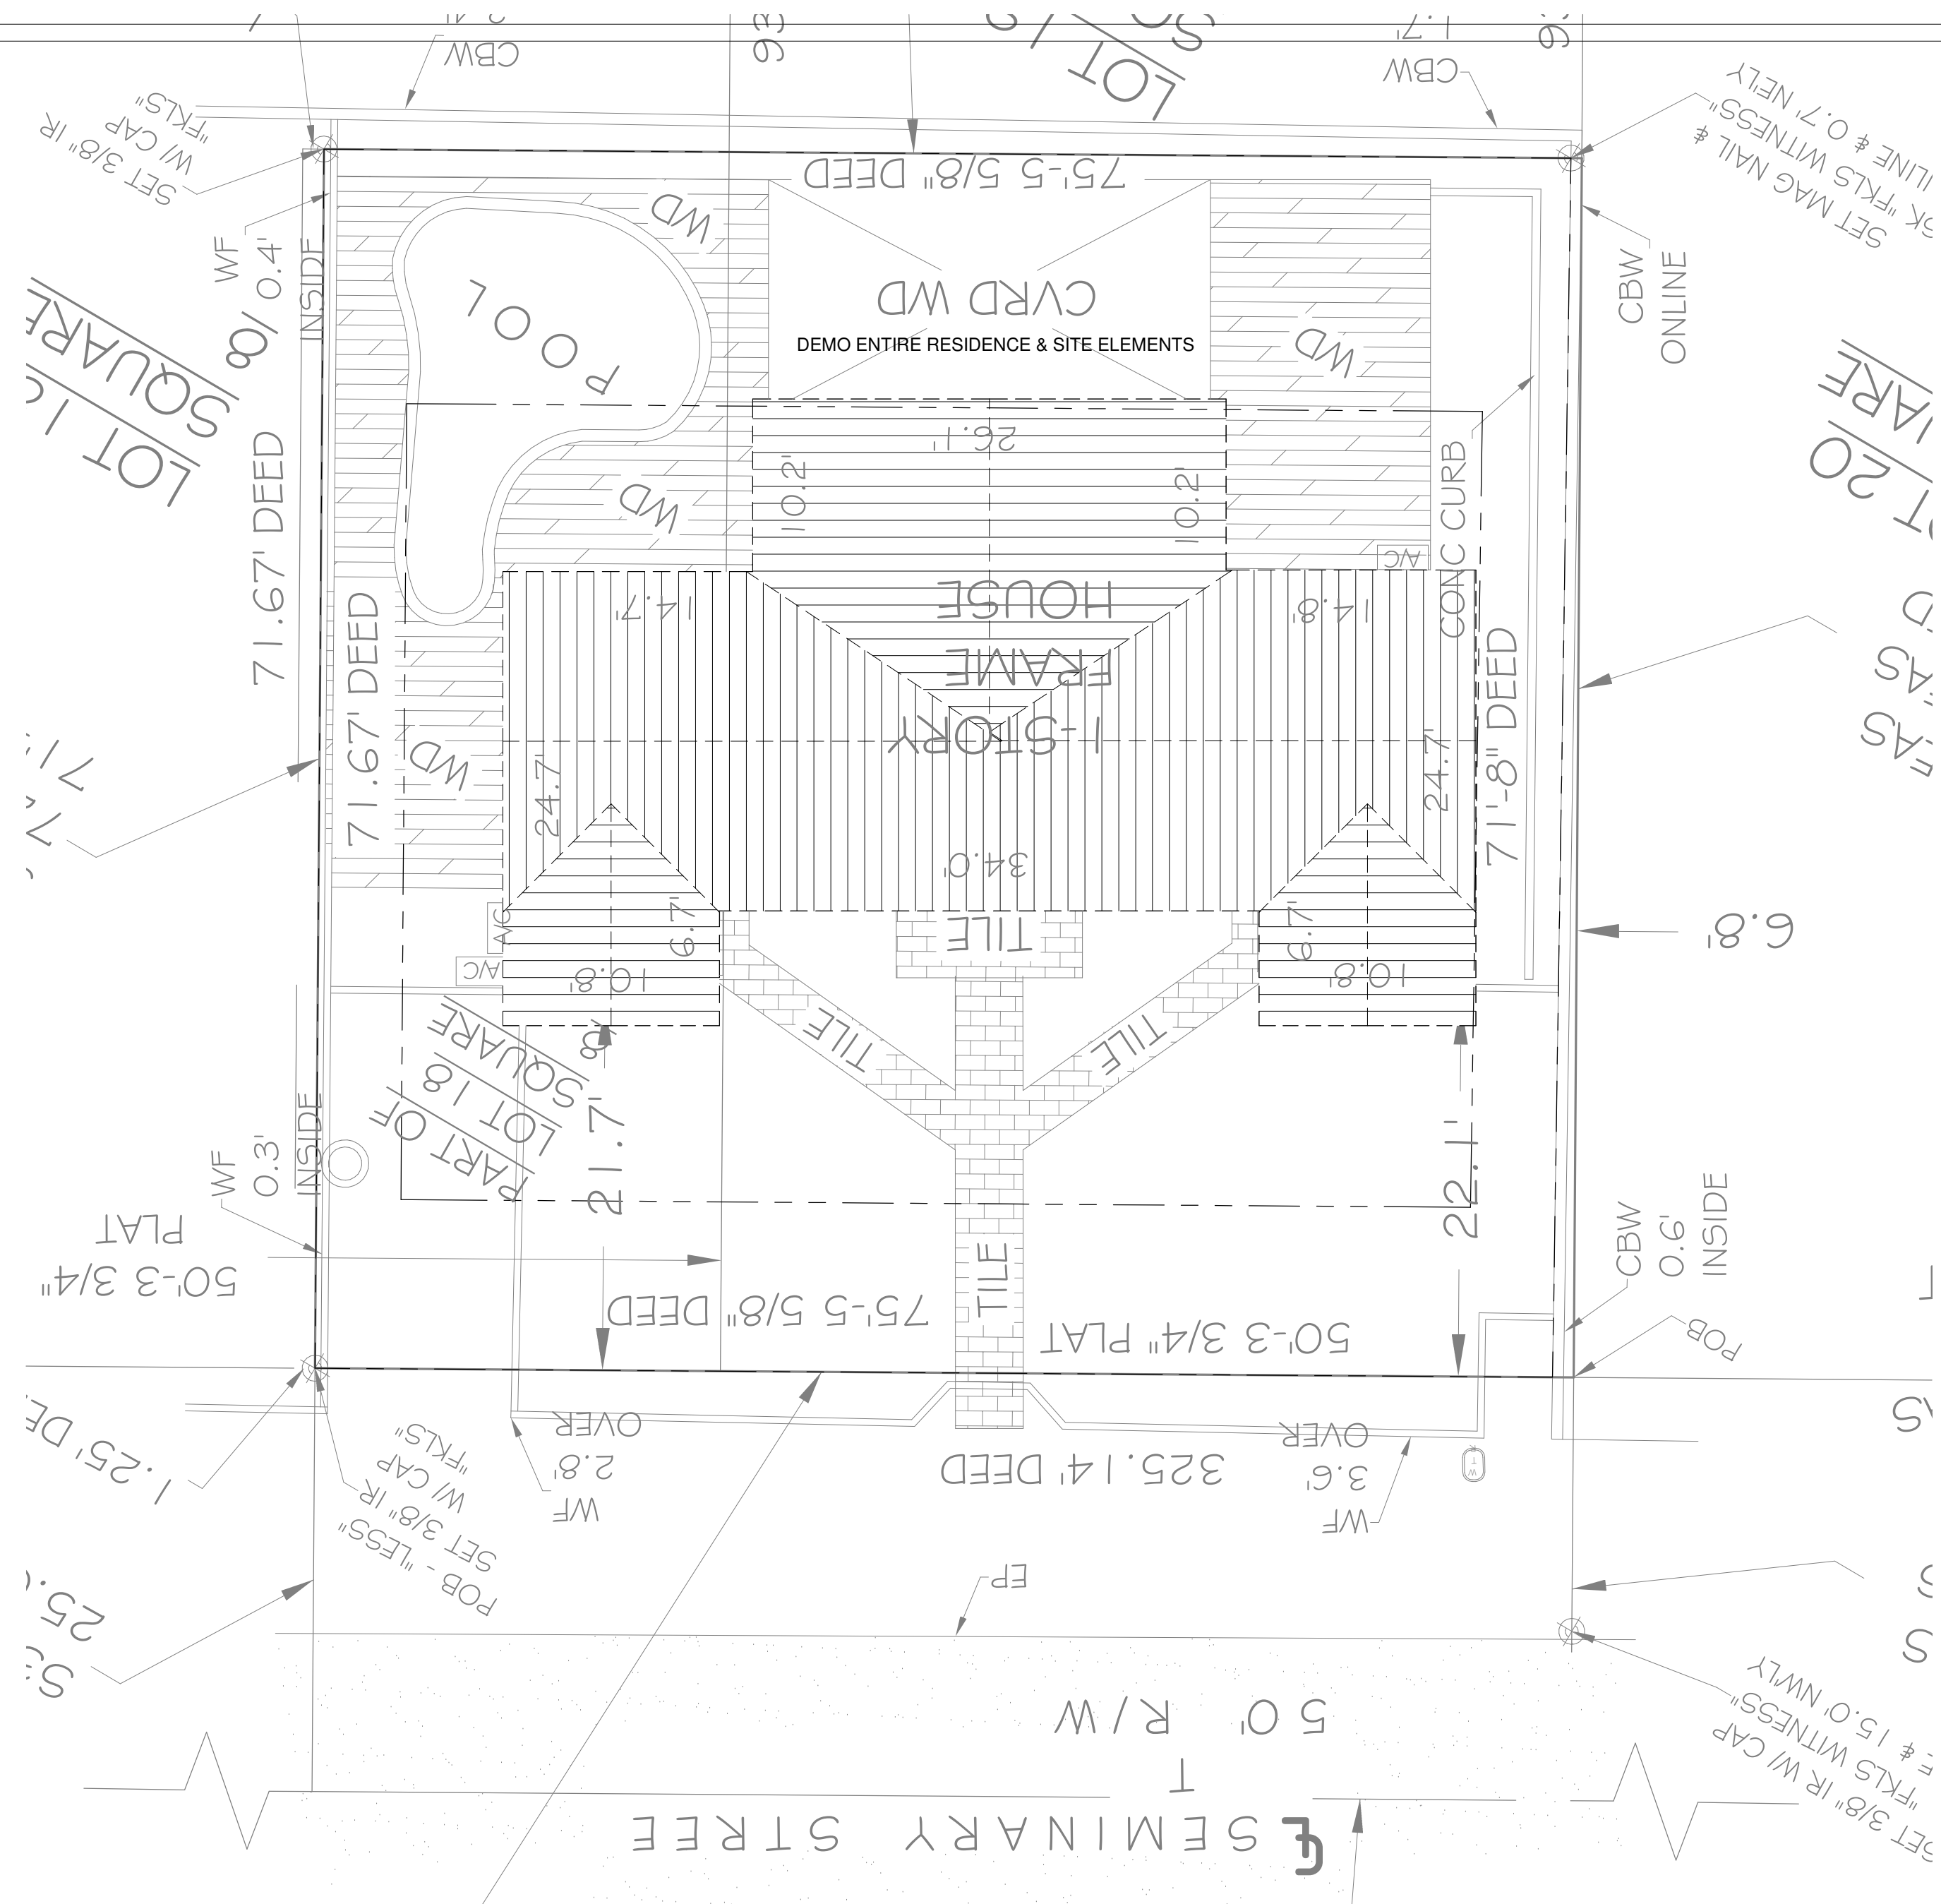

2 SITE PLAN - EXISTING/DEMO
1/8" = 1'-0"

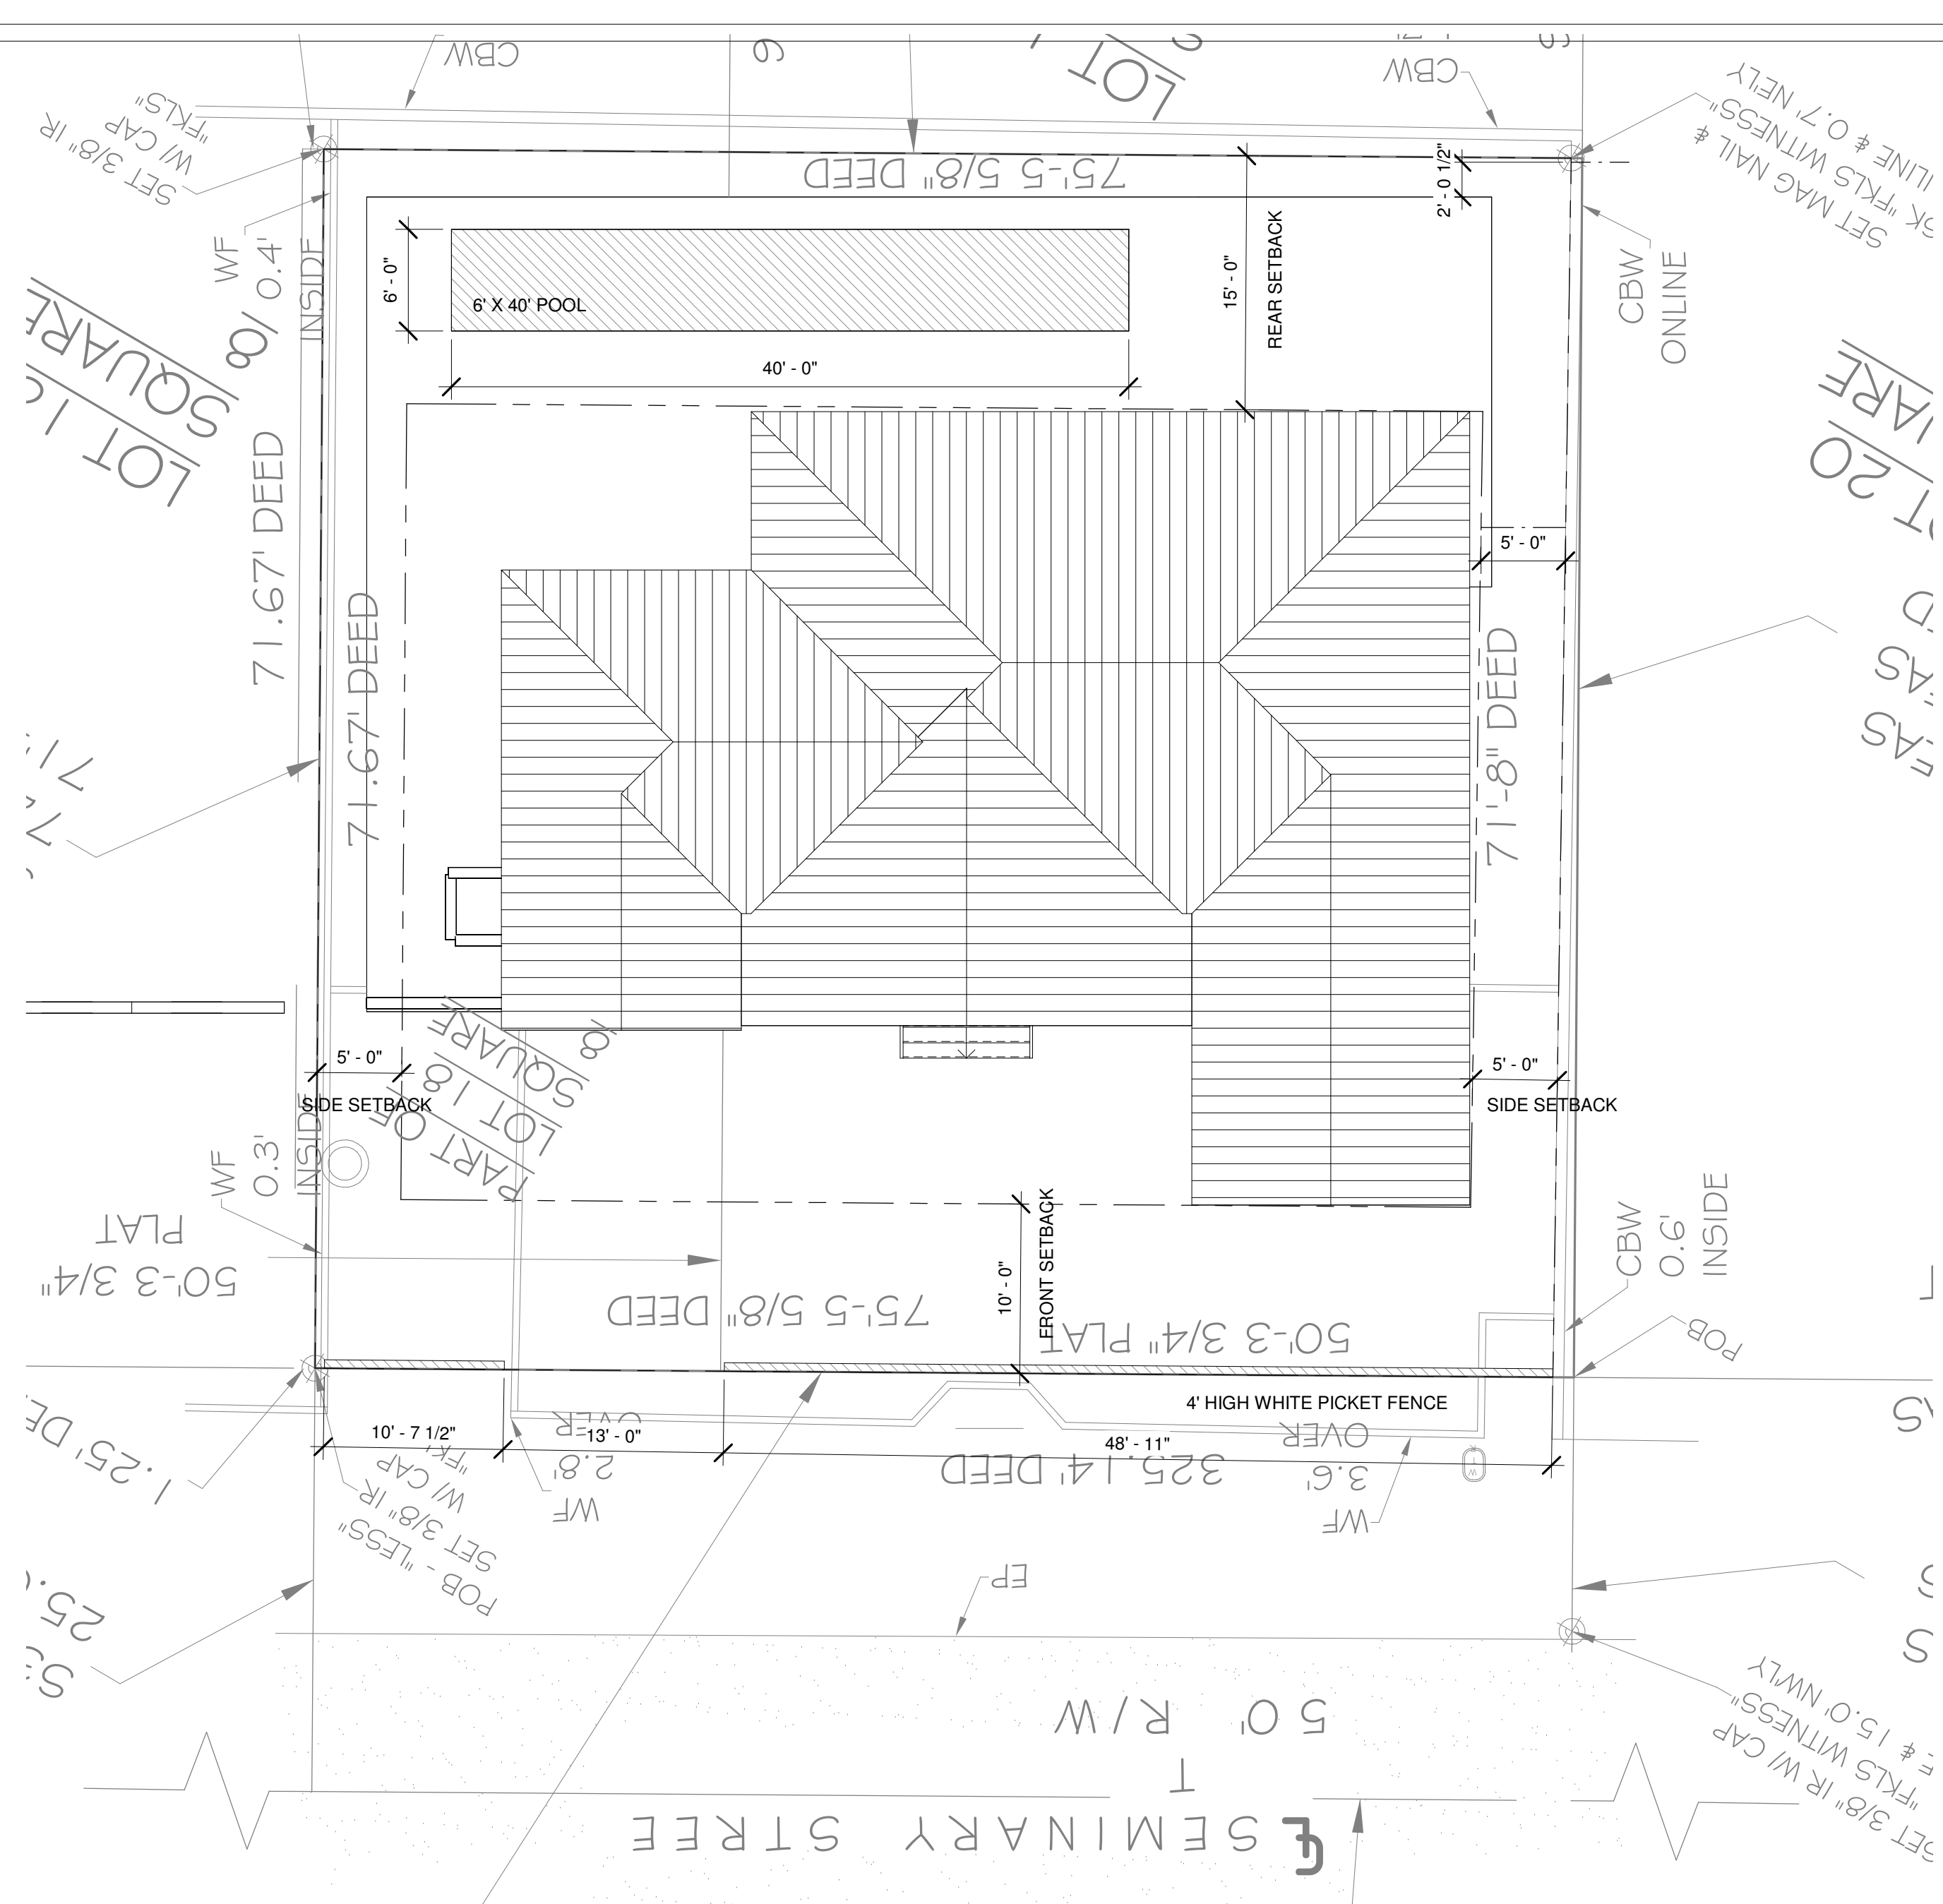

1 SITE PLAN - PROPOSED
1/8" = 1'-0"

| SITE DATA TABLE | | | | |
|------------------------|------------------|---------------|------------------|------------------|
| | CODE REQUIREMENT | EXISTING SITE | PROPOSED | VARIANCE REQUEST |
| Zoning | HMDR | HMDR | HMDR | N/A |
| Flood Zone | X-ZONE/AE-6 | X-ZONE/AE-6 | X-ZONE/AE-6 | N/A |
| Size of Site | 5,353 | 5,353 | 5,353 | N/A |
| Height | 35'-0" | 14'-7" | NO CHANGE | N/A |
| Front Setback | 10'-0" | 22.1' | 10.1' | N/A |
| Side Setback A | 5'-0" | 6.8' | NO CHANGE | N/A |
| Side Setback B | 5'-0" | 11.9' | NO CHANGE | N/A |
| Street Side Setback | 15'-0" | N/A | N/A | N/A |
| Rear Setback | 15'-0" | 1.6' | 15.3' | N/A |
| Residential Floor Area | N/A | N/A | N/A | N/A |
| Density | 1 DU/ACRE | N/A | N/A | N/A |
| Building Coverage | 40% | 26% | 35% | N/A |
| Impervious Surface | 60% | 44% | 46% | N/A |
| Open Space | 35% | 56% | 54% | N/A |
| Breakdowns (SF) | | | | |
| Lot Area | 5,353 | | | |
| Existing Coverages | | | | |
| Impervious Surface | 2,355 | | Front Tile | 277 |
| Impervious Surface (%) | 44% | | Pool | 309 |
| Building Coverage | 1412 | | Wood Deck 1 | 511 |
| Building Coverage (%) | 26% | | Wood Deck 2 | 306 |
| Open Space | 2,998 | | Covered Deck | 357 |
| Open Space (%) | 56% | | House Footprint | 1412 |
| Proposed Developments | | | | |
| Impervious Surface | 2,469 | | Front Drive/Walk | 466 |
| Impervious Surface (%) | 46% | | Pool | 240 |
| Building Coverage | 1,888 | | Pool Deck | 979 |
| Building Coverage (%) | 35% | | House Footprint | 1763 |
| Open Space | 2,884 | | | 125 |
| Open Space (%) | 54% | | | |



3 STREET ELEVATION - EXISTING/DEMO
1" = 10'-0"

4 STREET ELEVATION - PROPOSED
1" = 10'-0"

Single Family Residence
1222 Seminary Street
Key West, FL 33040

SEAL:

NOT FOR CONSTRUCTION

NOT VALID FOR CONSTRUCTION UNLESS
SIGNED/SEALED IN THIS BLOCK

ERICA HELEN POOLE - ARCHITECT
#AR98525




SANDBAR DESIGN STUDIO
20185 CAMELIA LANE
BIG PINE KEY, FL 33043
WWW.SANDBARDESIGNSTUDIO.COM
8479035854

SITE PLAN


SHEET TITLE

A 2


PROJECT NO: HHB2025
DRAWN BY: EHP
APPROVED BY: EHP

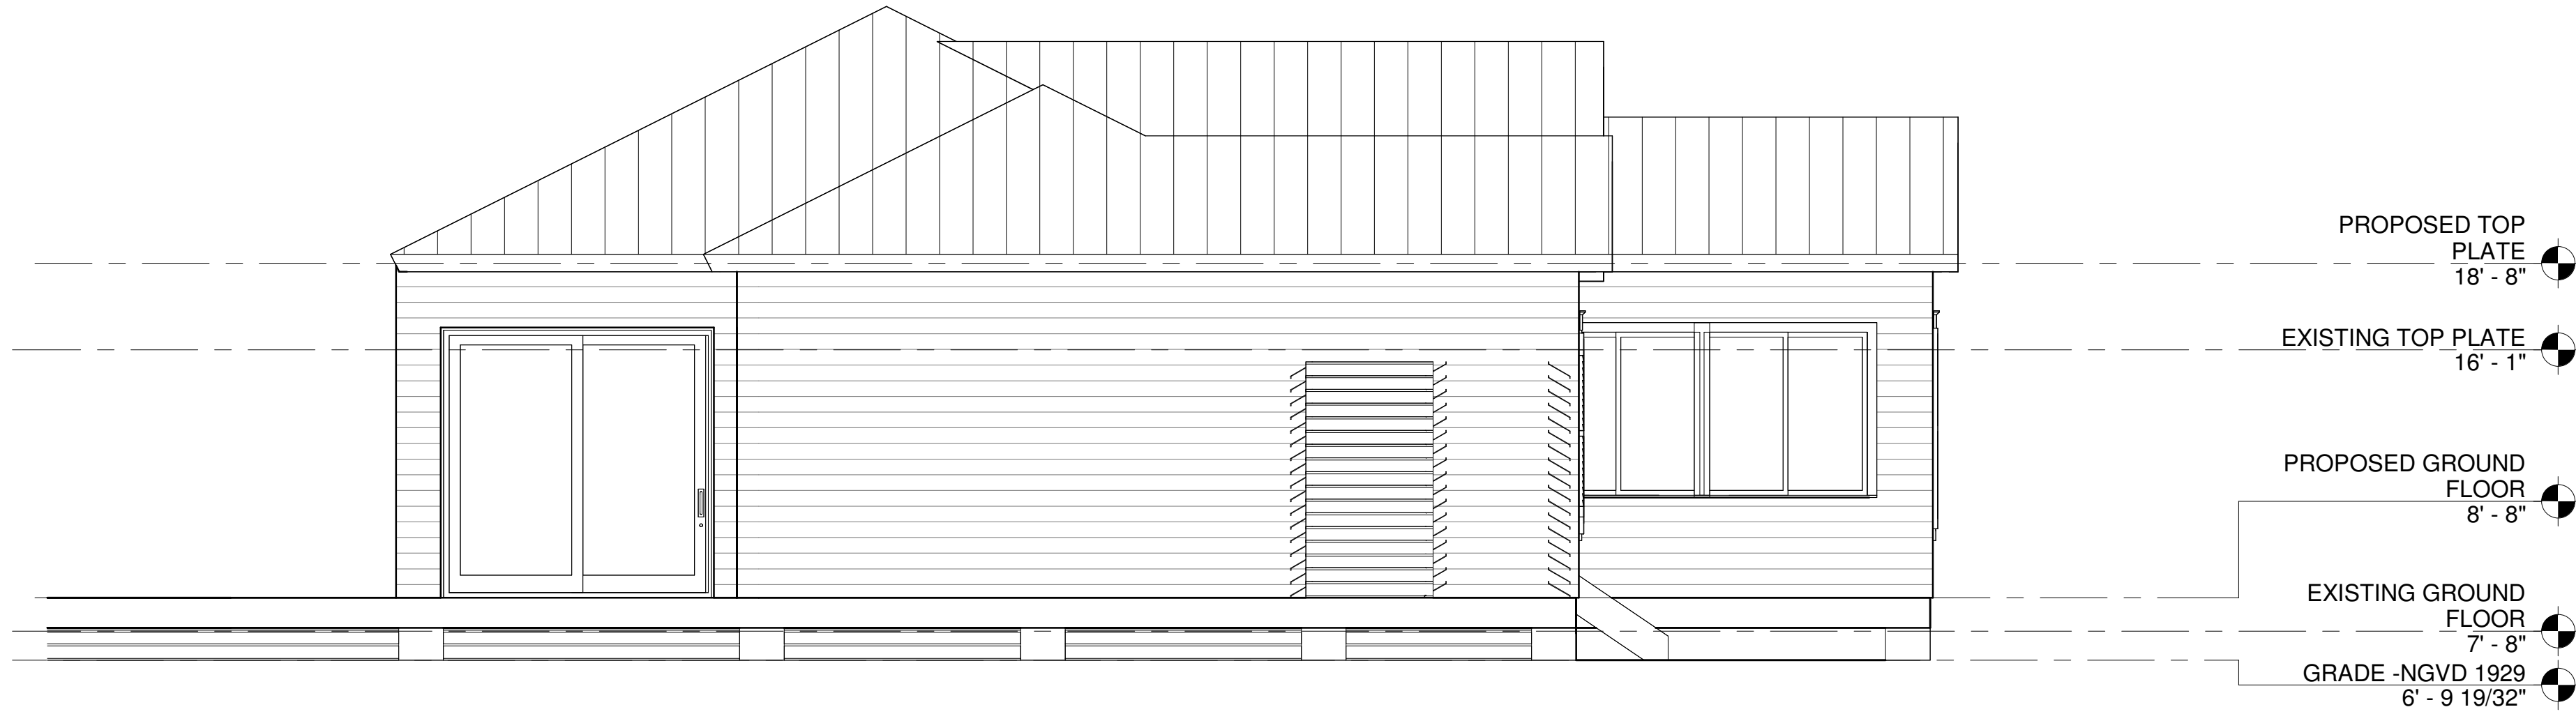

2 EAST ELEVATION - PROPOSED
A 4 1/4" = 1'-0"

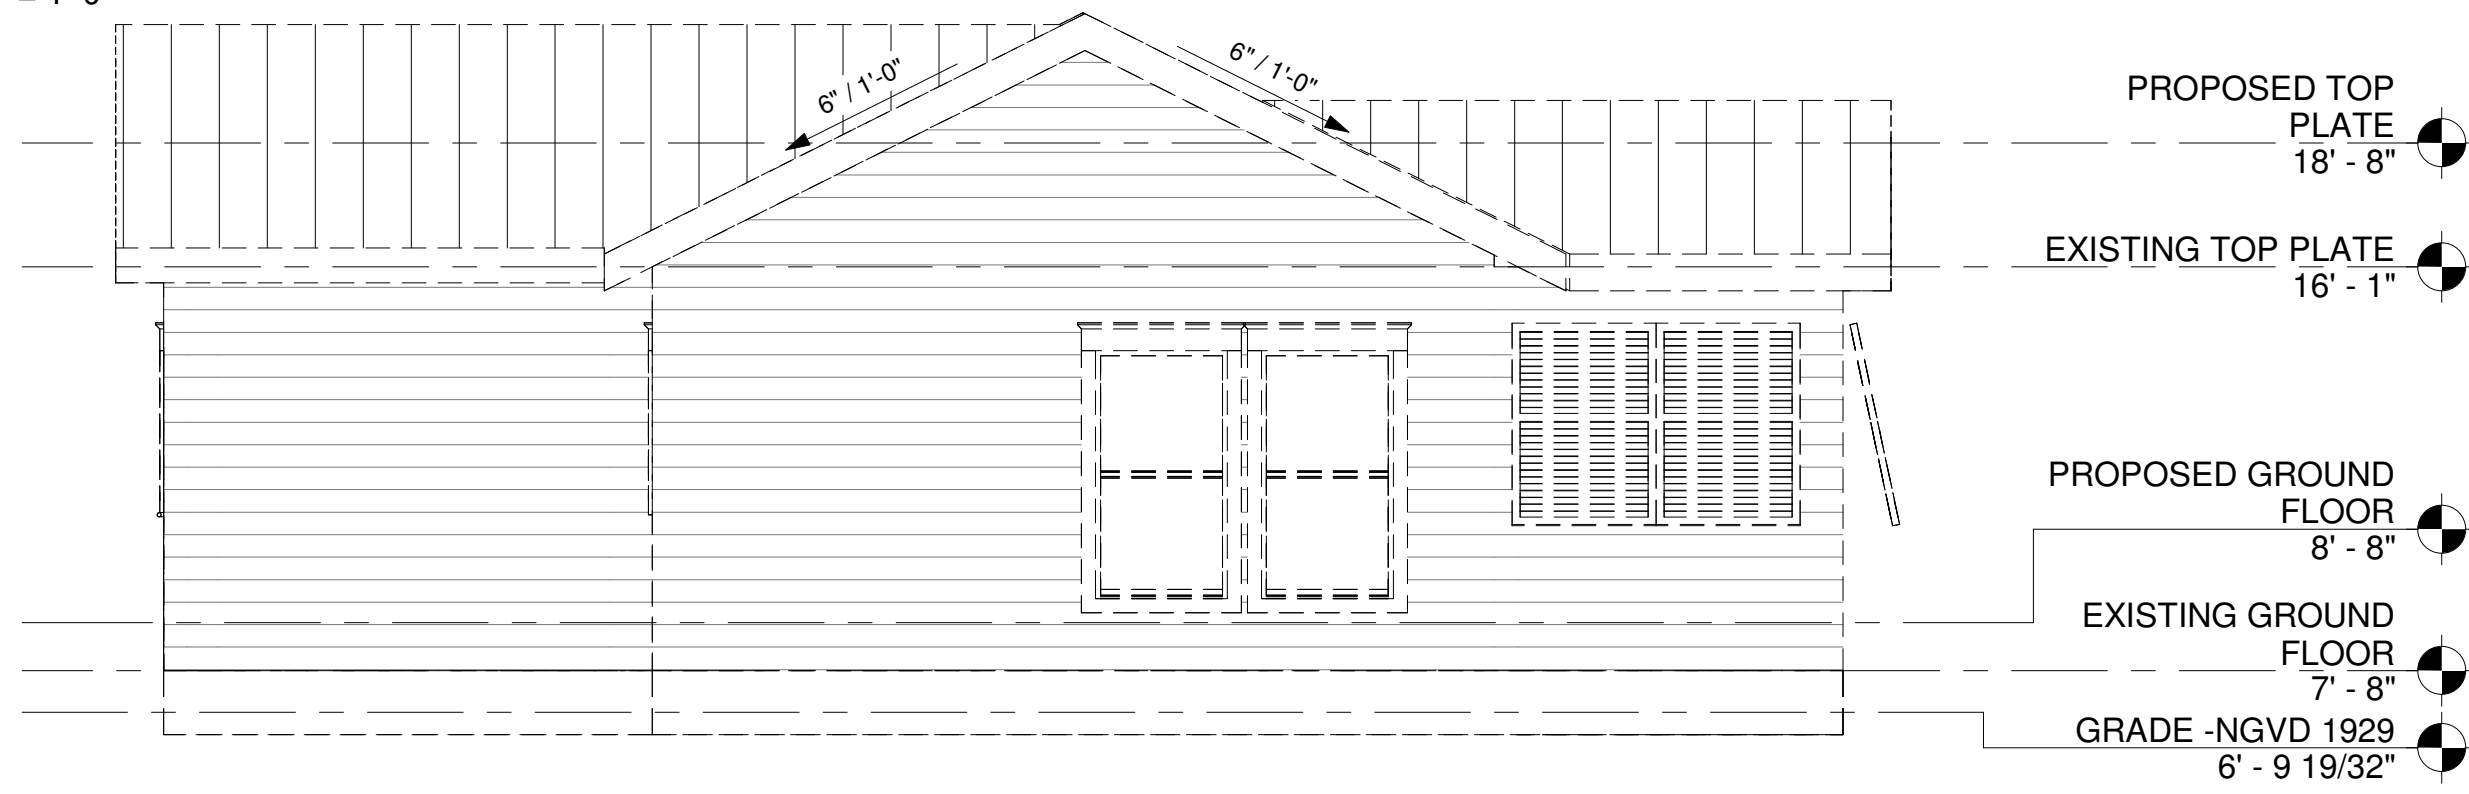

1 EAST ELEVATION - EXISTING
A 4 1/4" = 1'-0"

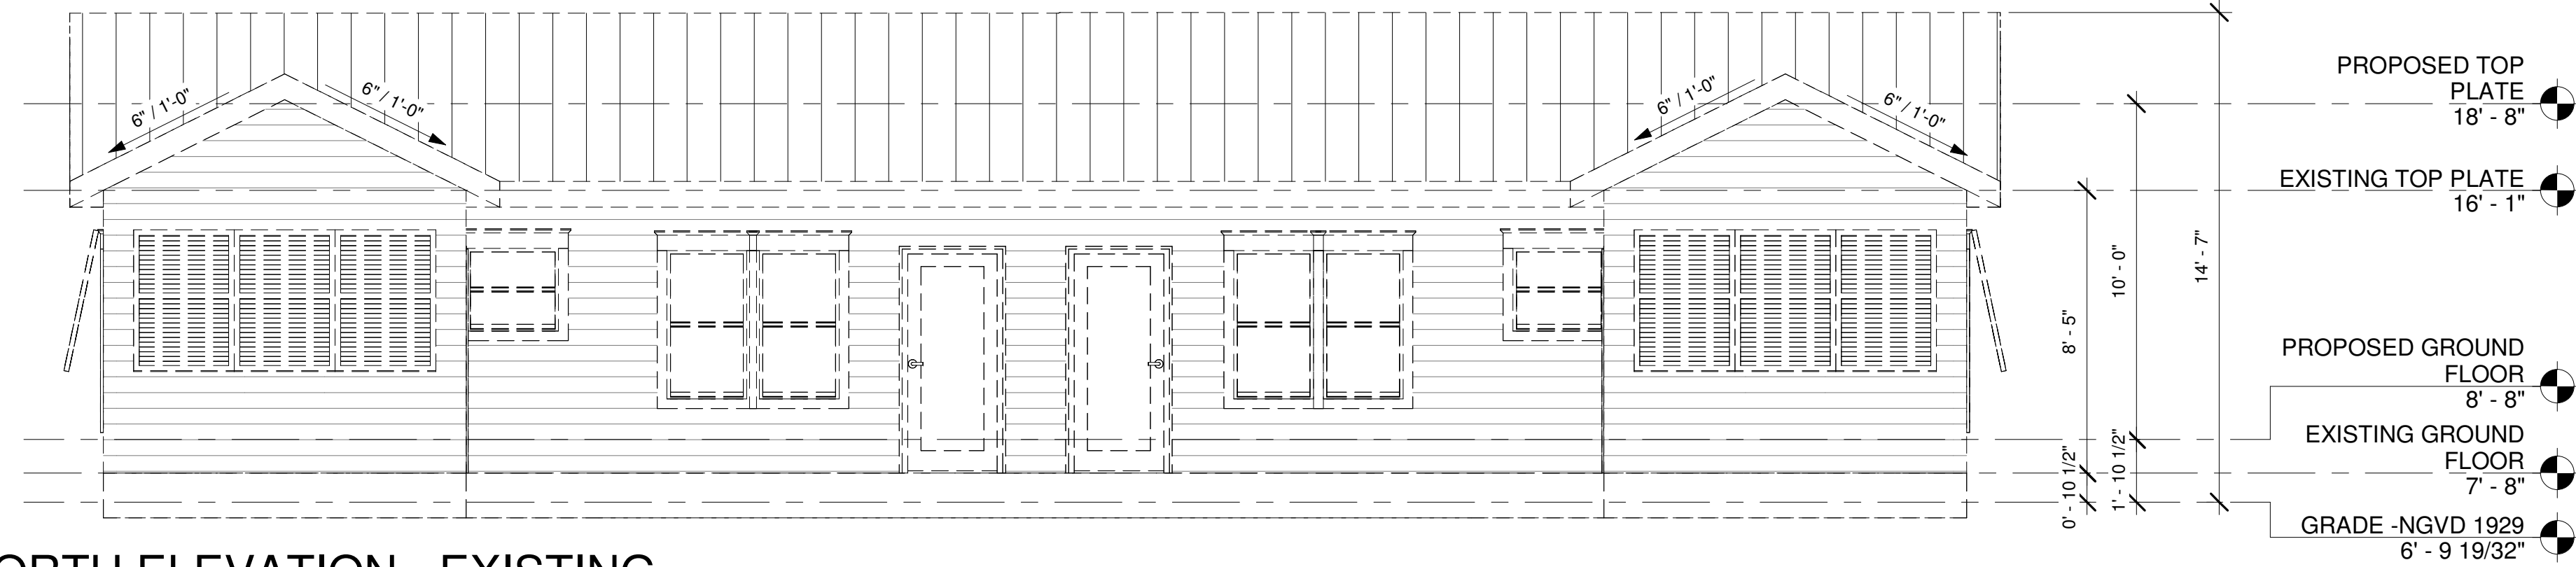

3 NORTH ELEVATION - EXISTING
A 4 1/4" = 1'-0"



4 NORTH ELEVATION - PROPOSED
A 4 1/4" = 1'-0"

DATE: 2025 04 22

REV: HARC SUBMITTAL SET

Single Family Residence
1222 Seminary Street
Key West, FL 33040

SEAL:

NOT FOR CONSTRUCTION

NOT VALID FOR CONSTRUCTION UNLESS
SIGNED/SEALED IN THIS BLOCK

ERICA HELEN POOLE - ARCHITECT
#AR98525

SANDBAR
DESIGN STUDIO
SANDBAR DESIGN STUDIO
20185 CAMEL JAIL LANE
BIG PINE KEY, FL 33043
WWW.SANDBARDESIGNSTUDIO.COM
8473935854

ELEVATIONS


SHEET TITLE

A 4

PROJECT NO:
HHB2025

DRAWN BY:
EHP

APPROVED BY:
EHP

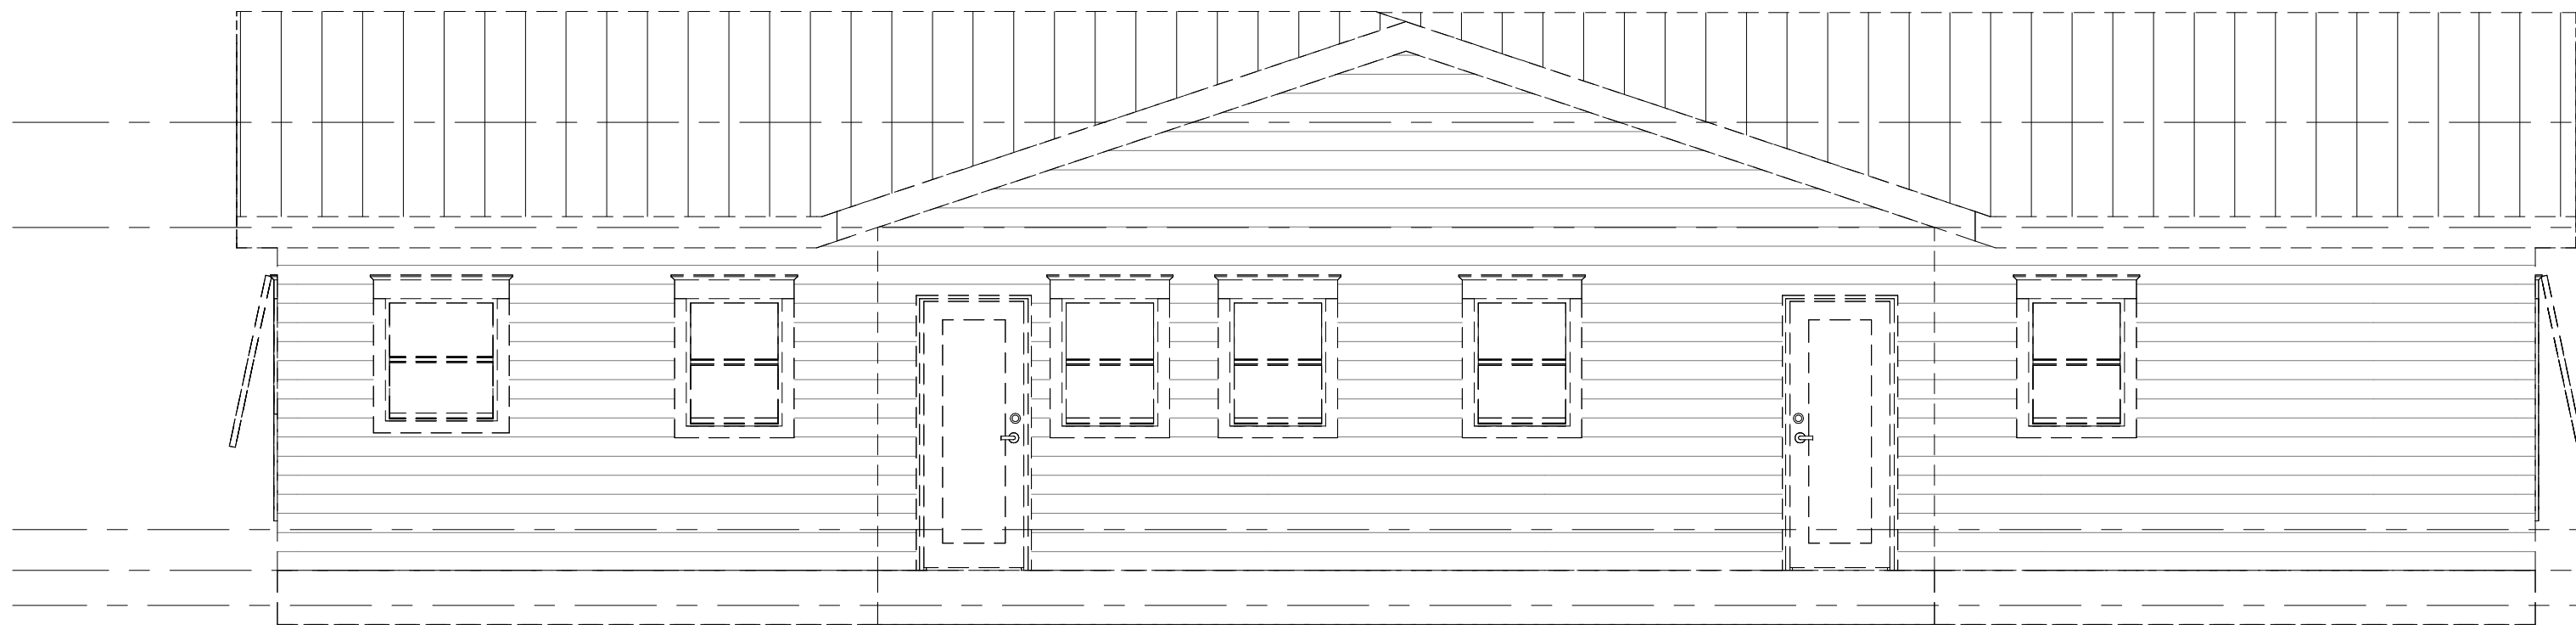

PROPOSED TOP
PLATE
18' - 8"

EXISTING TOP PLATE
16' - 1"

PROPOSED GROUND
FLOOR
8' - 8"

EXISTING GROUND
FLOOR
7' - 8"

GRADE -NGVD 1929
6' - 9 19/32"

1 SOUTH ELEVATION - EXISTING
A 5 1/4" = 1'-0"



PROPOSED TOP
PLATE
18' - 8"


EXISTING TOP PLATE
16' - 1"

PROPOSED GROUND
FLOOR
8' - 8"

EXISTING GROUND
FLOOR
7' - 8"

GRADE -NGVD 1929
6' - 9 19/32"

2 SOUTH ELEVATION - PROPOSED
A 5 1/4" = 1'-0"

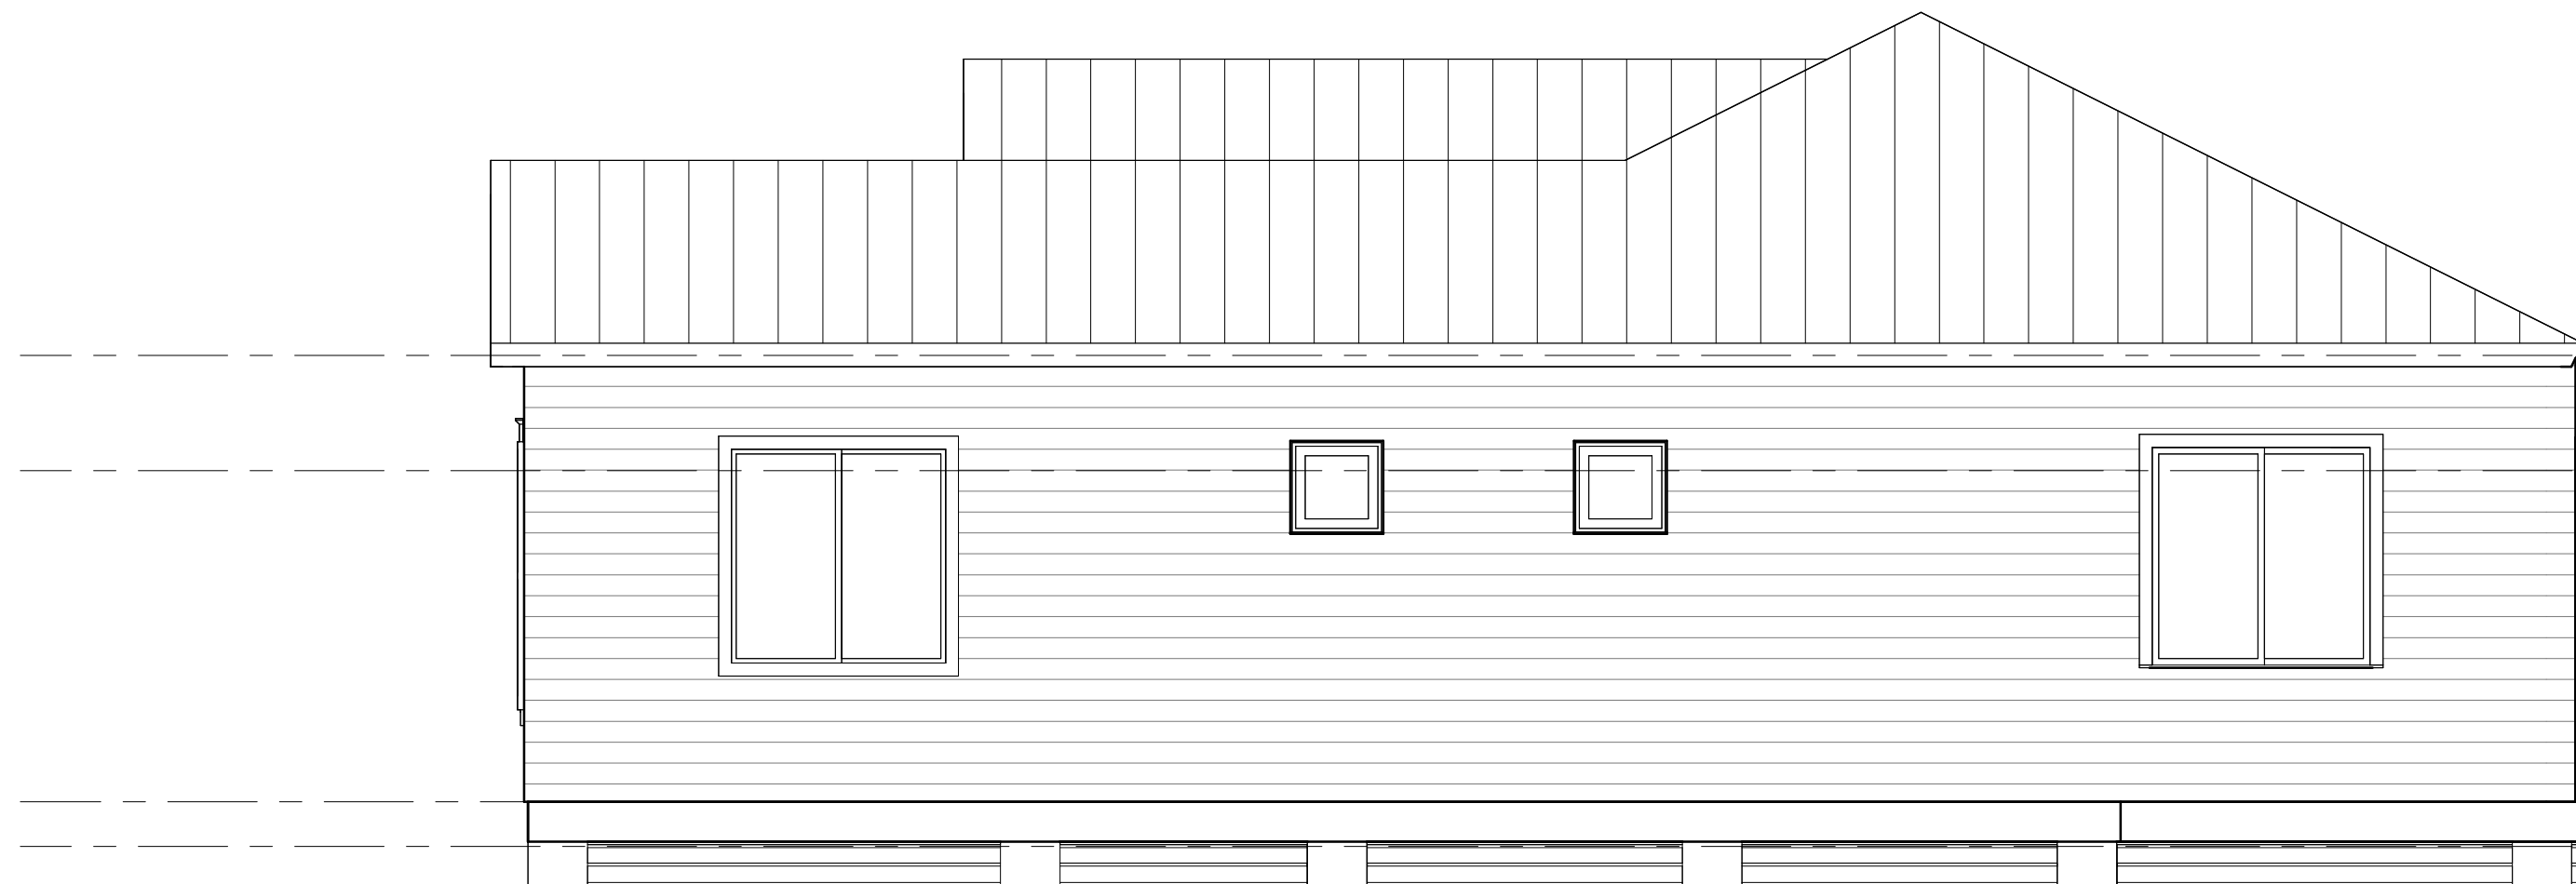

PROPOSED TOP
PLATE
18' - 8"


EXISTING TOP PLATE
16' - 1"

PROPOSED GROUND
FLOOR
8' - 8"

EXISTING GROUND
FLOOR
7' - 8"

GRADE -NGVD 1929
6' - 9 19/32"

3 WEST ELEVATION - PROPOSED
A 5 1/4" = 1'-0"

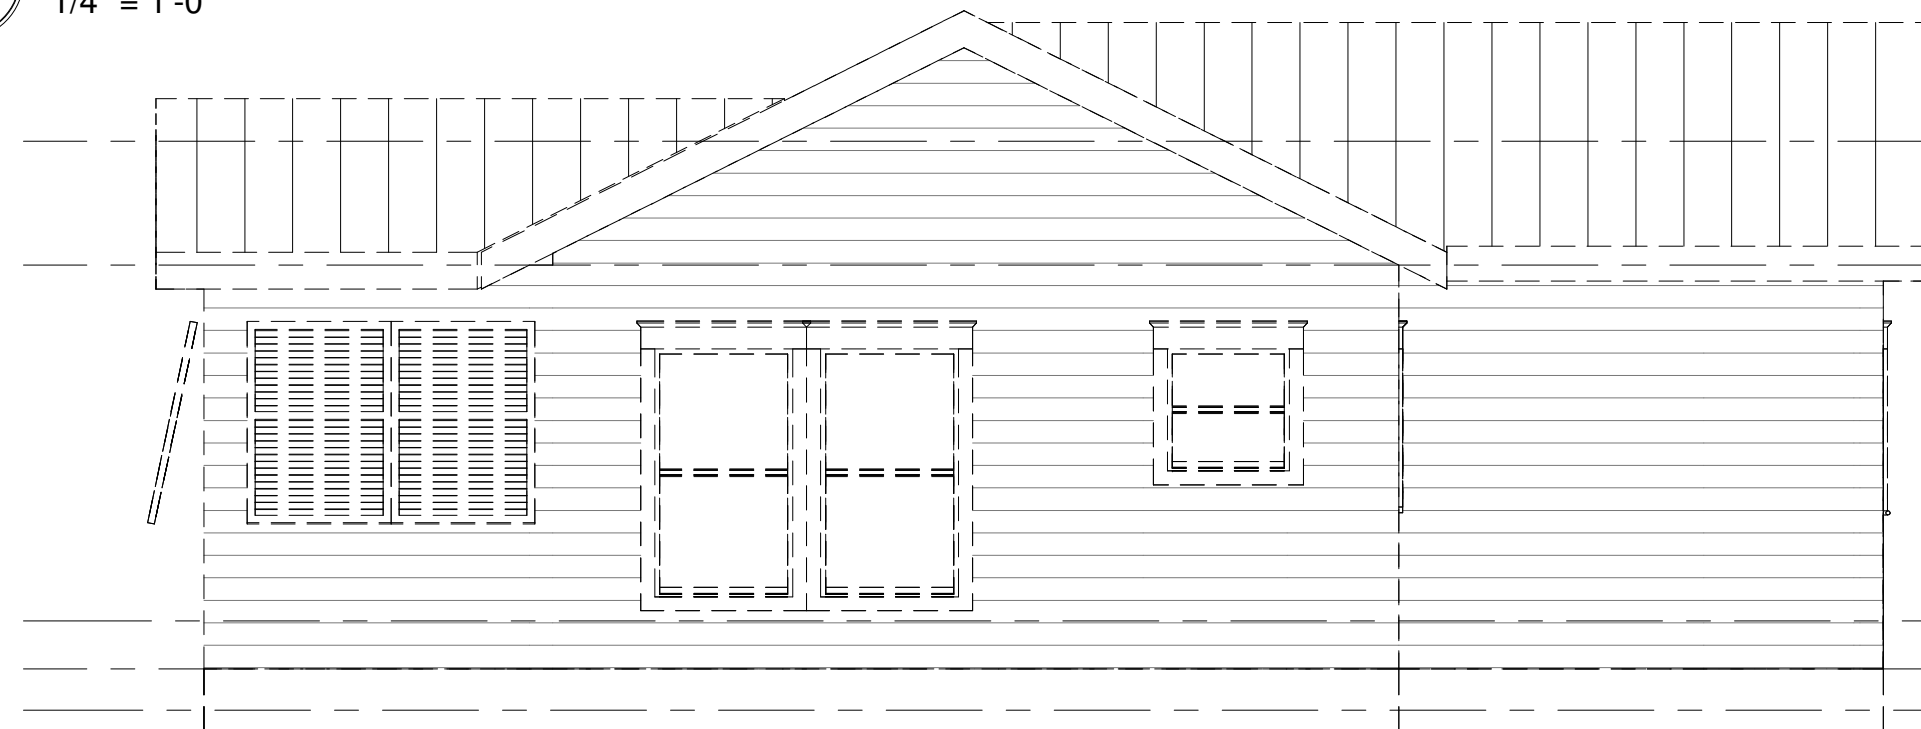

PROPOSED TOP
PLATE
18' - 8"

EXISTING TOP PLATE
16' - 1"

PROPOSED GROUND
FLOOR
8' - 8"

EXISTING GROUND
FLOOR
7' - 8"

GRADE -NGVD 1929
6' - 9 19/32"

4 WEST ELEVATION = EXISTING
A 5 1/4" = 1'-0"

DATE: 2025 04 22

REV: 1

DESCRIPTION: HARC SUBMITTAL SET

Single Family Residence
1222 Seminary Street
Key West, FL 33040

SEAL:

NOT FOR CONSTRUCTION

NOT VALID FOR CONSTRUCTION UNLESS
SIGNED/SEALED IN THIS BLOCK

ERICA HELEN POOLE - ARCHITECT
#AR98525

SANDBAR
DESIGN STUDIO
SANDBAR DESIGN STUDIO
20185 CAMEL JAIL LANE
BIG PINE KEY, FL 33043
WWW.SANDBARDESIGNSTUDIO.COM
8479035854

ELEVATIONS

SHEET TITLE

A 5

PROJECT NO:
HHB2025

DRAWN BY: Author

APPROVED BY: Checker

NOTICING

Public Meeting Notice

The Historic Architectural Review Commission will hold a public meeting at **5:00 p.m., May 27, 2025, at City Hall, 1300 White Street**, Key West, Florida. The purpose of the hearing will be to consider a request for:

**NEW SINGLE-FAMILY RESIDENCE, POOL, AND SITE IMPROVEMENTS.
DEMOLITION OF HISTORIC ONE-STORY WOOD-FRAME RESIDENTIAL
STRUCTURE, DECKS, WALKWAYS, AND POOL.**

#1222 SEMINARY STREET

Applicant – Sandbar Design Studio, Inc Application #C2025-0036

If you wish to see the application or have any questions, you may visit the Planning Department during regular office hours at 1300 White Street, call 305-809-3975 or visit our website at www.cityofkeywest-fl.gov.

THIS NOTICE CAN NOT BE REMOVED FROM THE SITE UNTIL HARC FINAL DETERMINATION

ADA ASSISTANCE: It is the policy of the City of Key West to comply with all requirements of the Americans with Disabilities Act (ADA). Please call the TTY number at 800-955-8771 or 800-955-8770 (Voice) or the ADA Coordinator at 305-809-3811 at least five business days in advance for sign language interpreters, assistive listening devices, or materials in accessible format.

HARC POSTING AFFIDAVIT

STATE OF FLORIDA:
COUNTY OF MONROE:

BEFORE ME, the undersigned authority, personally appeared Edward Flynn, who, first being duly sworn, on oath, depose and says that the following statements are true and correct to the best of his/her knowledge and belief:

1. That a legal notice for Public Notice of Hearing of the Historic Architectural Review Commission (HARC) was placed on the following address:
1222 Seminary St Key West FL 33040 on the 19 day of May, 2025.

This legal notice(s) contained an area of at least 8.5"x11".

The property was posted to notice a public hearing before the Key West Historic Architectural Review Commission to be held on May 27, 2025.

The legal notice(s) is/are clearly visible from the public street adjacent to the property.

The Certificate of Appropriateness number for this legal notice is _____.

2. A photograph of that legal notice posted in the property is attached hereto.

Signed Name of Affiant:

Edward Flynn
Date: 5-19-25
Address: 521 Margaret Street
City: Key West
State, Zip: FL 33040


The forgoing instrument was acknowledged before me on this 19 day of May, 2025.

By (Print name of Affiant) Edward Flynn who is personally known to me or has produced _____ as identification and who did take an oath.

NOTARY PUBLIC

Sign Name: Celia L. Tolle
Print Name: CELIA TOLLE

Notary Public - State of Florida (seal)
My Commission Expires: 10-2-27

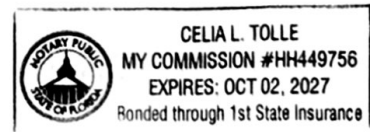



PROPERTY APPRAISER INFORMATION

Monroe County, FL

****PROPERTY RECORD CARD******Disclaimer**

The Monroe County Property Appraiser's office maintains data on property within the County solely for the purpose of fulfilling its responsibility to secure a just valuation for ad valorem tax purposes of all property within the County. The Monroe County Property Appraiser's office cannot guarantee its accuracy for any other purpose. Likewise, data provided regarding one tax year may not be applicable in prior or subsequent years. By requesting such data, you hereby understand and agree that the data is intended for ad valorem tax purposes only and should not be relied on for any other purpose.

By continuing into this site you assert that you have read and agree to the above statement.

Summary

Parcel ID 00042120-000000
 Account# 1042765
 Property ID 1042765
 Millage Group 10KW
 Location 1222 SEMINARY St, KEY WEST
 Address
 Legal KW TROPICAL BLDG AND INVESTMENT CO SUB PT LOTS 18 & 19 SQR 8 TR 19
 Description PB1-34 OR269-274 OR281-492 OR621-892 OR920-299 OR920-300 OR920-301 OR1029-1538 OR1055-116 OR1121-1168 OR2609-2151 OR2795-1765 OR3310-1412
 (Note: Not to be used on legal documents.)
 Neighborhood 6157
 Property Class MULTI-FAMILY TRIPLEX (0803)
 Subdivision Tropical Building and Investment Co
 Sec/Twp/Rng 05/68/25
 Affordable No
 Housing

**Owner**

[FC REAL ESTATE INVESTMENTS LLC](#)
 221 Simonton St
 Key West FL 33040

Valuation

| | 2024 Certified Values | 2023 Certified Values | 2022 Certified Values | 2021 Certified Values |
|----------------------------|-----------------------|-----------------------|-----------------------|-----------------------|
| + Market Improvement Value | \$252,367 | \$256,211 | \$262,461 | \$162,724 |
| + Market Misc Value | \$27,048 | \$27,729 | \$28,462 | \$29,195 |
| + Market Land Value | \$893,424 | \$814,984 | \$579,662 | \$382,896 |
| = Just Market Value | \$1,172,839 | \$1,098,924 | \$870,585 | \$574,815 |
| = Total Assessed Value | \$765,080 | \$695,527 | \$632,297 | \$574,815 |
| - School Exempt Value | \$0 | \$0 | \$0 | \$0 |
| = School Taxable Value | \$1,172,839 | \$1,098,924 | \$870,585 | \$574,815 |

Historical Assessments

| Year | Land Value | Building Value | Yard Item Value | Just (Market) Value | Assessed Value | Exempt Value | Taxable Value | Maximum Portability |
|------|------------|----------------|-----------------|---------------------|----------------|--------------|---------------|---------------------|
| 2024 | \$893,424 | \$252,367 | \$27,048 | \$1,172,839 | \$765,080 | \$0 | \$1,172,839 | \$0 |
| 2023 | \$814,984 | \$256,211 | \$27,729 | \$1,098,924 | \$695,527 | \$0 | \$1,098,924 | \$0 |
| 2022 | \$579,662 | \$262,461 | \$28,462 | \$870,585 | \$632,297 | \$0 | \$870,585 | \$0 |
| 2021 | \$382,896 | \$162,724 | \$29,195 | \$574,815 | \$574,815 | \$0 | \$574,815 | \$0 |
| 2020 | \$361,624 | \$162,724 | \$29,928 | \$554,276 | \$554,276 | \$0 | \$554,276 | \$0 |
| 2019 | \$343,968 | \$165,117 | \$30,661 | \$539,746 | \$539,746 | \$0 | \$539,746 | \$0 |
| 2018 | \$360,640 | \$167,510 | \$31,395 | \$559,545 | \$559,545 | \$0 | \$559,545 | \$0 |

The Maximum Portability is an estimate only and should not be relied upon as the actual portability amount. Contact our office to verify the actual portability amount.

Land

| Land Use | Number of Units | Unit Type | Frontage | Depth |
|----------------------|-----------------|-------------|----------|-------|
| MULTI RES DRY (080D) | 5,318.00 | Square Foot | 73 | 72 |

Buildings

| | | | |
|----------------|-------------------------|--------------------|--------------------|
| Building ID | 3299 | Exterior Walls | ABOVE AVERAGE WOOD |
| Style | 1 STORY ELEV FOUNDATION | Year Built | 1948 |
| Building Type | M.F. - R3 / R3 | EffectiveYearBuilt | 2007 |
| Building Name | | Foundation | CONCR FTR |
| Gross Sq Ft | 1767 | Roof Type | GABLE/HIP |
| Finished Sq Ft | 1268 | Roof Coverage | METAL |
| Stories | 1 Floor | Flooring Type | CONC S/B GRND |
| Condition | GOOD | Heating Type | FCD/AIR DUCTED |
| Perimeter | 168 | Bedrooms | 3 |
| Functional Obs | 40 | Full Bathrooms | 3 |
| Economic Obs | 0 | Half Bathrooms | 0 |
| Depreciation % | 24 | Grade | 550 |
| Interior Walls | WALL BD/WD WAL | Number of Fire Pl | 0 |

| Code | Description | Sketch Area | Finished Area | Perimeter |
|--------------|----------------|--------------|---------------|-----------|
| FLA | FLOOR LIV AREA | 1,268 | 1,268 | 0 |
| OPU | OP PR UNFIN LL | 55 | 0 | 0 |
| OPF | OP PRCH FIN LL | 312 | 0 | 0 |
| SPF | SC PRCH FIN LL | 132 | 0 | 0 |
| TOTAL | | 1,767 | 1,268 | 0 |

Yard Items

| Description | Year Built | Roll Year | Size | Quantity | Units | Grade |
|-------------|------------|-----------|--------|----------|--------|-------|
| FENCES | 1959 | 1960 | 0 x 0 | 1 | 508 SF | 3 |
| FENCES | 1988 | 1989 | 0 x 0 | 1 | 408 SF | 2 |
| WOOD DECK | 1988 | 1989 | 0 x 0 | 1 | 874 SF | 2 |
| TILE PATIO | 1993 | 1994 | 0 x 0 | 1 | 196 SF | 4 |
| FENCES | 1994 | 1995 | 4 x 82 | 1 | 328 SF | 2 |
| RES POOL | 1999 | 2000 | 0 x 0 | 1 | 294 SF | 4 |

Sales

| Sale Date | Sale Price | Instrument | Instrument Number | Deed Book | Deed Page | Sale Qualification | Vacant or Improved | Grantor | Grantee |
|-----------|-------------|-----------------|-------------------|-----------|-----------|--------------------|--------------------|---------|---------|
| 1/31/2025 | \$1,200,000 | Warranty Deed | 2488671 | 3310 | 1412 | 01 - Qualified | Improved | | |
| 5/2/2016 | \$655,000 | Warranty Deed | | 2795 | 1765 | 02 - Qualified | Improved | | |
| 4/28/2016 | \$100 | Quit Claim Deed | | 2795 | 1763 | 11 - Unqualified | Improved | | |
| 1/23/2013 | \$100 | Quit Claim Deed | | 2609 | 2151 | 11 - Unqualified | Improved | | |
| 10/1/1987 | \$145,000 | Warranty Deed | | 1029 | 1538 | U - Unqualified | Improved | | |


Permits

| Number | Date Issued | Status | Amount | Permit Type | Notes |
|---------|-------------|-----------|---------|-------------|--|
| 25-0251 | 02/05/2025 | Active | \$0 | Residential | Demo 3 kitchens, 3 baths, interior exploratory. |
| 11-1597 | 05/17/2011 | Completed | \$6,200 | Residential | RE-PAINT CONCRETE COPING, NEW TILE CERAMIC (COLBALT BLUE) AND REPLASTER. |
| 06-4357 | 07/17/2006 | Completed | \$1,145 | Residential | INSTALL 7 GFL'S & 3 SMOKE DETECTORS. |
| 03-2275 | 06/27/2003 | Completed | \$6,000 | Residential | INSTALLED SEWER LATERAL |
| 9903921 | 12/03/1999 | Completed | \$2,300 | Residential | RESURFACE POOL |
| A951359 | 04/01/1995 | Completed | \$1,200 | Residential | PICKET FENCE |

View Tax Info

[View Taxes for this Parcel](#)

Sketches (click to enlarge)

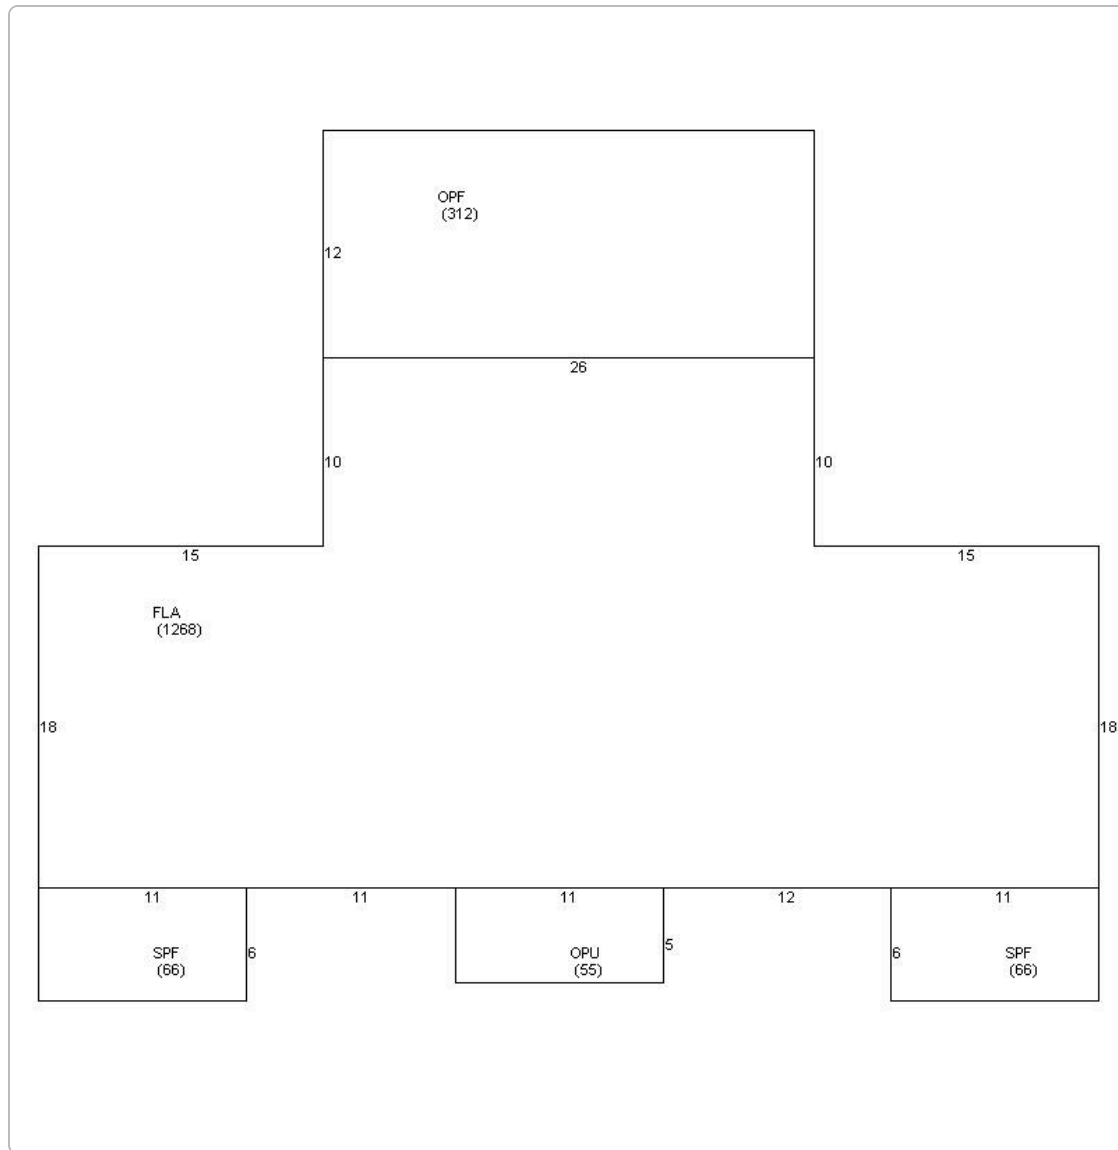


Photos





Map

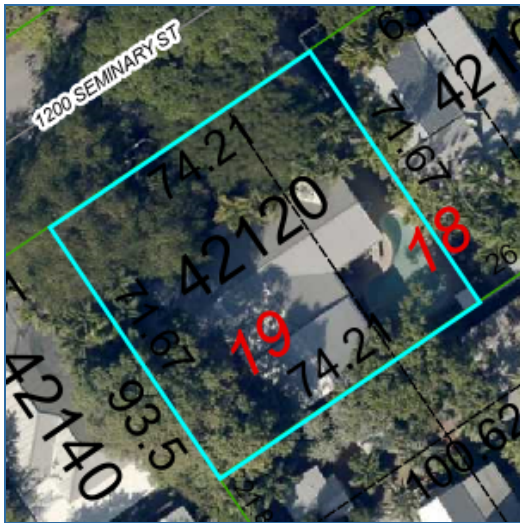

TRIM Notice



[User Privacy Policy](#) [GDPR Privacy Notice](#)
Last Data Upload: 4/16/2025, 1:47:17 AM