

### For In-House Use Only

This proposal is presented by Rep Services, Inc.

Proposed City of Key West

To:

Attn:

Public Works 633 Palm Avenue Key West, FL 33040-4602 Ship TBD at a later date

To:

Bill City of Key West

To: Public Works 633 Palm Avenue Key West, FL 33040-4602

Attn: Richard Sarver Attn: Richard Sarver

6/13/2025

Project No: 21667 Proposal No: 21667.01 **Project Name:** Proposal Name: Proposal Expires: Key West Shelters Various Shelters Key West **Project Contact:** Richard Sarver **Project Location:** 

3420 Northside Dr Key West, FL 33040

Project County: Monroe

5/13/2025 Proposal Date:

**General Terms of Sale and Proposal Summary** 

Proj Drawings: Engr-permit  cription  yon Shelter Model: REK 16x24 any Roof: PBR ondary Roof: N/A ber of Columns 4 e Height (UPB): 8 er Roof Slope: 4/12 trical Cutout: yes trical Access: 4 mentation: N/A der Coat over Galvanized Finish d for Exposure D uning Protection: N/A	<b>Unit Price</b> 45,140.00	602883 Ext Price 45,140.00
on Shelter Model: REK 16x24 ary Roof: PBR ondary Roof: N/A ber of Columns 4 e Height (UPB): 8 er Roof Slope: 4/12 trical Cutout: yes trical Access: 4 imentation: N/A der Coat over Galvanized Finish d for Exposure D		
ary Roof: PBR ondary Roof: N/A ber of Columns 4 Height (UPB): 8 er Roof Slope: 4/12 trical Cutout: yes trical Access: 4 imentation: N/A der Coat over Galvanized Finish d for Exposure D	45,140.00	45,140.00
nor Bolts Included Florida Building Code 8th Edition neering to comply with HVHZ: Yes		
Product Subtotal: Discount per the Sourcewell (NJPA) Purchasing Contract #012621-PPC Discounted Product Total:	8%	\$45,140.00 (\$3,611.20) \$41,528.80
Electronic of Signed & Sealed Engineering:  ht: Prepaid Ship Method: Best Way FOB: Destination Freight Charge  Poligon Total:		\$1,000.00 \$6,350.00 \$48.878.80
Proj Drawings: Engr-permit	- Buryllia	602884
cription	Unit Price	Ext Price
ary Roof: PBR ondary Roof: N/A ber of Columns 8 e Height (UPB): 8 er Roof Slope: 5/12 trical Cutout: 4 trical Access: Yes imentation: N/A der Coat over Galvanized d for Exposure D ching Protection: N/A nor Bolts Included yes it Florida Building Code 8th Edition	59,525.00	59,525.00
Product Subtotal:	00/	\$59,525.00
Discount per the Sourcewell (NJPA) Purchasing Contract #012621-PPC Discounted Product Total:	8%	(\$4,762.00) \$54,763.00
		\$1,000.00 \$3,000.00
Discount per the Sourcewell (NJPA) Purchasing Contract #012621-PPC		

Proposal No: 21667.01 Project Name: Key West Shelters Proposal Date: 5/13/2025 Page 2 of 3

Net 30

 Product:
 \$98,291.80

 Freight:
 \$9,350.00

 Proposal Total:
 \$107,641.80

### **Notes**

Sourcewell Purchasing Contract #012621-PPC for Poligon: 8% discount off of product list price. All structures in Florida exceed the standard wind load conditions, and are therefore not included in the Sourcewell price list. The contract limits installation to 42% of the list price, before discount. Site preparation, concrete, engineered footings and freight are not subject to the Sourcewell contract.

Basis of Proposal:

Our proposal is based upon a request for shelters. Email request to Manufacturer 4/3/2024 requesting a REK 16x24 and OTC 16x24 for equipment only.

### Proposal includes:

- Supply of equipment requested
- · Freight to site
- · Engineering for structure

### Proposal excludes

- Offloading, assembly, foundations and installation of shelters
- · permit filing and permit fees

Please note the vendor information itemized below.

If a performance and payment bond is required, add 3% to the proposal total.

If a owner controlled insurance program (OCIP) is required, add 2% to the proposal total.

Also, please be aware that we generate separate invoices for product at the time of delivery. If your project should include products from multiple manufacturers, each will be invoiced and taxed separately. If you require consolidated invoices, please alert your sales team.

### Estimated project completion schedule

(This schedule starts when all required information for engineering has been gathered.)

- 8 Weeks: Shelter Engineering
- 4 Weeks: Submittal Approval
- 17 Weeks Longest manufacturing lead time. (Typical for scheduling.)
- 1 Week Shipping
- 30 Weeks TOTAL

Note that RSI is committed to do all it can to meet the needs of your project.

This proposal is for material, freight, and applicable tax only. Any building permits, engineering, unloading, assembly, installation, site preparation and surfacing are by others. Drivers will not unload the shipment. Purchaser must make arrangements for unloading of playground or exercise equipment, shade, and shelter product lines. In most circumstances this will require a forklift. For certain site furnishing orders, a lift gate and pallet jack may be available for an additional fee. Please alert your sales team of this need.

### Poligon by PorterCorp:

- Porter units are designed to meet 2023 Florida Building Code 8th Edition.
- Please provide Building Department permit application requirements including Risk Category.
- The following certificates are available:
  - Miami-Dade County Certificate of Competency No. 23-0915.11
  - PCI (Powder Coating Institute) 4000 Certified
  - · American Institute of steel construction quality management systems certified
- Four sets of signed and sealed drawings and calc books for building permitting will be provided. If additional sets of drawings and calc books are
  required, additional fees will apply.

Electrical Cutout: Selections to be made at time of electrical cut out submittal approval

### **Color Selection:**

To be made at time of color submittal approval

Can find standard roofing and frame color selections here: <a href="https://poligon.com/shelter-option/frame-roof-colors/">https://poligon.com/shelter-option/frame-roof-colors/</a>

Non-Standard colors and finishes are available at an additional charge

### Warranty

The 10-year limited warranty excludes buildings erected at sites where salt air, corrosive environment, high humidity, or sprinkler systems come in contact with the shelter.

Failure to maintain the finished system with annual touch-ups and documented maintenance procedures will void the limited warranty. See Poligon warranty document for full details and terms.

Terms Porter Billing

Porter requires a 50% deposit with the order before fabrication can begin. Balance net 15 with credit approval.

### **Time Limitations Holding Prices Firm:**

Orders are shipped within our manufacturer's standard lead times. Requests for delayed shipping may result in additional costs due to increases in freight, material costs or other factors. To secure the prices on this proposal, the offer must be accepted prior to the expiration date noted.

If, during the performance of this contract, the price of a product increases 3% or more as documented by factory quotes, invoices or receipts to contractor (Rep Services, Inc.) from the date of the contract signing the price of shall be equitably adjusted by an amount reasonably necessary to cover such price

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increases. Where the delivery of a product is delayed, through no fault of contractor (RSI) as a result of the shortage or unavailability of a product, contractor (RSI) shall not be liable for any additional costs or damages associated with such delay(s).

The undersigned warrants that he/she is an authorized representative of the City of Key West noted and has the requisite authority to bind the City of Key West and/or principal.

Accepted By: City of Key West	XXXXXXXXXXXXXXXXXXXXXXXXXXXXXXXXXXXXXXX			
Company Name	Authorized By	Printed Name	Date	
As Its:	(Title)			



## PROJECT:

LOCATION:

**BUILDING TYPE: OTC-24** 

ROOF TYPE: **MULTI-RIB** 

ORDER NUMBER:

BUILDING NUMBER:

QUOTE NUMBER:

# DRAWING LIST:

# CERTIFICATES: MAMI-SADE COUNTY CERTIFICATE OF COMPETENCY NO. 21-0819.13 PCI (POWDER COATING INSTITUTE) 4000 CERTIFIED

FABRICATOR APPROVALS:

OTY OF PHOENIX. AZ APPROVED FABRICATOR #C08-2010
OTY OF LOS ANGELES, CA APPROVED FABRICATOR #E001596
CITY OF RIVERSIDE, CA APPROVED FABRICATOR #SE 000042
CITY OF HOUSTON, TX APPROVED FABRICATOR #20
CLARK COUNTY, NV APPROVED FABRICATOR #24
STATE OF ULH APPROVED FABRICATOR #264
STATE OF ULH APPROVED FABRICATOR #264
STATE OF ULH APPROVED FABRICATOR #264
STATE OF UTH APPROVED FABRICATOR #264

DESCRIPTION
TUBE STEEL
SCHEDULE PIPE
RMIT PIPE
LIGHT GAGE COLD FORMED
STRUCTURAL STEEL PLATE
ROOF PANELS (STEEL) ASTM DESIGNATION A500 (GRADE B) A53 (GRADE B) A519 A103 (GRADE 50) A36 A653

NOT FOR CONSTRUCTION USE FOR PRELIMINARY
PLANNING AND ESTIMATING
ONLY

STOPII

MATERIALS:

19.13

GENERAL NOTES:
UNLESS NOTED OTHERWISE. THIS STRUCTURE WAS DESIGNED TO UNLESS NOTED OTHERWISE. THE SERVINGS THE ONLY SUPPORT WHAT IS SHOWN ON THESE DRAWFINGS. THE MANUFACTURER MUST BE CONTACTED FAVYTHING I.SE IS TO BE ATTACHED TO THIS STRUCTURE (WALLS COLUMN WRAPS, RAULINGS, POSSIBLY REVISION OF THIS STRUCTURE CAN BE REVIEWED AND POSSIBLY REVISION.

UNLESS NOTED OTHERWISE, THIS STRUCTURE WAS DESIGNED ASSUMING A 20' SEPARATION BETWEEN ARY ADJACEN I STRUCTURE WITH AN EAVE HEIGHT COULT, TO OR GREATER THAN THE EAVE HEIGHT OF THIS STRUCTURE, IF THAT SEPARATION DOES NOT EXIST, THE MANUFACTHER MUST BE CONTACTED SO THE DESIGN OF THIS STRUCTURE OF THE SOTH OF THIS STRUCTURE OF THE SOURCE OF THIS STRUCTURE ON THE CAN BE REVIEWED AND POSSIBLY REVISED.

STRUCTUPAL STEEL SHALL BE DETAILED, PABRICATIED, AND ERECTED IN ACCORDANCE WITH THE LATEST EDITION OF THE AMERICAN INSTITUTE OF STEEL CONSTRUCTION (AISC) SPECIFICATION MANUAL.

ALL, WELDING IS PERFORNED BY AMERICAN WELDING SOCIETY (AWS) CERTIFIED WELDERS AND CONFORMS TO THE LATEST EDIT OF AWS D1.1 OR D1.3 AS REQUIRED.


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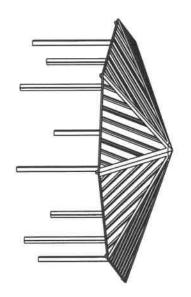
FOR PROPER FIELD INSTALL RECOMMENDED THAT THE FIROOF INSTALLER HAVE A MI

FOR PROPER FIELD INSTALLATION OF THE BUILDING IT IS RECOMMENDED THAT ELECTRIC WHINIG, IF REQUIRED, BE RUN THROUGH THE STRUCTURAL MEMBERS BEFORE THE BUILDING IS ERECTED.

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PROJECT:	PRINT DATE: 12/21/2023	Chris.lisac	AO2	a oligoos
또 PROJECT LOCATION:	JOB NO:		1:48	POHGOTI WWW.POLIGON.COM
COVER SHEET	CAD MODEL: E1W-OTC-24MR			MAIN: (616) 888-3500 by PORTER CORP FIELD SUPPORT: (616) 888-3504



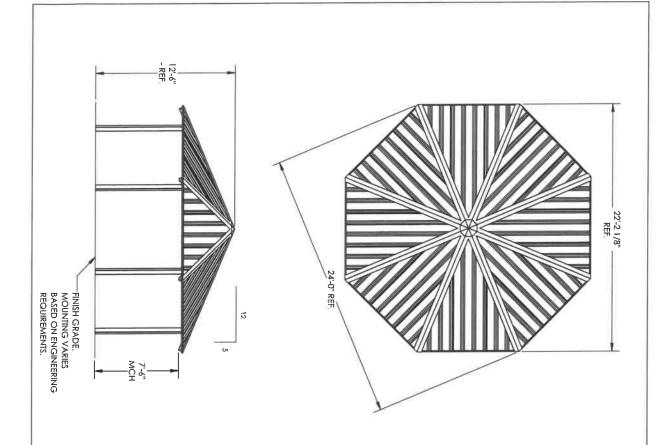

## SCALE SCALE 1:65 In the second of the secon STOP!! NOT FOR CONSTRUCTION USE FOR PRELIMINARY PLANNING AND ESTIMATING ONLY

SHEET

# GENERAL ROOF NOTES:

METAL ROOFING:

24 GAUGE

4 GAUGE


4 GAUGE


500 PAINTED

TRIM COLOR MATCHES ROOF

SEE POLICON COM FOR

COLOR OPTIONS

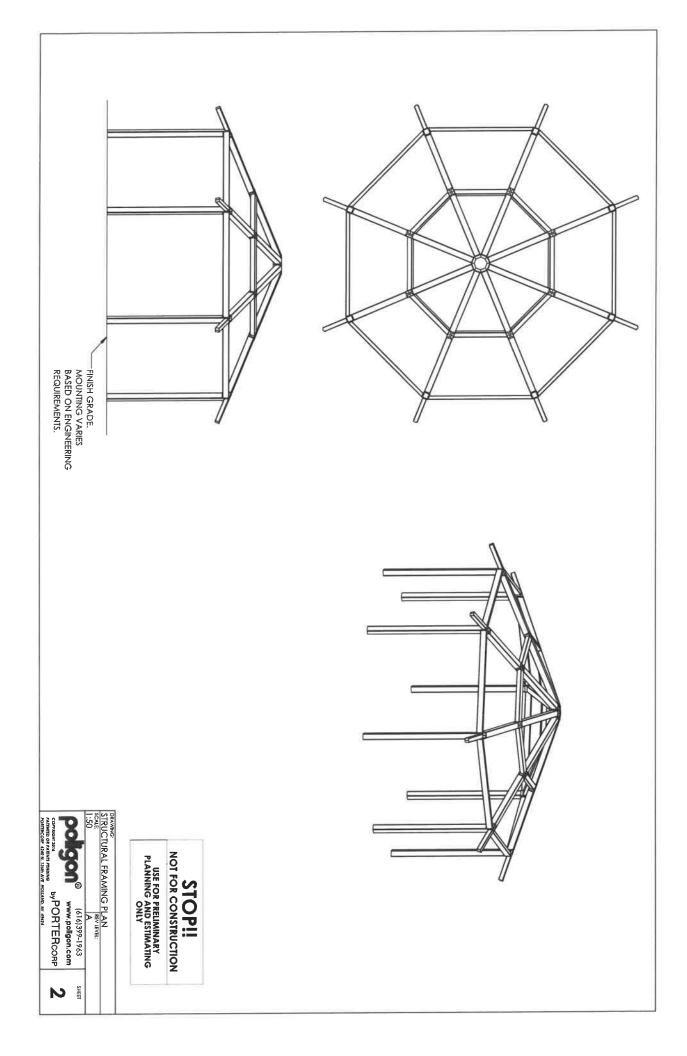

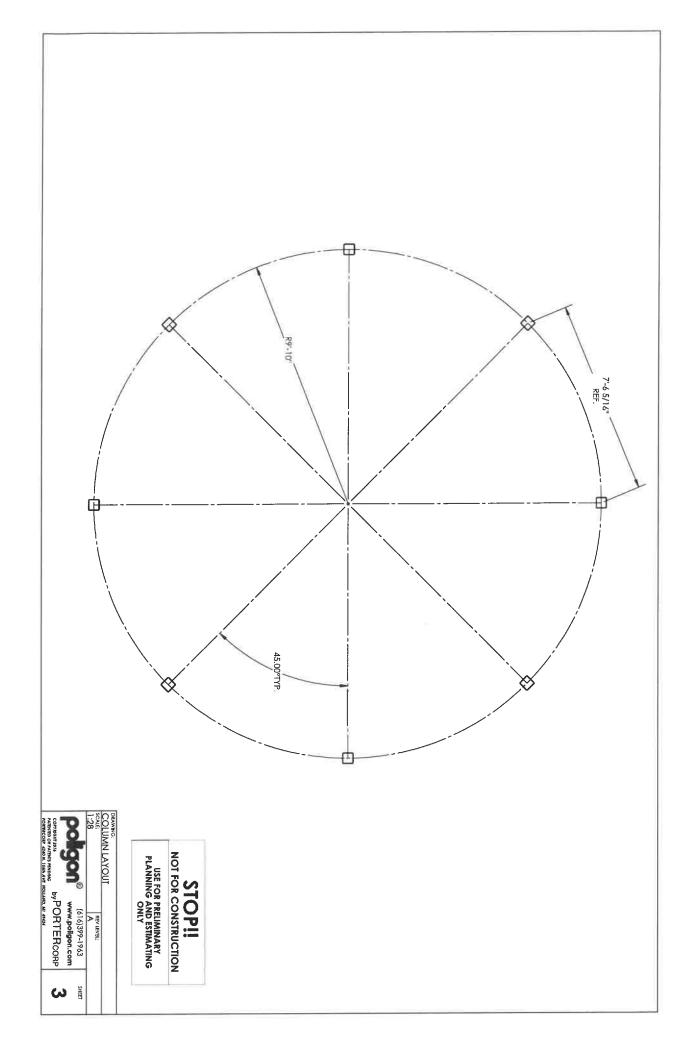



# PROJECT:

LOCATION:

BUILDING TYPE: **REK 16x24** 

ROOF TYPE: MULTI-RIB

BUILDING NUMBER:

ORDER NUMBER:

QUOTE NUMBER:

DRAWING LIST:

COLUMN LAYOUT	ω	
STRUCTURAL FRAMING PLAN	2	
ARCHITECTURAL ELEVATIONS	1	
COVER SHEET	S	
SHEET NUMBER DRAWING DESCRIPTION	SHEET NUMBER	



EABRICATOR APPROVALS:
CITY OF PHOENIX, AZ APPROVED FABRICATOR #C08-2010
CITY OF PHOENIX, AZ APPROVED FABRICATOR #F8010
CITY OF LOS ANGELES, CA APPROVED FABRICATOR #SF 2000
CITY OF RIVERSIDE, CA APPROVED FABRICATOR #370
CITY OF HOUSTON, TA APPROVED FABRICATOR #264
STATE OF UNITY, NIV APPROVED FABRICATOR #264
STATE OF UNITY APPROVED FABRICATOR 2008-14
AISC APPROVED FABRICATOR 2008-13 CERTIFICATES:
MIAMI-DADE COUNTY CERTIFICATE OF COMPETENCY NO. 21-0819.13
PCI (POWDER COATING INSTITUTE) 4000 CERTIFIED

GENERAL NOTES:
UNLESS NOTED THERWISE. THIS STRUCTURE WAS DESIGNED TO UNLESS NOTED TO THE WAS DESIGNED TO UNLY SUPPORT WHAT IS SHOWN ON THESE DRAWNOSS. THE MANUFACTURER MUST BE CONVENTED FO ANYTHING ELSE IS TO BE ATTACHED TO THIS STRUCTURE (WALLS COLUMN WRAPS RAULINGS. ETC.) SO THE DESIGN OF THIS STRUCTURE CAN BE REVIEWED AND POSSIBLY REVISED.

UNLESS NOTED OTHERWISE THIS STRUCTURE WAS DESIGNED ASSUMING A 20' SEPARATION BETWEEN ANY ADJACENT IS TRUCTURE WITH AN EAVE HEIGHT EQUAL TO OR GREATER THAN THE EAVE HEIGHT OF THIS STRUCTURE. IF THAT SEPARATION DOES NOT EXIST, THE MANUFACTURER MIST BE CONTACTED SO THE DESIGN OF THIS STRUCTURE THE APPROVED SO THE DESIGN OF THIS STRUCTURE CAN BE REVIEWED AND POSSIBLY REVISED.

STRUCTURAL STEEL SHALL BE DETAILED, FABRICATED, AND ERECTED IN ACCORDANCE WITH THE LATEST EDITION OF THE AMERICAN INSTITUTE OF STEEL CONSTRUCTION (AISC) SPECIFICATION MANUAL.

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PLANNING AND ESTIMATING
ONLY

DESCRIPTION
TUBE STEEL
SCHEDULE PIPE
RMT PIPE
LIGHT GAGE COLD FORMED
STRUCTURAL STEEL PLATE
ROOF PANELS (STEEL)

ASTM DESIGNATION A500 (GRADE B) A53 (GRADE B) A519 A1003 (GRADE 50) A36 A36

**STOP!!** 

MATERIALS:

ALL WELDING IS PERPORMED BY AMERICAN WELDING SOCIETY (AWS) CERTIFIED WELDERS AND CONFORMS TO THE LATEST EDITION OF AWS D1.1 OR D1.3 AS REQUIRED.

PARTIS SHOWN MAY BE UPGRADED DUE TO STANDARDIZED FABRICATION. REFER TO THE SHIPPING BILL OF MATERIALS FOR POSSIBLE SUBSTITUTIONS.


FOR PROPER FIELD INSTALLATION OF THE BUILDING IT IS RECOMMENDED THAT THE PRIMARY FRAME INSTALLER AND THE ROOF INSTALLER HAVE A MINIMUM FYEE BY YEARS DOCUMENTED EXPERIENCE INSTALLING THIS TYPE OF PRODUCT.


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Ħ	DRAWING: COVER SHEE


CS

FOR PROPER FIELD INSTALLATION OF THE BUILDING IT IS RECOMMENDED THAT ELECTRIC WIRING, IF REQUIRED, BE RUN THROUGH THE STRUCTURAL MEMBERS BEFORE THE BUILDING IS ERECTED. PRINT DATE: 12/27/2023 JOB NO: chris.lisac CAD MODEL: REK-16X24-E1W.SLDPRT



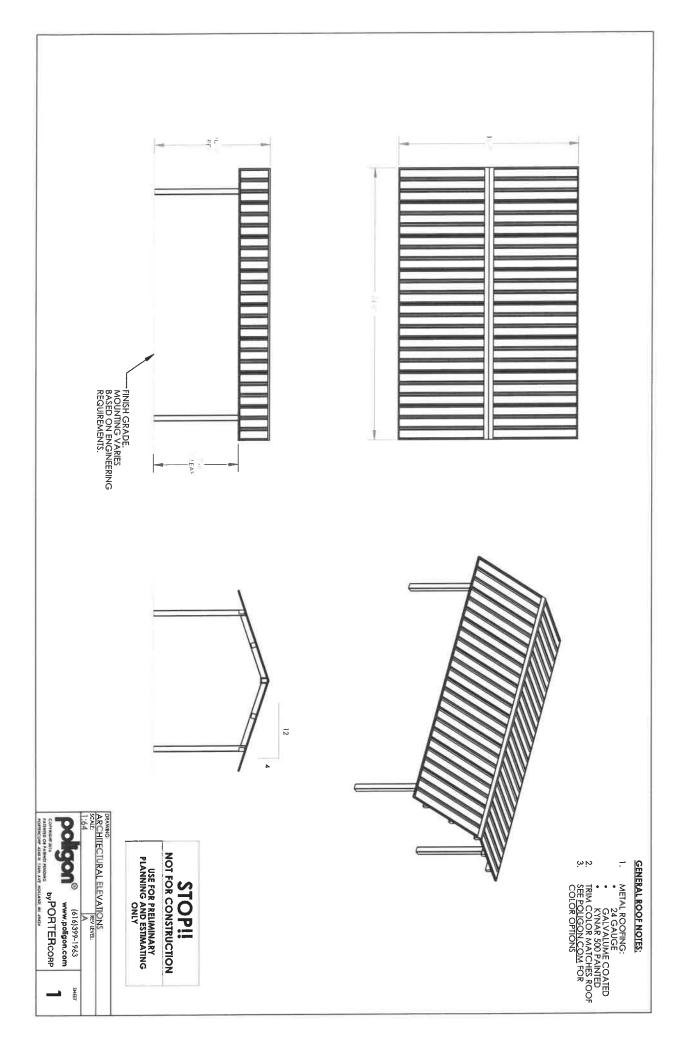

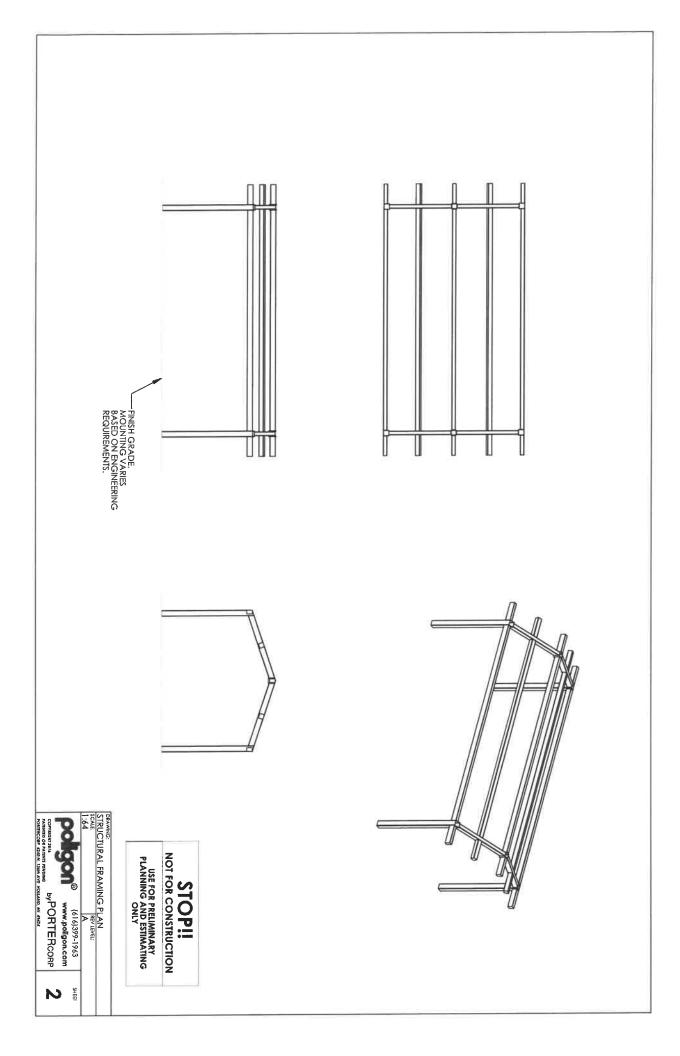

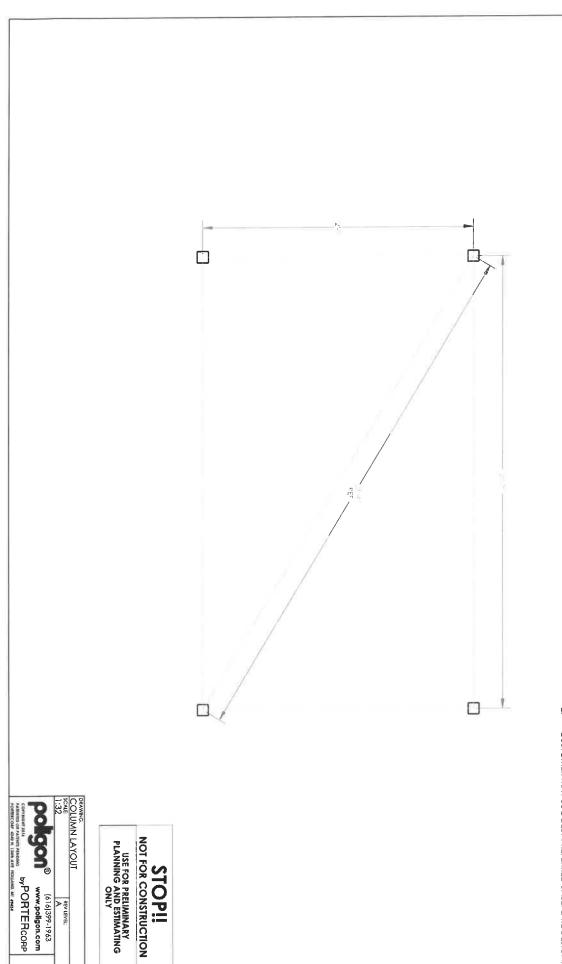

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## BASEPLATE NOTES:

- POLIGON ENGINEERING WILL DETERMINE REQUIRED BASEPLATE DESIGN AFTER ENGINEERING PACKAGE IS ORDERED. CUSTOMER MAY SUGGEST PREFERRED BASEPLATE DESIGN.

