



Survey

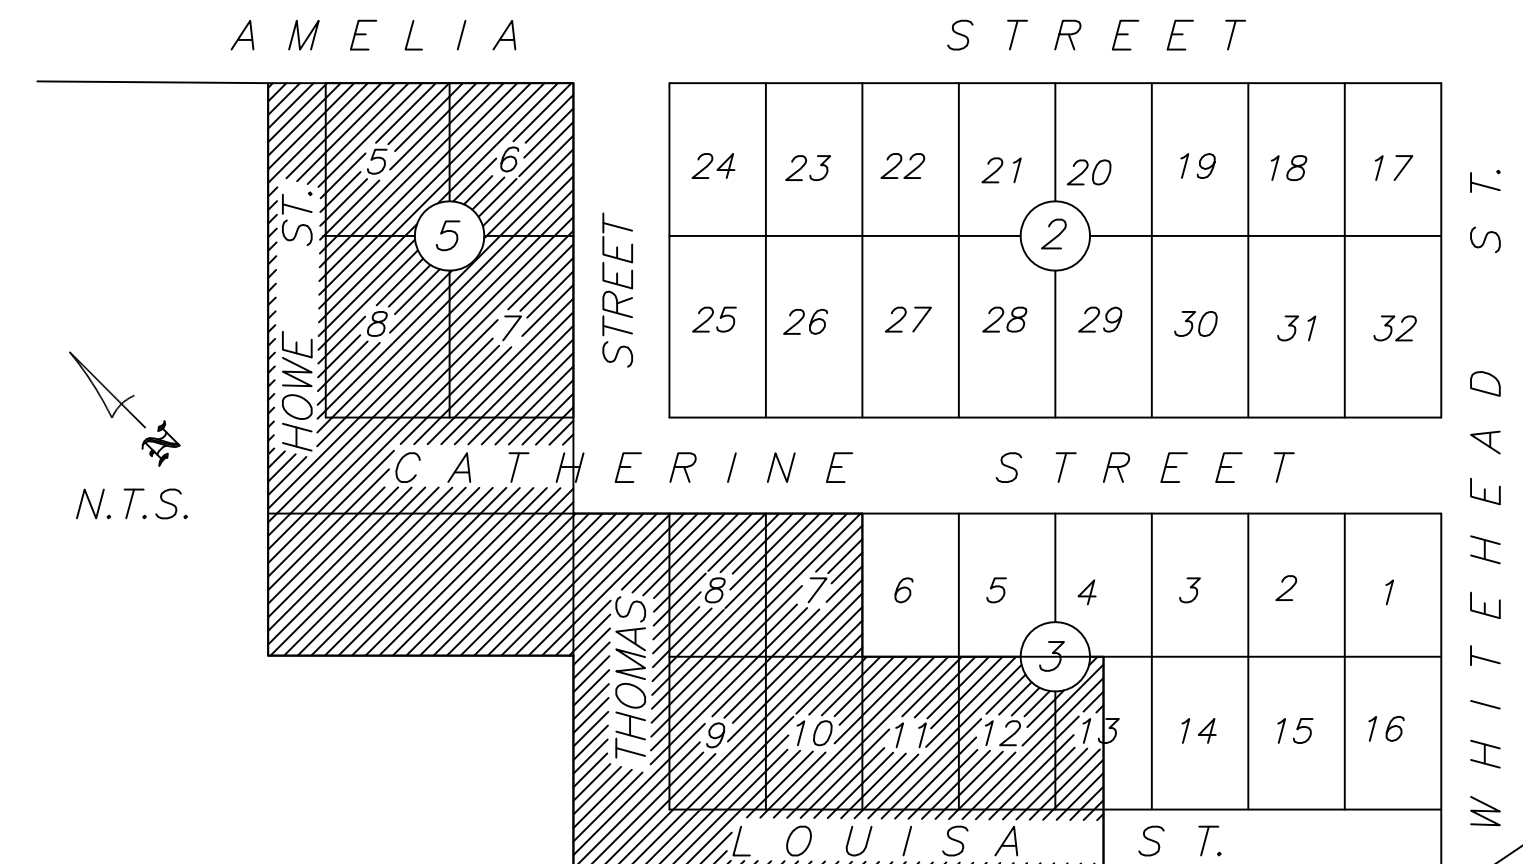

LOCATION MAP
A Portion of Tracts 10 & 15
Plat Book 1, page 40
City of Key West

LEGAL DESCRIPTION:
Lots 5,6,7 & 8, Square 5, Lots 7,8,9,10,11,12 and the Southwesterly 22.25 of Lot 13, Square 3 "TRACTS 10 & 15, according to the Plat thereof, as recorded in Plat Book 1, at Page 40, of the Public Records of Monroe County Florida.
AND
Catherine Street Lying Southeasterly of and adjacent to Lots 7 & 8, Square 5.
AND
Louisa Street Lying Southeasterly of and adjacent to Lots 9, 10,11, 12 and the S'ly 22.25 feet of Lot 13, Square 3 and Northwesterly of the U.S. Navy Property and also lying Southeasterly of the end of Thomas Street.
AND
Thomas Street lying Southwesterly of and adjacent to lots 8 & 9, Square 3
AND
Howe Street Lying Southwesterly of and adjacent to Lots 5, & 8, Square 5 and the end of Catherine Street.
AND
a 74 foot by 160.40 foot parcel of land Known as Catherine Street Playground, lying Southeasterly of Catherine Street and Southwesterly of Thomas Street, also being known as O.R. 00026610-000100

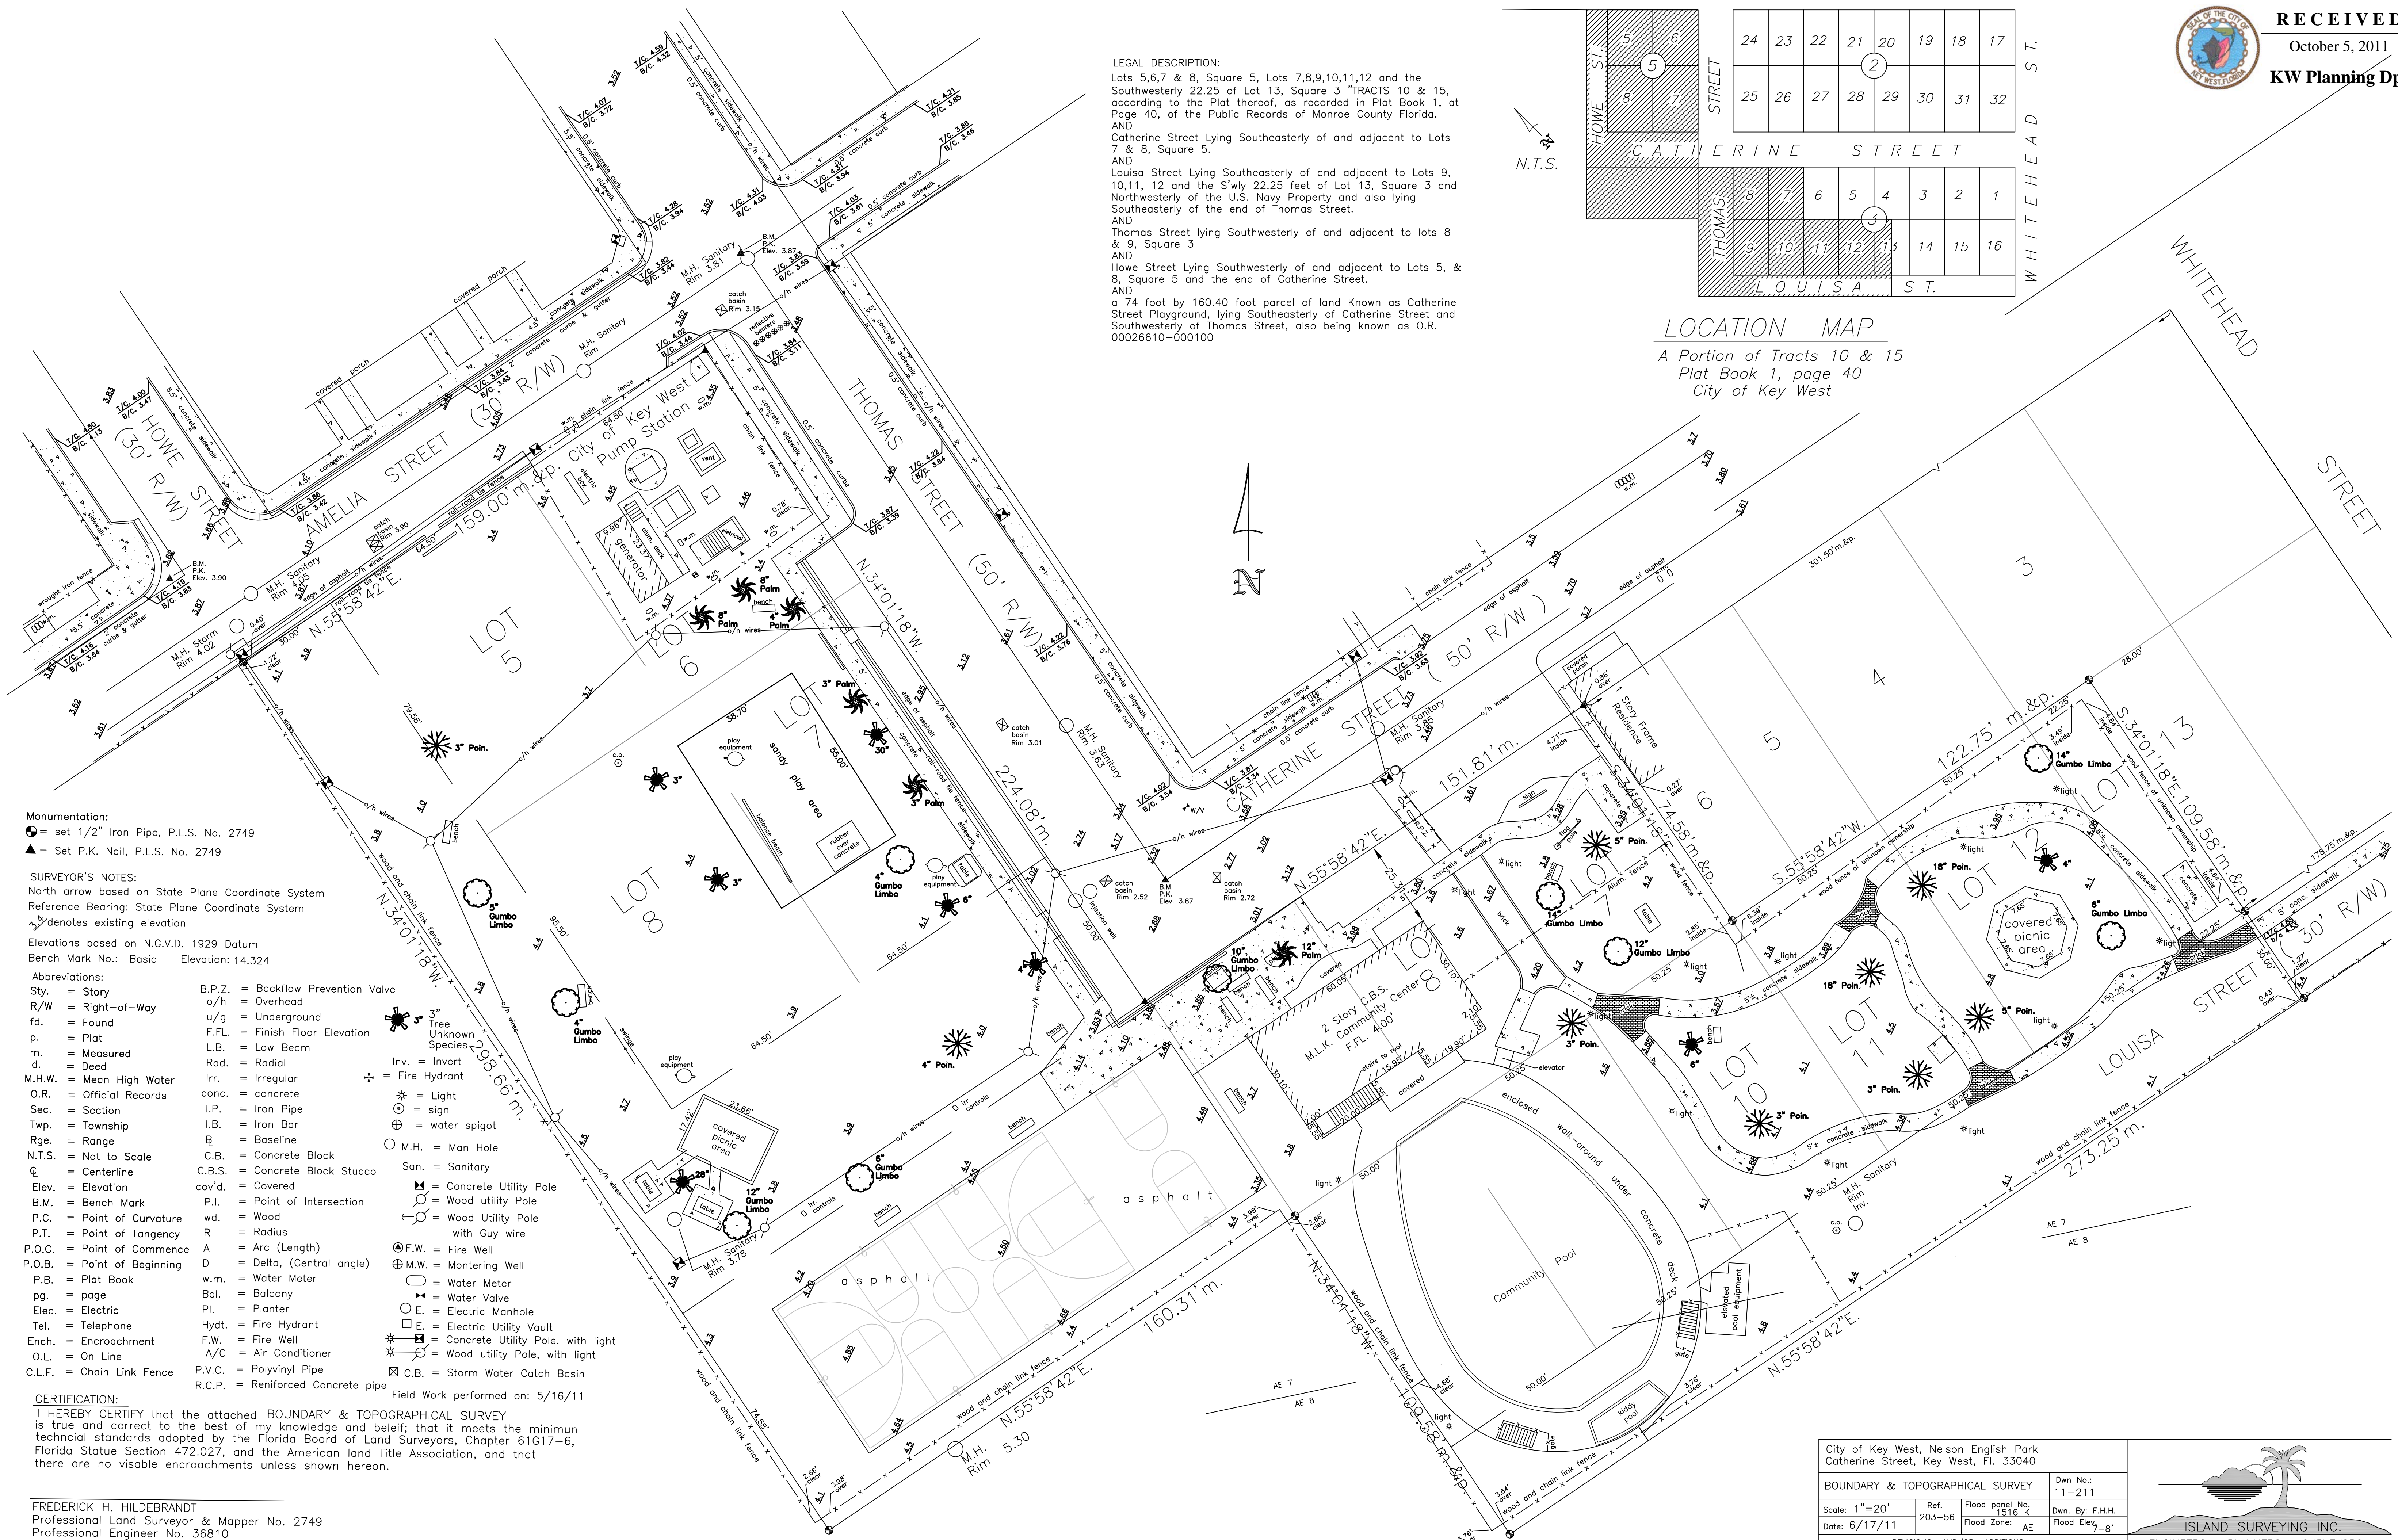

Monumentation:
● = set 1/2" Iron Pipe, P.L.S. No. 2749
▲ = Set P.K. Nail, P.L.S. No. 2749

SURVEYOR'S NOTES:
North arrow based on State Plane Coordinate System
Reference Bearing: State Plane Coordinate System
▲ denotes existing elevation
Elevations based on N.G.V.D. 1929 Datum
Bench Mark No.: Basic Elevation: 14.324

- Abbreviations:**
- Sty. = Story
 - R/W = Right-of-Way
 - fd. = Found
 - p. = Plat
 - m. = Measured
 - d. = Dead
 - M.H.W. = Mean High Water
 - O.R. = Official Records
 - Sec. = Section
 - Twp. = Township
 - Rge. = Range
 - N.T.S. = Not to Scale
 - CL. = Centerline
 - Elev. = Elevation
 - B.M. = Bench Mark
 - P.C. = Point of Curvature
 - P.T. = Point of Tangency
 - P.O.C. = Point of Commence
 - P.O.B. = Point of Beginning
 - P.B. = Plat Book
 - pg. = page
 - Elec. = Electric
 - Tel. = Telephone
 - Ench. = Encroachment
 - O.L. = On Line
 - C.L.F. = Chain Link Fence
 - B.P.Z. = Backflow Prevention Valve
 - o/h = Overhead
 - u/g = Underground
 - fd. = Found
 - F.F.L. = Finish Floor Elevation
 - L.B. = Low Beam
 - Rad. = Radial
 - Irr. = Irregular
 - conc. = concrete
 - I.P. = Iron Pipe
 - I.B. = Iron Bar
 - Bas. = Baseline
 - C.B. = Concrete Block
 - C.B.S. = Concrete Block Stucco
 - cov'd. = Covered
 - P.I. = Point of Intersection
 - wd. = Wood
 - R. = Radius
 - A = Arc (Length)
 - D = Delta, (Central angle)
 - w.m. = Water Meter
 - Bal. = Balcony
 - Pl. = Planter
 - Hyd. = Fire Hydrant
 - F.W. = Fire Well
 - A/C = Air Conditioner
 - P.V.C. = Polyvinyl Pipe
 - R.C.P. = Reinforced Concrete pipe
 - Inv. = Invert
 - ⊕ = Fire Hydrant
 - * = Light
 - ⊙ = sign
 - ⊕ = water spigot
 - M.H. = Man Hole
 - San. = Sanitary
 - ⊕ = Concrete Utility Pole
 - ⊙ = Wood utility Pole
 - ⊕ = Wood Utility Pole with Guy wire
 - ⊕ F.W. = Fire Well
 - ⊕ M.W. = Monitoring Well
 - ⊕ = Water Meter
 - ⊕ = Water Valve
 - ⊕ E. = Electric Manhole
 - ⊕ E. = Electric Utility Vault
 - ⊕ = Concrete Utility Pole. with light
 - ⊕ = Wood utility Pole, with light
 - ⊕ C.B. = Storm Water Catch Basin

CERTIFICATION:
I HEREBY CERTIFY that the attached BOUNDARY & TOPOGRAPHICAL SURVEY is true and correct to the best of my knowledge and belief; that it meets the minimum technical standards adopted by the Florida Board of Land Surveyors, Chapter 61G17-6, Florida Statute Section 472.027, and the American land Title Association, and that there are no visible encroachments unless shown hereon.

FREDERICK H. HILDEBRANDT
Professional Land Surveyor & Mapper No. 2749
Professional Engineer No. 36810
State of Florida

NOT VALID UNLESS EMBOSSED WITH RAISED SEAL & SIGNATURE

City of Key West, Nelson English Park Catherine Street, Key West, Fl. 33040			
BOUNDARY & TOPOGRAPHICAL SURVEY		Dwn No.: 11-211	
Scale: 1"=20'	Ref. 203-56	Flood panel No. 1516 K	Dwn. By: F.H.H.
Date: 6/17/11		Flood Zone: AE	Flood Elev. 7'-8"
REVISIONS AND/OR ADDITIONS			
f:/datafred/awg/cityofkeywest/nelsonenglish			

ISLAND SURVEYING INC.
ENGINEERS PLANNERS SURVEYORS
3152 Northside Drive
Suite 201
Key West, Fl. 33040
(305) 293-0466
Fax: (305) 293-0237
fride1@islandsurveying.net
L.B. No. 7700

Site Plans

Seal:

Consultants:

CIVIL ENGINEER:
Meridian Engineering, LLC
LANDSCAPE ARCHITECT:
Craig Reynolds, RLA

Submissions:

July 28, 2011 - Public Meeting #1
August 18, 2011 - Public Meeting #2
September 30, 2011 - HARB, Tree
Commission, DRC and Planning
January 4, 2012 - TIF Application
January 18, 2012 - Revised Planning
Board Submission
January 27, 2012 - Revised Planning
Board Submission

NELSON ENGLISH / WILLIE WARD
PARK ENHANCEMENT PROJECT
CITY OF KEY WEST
300 Catherine Street, Key West, Florida 33040

PLOTTED: 1/27/2012 8:57 AM

Drawing Size 24x36	Project #: MK-11035
Drawn By: PSS	Checked By: ADS

Title:

SCOPE OF WORK,
PHASING PLAN,
LOCATION MAP &
DESIGN TEAM

Sheet Number:

A0.1.2

Date: January 27, 2012

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SCOPE OF WORK


The Park Enhancement project for Nelson English and Willie Ward Parks in Bahama Village is anticipated as three phases of work, to be implemented as funding allows. The project received TIF funding during the 2010 and 2012 Allocation process, which has provided funding for the Design and Construction Documents as well as Phase I and II construction.

The scope of work for the project is improvements to the existing park / pool area for safety and community enhancements, which includes:

- new playground equipment and safety surfacing for various age groups (Phase I)
- improvements to the existing pool and related facilities (Phase I)
- reconfiguration of the entrance of the Martin Luther King Community Center to address flooding (Phase II)
- addition to the Martin Luther King Community Center to provide accessible restrooms for use by the Park visitors (Phase III)
- reorganization of the parking areas to include vehicular, bicycle, and scooter parking (Phase I and II)
- open play lawn (Phase I and III)
- park shelters (Phase I and III)
- enhanced landscaping (Phase I, II, and III)
- site furnishings, including benches, trash and recycling receptacles, bar-b-q grills, picnic benches, and signage (Phase I, II, and III)
- multiple levels of lighting, for both safety / security and aesthetics (Phase I, II, and III)
- organized pedestrian pathways throughout the park linking the parks with the Community (Phase I, II, and III)


Specifically, the Phase II scope of work is focused on the parking and grading at the MLK Community Center, as well as the other amenities that are included in all three phases of work.

LOCATION MAP

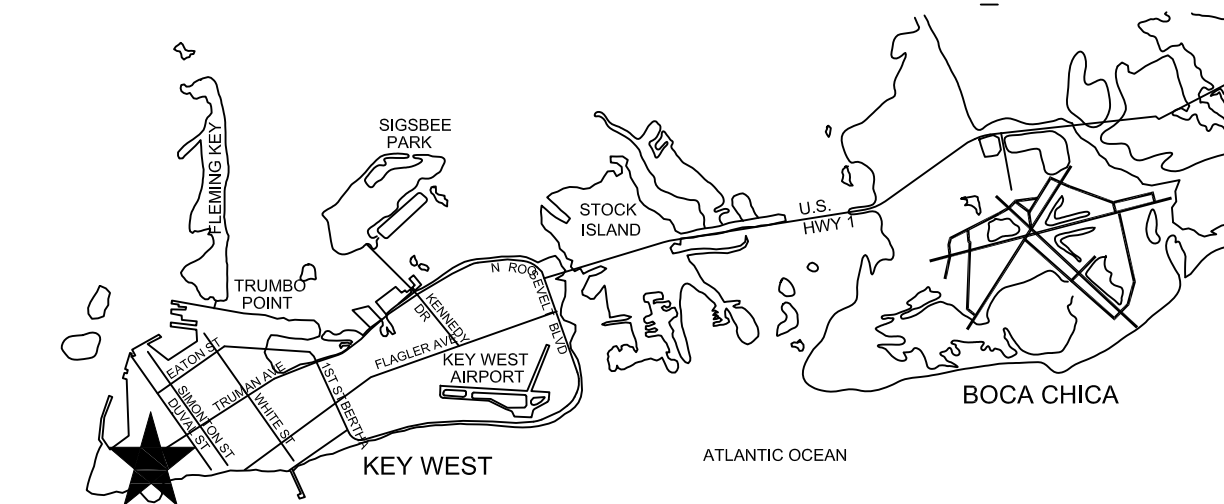

PROJECT LOCATION ★


PHASING PLAN

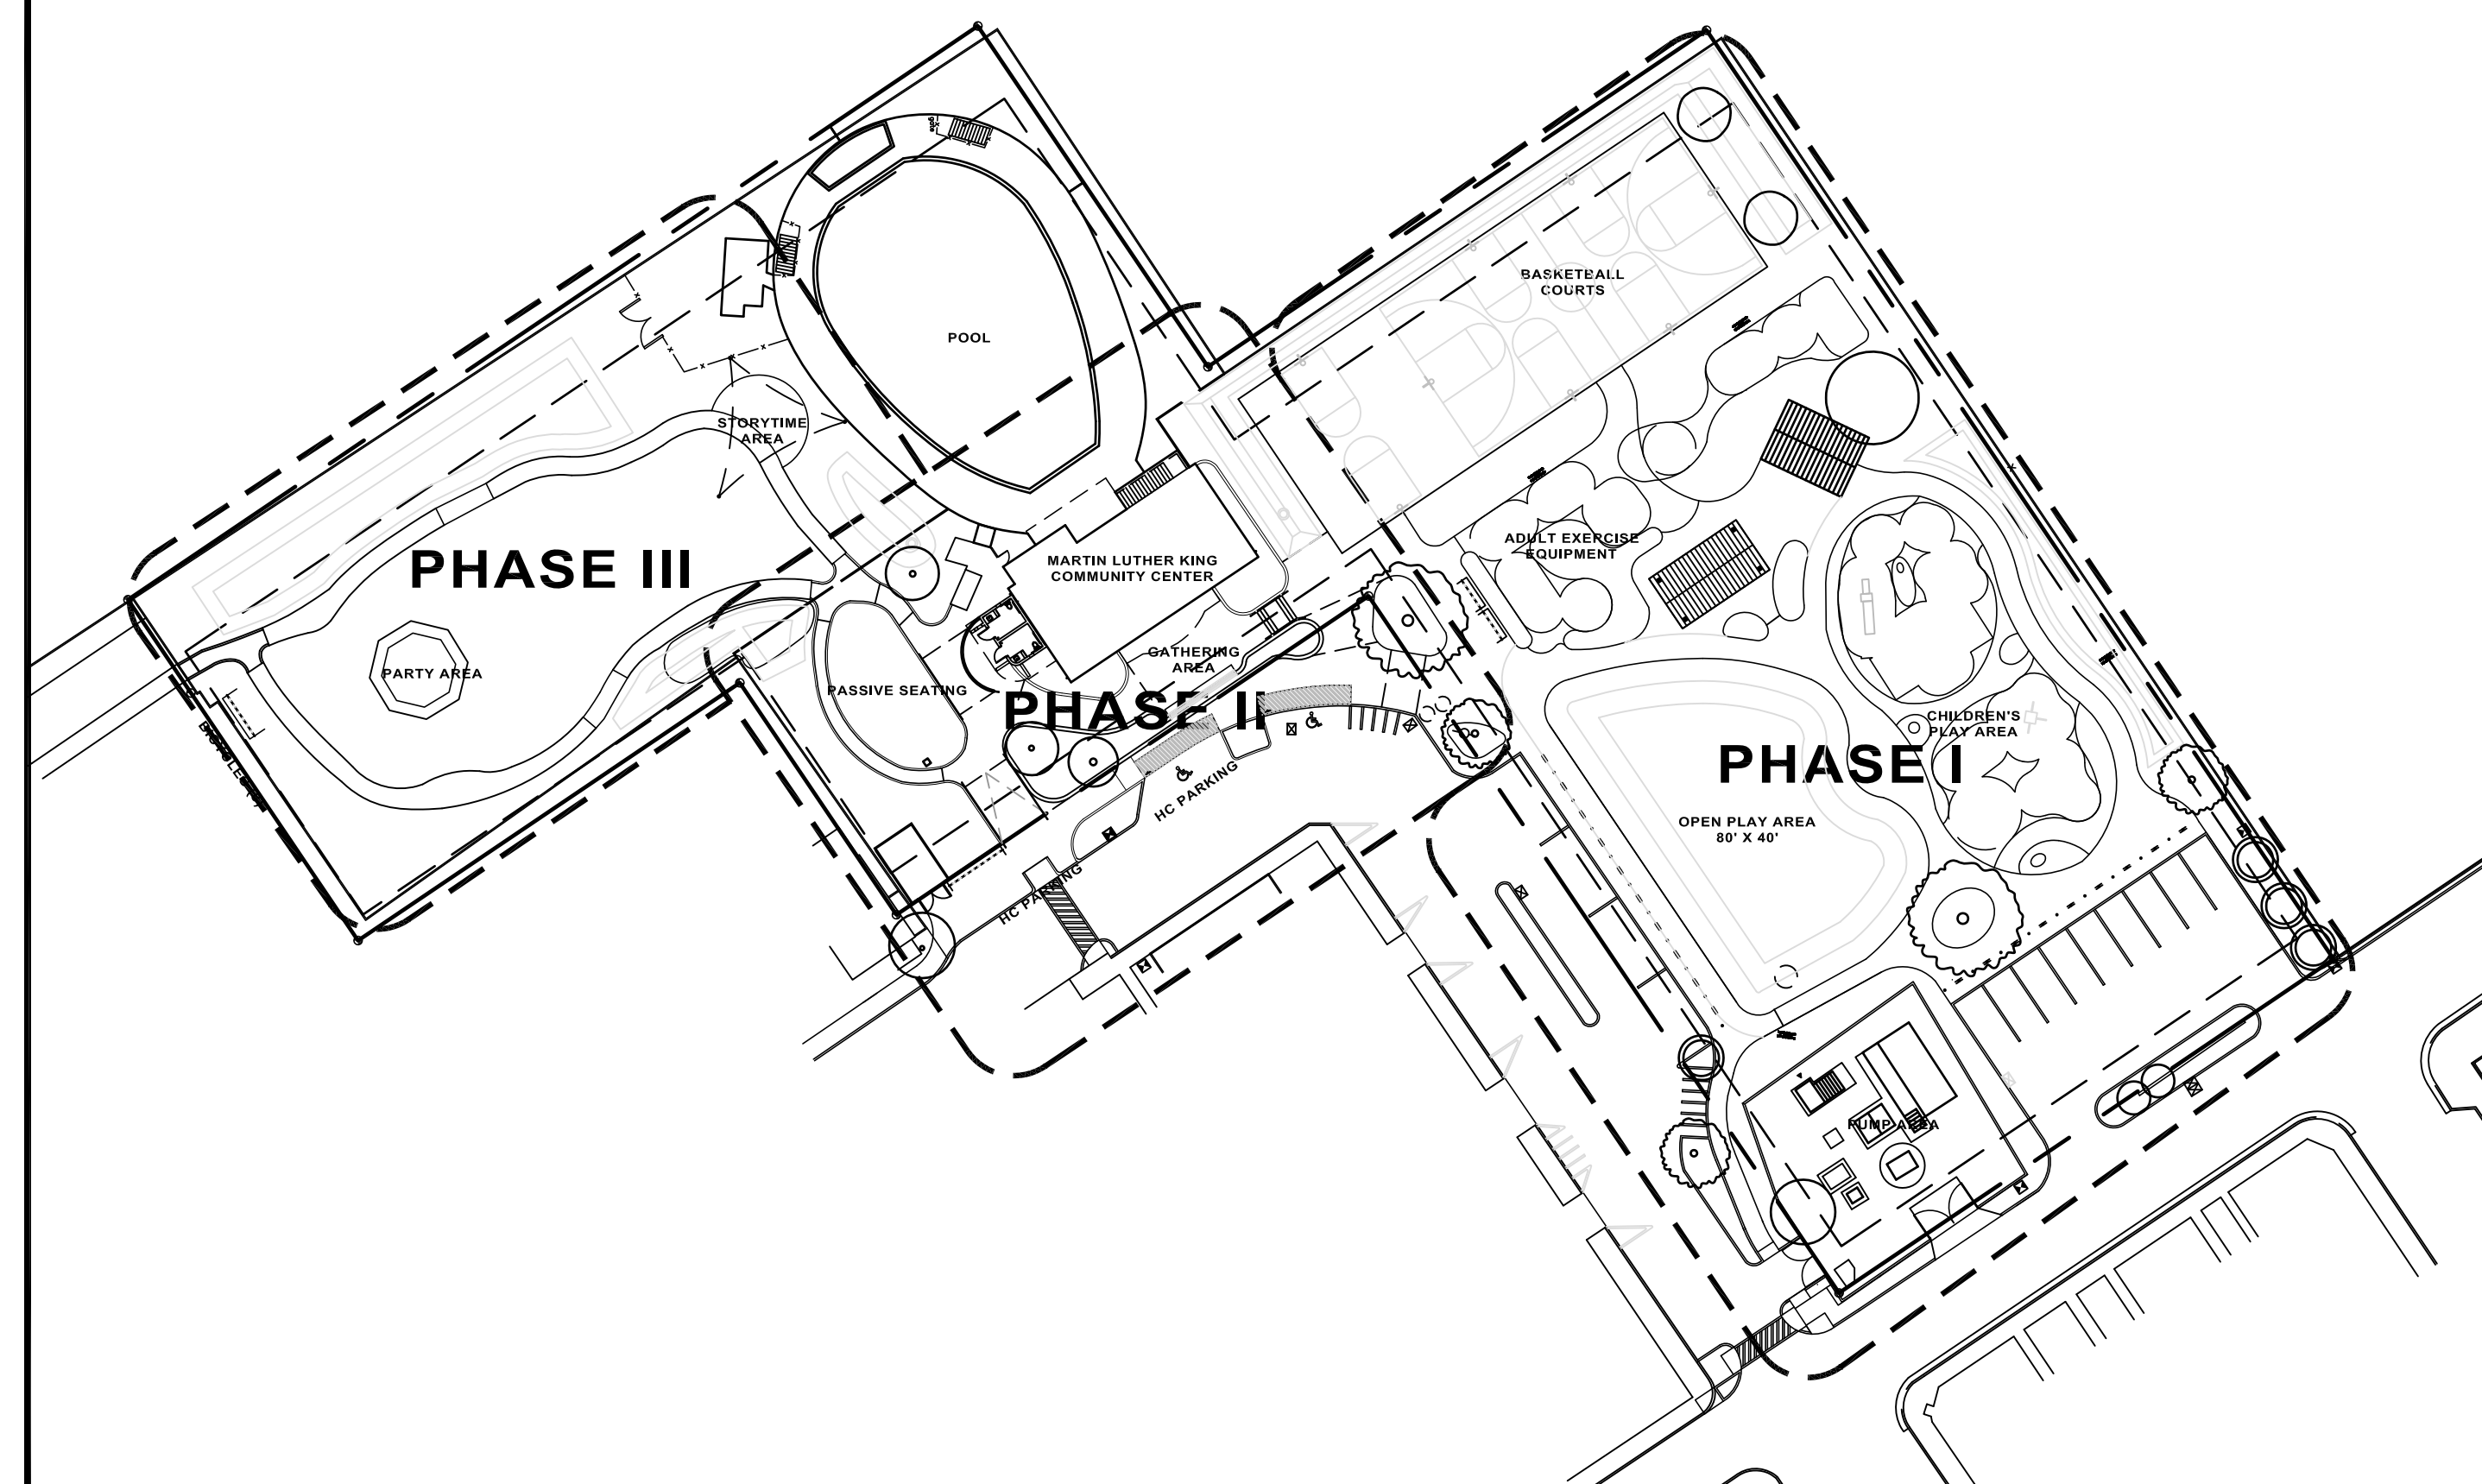

PROJECT TEAM INFORMATION

ARCHITECT: mbi k2m Architecture, Inc. Michael B. Ingram, R.A. 1001 Whitehead Street Key West, Florida 33040 tel: 305.292.7722 PROF. REG. AA26001059	OWNER: City of Key West Jim Scholl, City Manager 3132 Flagler Avenue Key West, Florida 33040 tel: 305.809.3888
CIVIL ENGINEER: Meridian Engineering, LLC Rick Milelli, P.E. 201 Front Street, Suite 207 Key West, Florida 33040 tel: 305.293.3263	LANDSCAPE ARCHITECT: Craig Reynolds Landscape Architecture Craig Reynolds, RLA 3255 Flagler Avenue, Suite 305 Key West, Florida 33040 tel: 305.292.7243
SURVEYOR: Island Surveying, Inc. Frederick H. Hildebrandt 3152 Northside Drive, Suite 201 Key West, Florida 33040 tel: 305.293.0466	

SHEET NUMBERING SYSTEM

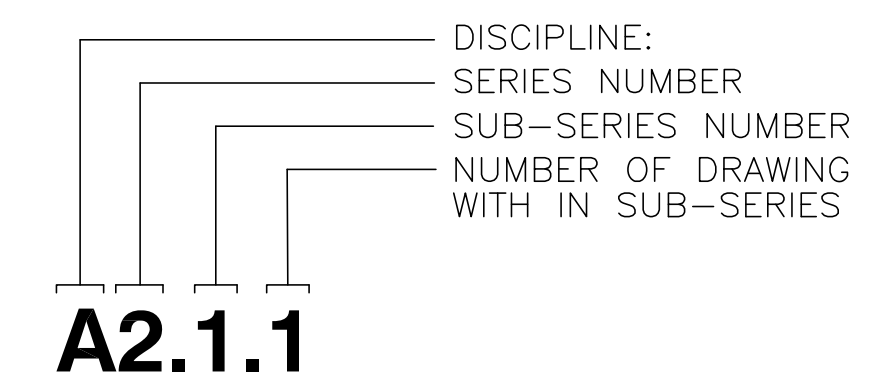

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Consultants:
CIVIL ENGINEER:
Meridian Engineering, LLC
LANDSCAPE ARCHITECT:
Craig Reynolds, RLA

Submissions:
July 28, 2011 - Public Meeting #1
August 18, 2011 - Public Meeting #2
September 30, 2011 - HARBG Tree
Commission, DRC and Planning
January 4, 2012 - TIF Application
January 18, 2012 - Revised Planning
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January 27, 2012 - Revised Planning
Board Submission

**NELSON ENGLISH / WILLIE WARD
PARK ENHANCEMENT PROJECT**
CITY OF KEY WEST
300 Catherine Street, Key West, Florida 33040

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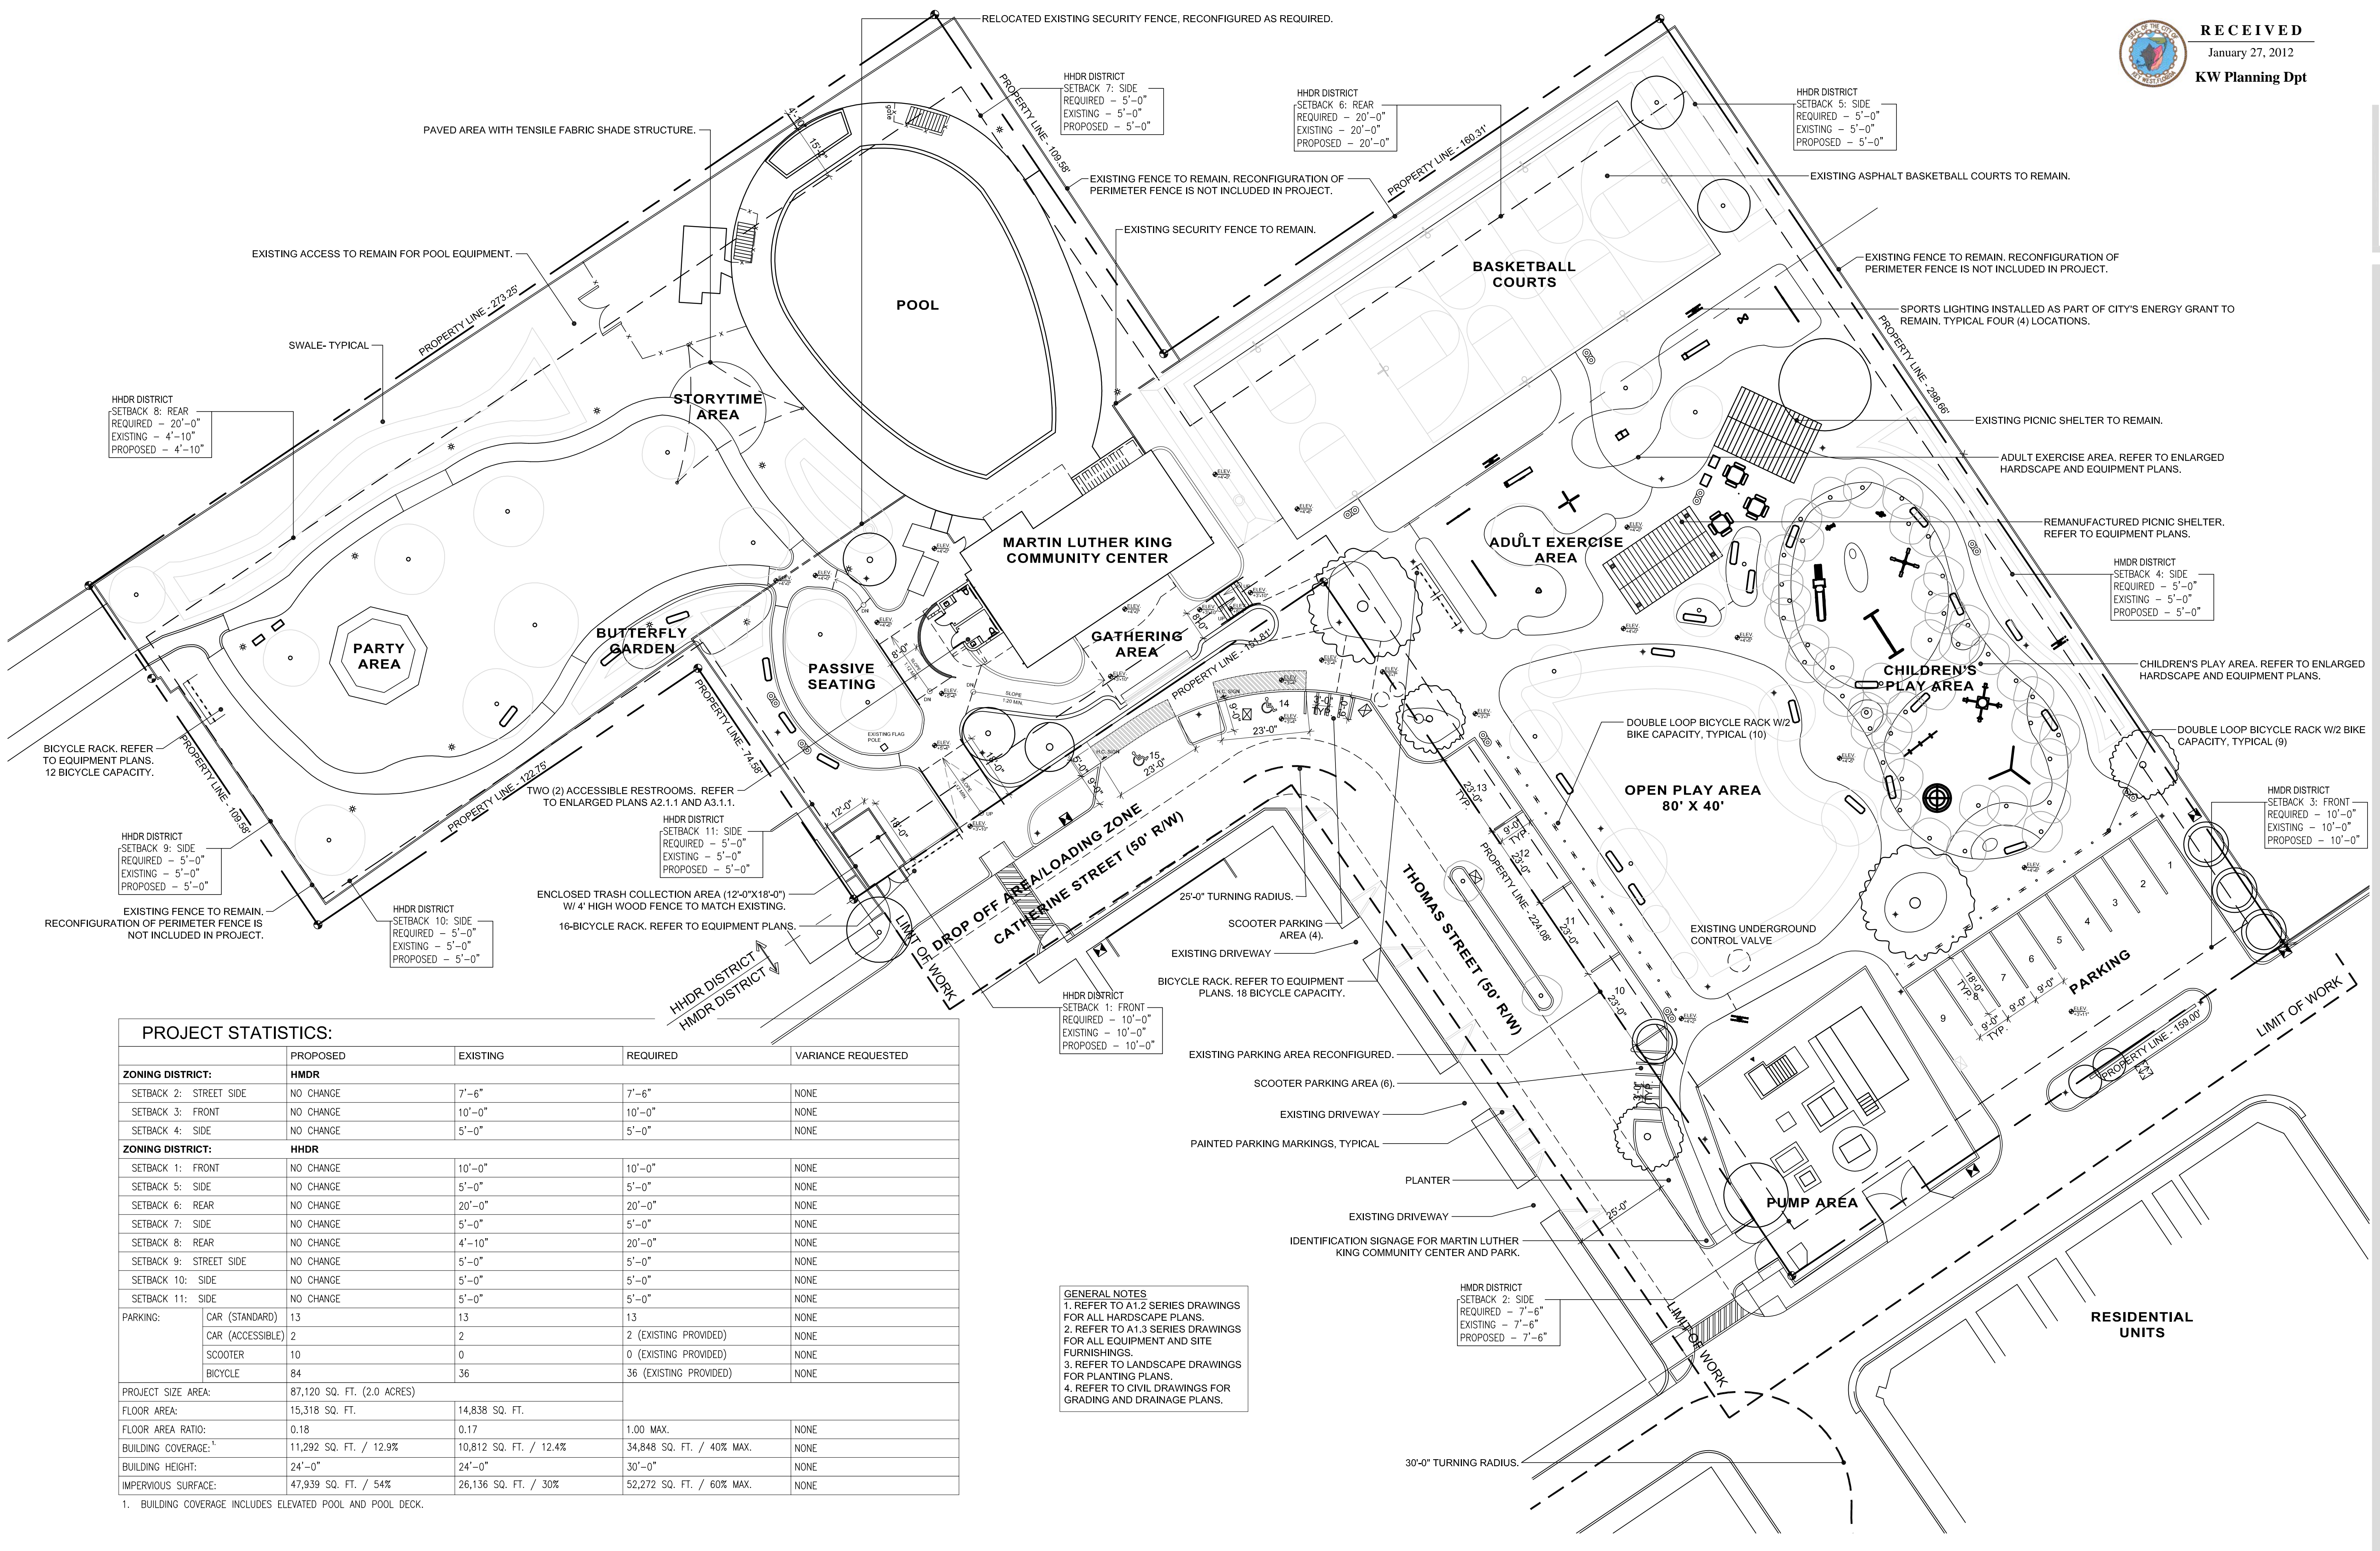
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24x36 | MK-11035
Drawn By: | Checked By:
PSS | ADS

Title:
OVERALL SITE PLAN

Sheet Number:

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Date: January 27, 2012
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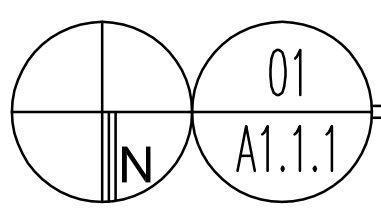


PROJECT STATISTICS:

	PROPOSED	EXISTING	REQUIRED	VARIANCE REQUESTED
ZONING DISTRICT:	HMDR			
SETBACK 2: STREET SIDE	NO CHANGE	7'-6"	7'-6"	NONE
SETBACK 3: FRONT	NO CHANGE	10'-0"	10'-0"	NONE
SETBACK 4: SIDE	NO CHANGE	5'-0"	5'-0"	NONE
ZONING DISTRICT:	HHDR			
SETBACK 1: FRONT	NO CHANGE	10'-0"	10'-0"	NONE
SETBACK 5: SIDE	NO CHANGE	5'-0"	5'-0"	NONE
SETBACK 6: REAR	NO CHANGE	20'-0"	20'-0"	NONE
SETBACK 7: SIDE	NO CHANGE	5'-0"	5'-0"	NONE
SETBACK 8: REAR	NO CHANGE	4'-10"	20'-0"	NONE
SETBACK 9: STREET SIDE	NO CHANGE	5'-0"	5'-0"	NONE
SETBACK 10: SIDE	NO CHANGE	5'-0"	5'-0"	NONE
SETBACK 11: SIDE	NO CHANGE	5'-0"	5'-0"	NONE
PARKING:				
CAR (STANDARD)	13	13	13	NONE
CAR (ACCESSIBLE)	2	2	2 (EXISTING PROVIDED)	NONE
SCOOTER	10	0	0 (EXISTING PROVIDED)	NONE
BICYCLE	84	36	36 (EXISTING PROVIDED)	NONE
PROJECT SIZE AREA:	87,120 SQ. FT. (2.0 ACRES)			
FLOOR AREA:	15,318 SQ. FT.	14,838 SQ. FT.		
FLOOR AREA RATIO:	0.18	0.17	1.00 MAX.	NONE
BUILDING COVERAGE:¹	11,292 SQ. FT. / 12.9%	10,812 SQ. FT. / 12.4%	34,848 SQ. FT. / 40% MAX.	NONE
BUILDING HEIGHT:	24'-0"	24'-0"	30'-0"	NONE
IMPERVIOUS SURFACE:	47,939 SQ. FT. / 54%	26,136 SQ. FT. / 30%	52,272 SQ. FT. / 60% MAX.	NONE

1. BUILDING COVERAGE INCLUDES ELEVATED POOL AND POOL DECK.

GENERAL NOTES
1. REFER TO A1.2 SERIES DRAWINGS FOR ALL HARDSCAPE PLANS.
2. REFER TO A1.3 SERIES DRAWINGS FOR ALL EQUIPMENT AND SITE FURNISHINGS.
3. REFER TO LANDSCAPE DRAWINGS FOR PLANTING PLANS.
4. REFER TO CIVIL DRAWINGS FOR GRADING AND DRAINAGE PLANS.



OVERALL SITE PLAN
SCALE: 1"=20'-0"



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www.mbi-k2m.com
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Baltimore Florida | Washington DC

Seal

Consultants:
CIVIL ENGINEER
Meridian Engineering, LLC
LANDSCAPE ARCHITECT
Craig Reynolds, RLA

Submissions:

- July 28, 2011 - Public Meeting #1
- August 18, 2011 - Public Meeting #2
- September 30, 2011 - HADR, Tier
- Commission, DDC and Planning
- January 4, 2012 - TP Application
- January 18, 2012 - Revised Plan
- Board Submission
- January 27, 2012 - Revised Plan
- Board Submission

**NELSON ENGLISH / WILLIE WARD
PARK ENHANCEMENT PROJECT**
CITY OF KEY WEST
300 Catherine Street, Key West, Florida 33040

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PSS	ADS

Title:
OVERALL SITE PLAN


Sheet Number:

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Date: January 27, 2012
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01
A1.1.1
ENLARGED STREET PLAN
SCALE: N.T.S.

Seat

Consultants:
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 Meridian Engineering, LLC
 LANDSCAPE ARCHITECT
 Craig Reynolds, RLA

Submissions:
 July 28, 2011 - Public Meeting #1
 August 18, 2011 - Public Meeting #2
 September 20, 2011 - HARC Review
 Commission, QDC and Planning
 January 4, 2012 - TIF Application
 January 18, 2012 - Revised Planning
 Board Submission
 January 27, 2012 - Revised Planning
 Board Submission

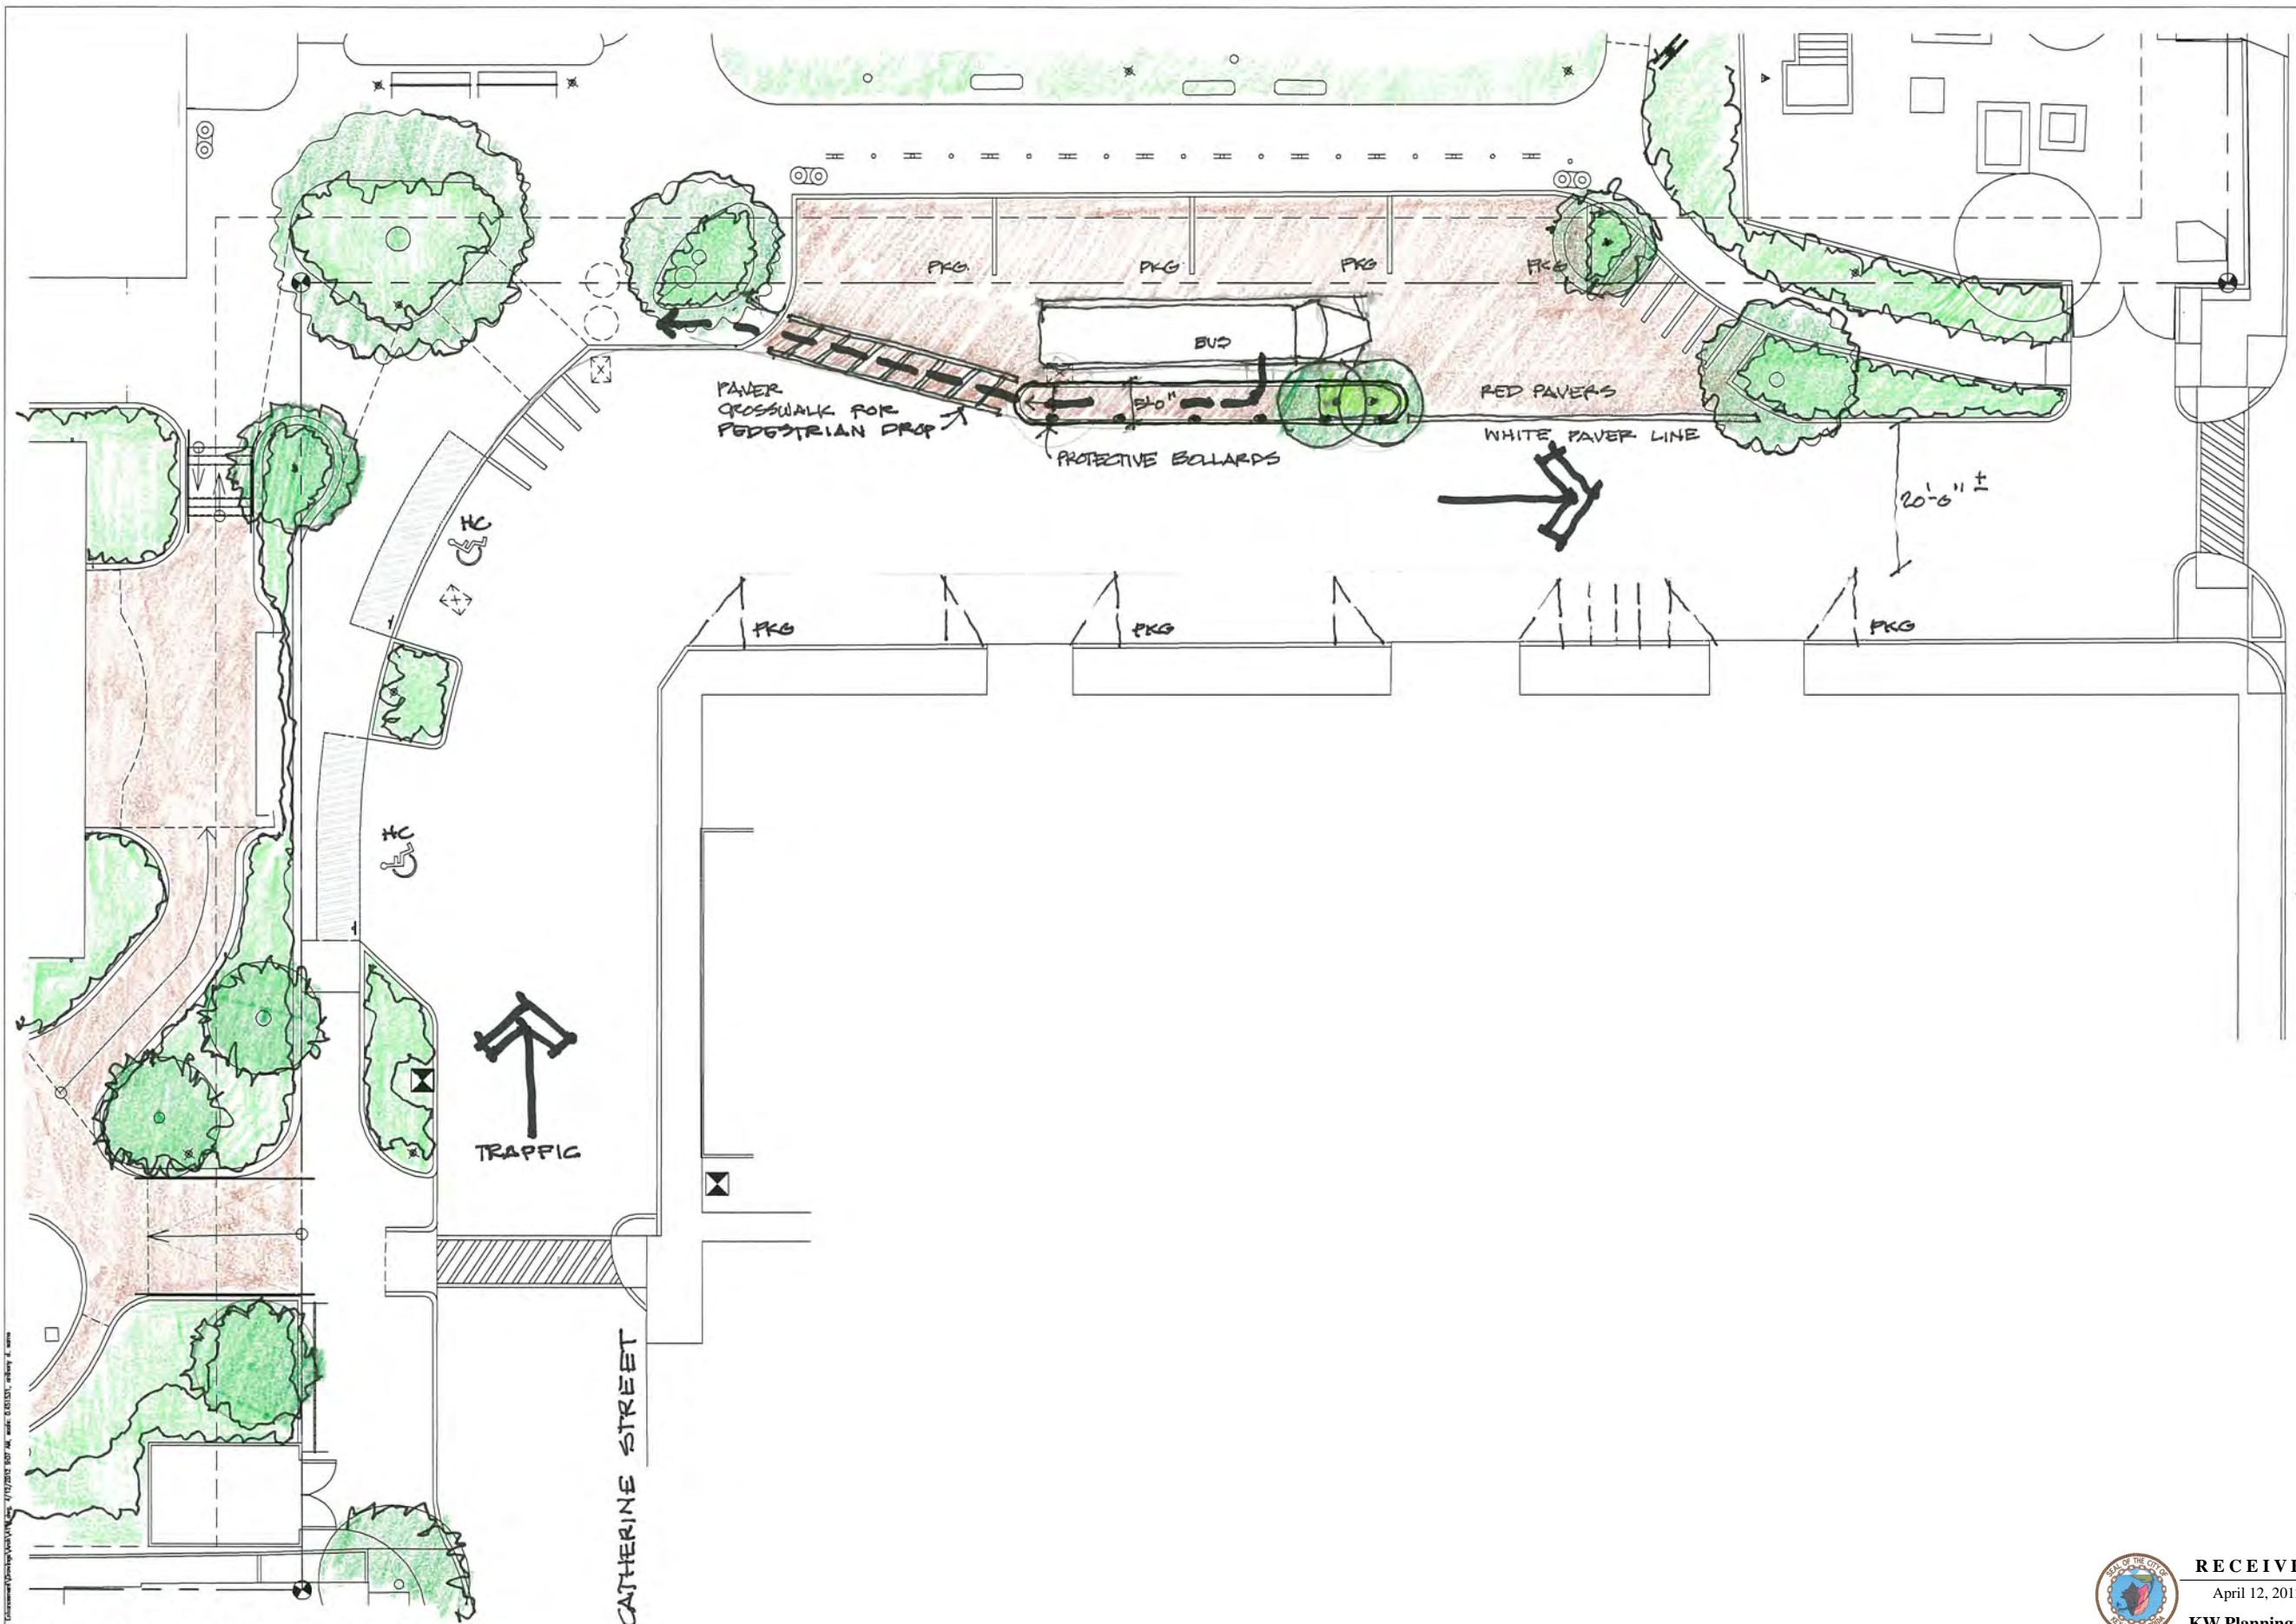**NELSON ENGLISH / WILLIE WARD
 PARK ENHANCEMENT PROJECT**
CITY OF KEY WEST
 300 Catherine Street, Key West, Florida 33040

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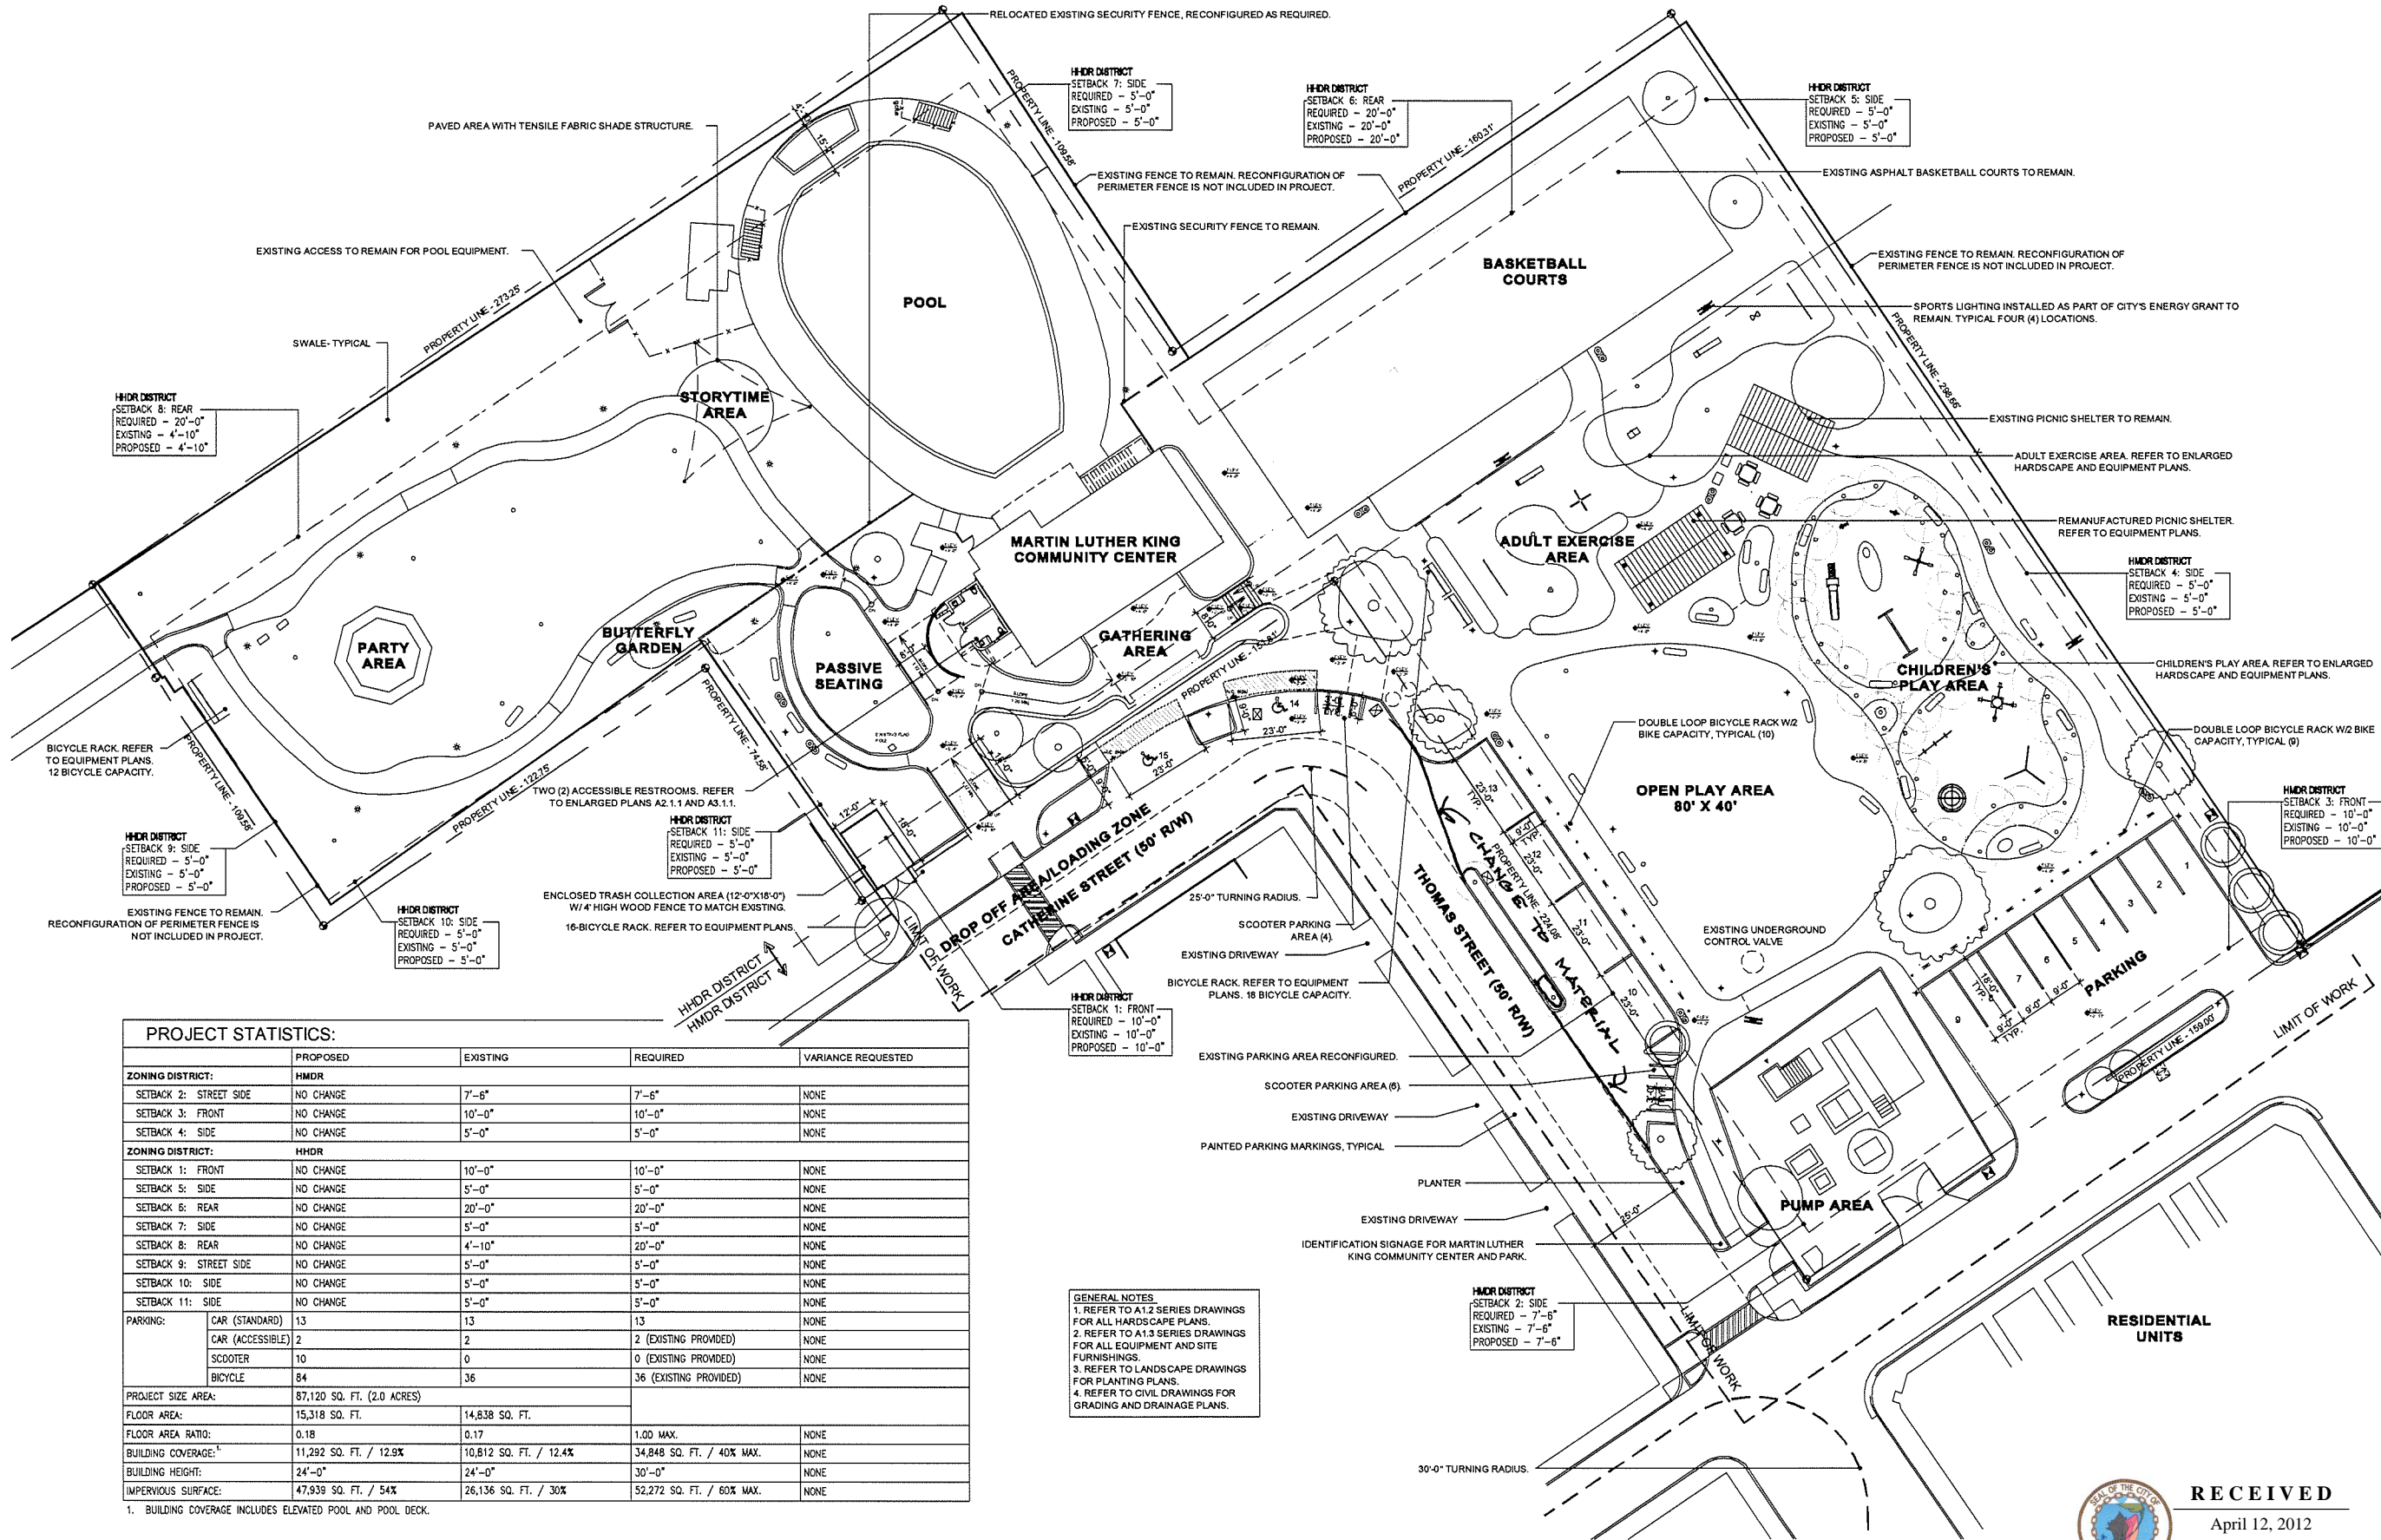
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 Drawn By: PSS Checked By: ADS

Title: OVERALL SITE PLAN

Sheet Number:

A1.1.1

Date: January 27, 2012
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PROJECT STATISTICS:

	PROPOSED	EXISTING	REQUIRED	VARIANCE REQUESTED
ZONING DISTRICT: HMDR				
SETBACK 2: STREET SIDE	NO CHANGE	7'-6"	7'-6"	NONE
SETBACK 3: FRONT	NO CHANGE	10'-0"	10'-0"	NONE
SETBACK 4: SIDE	NO CHANGE	5'-0"	5'-0"	NONE
ZONING DISTRICT: HMDR				
SETBACK 1: FRONT	NO CHANGE	10'-0"	10'-0"	NONE
SETBACK 5: SIDE	NO CHANGE	5'-0"	5'-0"	NONE
SETBACK 6: REAR	NO CHANGE	20'-0"	20'-0"	NONE
SETBACK 7: SIDE	NO CHANGE	5'-0"	5'-0"	NONE
SETBACK 8: REAR	NO CHANGE	4'-10"	20'-0"	NONE
SETBACK 9: STREET SIDE	NO CHANGE	5'-0"	5'-0"	NONE
SETBACK 10: SIDE	NO CHANGE	5'-0"	5'-0"	NONE
SETBACK 11: SIDE	NO CHANGE	5'-0"	5'-0"	NONE
PARKING:				
CAR (STANDARD)	13	13	13	NONE
CAR (ACCESSIBLE)	2	2	2 (EXISTING PROVIDED)	NONE
SCOOTER	10	0	0 (EXISTING PROVIDED)	NONE
BICYCLE	84	36	36 (EXISTING PROVIDED)	NONE
PROJECT SIZE AREA: 87,120 SQ. FT. (2.0 ACRES)				
FLOOR AREA: 15,318 SQ. FT. / 14,838 SQ. FT.				
FLOOR AREA RATIO: 0.18 / 0.17 / 1.00 MAX.				
BUILDING COVERAGE: 11,292 SQ. FT. / 12.9% / 10,812 SQ. FT. / 12.4% / 34,848 SQ. FT. / 40% MAX.				
BUILDING HEIGHT: 24'-0" / 24'-0" / 30'-0"				
IMPERVIOUS SURFACE: 47,939 SQ. FT. / 54% / 26,136 SQ. FT. / 30% / 52,272 SQ. FT. / 60% MAX.				

1. BUILDING COVERAGE INCLUDES ELEVATED POOL AND POOL DECK.

01 OVERALL SITE PLAN
 SCALE: 1"=20'-0"

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GRAPHIC SCALE: 1" = 20'-0"



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ARCHITECT:

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ARCHITECTURE, INC.

Architecture, Interior Design,
Procurement,
Owner Representation,
Specialty Consulting

1001 Whitehead Street
Key West, Florida 33040
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Consultants:

CIVIL ENGINEER:
Meridian Engineering, LLC
LANDSCAPE ARCHITECT:
Craig Reynolds, RLA

Submissions:

July 28, 2011 - Public Meeting #1
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Board Submission
January 27, 2012 - Revised Planning
Board Submission

NELSON ENGLISH / WILLIE WARD
PARK ENHANCEMENT PROJECT
CITY OF KEY WEST
300 Catherine Street, Key West, Florida 33040

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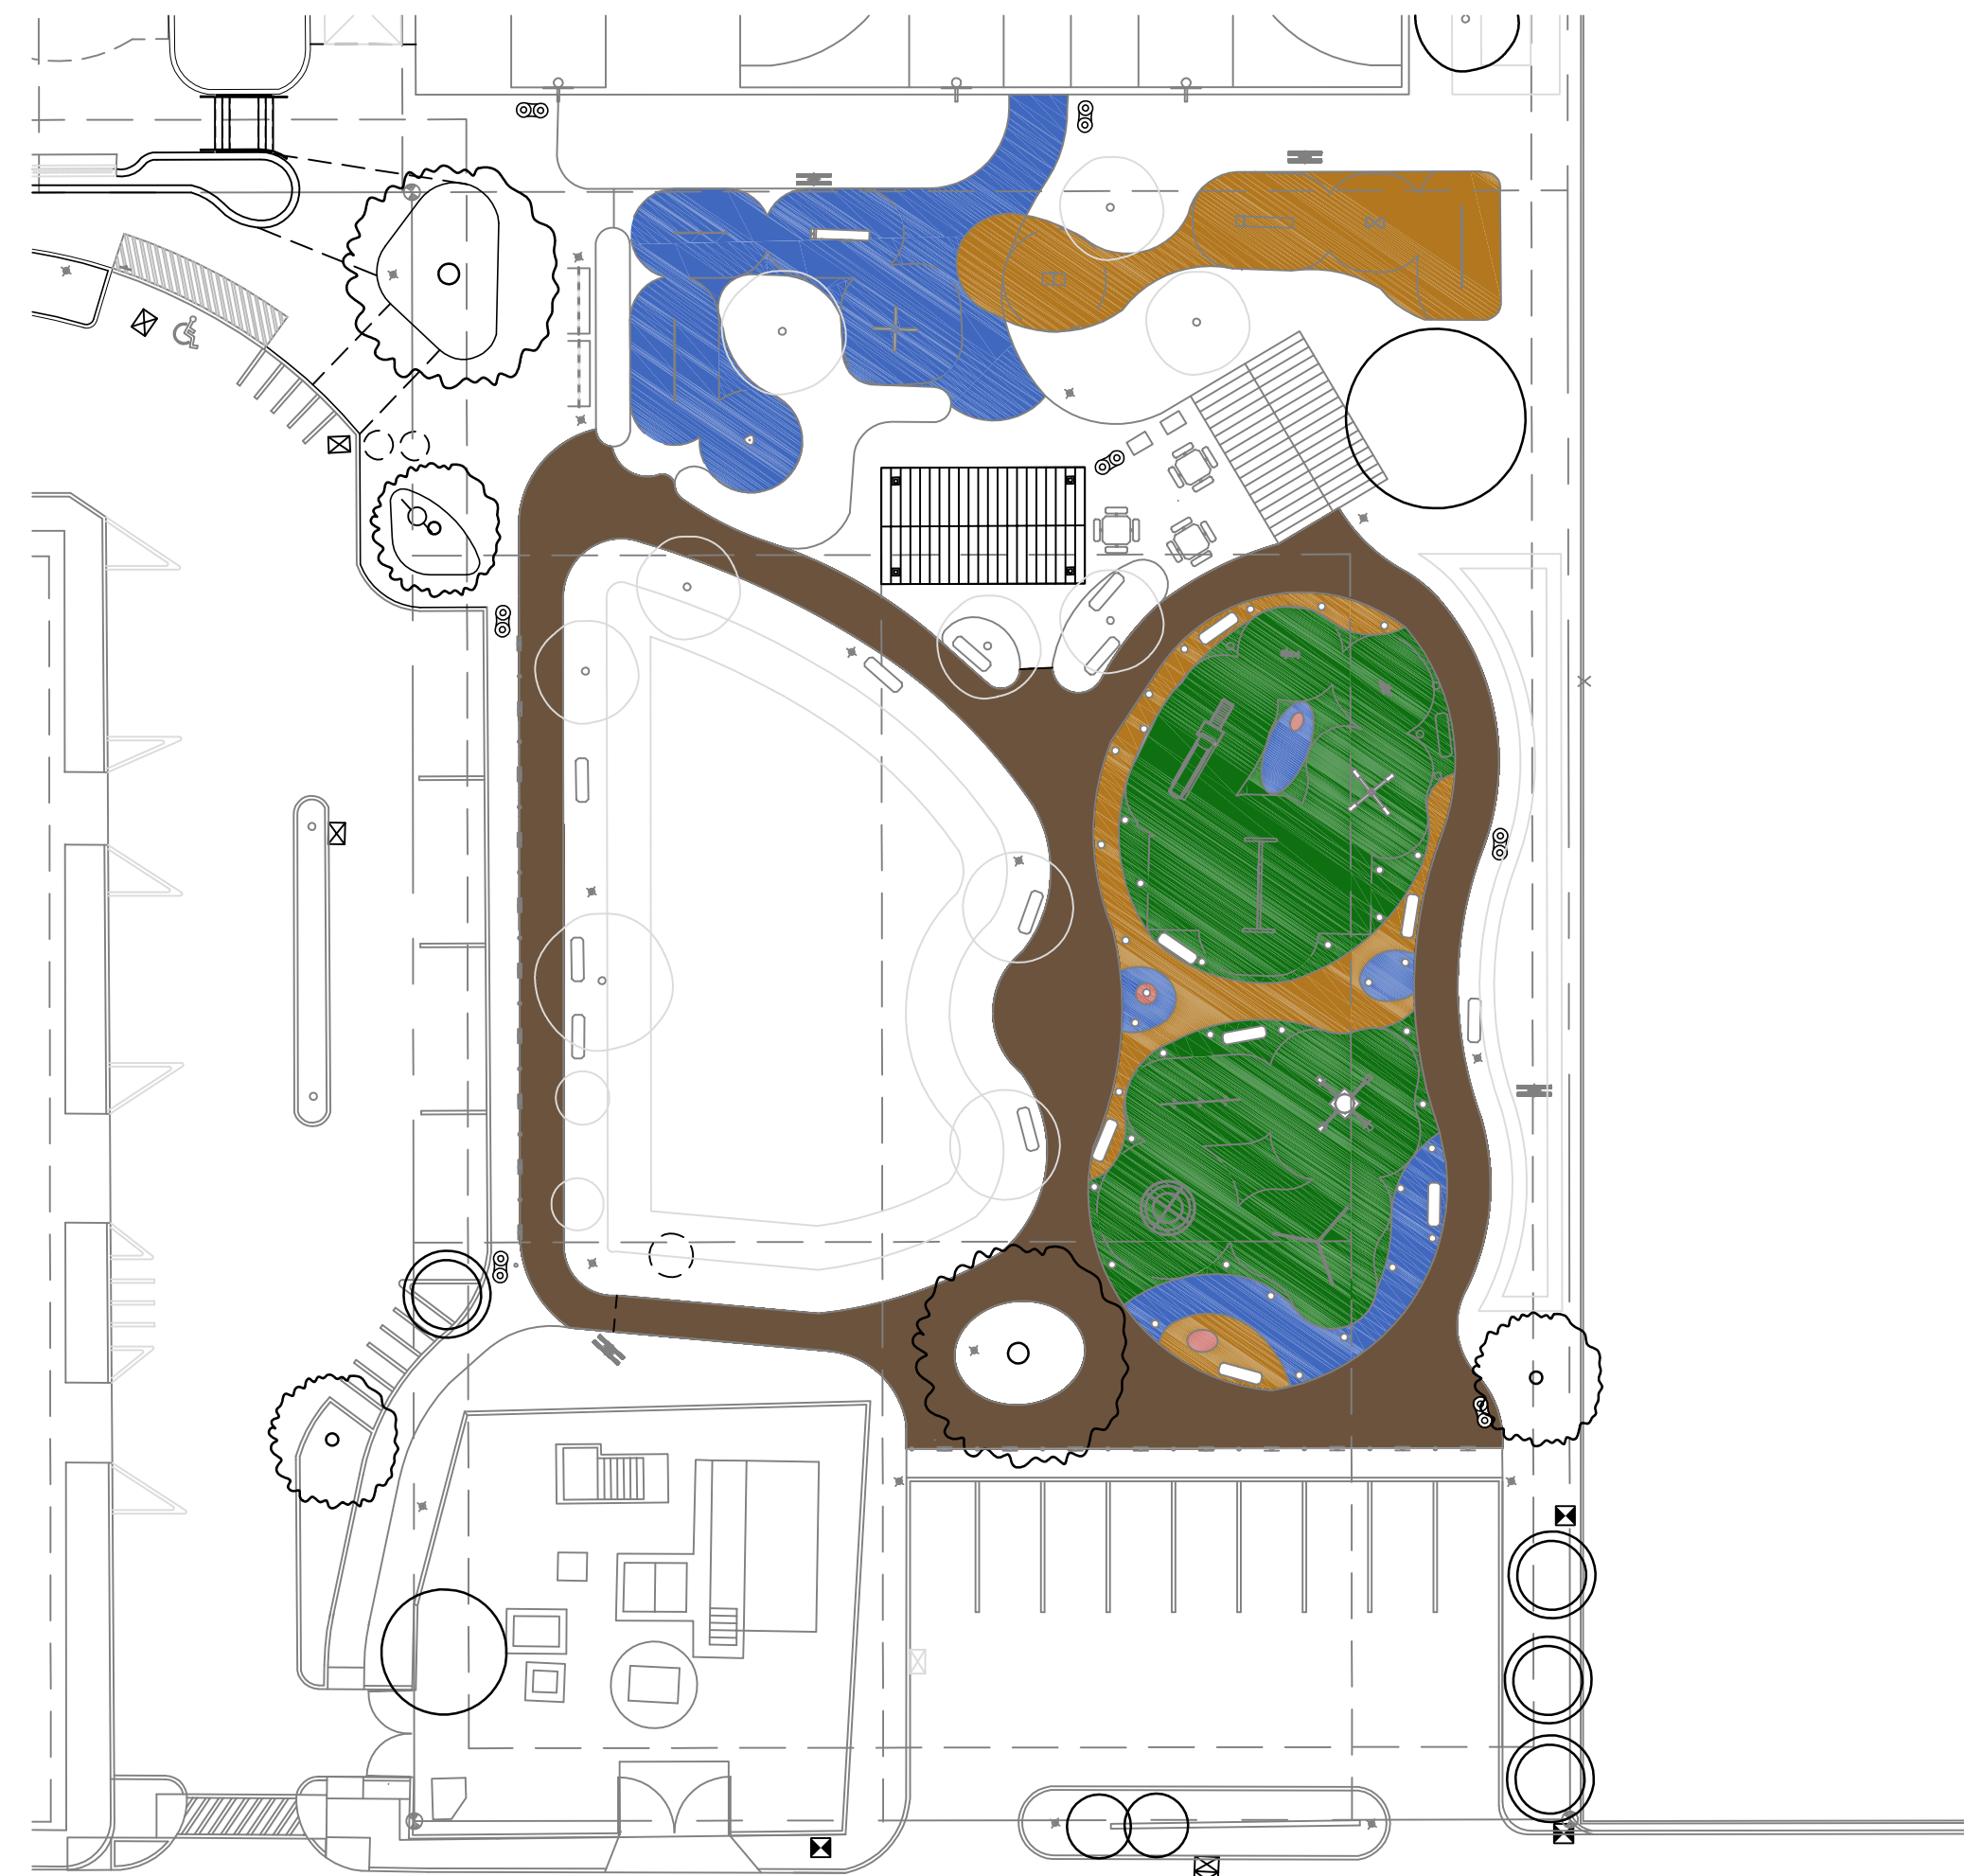
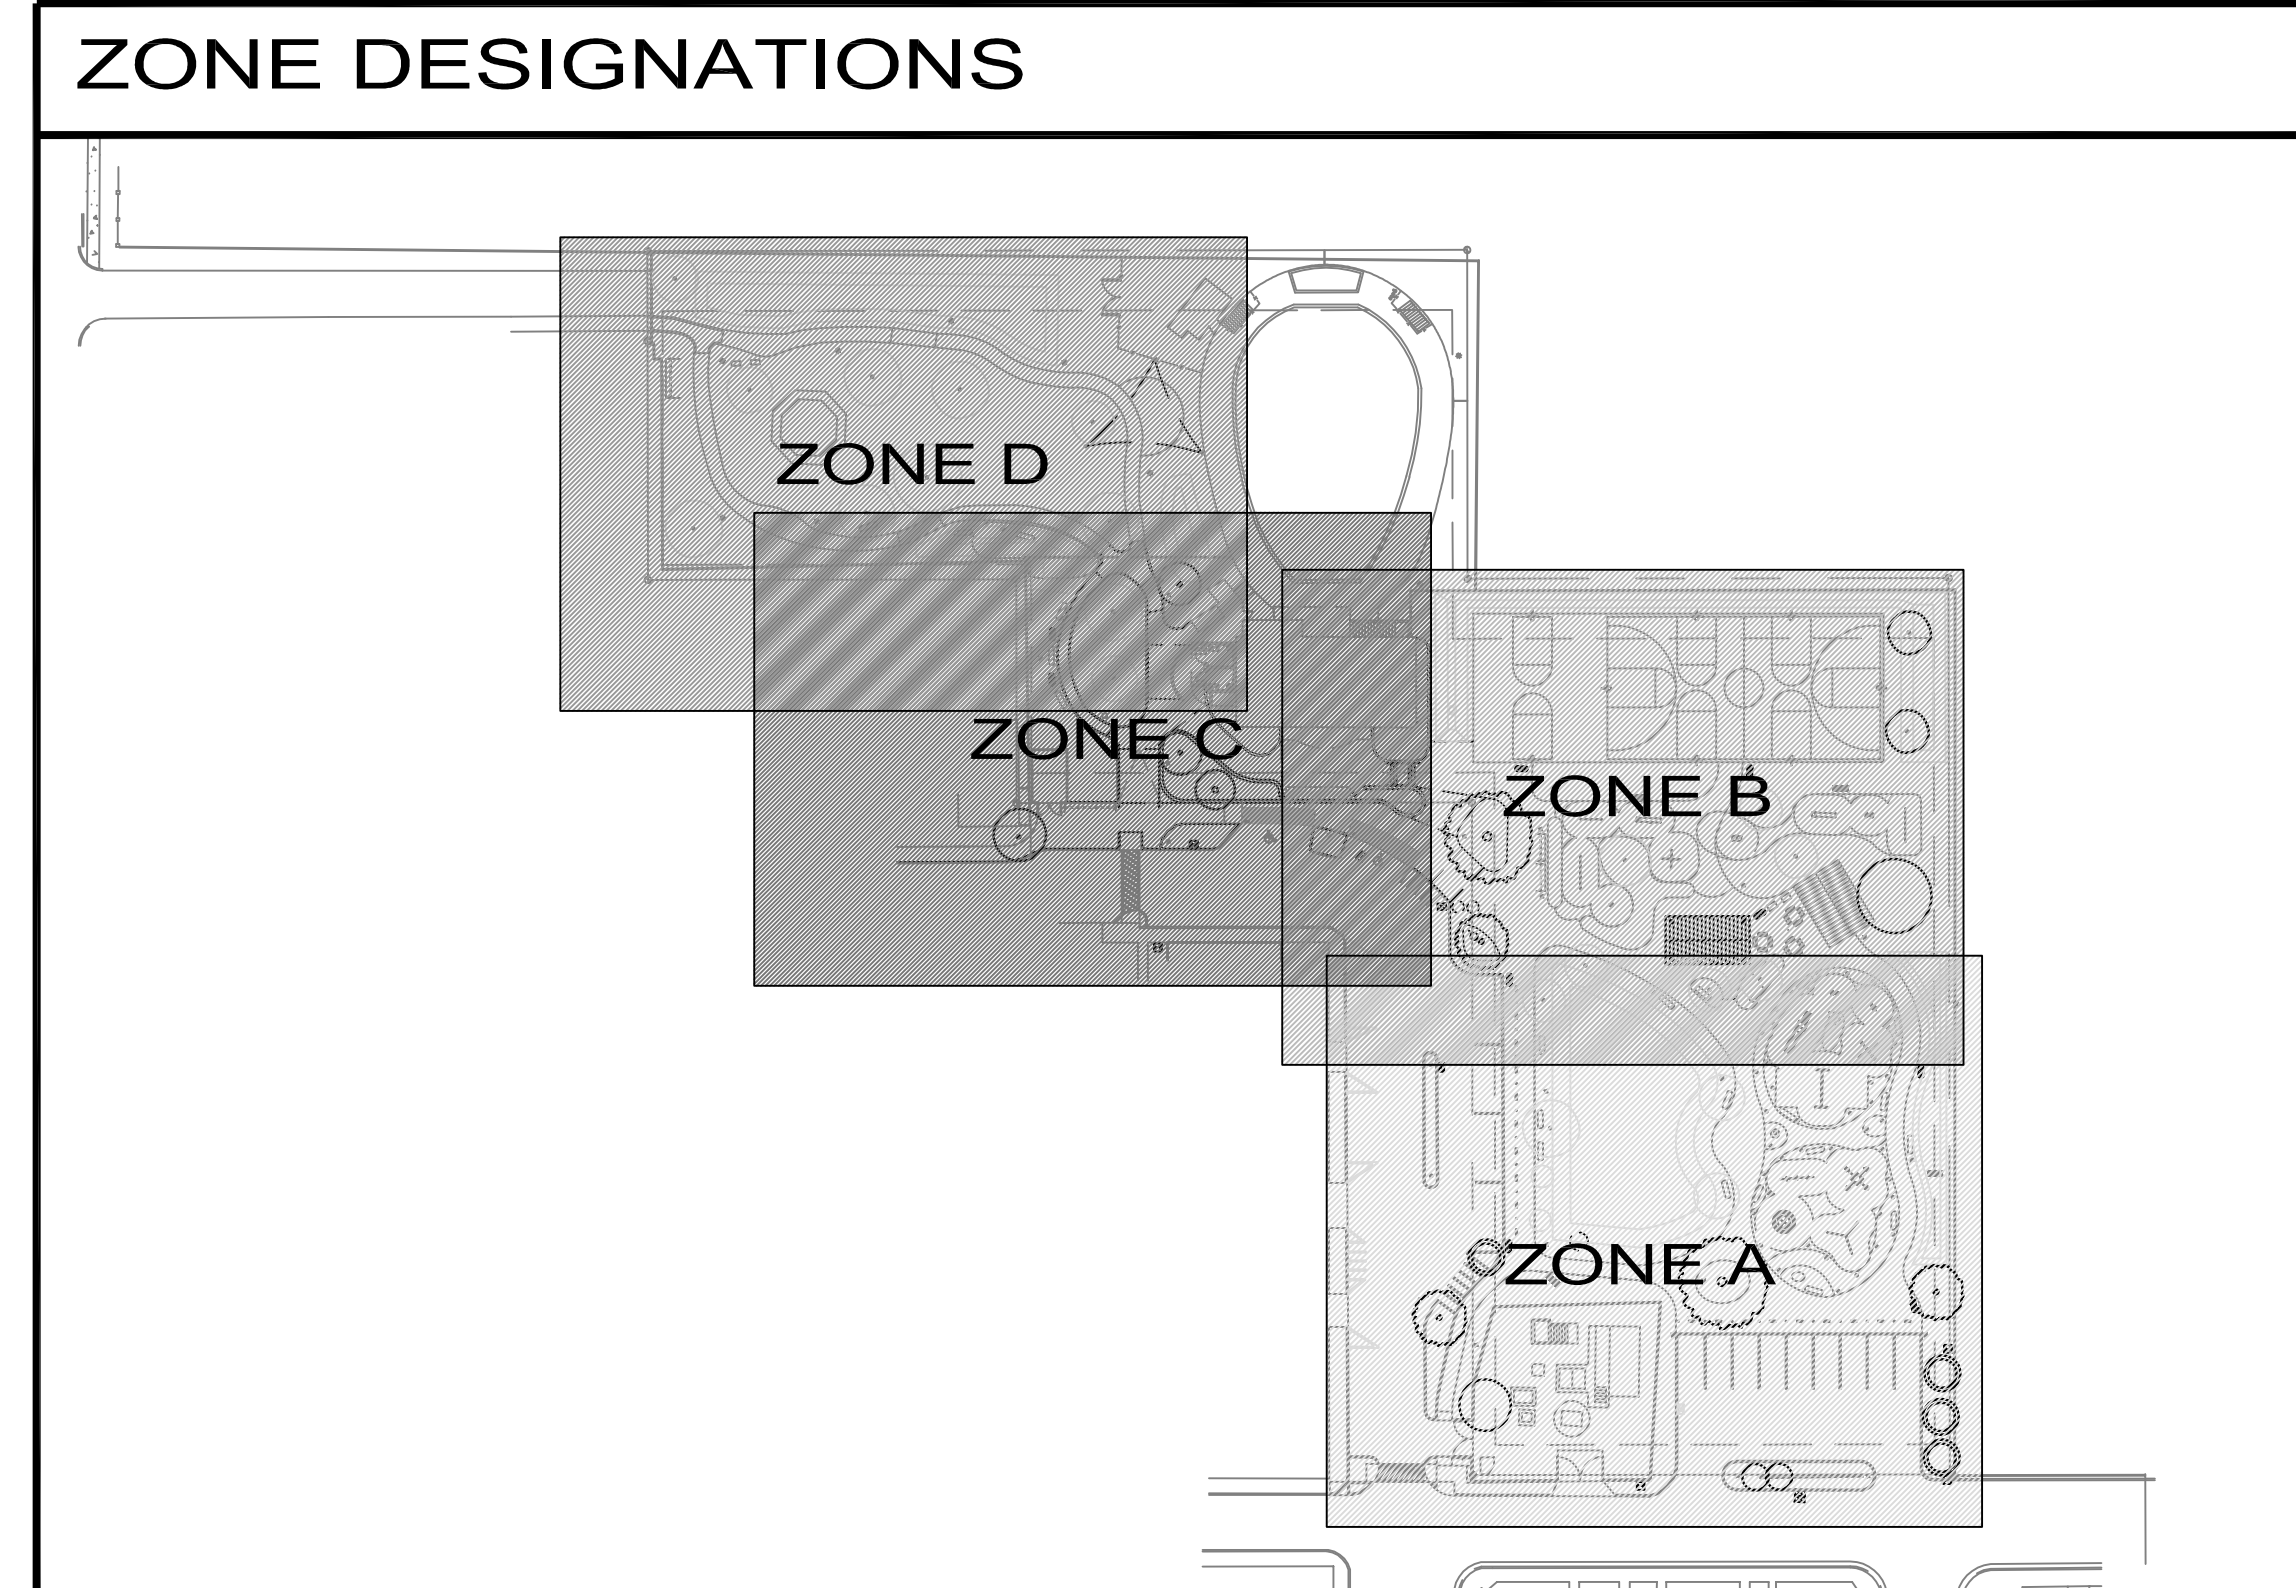
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HARDSCAPE
NOTES AND LEGENDS

Sheet Number:

A1.2.0

Date: January 27, 2012

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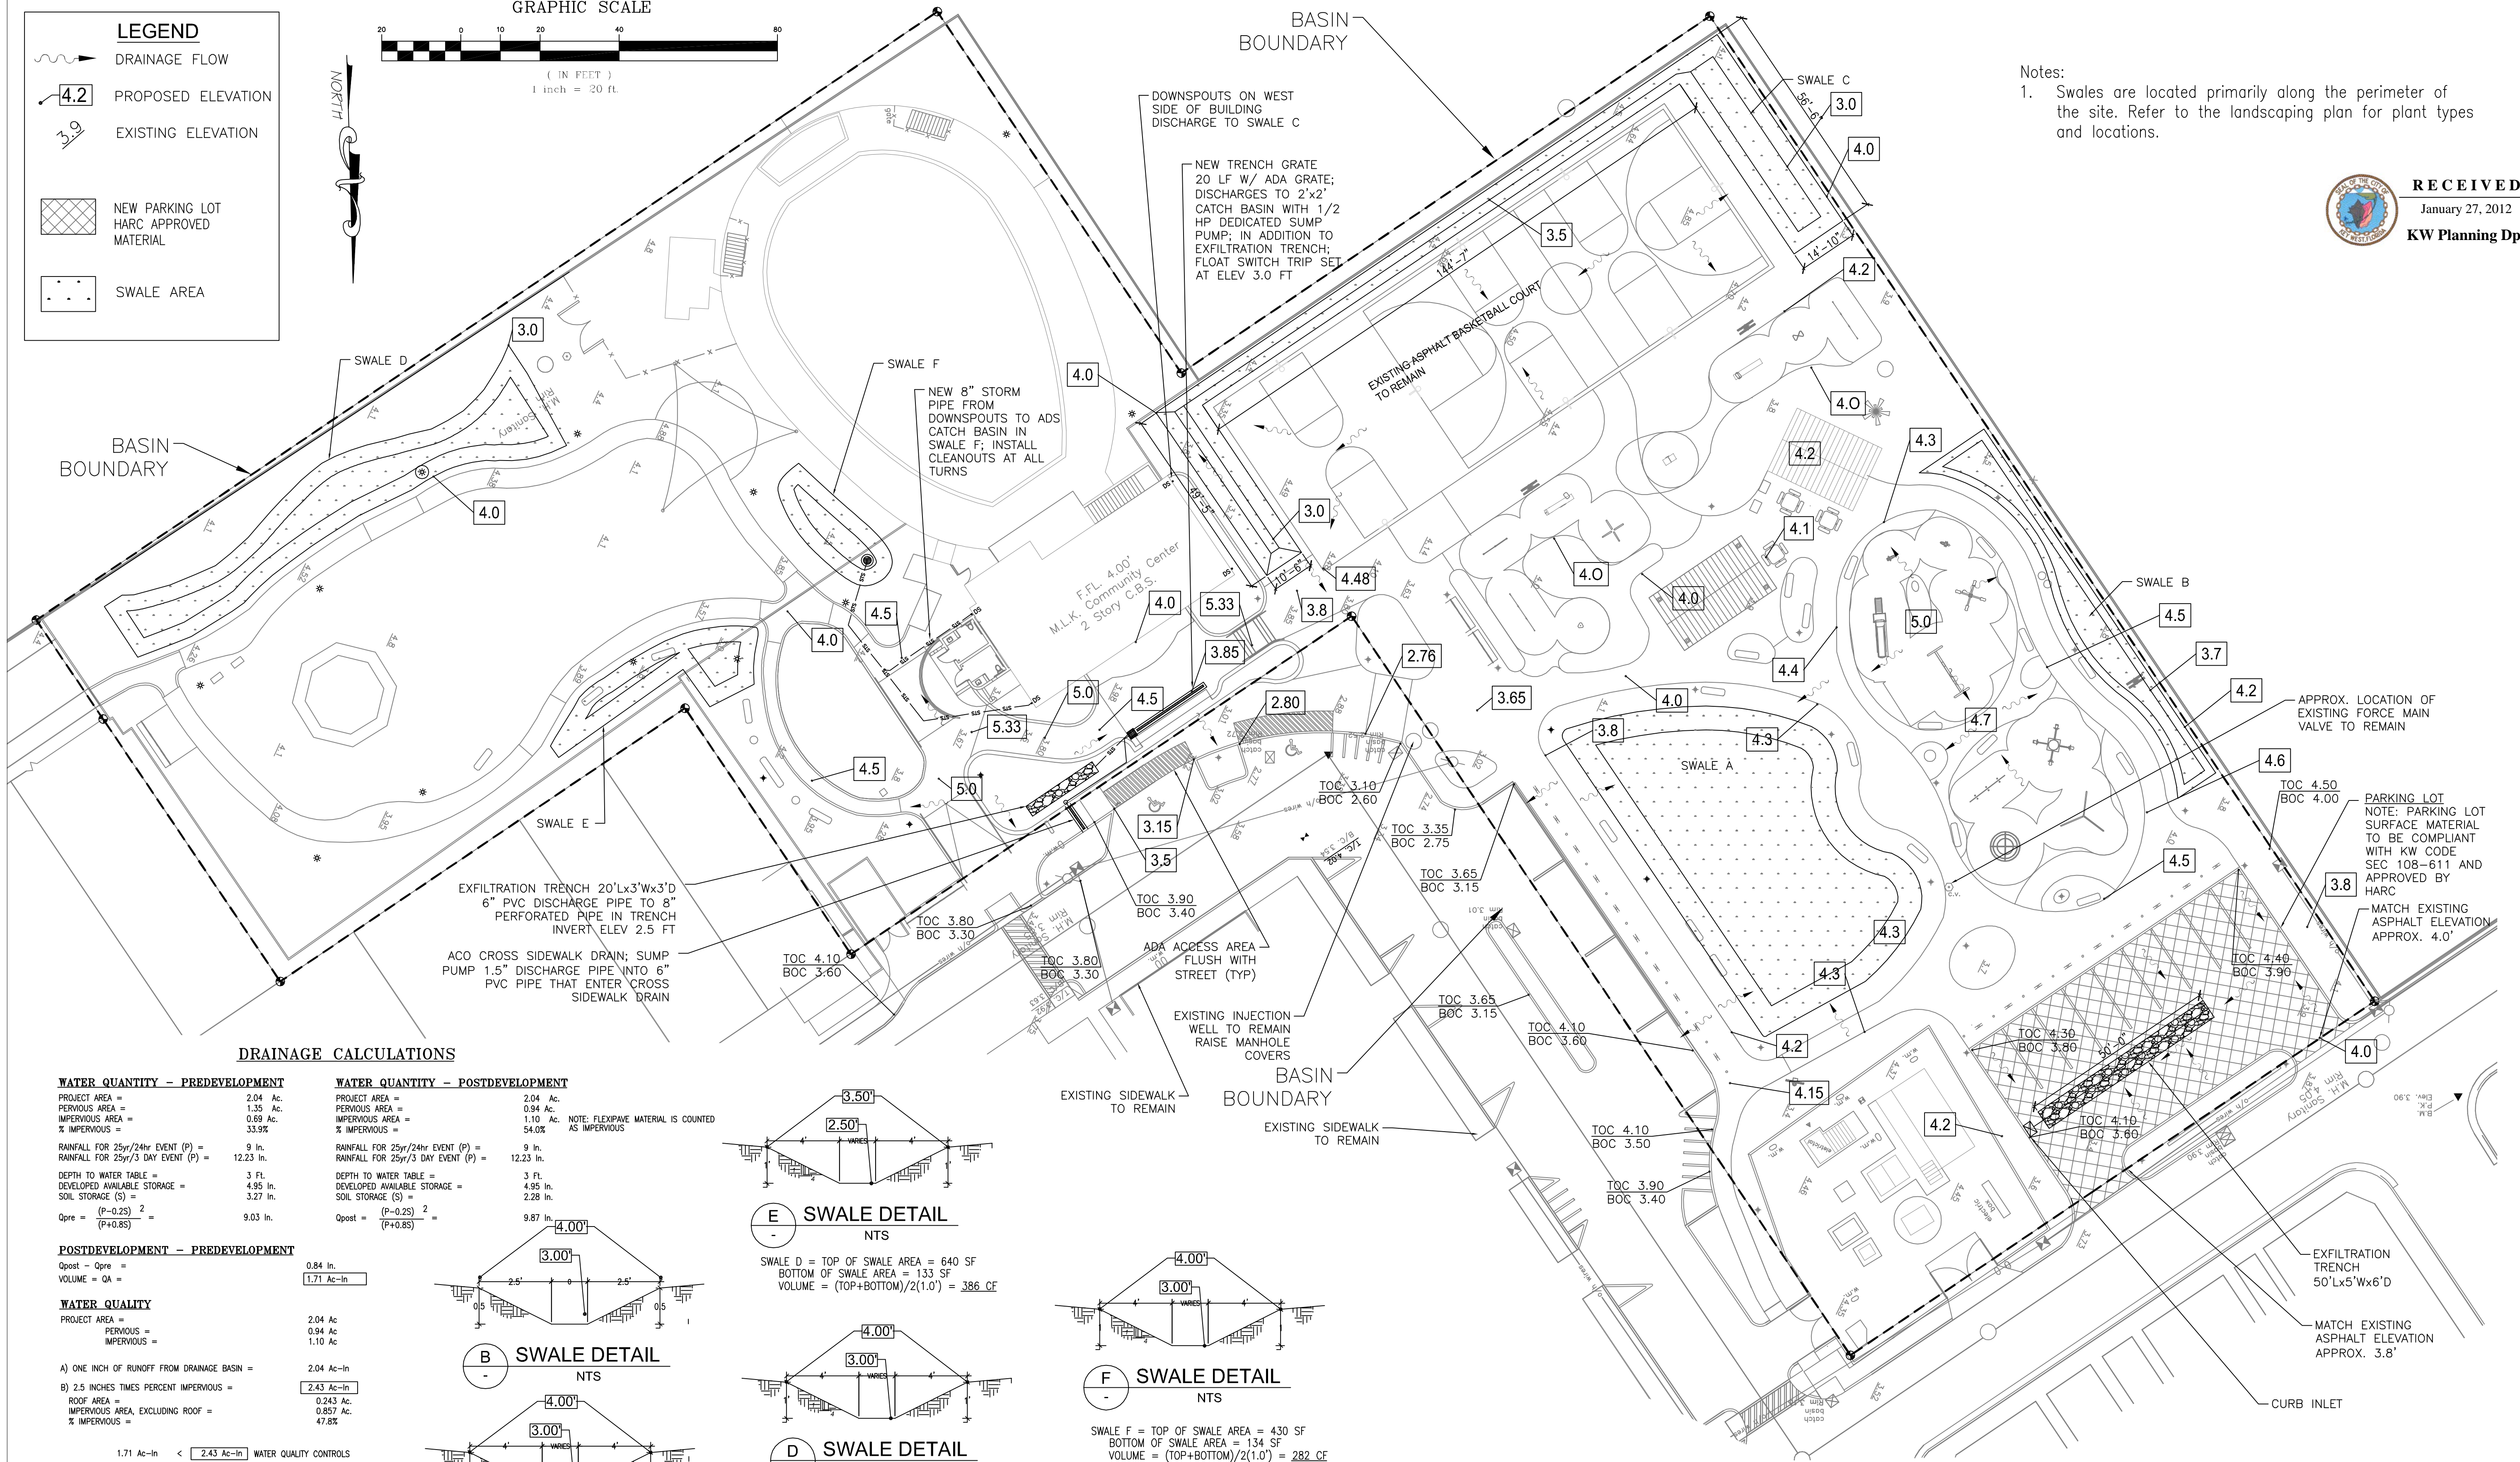
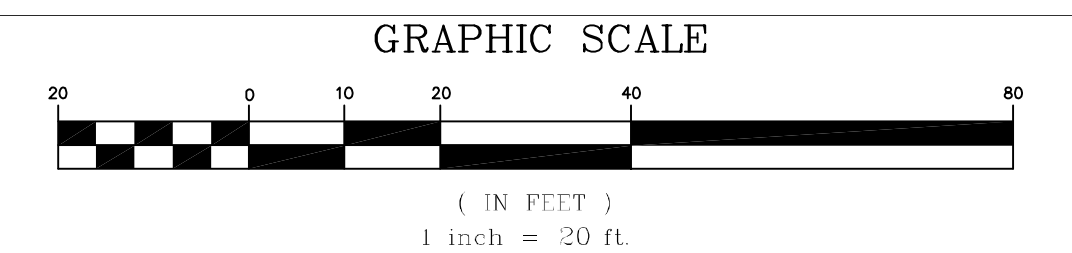
PAVING SCHEDULE

	FLEXIBLE PAVING COLOR A MANUFACTURER: KBI FLEXI-PAVE PRODUCT TYPE: P2000 PRODUCT COLOR: CYPRESS
	FLEXIBLE PAVING COLOR B MANUFACTURER: KBI FLEXI-PAVE PRODUCT TYPE: P2000 PRODUCT COLOR: GREEN
	FLEXIBLE PAVING COLOR C MANUFACTURER: KBI FLEXI-PAVE PRODUCT TYPE: P2000 PRODUCT COLOR: ADA BLUE
	FLEXIBLE PAVING COLOR D MANUFACTURER: KBI FLEXI-PAVE PRODUCT TYPE: P2000 PRODUCT COLOR: RED
	FLEXIBLE PAVING COLOR E MANUFACTURER: KBI FLEXI-PAVE PRODUCT TYPE: HD2000 PRODUCT COLOR: ADA DARK BROWN
	ASPHALT PAVEMENT
	CONCRETE SIDEWALK
	PAVER SIDEWALK


01 FLEXI-PAVE COLORS
A1.2.0 SCALE: NTS

LEGEND

- DRAINAGE FLOW
- PROPOSED ELEVATION
- EXISTING ELEVATION
- NEW PARKING LOT HARC APPROVED MATERIAL
- SWALE AREA



Notes:
1. Swales are located primarily along the perimeter of the site. Refer to the landscaping plan for plant types and locations.

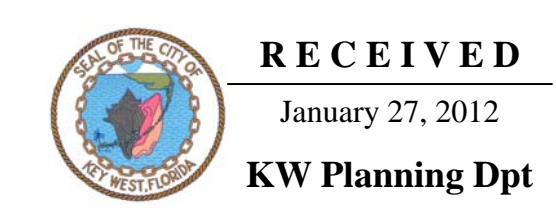

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Southwest Florida | Washington DC

Seal:

Richard J. Millili
P.E. No. 58315

Consultants:
LANDSCAPE ARCHITECT:
Craig Reynolds, PLA
CIVIL ENGINEER:
Meridian Engineering, LLC
231 Front Street, Suite 207
Key West, Florida 33040
Cert of Auth 29401

Submissions:
July 28, 2011 - Public Meeting #1
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Board Submission

NELSON ENGLISH / WILLIE WARD
PARK ENHANCEMENT PROJECT
CITY OF KEY WEST
300 Catherine Street, Key West, Florida 33040

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Drawn By: Checked By:
Title: DRAINAGE PLAN
Sheet Number: **C-1**
Date: January 27, 2012
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DRAINAGE CALCULATIONS

WATER QUANTITY - PREDEVELOPMENT

PROJECT AREA =	2.04 Ac.
PERVIOUS AREA =	1.35 Ac.
IMPERVIOUS AREA =	0.69 Ac.
% IMPERVIOUS =	33.9%
RAINFALL FOR 25yr/24hr EVENT (P) =	9 in.
RAINFALL FOR 25yr/3 DAY EVENT (P) =	12.23 in.
DEPTH TO WATER TABLE =	3 ft.
DEVELOPED AVAILABLE STORAGE =	4.95 in.
SOIL STORAGE (S) =	3.27 in.
Oppe = $\frac{(P-0.2S)^2}{(P+0.8S)}$	9.03 in.

WATER QUANTITY - POSTDEVELOPMENT

PROJECT AREA =	2.04 Ac.
PERVIOUS AREA =	0.94 Ac.
IMPERVIOUS AREA =	1.10 Ac.
% IMPERVIOUS =	54.0%
RAINFALL FOR 25yr/24hr EVENT (P) =	9 in.
RAINFALL FOR 25yr/3 DAY EVENT (P) =	12.23 in.
DEPTH TO WATER TABLE =	3 ft.
DEVELOPED AVAILABLE STORAGE =	4.95 in.
SOIL STORAGE (S) =	2.28 in.
Opost = $\frac{(P-0.2S)^2}{(P+0.8S)}$	9.87 in.

NOTE: FLEXPAVE MATERIAL IS COUNTED AS IMPERVIOUS

POSTDEVELOPMENT - PREDEVELOPMENT
Opost - Oppe = 0.84 in.
VOLUME = OA = 1.71 Ac-in

WATER QUALITY

PROJECT AREA =	2.04 Ac.
PERVIOUS =	0.94 Ac.
IMPERVIOUS =	1.10 Ac.

A) ONE INCH OF RUNOFF FROM DRAINAGE BASIN = 2.04 Ac-in
B) 2.5 INCHES TIMES PERCENT IMPERVIOUS = 2.43 Ac-in
ROOF AREA = 0.243 Ac.
IMPERVIOUS AREA, EXCLUDING ROOF = 0.857 Ac.
% IMPERVIOUS = 47.8%











1.71 Ac-in < 2.43 Ac-in WATER QUALITY CONTROLS

SWALE VOLUME REQUIRED


SUBTRACT EXFILTRATION TRENCH VOLUME BEFORE CALCULATING SWALE VOLUME
SWALE VOLUME REQUIRED = (2.43 - 0.43) * 3630 * 50% CREDIT DRY RETENTION = 3,630 CF
SWALE VOLUME PROVIDED = A + B + C + D + E + F = 3,899 CF
SWALE VOLUME PROVIDED IS GREATER TO ACCOUNT FOR TREES AND SHRUBS

EXFILTRATION TRENCH PROVIDED



TRENCH LENGTH = 30 FT
EXFILTRATION TRENCH VOLUME CALCULATED USING SF/MD EQUATION (PG 7-10 OF THE ERP INFORMATION MANUAL)
VARIABLES K=0.0001; H=5; W=5; Dm=3; Ds=2
VOLUME = 0.43 Ac-in

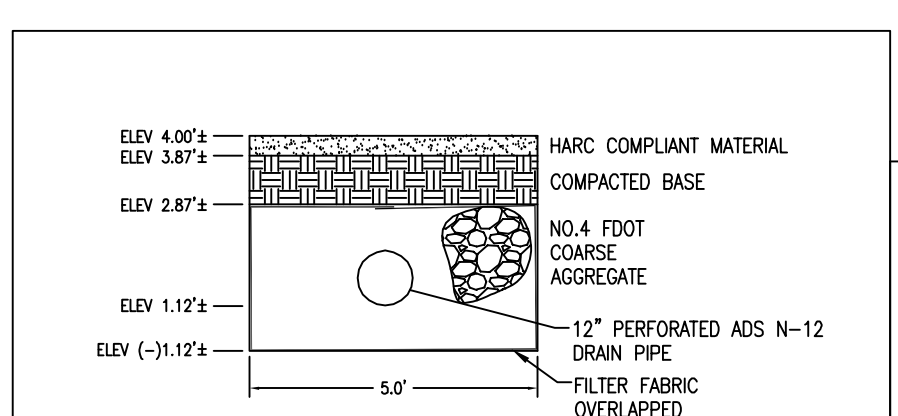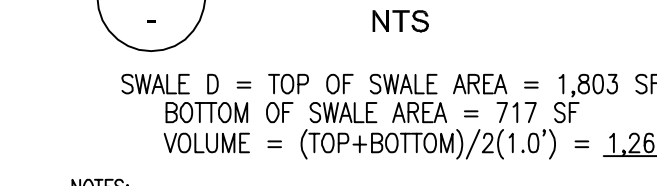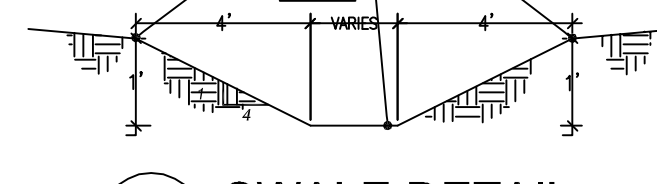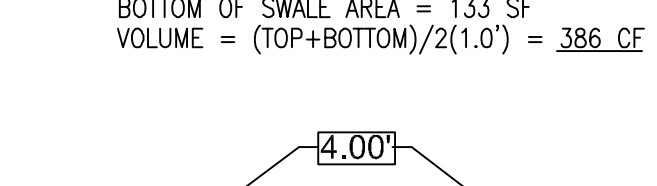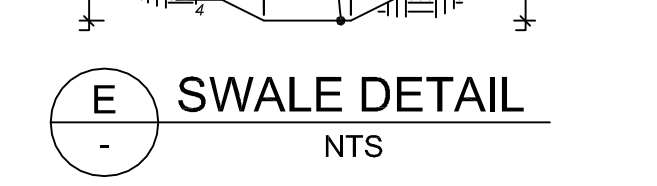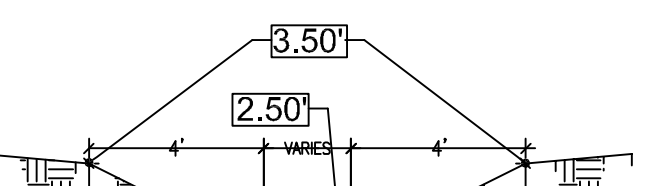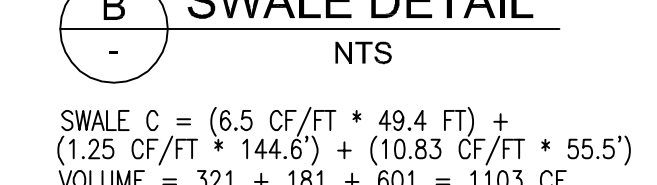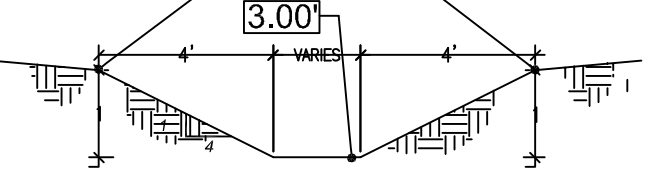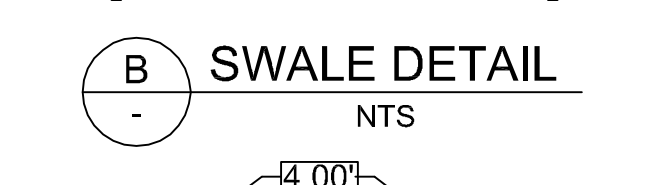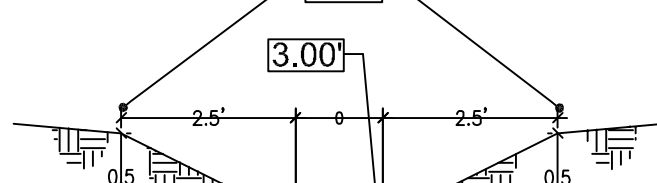

NOTES:
1. FILTER FABRIC SHALL BE MARAFI FILTERWEAVE 300 OR ENGINEER APPROVED EQUIVALENT. FILTER FABRIC SHALL BE INSTALLED PER MANUFACTURER'S INSTRUCTIONS.

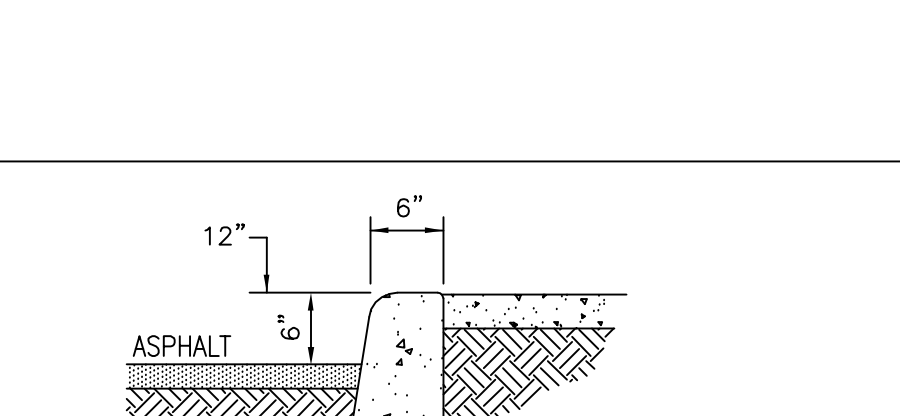

NOTES:
1. CONTRACTOR MAY USE SURPLUS GRANITE CURB. COORDINATE WITH CITY OF KEY WEST PERSONNEL.

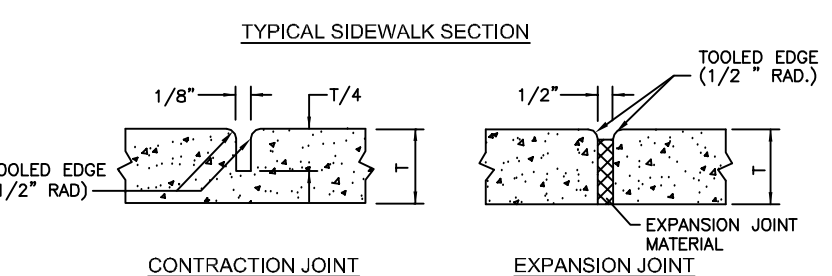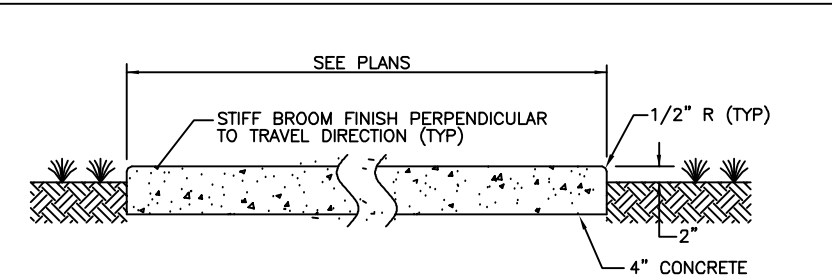

NOTES:
1. THICKNESS OF LAYERS SHALL BE DETERMINED BY LANDSCAPE ARCHITECT.



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Best
Consultants:
Civil Engineer:
Merrill Engineering, LLC
Landscape Architect:
Cary Reynolds, P.A.


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01.01.02 - Plant Material
01.01.03 - Plant Material
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01.01.05 - Plant Material
01.01.06 - Plant Material
01.01.07 - Plant Material
01.01.08 - Plant Material
01.01.09 - Plant Material
01.01.10 - Plant Material

NELSON ENGLISH / WILLIE WARD
PARK ENHANCEMENT PROJECT
CITY OF KEY WEST
300 Catherine Street, Key West, Florida 33040

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Drawn By: MK | Checked By: MK


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LANDSCAPE PLAN
ZONE B


Sheet Number:
L1.2.2
Date: January 27, 2012
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- NOTES:
1. REPLACE ST. AUGUSTINE SOD AS NEEDED THIS ENTIRE AREA - USE 1" MIN. SILICA SAND AND AERATE EXISTING SOIL
 2. TRIM ALL TREES ACCORDING TO ASCA GUIDELINES TO ALLOW PROPER SUNLIGHT TO UNDERSTORY

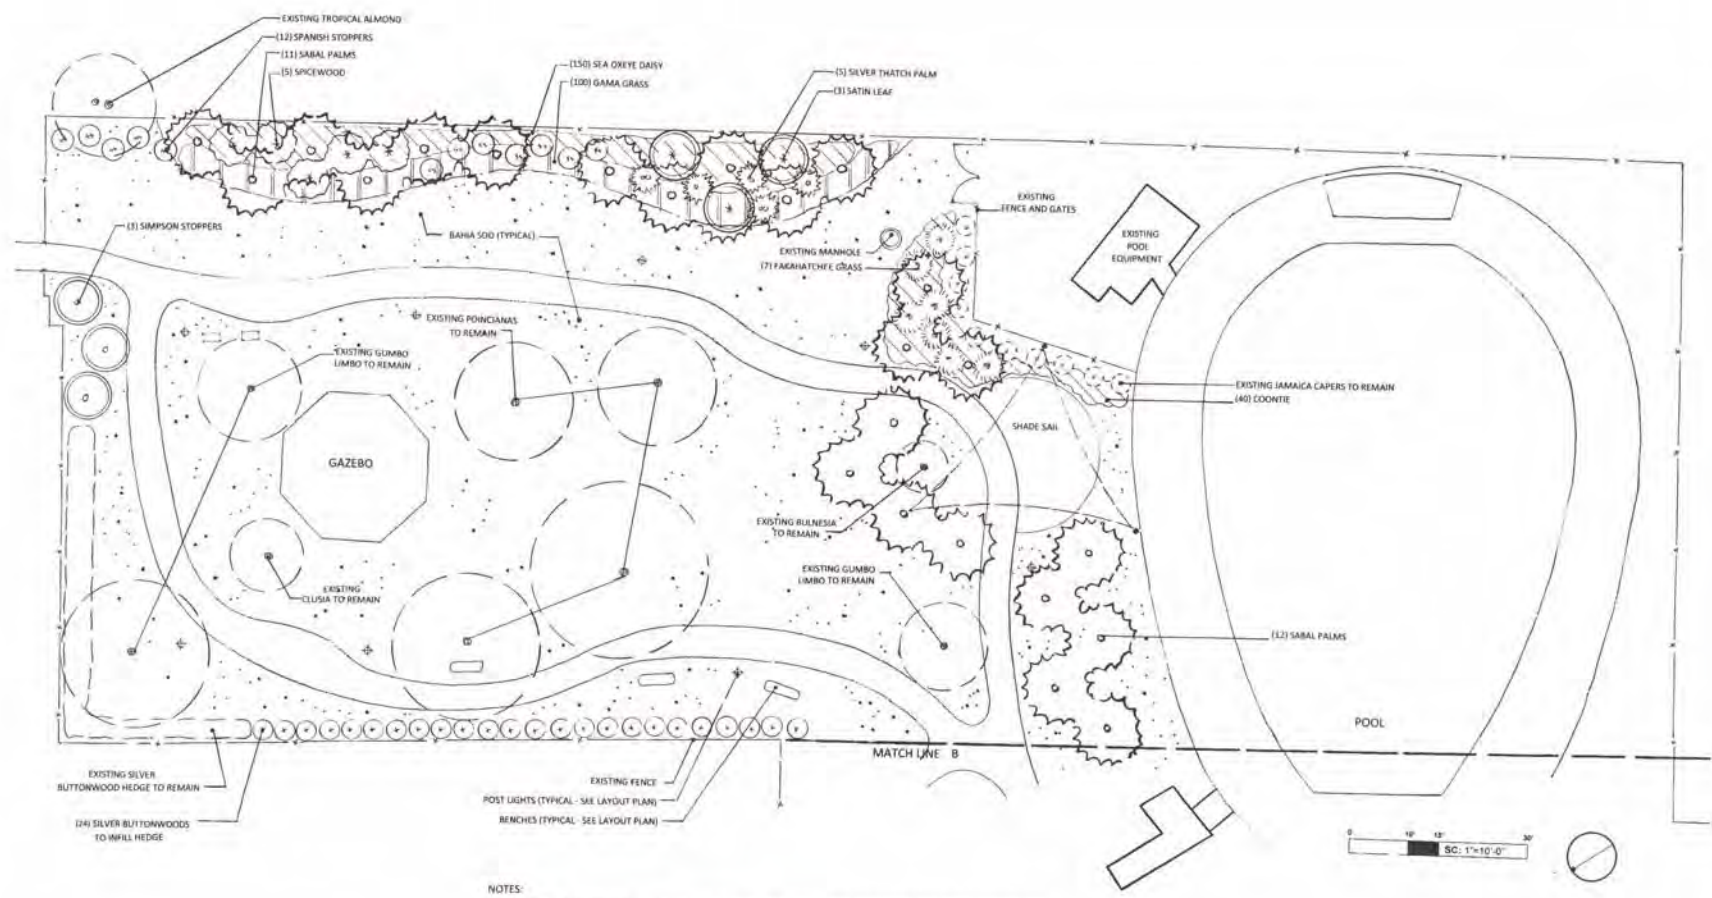01 LANDSCAPE PLAN - ZONE B
SCALE: 1"=10'-0"



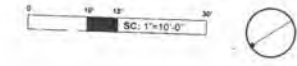

LANDSCAPE PLAN - ZONE C

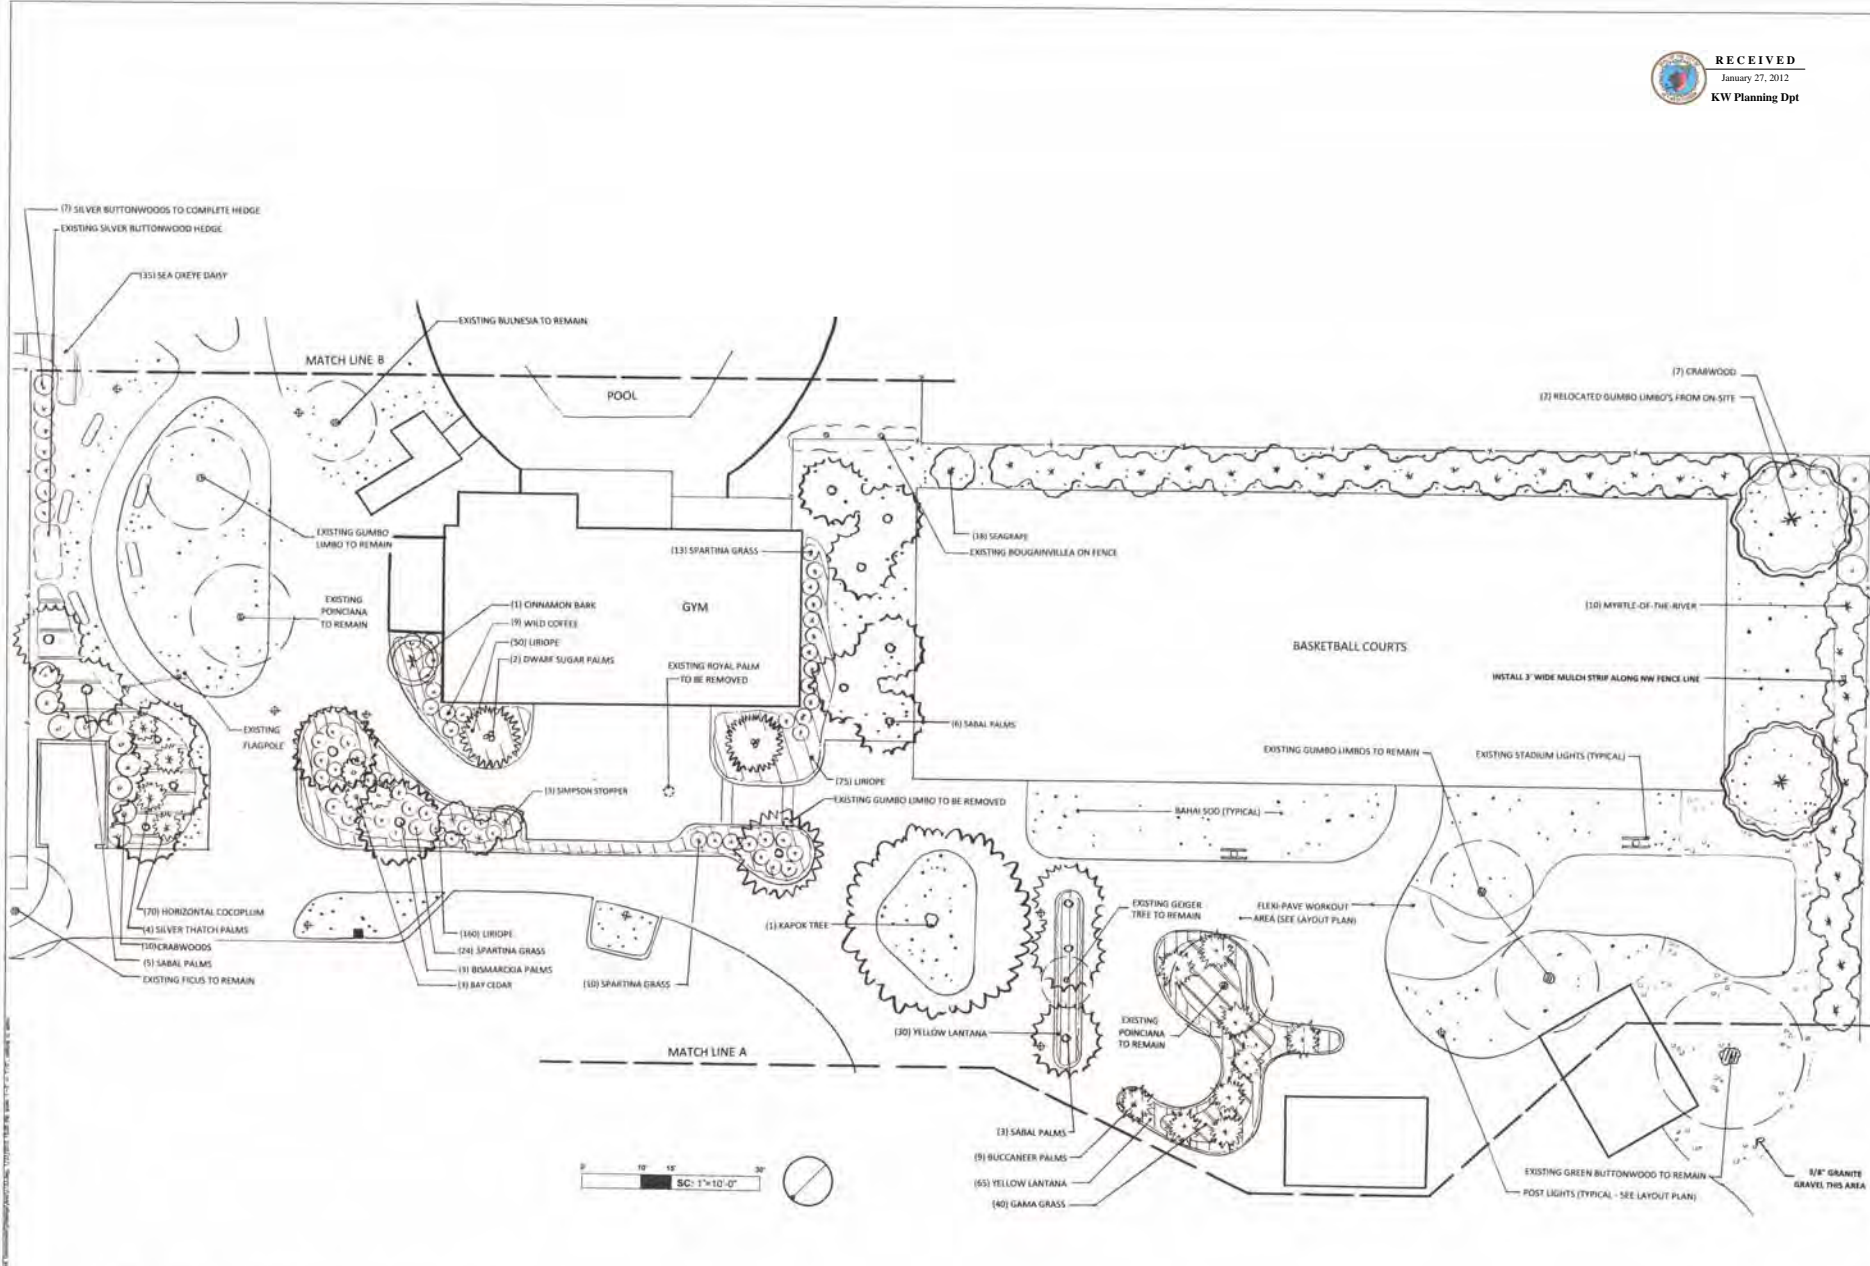SCALE: 1"=10'-0"





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Consultants:
CIVIL ENGINEER:
Meridian Engineering, LLC
LANDSCAPE ARCHITECT:
Craig Reynolds, RLA

Submissions:

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CITY OF KEY WEST
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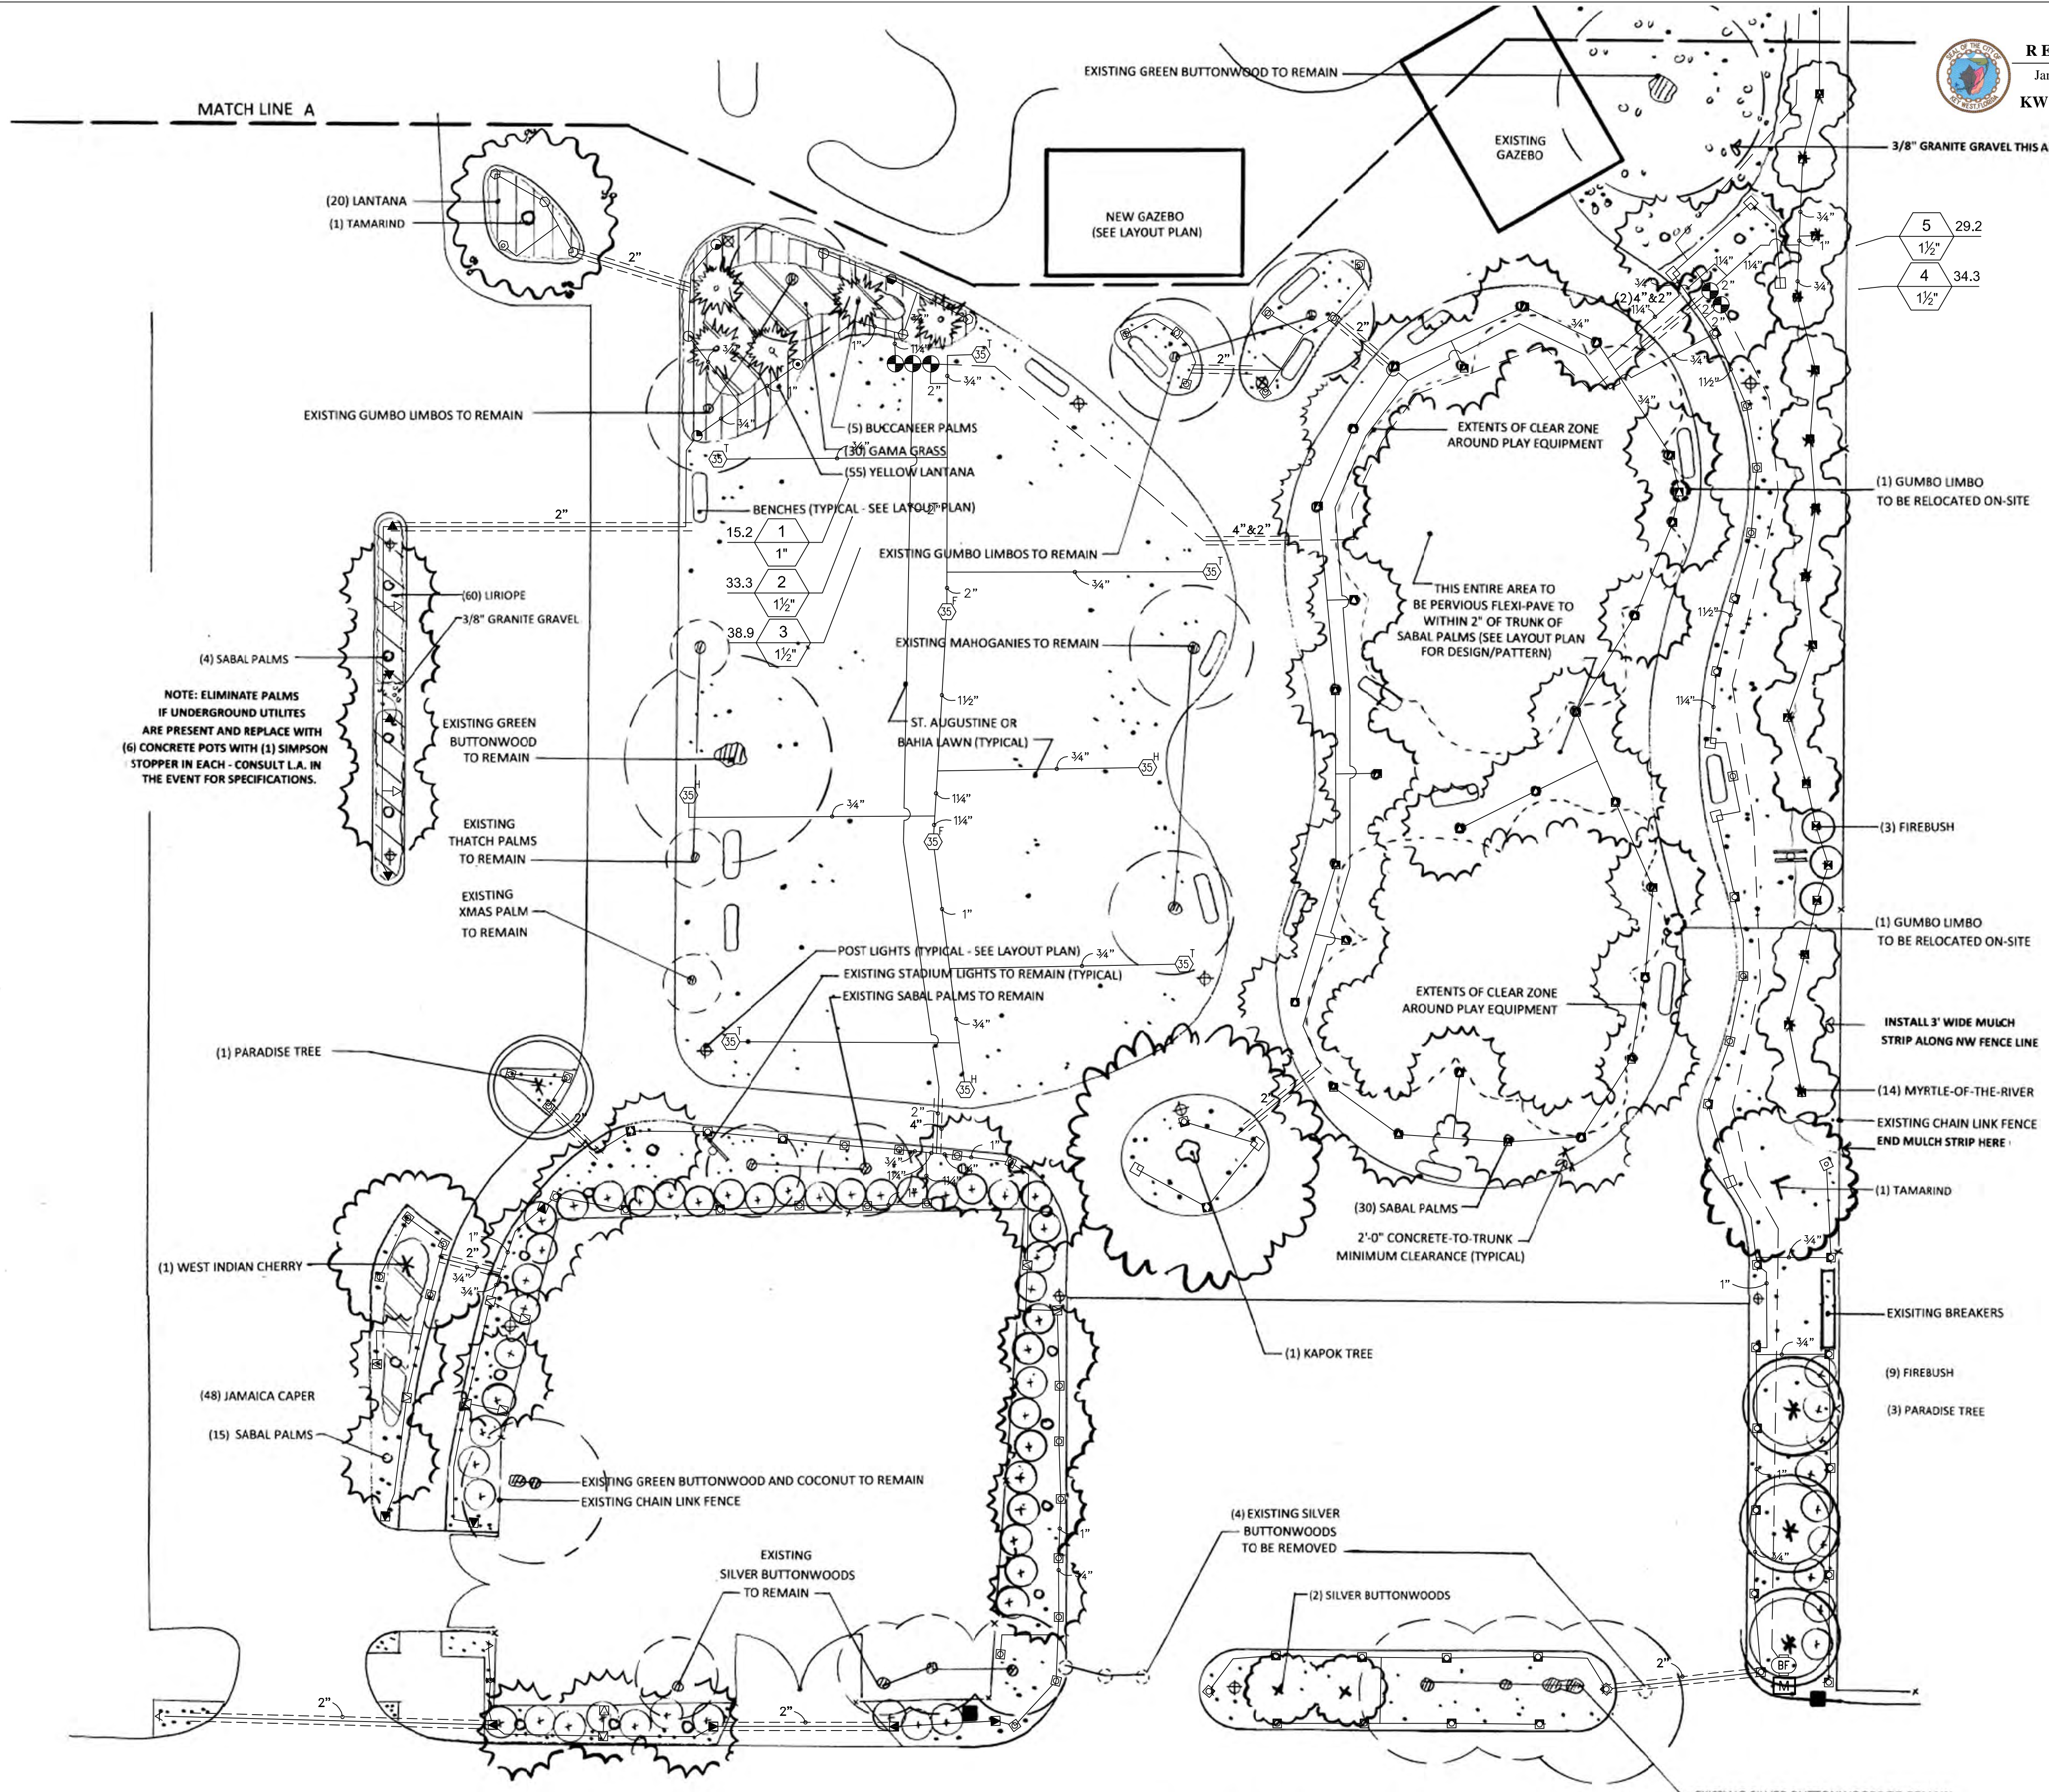
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Drawing Size: 24x36 | Project #: MK-11035
Drawn By: ADS | Checked By: MBI

Title:
IRRIGATION PLAN
ZONE A


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Date: January 18, 2012
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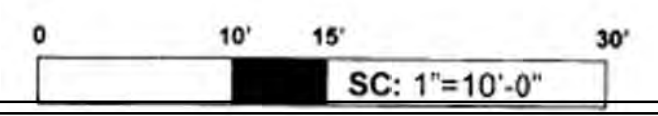


NOTE: ELIMINATE PALMS
IF UNDERGROUND UTILITIES
ARE PRESENT AND REPLACE WITH
(6) CONCRETE POTS WITH (1) SIMPSON
STOPPER IN EACH - CONSULT L.A. IN
THE EVENT FOR SPECIFICATIONS.



IRRIGATION PLAN - ZONE A

SCALE: 1"=10'-0"

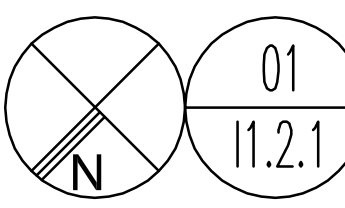

P:\017172 Nelson English Park\Nelson English Park\Irrigation\11035\11035_11.2.1.dwg, 1/19/2012 4:09 PM, scale: 1"=10'-0", drawn:



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Consultants:
CIVIL ENGINEER:
Meridian Engineering, LLC
LANDSCAPE ARCHITECT:
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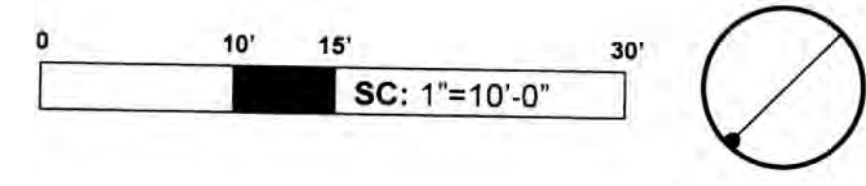
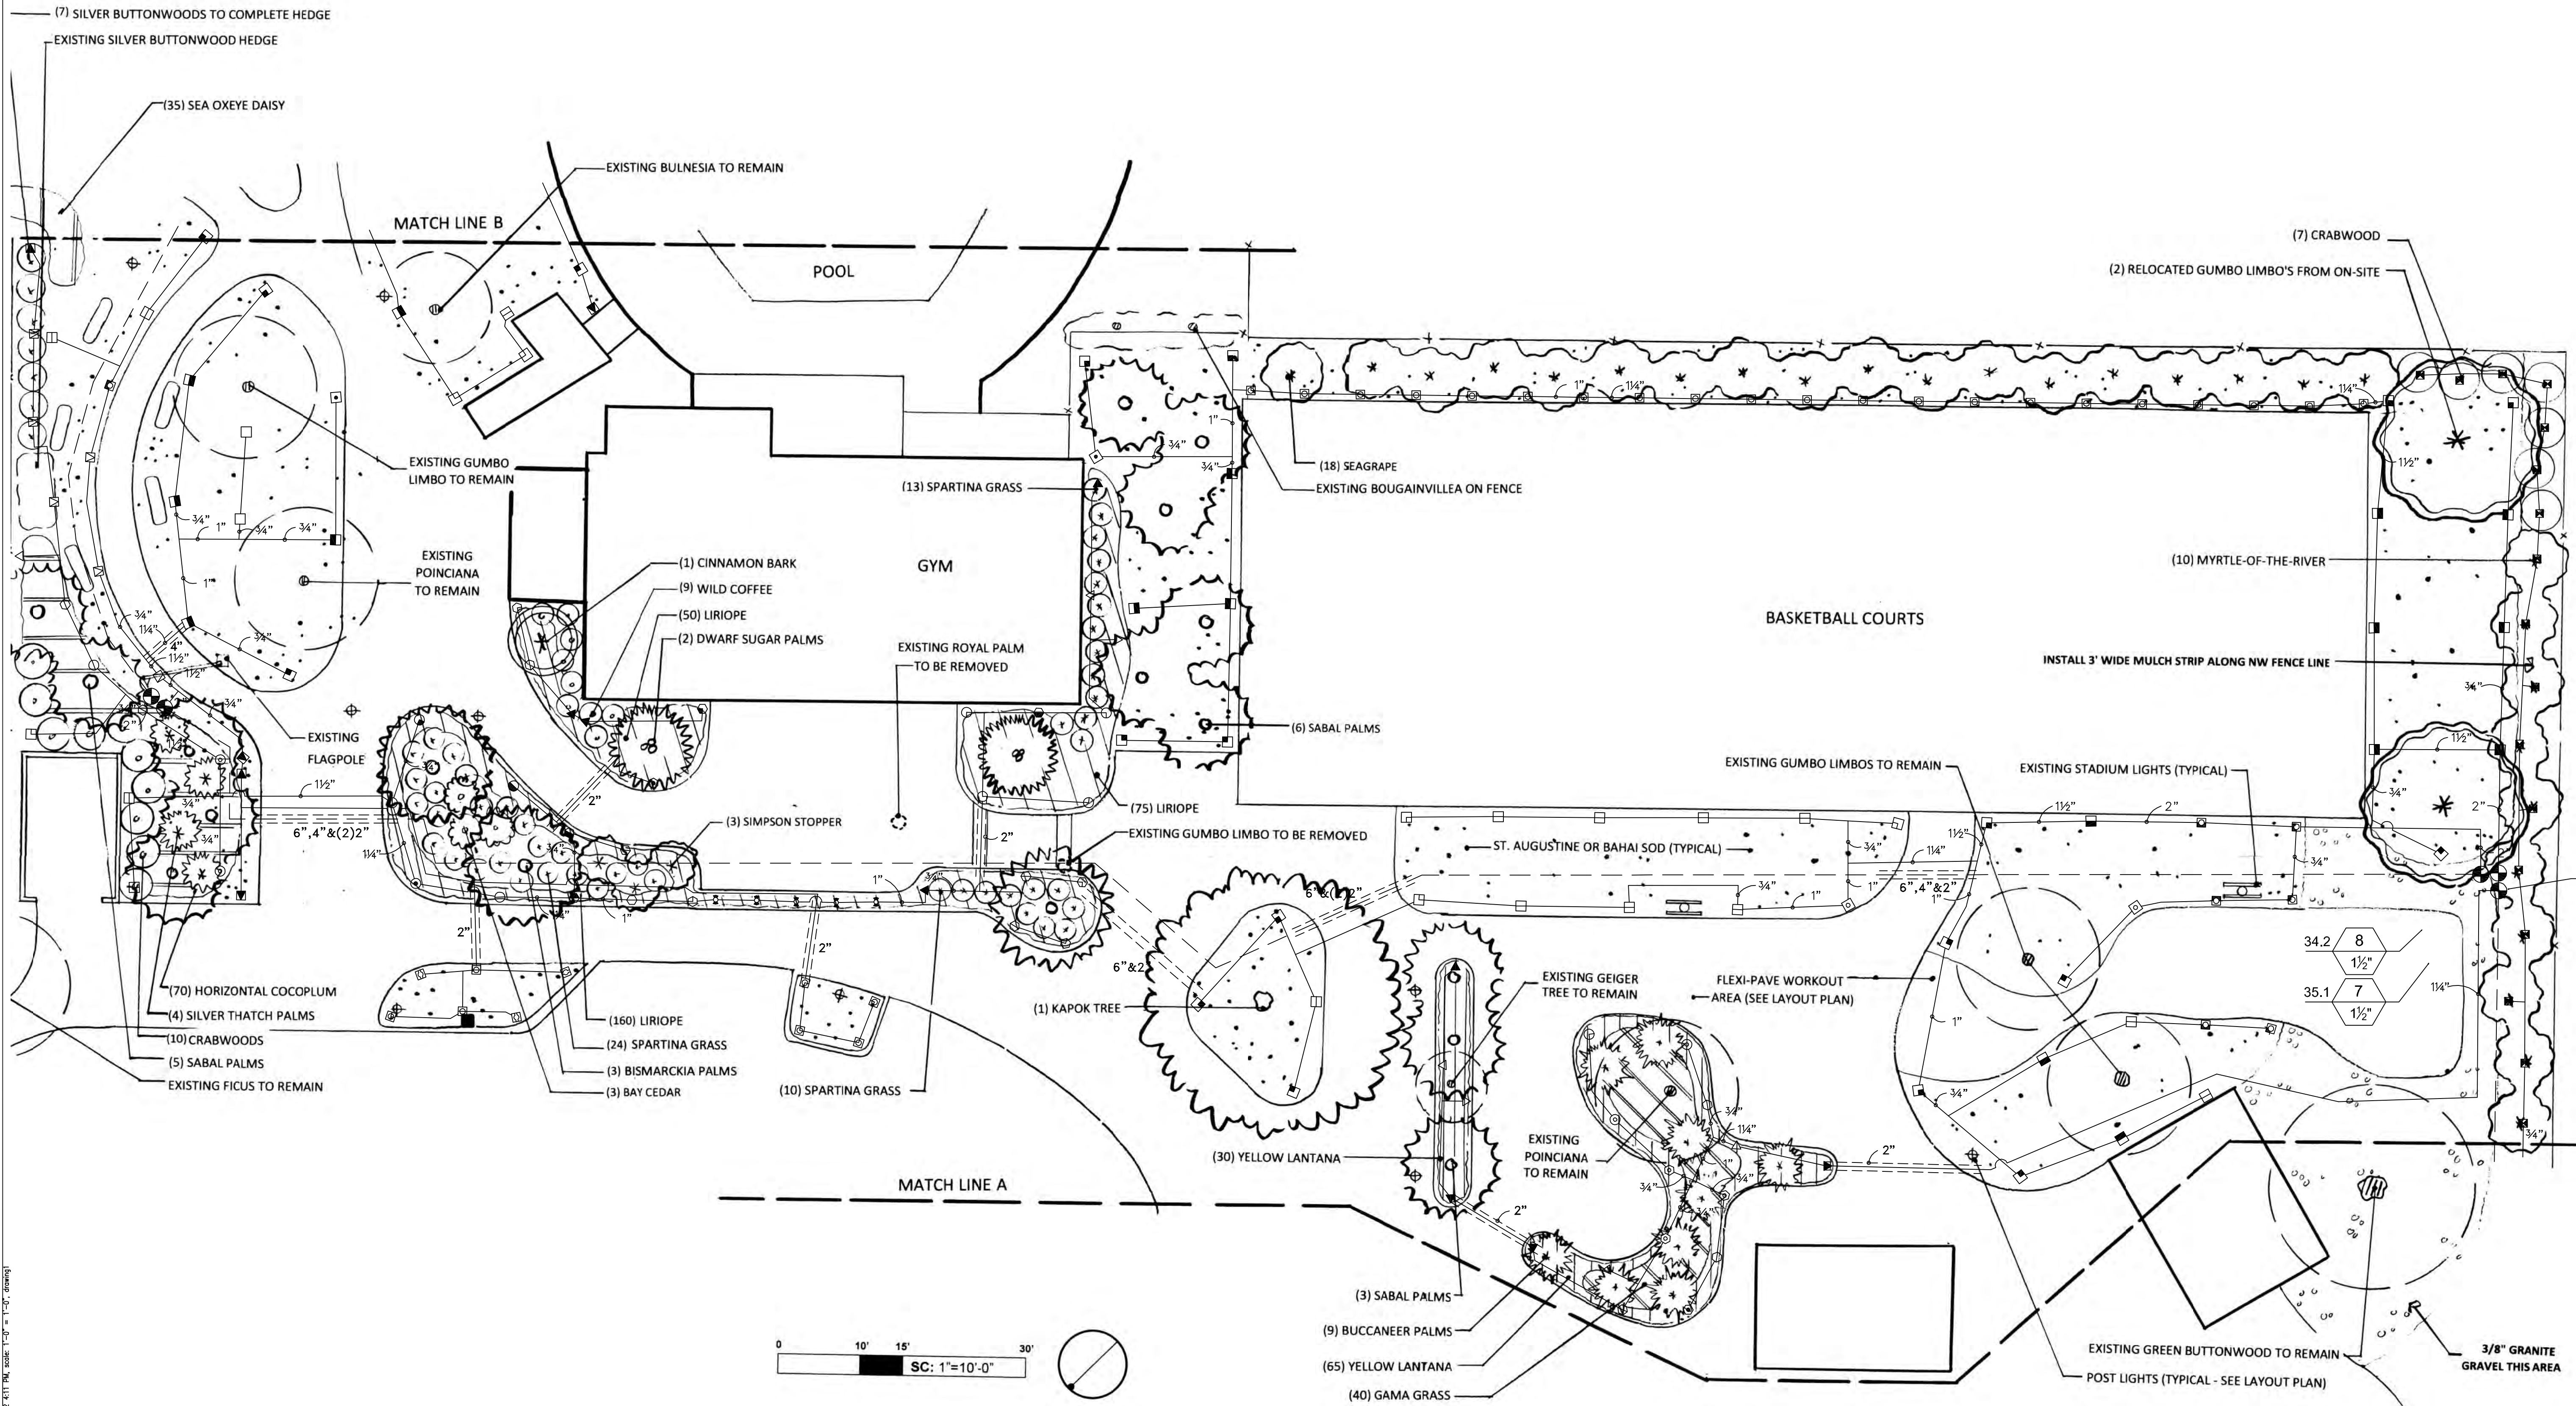
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Drawn By: ADS Checked By: MBI

Title:
IRRIGATION PLAN
ZONE B

Sheet Number:

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01 IRRIGATION PLAN - ZONE B
SCALE: 1"=10'-0"



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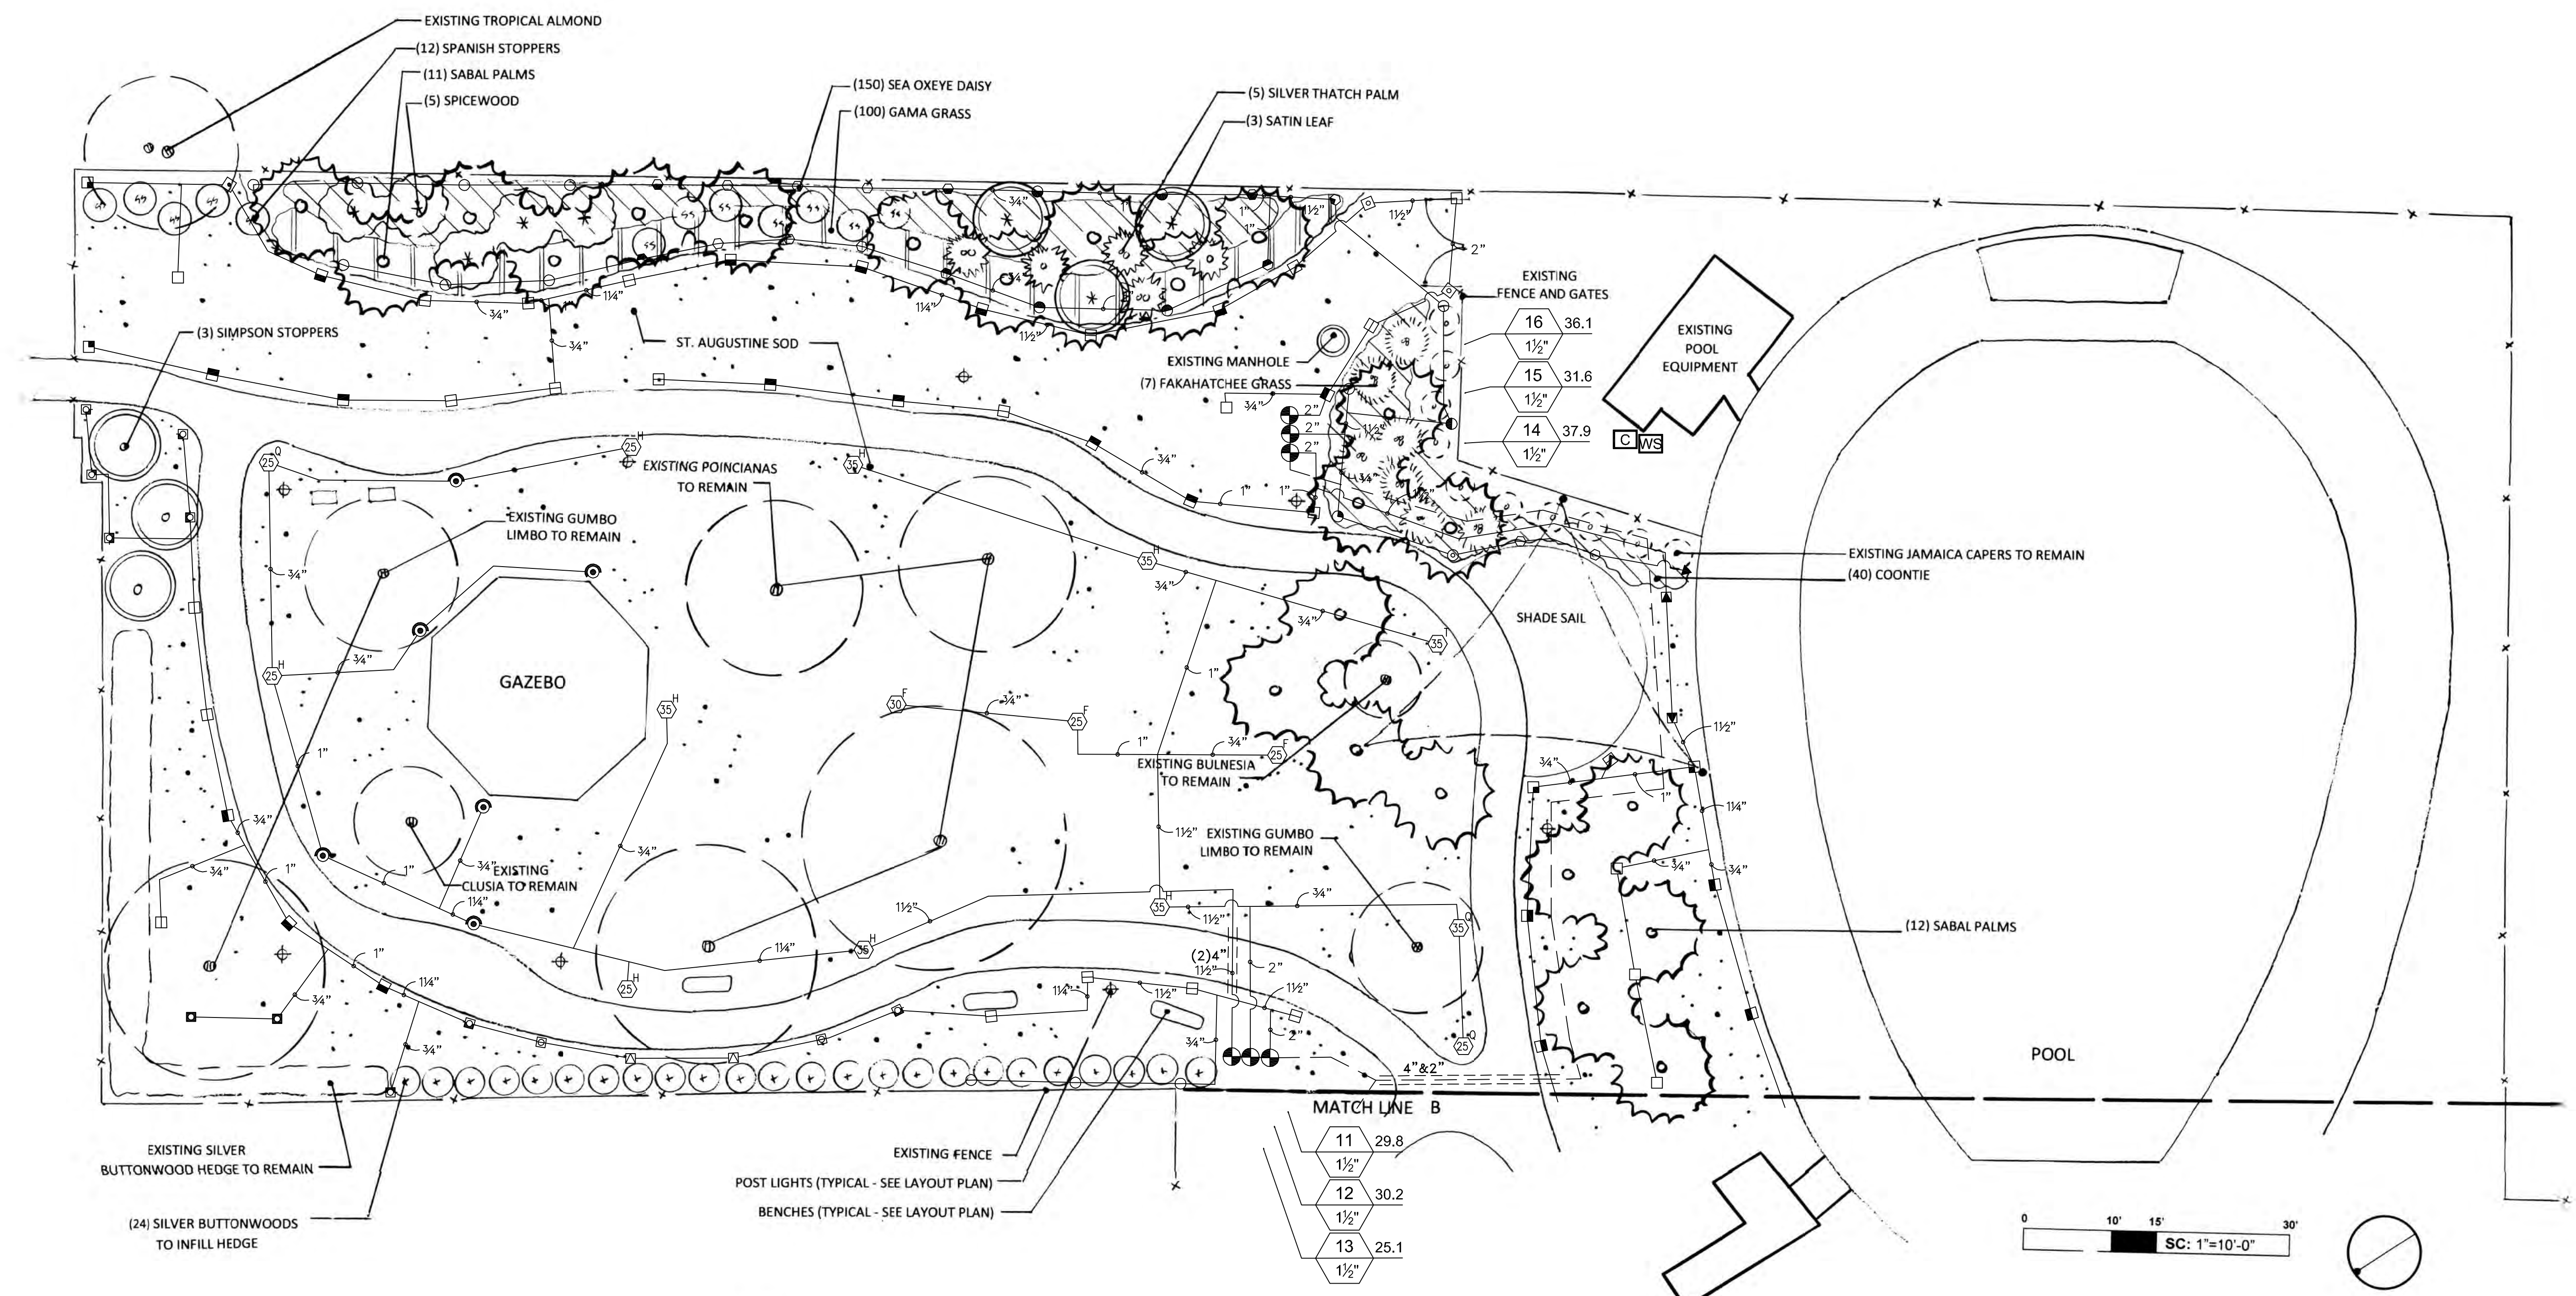
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Drawn By:	Checked By:
ADS	MBI

Title:
IRRIGATION PLAN
ZONE C

Sheet Number:

11.2.3

Date: January 18, 2012
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- NOTES:
1. REPLACE ST. AUGUSTINE SOD AS NEEDED THIS ENTIRE AREA - USE 1" MIN. SILICA SAND AND AERATE EXISTING SOIL
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