

Historic Architectural Review Commission Staff Report for Item 7

To: Chairman Haven Burkee and Historic Architectural Review

Commission Members

From: Enid Torregrosa-Silva, MSHP

Historic Preservation Planner

Meeting Date: September 26, 2023

Applicant: Johnathan Herold, Contractor

Application Number: H2023-0026

Address: 1215 Grinnell Street

Description of Work:

Partial demolition of non-historic demolition of front wall at second floor. Partial demolition of front roofs.

Site Facts:

The house under review is not listed in the historic preservation survey as it was built in 1990. The two-story structure sits at the end of a "U" shape form residential compound, Grinnell Gardens, that was built on a vacant lot. A swimming pool is the focal point of the residential complex. Adjacent buildings are two-story except for a house abutting the north side yard of the house under review. The applicant submitted an approval letter from the HOA. Building permits have been issued for interior renovations.

Ordinance Cited on Review:

• Section 102-217 (2), demolition for non-contributing or non-historic structures of the Land Development Regulations.



Photograph of the house front elevation with proposed demolition marked in red.

Staff Analysis:


The Certificate of Appropriateness proposes the partial demolition of front roofs and second floor front wall. Staff opines the proposed demolition will not have any adverse effect on surrounding buildings.

Since the portions of the structure under review are non-historic, the evaluation shall be based on section 102-217 (b) of the Land Development Regulations, which requires the following criteria for demolitions:

The historic architectural review commission shall not issue permits that would result in:

(1) Removing buildings or structures that are important in defining the overall historic character of a district or neighborhood so that the character is diminished;

It is staff's opinion that the architectural elements under review are not important character defining features to the site or surrounding urban context.

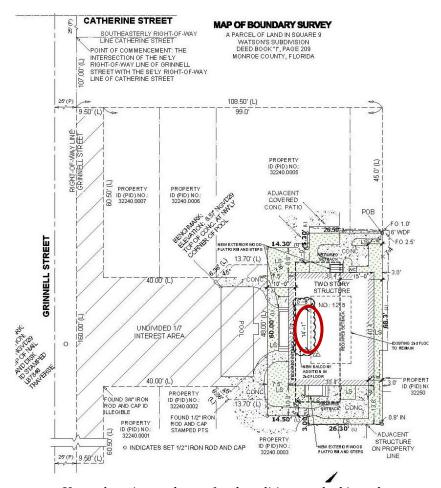

House location and area for demolition marked in red.

(2) Removing historic buildings or structures and thus destroying the historic relationship between buildings or structures and open space;

The proposed structural elements to be demolished are not historic.

(3) Removing an historic building or structure in a complex; or removing a building facade; or removing a significant later addition that is important in defining the historic character of a site or the surrounding district or neighborhood.

The non-historic architectural elements are not significant to the house or the complex.

(4) Removing buildings or structures that would otherwise qualify as contributing, as set forth in section 102-62(3).

It is staff's opinion the portions of building under review will not qualify to be contributing to the district in a near future.

Staff recommends to the Commission the consideration of this request for demolition as proposed for non-historic structural components. The house and the architectural elements are not historic and are not part of a significant residential complex within the historic district. If the Commission finds the design to be appropriate this will be the only required reading for demolition.

APPLICATION

RECEIVED

AUG 1 1 2023

HARC MAJOR PROJECTS CERTIFICATE OF APPROPRIATE NESS \$463.05 NON-REFUNDABLE BASE APPLICATION FEE - OTHER FEES MAY BE APPLICABLE REV 10/02/2

City of Key West

Key West, Florida 33040

HARC COA#	REVISION#	INITIAL & DATE
ARC 2023	-0026	TAK
FLOOD ZONE	ZONING DISTRICT	BLDG PERMIT #

A PRE-APPLICATION MEETING WITH HARC STAFF IS REQUIRED PRIOR TO SUBMITTAL

DDRESS OF PROPOSED PROJE	ECT: 1215 GridNell	
AME ON DEED:	Robert Vaylor	PHONE NUMBER
WNER'S MAILING ADDRESS:	1215 Grinnell	EMAIL 1215griv NCI 12 gmail. Co
PPLICANT NAME:	Johnsthan Hero	PHONE NUMBER OLD (1923 7220
PPLICANT'S ADDRESS:	1659 Long Beach De	EMAIL
PPLICANT'S SIGNATURE:		DATE 8.8.2023
IY PERSON THAT MAKES CHA	NGES TO AN APPROVED CERTIFICATE OF APPRI	ROPRIATENESS MUST SUBMIT A NEW APPLICATION.
DJECT INCLUDES: REPLACEI DJECT INVOLVES A CONTRIBU DJECT INVOLVES A STRUCTUR	MENT OF WINDOWS RELOCATION OF A S TING STRUCTURE: YES NO IN RETHAT IS INDIVIDUALLY LISTED ON THE NATIONAL STRUCTURE IN THE	STRUCTURE ELEVATION OF A STRUCTURE IVOLVES A HISTORIC STRUCTURE: YES NO IONAL REGISTER: YES NO
	RIPTION INCLUDING MATERIALS, HEIGHT, DIME	ENSIONS, SQUARE FOOTAGE, LOCATION, ETC.
ENERAL: Beplace	e Siding, windows	porch.
AIN BUILDING:		
Lemoving Par	AND ATTACH DEMOLITION APPENDIX): +ial front wall of	2 and Story with partial
	tial front wall of	2 ad Story

APPLICATIONS MUST BE SUBMITTED IN PERSON WITH HARD COPIES BY 3PM ON THE SCHEDULED DEADLINE PLEASE SEND AN ELECTRONIC COPY OF ALL DOCUMENTS CITY_HARC@CITYOFKEYWEST-FL.GOV

PAVERS:			FENCES:	
DECKS:			PAINTING:	
SITE (INCLUDING GRADING	G, FILL, TREES, E	TC):	POOLS (INCLUDING EQUIPMENT):	
ACCESSORY EQUIPMENT	(GAS, A/C, VENTS	S, ETC):	OTHER:	
OFFICIAL USE ONLY:		HARC COI	MMISSION REVIEW	EXPIRES ON:
MEETING DATE:	APPROVED .	NOT APPROVED	DEFERRED FOR FUTURE CONSIDERATION	INITIAL:
MEETING DATE:			DEFERRED FOR FUTURE CONSIDERATION	INITIAL:
MEETING DATE:	APPROVED .	NOT APPROVED	DEFERRED FOR FUTURE CONSIDERATION	INITIAL:
REASONS OR CONDITIONS:				
STAFF REVIEW COMMENTS:				
FIRST READING FOR DEMO:			SECOND READING FOR DEMO:	

THIS APPLICATION MAY BE REVIEWED BY PLANNING DEPARTMENT STAFF.

HARC CERTIFICATE OF APPROPRIATENESS: DEMOLITION APPENDIX



HARC COA#	INITIAL & DATE	
H2023-000	26	
ZONING DISTRICT	BLDG PERMIT #	

THE WAY			
ADDRESS OF PROPOSED PROJECT: PROPERTY OWNER'S NAME: APPLICANT NAME:	1215 GriNNI Robert Bai Johnathan	105	
I hereby certify I am the owner of record and the Appropriateness, I realize that this project will refinal inspection is required under this application submitted for review.	quire a Building Permit approva	PRIOR to proceeding with the w	ork outlined above and that a
PROPERTY OWNER'S SIGNATURE	ant 21	Robert Bailor	8/9/2023 DATE AND PRINT NAME
DET	TAILED PROJECT DESCRIPT	ON OF DEMOLITION	
Partial front was trout of house.	11 2nd Story	Partial roof	remova
Before any Certificate of Appropriateness	may be issued for a demolit	ING OR HISTORIC STRUCTURES	ectural Review Commission
must find that the following requirements: (1) If the subject of the application is a contributive or compromised by extreme determined to the compromised by extreme determined to the compromise of the comprom	uting or historic building or str	acture, then it should not be demail	applies): lished unless its condition is
(a) The existing condition of the buil			oration,
(2) Or explain how the building or structure me			
City and is not a significant and	distinguishable building entity	ethod of construction of aesthetic whose components may lack indiv	or historic significance in the vidual distinction.
The state of the s	metal roof.	-1,	reletion
around it.	ly like the	other units	imediatly

(b)	Is not specifically associated with events that have made a significant contribution to local, state, or national history.
(c)	Has no significant character, interest, or value as part of the development, heritage, or cultural characteristics of the city, state or nation, and is not associated with the life of a person significant in the past.
(d)	Is not the site of a historic event with significant effect upon society.
(e)	Does not exemplify the cultural, political, economic, social, or historic heritage of the city.
(f)	Does not portray the environment in an era of history characterized by a distinctive architectural style.
(g)	If a part of or related to a square, park, or other distinctive area, nevertheless should not be developed or preserved according to a plan based on the area's historic, cultural, natural, or architectural motif.
(h)	Does not have a unique location or singular physical characteristic which represents an established and familiar visual
(**/	feature of its neighborhood or of the city, and does not exemplify the best remaining architectural type in a neighborhood

Nothing in i	this application is intended to alter the authority of the Building Official to condemn for demolition dangerous buildings, as provided in Section 102-218 of the Land Development Regulations and Chapter 14 of the Code of Ordinances.
(i)	Has not yielded, and is not likely to yield, information important in history,
	CRITERIA FOR DEMOLITION OF NON-CONTRIBUTING OR NON-HISTORIC STRUCTURES:
comment o	ng criteria will also be reviewed by the Historic Architectural Review Commission for proposed demolitions. The shall not issue a Certificate of Appropriateness that would result in the following conditions (please review and n each criterion that applies):
(1) Removing character	g buildings or structure that are important in defining the overall historic character of a district or neighborhood so that the is diminished.
(2) Removin	g historic buildings or structures and thus destroying the historic relationship between buildings or structures and open space.
(3) Removing important	g an historic building or structure in a complex; or removing a building façade; or removing a significant later addition that is tin defining the historic character of a site or the surrounding district or neighborhood.
(4) Removing	g buildings or structures that would otherwise qualify as contributing.
	1-4


GRINNELL GARDENS HOMEOWNERS' ASSOCIATION 1219 GRINNELL STREET, KEY WEST, FL 33040

27 February 2023


To whom it may concern:

The Grinnell Gardens Homeowners' Association confirms that: in accordance with the restrictions that come with our deeds, the majority of the homeowners have voted to approve the proposed exterior improvements that are visible from the common areas to the single family residence at 1215 Grinnell Street.

Mary H Smith

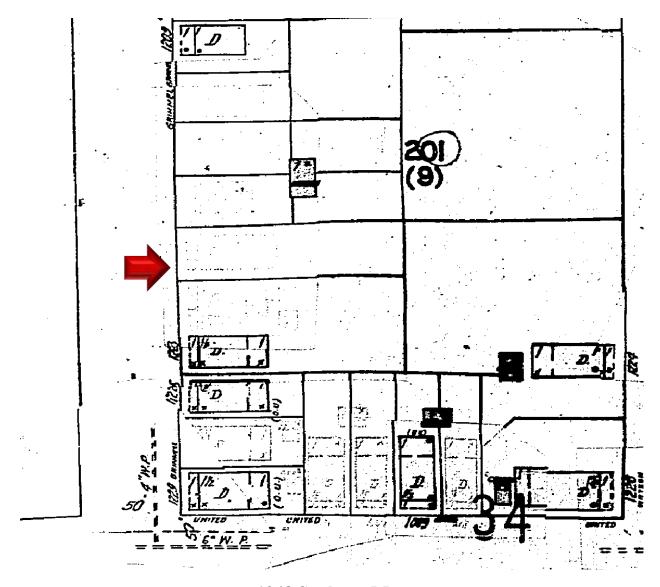


1948 Sanborn Map

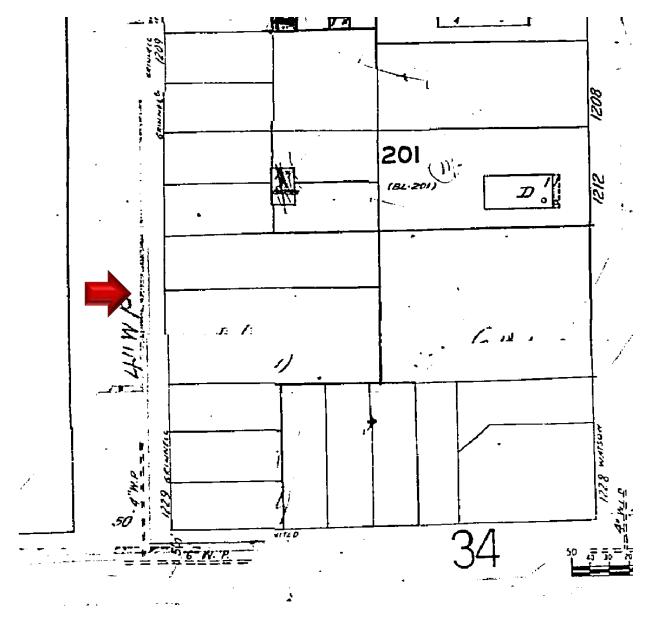

1962 Sanborn Map

PROJECT PHOTOS



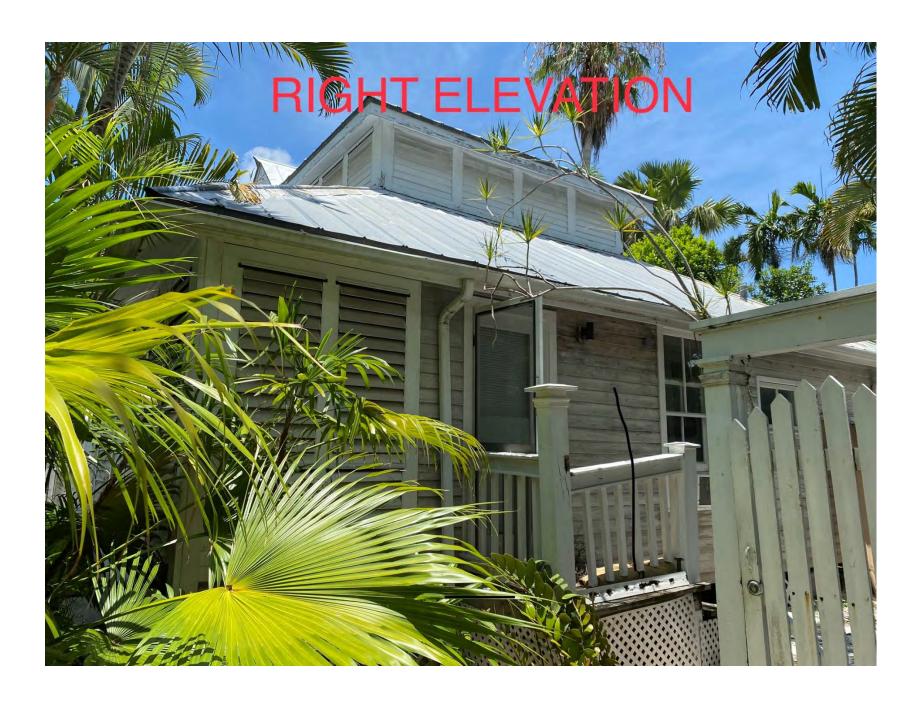







1213 Grinnell Street. The only one-story house in the complex.




Houses in the complex. Houses are facing south.



Houses in the complex. Houses are facing north.

PROPOSED DESIGN

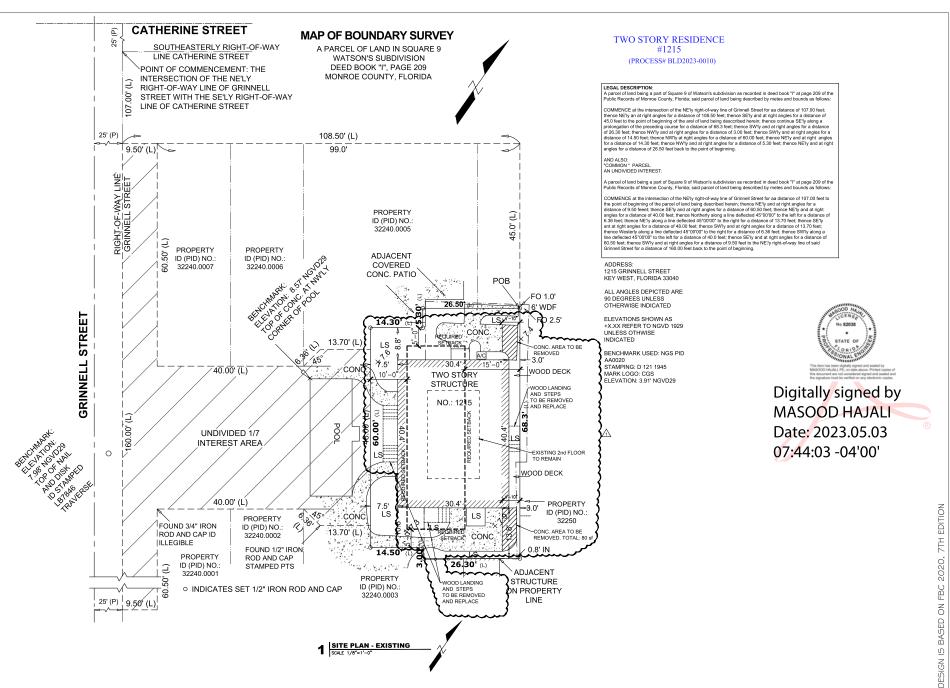

0

Calc Engineering

CALC ENGINEERING
www.calceng.com
2000 NW 89th FL. Unit 102
DORAL, FL 33 172
Phone: (305) 898-9995
ENGINEERING BUSINE55
CA CERTIFICATION: 32566
MASOOD HAJALI P.E
LIC #82038

ADDITION & REMODELING FOR RESIDENT @ 1215 Grundll 5t, Key West, FL 33040



22609

SP-I

TWO STORY RESIDENCE #1215

(PROCESS# BLD2023-0010)

LEGAL DESCRIPTION:

A parcel of land being a part of Square 9 of Watson's subdivision as recorded in deed book "I" at page 209 of the Public Records of Monroe County, Florida; said parcel of land being described by metes and bounds as follows:

COMMENCE at the intersection of the NE'ly right-of-way line of Grinnell Street for an distance of 107.00 feet; thence NE'ly an at right angles for a distance of 108.50 feet; thence SE'ly and at right angles for a distance of 45.0 feet to the point of beginning of the arel of land being described herein; thence continue SE'ly along a prolongation of the preceding course for a distance of 68.3 feet; thence SW'ly and at right angles for a distance of 26.30 feet; thence NW'ly and at right angles for a distance of 14.50 feet; thence NW'ly at right angles for a distance of 60.00 feet; thence NE'ly and at right angles for a distance of 14.30 feet; thence NW'ly and at right angles for a distance of 5.30 feet; thence NE'ly and at right angles for a distance of 26.50 feet back to the point of beginning.

AND ALSO:
"COMMON" PARCEL
AN UNDIVIDED INTEREST:

A parcel of land being a part of Square 9 of Watson's subdivision as recorded in deed book "I" at page 209 of the Public Records of Monroe County, Florida; said parcel of land being described by metes and bounds as follows:

COMMENCE at the intersection of the NE'ly right-of-way line of Grinnell Street for aa distance of 107.00 feet to the point of beginning of the parcel of land being described herein; thence NE'ly and at right angles for a distance of 9.50 feeet; thence SE'ly and at right angles for a distance of 60.50 feet; thence NE'ly and at right angles for a distance of 40.00 feet; thence Northerly along a line deflected 45°00'00" to the left for a distance of 6.36 feet; thence NE'ly along a line deflected 45°00'00" to the right for a distance of 13.70 feet; thence SE'ly ant at right angles for a distance of 48.00 feet; thence SW'ly and at right angles for a distance of 13.70 feet; thence Westerly along a line deflected 45°00'00" to the right for a distance of 6.36 feet; thence SW'ly along a line deflected 45°00'00" to the left for a distance of 40.0 feet; thence SE'ly and at right angles for a distance of 60.50 feet; thence SW'ly and at right angles for a distance of 9.50 feet to the NE'/y right-of-way line of said Grinnell Street for a distance of 160.00 feet back to the point of beginning.

ADDRESS:

1215 GRINNELL STREET KEY WEST, FLORIDA 33040

ALL ANGLES DEPICTED ARE 90 DEGREES UNLESS OTHERWISE INDICATED

ELEVATIONS SHOWN AS +X.XX REFER TO NGVD 1929 UNLESS OTHWISE INDICATED


BENCHMARK USED: NGS PID AA0020 STAMPING: D 121 1945 MARK LOGO: CGS ELEVATION: 3.91' NGVD29



Calc Engineering

CALC ENGINEERING
www.calceng.com
2000 NW 89th PL. Unit 102
DORAL, FL 33172
Phone: (305) 898-9995
ENGINEERING BUSINESS
CA CERTIFICATION: 32566
MASOOD HAJALI P.E
LIC #82038

ADDITION & REMODELING FOR RESIDENT @
1215 Grinnell St,
Key West, Fl 33040

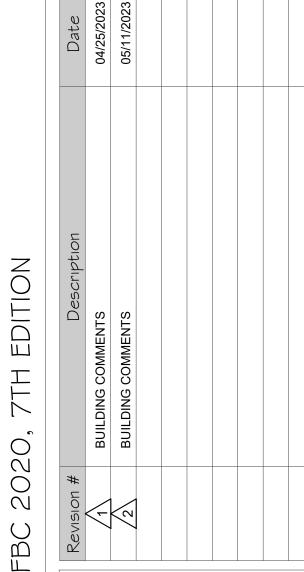


SITE PLAN EXISTING

Date 01/25/2023

Project Number 22609

SP-1

Scale Drawn By
As Shown JLO

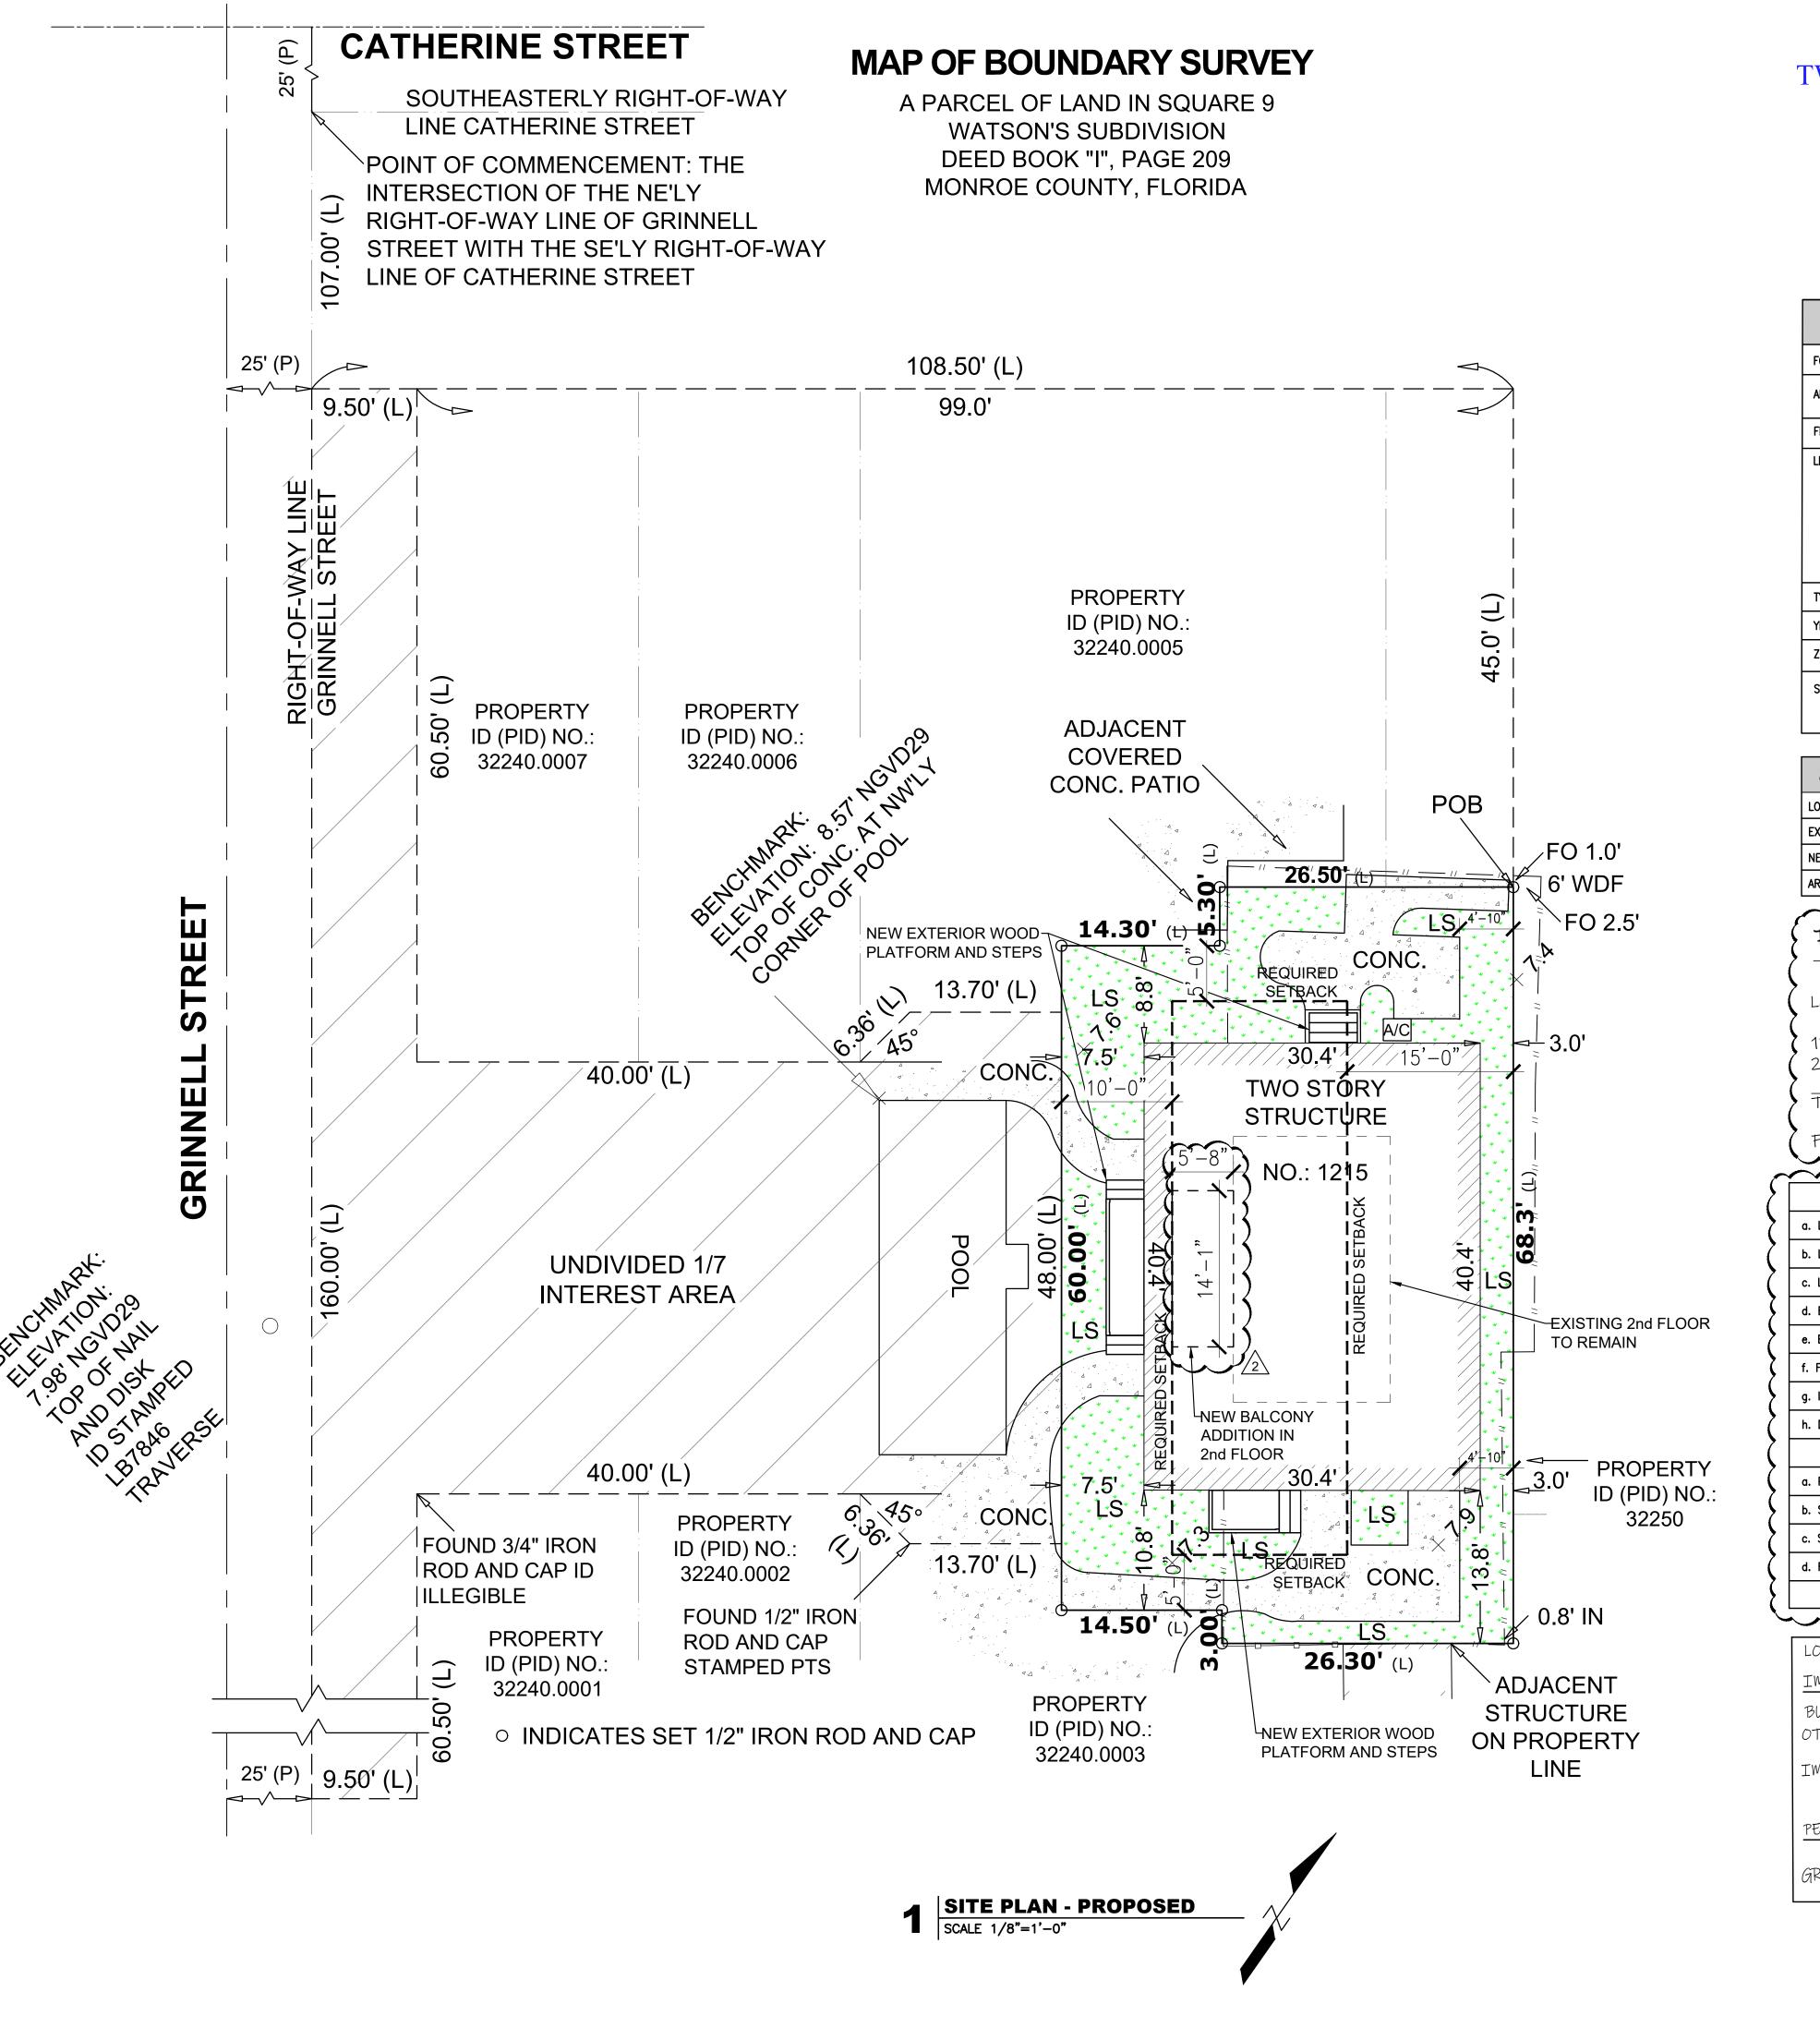

TWO STORY RESIDENCE #1215

(PROCESS# BLD2023-0010)

BUILDIN	IG DATA
FOLIO NUMBER	00032260-000400
ADDRESS	1215 GRINNELL St D, KEY WEST, FL. 33040
FL00RS	2
LEGAL DESCRIPTION	G G WATSON SUB I-209 PT LOTS 6, 8 AND 10 SQR 9 TR 13 (A/K/A PARCEL D GRINNELL GARDENS) OR1119-1645 OR1119-1652 OR1119-1653 OR1195-1827 OR1760-322 OR1760-3250R2357-2172 OR2399-2143 OR2807-2318 OR2839-2459 OR3140-0329
TYPE OF CONSTRUCTION	IV-B
YEAR OF BUILT	1990
ZONING CODE	HMDR (Historic Medium Density Residential)
STRUCTURE	HARDIE BD WALL CONC BLOCK FOUNDATION METAL ROOF

ZONING DATA	Sq.Ft.
LOTE AREA	2,823
EXISTING BUILDING AREA	1,228
NEW BALCONY AREA	79
AREA OF WORK	800

EXISTING	PROPOSED
Lote Area = 2.823 Sq.ft.	Lote Area = 2.823 Sq.ft.
1St Floor = 1,349	1St Floor = 1,228
1St Floor = 1,349 2Nd Floor = 340	2Nd Floor = 340
	Balcony = 79
Total = 1,689 Sq.Ft.	$\frac{\text{Balcony}}{\text{Total}} = \frac{79}{1,647 \text{ Sa.Ft.}}$

LOT OCCUPATION	REQUIRED	EXISTING	PROPOSED
a. LOT AREA	4,000 SQ.FT MIN.	2,823 SQ.FT	2,823 SQ.FT
b. LOT WIDTH	40 FT MIN.	40.80 FT	40.80 FT
c. LOT DEPTH	90 FT MIN.	68.30 FT	68.30 FT
d. BUILDING HEIGHT	30 FT MIN.	23.23 FT	23.23 FT
e. BUILDING COVERAGE	40% MAX	(47.7%) 1,349 SQ.FT	(43.5%) 1,228 SQ.FT
f. FLOOR AREA RATIO (FAR)	1.0	0.598	0.583
g. IMPERVIOUS SURFACE RATIO:	60% MAX 2	(66.7%) 1,883 SQ.FT	(59.6%) 1,683 SQ.FT
h. DENSITY	HMDR (HISTORIC	MEDIUM DENSITY RESIDE	ENTIAL)
BUILDING SETBACK	ζ		
a. PRINCIPAL FRONT	10 FT	7.5 FT	7.5 FT
b. SECONDARY FRONT	N/A	N/A	N/A
c. SIDE	5 FT / 5 FT	10.8 FT / 8.8 FT	10.8 FT / 8.8 FT
d. REAR	15 FT	3.0 FT	3.0 FT

LOT AREA 2,823.0 SQ.FT	NOTE:
LOT AREA 2,823.0 SQ.FT	NOTE:
	NOTE:
IMPERVIOUS	
BUILDING AREA OTHERS (CONCRETE AREA) 1,228.0 SQ.FT 455.0 SQ.FT	THE PROF A SUBSTA EXISTING
IMPERVIOUS TOTAL 59.6% 1,683.0 SQ.FT	
PERVIOUS	
GREEN AREA & WOOD DECK (PERVIOUS) 40.4% 1,140.0 SQ.FT	

NOTE:

THE PROPOSED LAYOUT DOES NOT QUALIFY AS A SUBSTANTIAL IMPROVEMENT HENCE THE EXISTING BUILDING IS TO REMAIN AS IS.

Calc Engineering

CALC ENGINEERING

www.calceng.com

2000 NW 89th PL. Unit 102

DORAL, FL 33172

Phone: (305) 898-9995


ENGINEERING BUSINESS

CA CERTIFICATION: 32566

MASOOD HAJALI P.E

LIC #82038

ADDITION & REMODELING FC RESIDENT @ 1215 Grinnell St, Key West Fl 33040

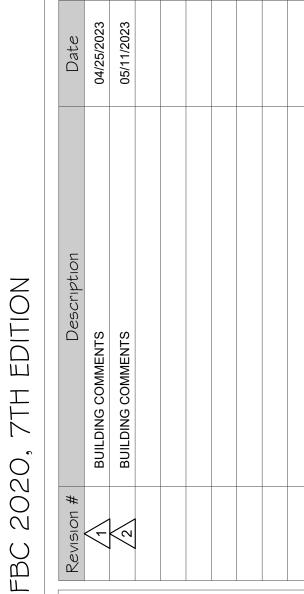

SITE PLAN PROPOSED

Date 01/25/2023

Project Number 22609

SP-2

Scale Drawn By
As Shown JLO

GENERAL NOTES

- 1. CONTRACTOR SHALL VERIFY ALL DIMENSIONS AND CONDITIONS AT JOB SITE BEFORE STARTING WORK. DISCREPANCIES SHALL BE BROUGHT TO THE ATTENTION OF THE ARCHITECT/ENGINEER BEFORE PROCEEDING WITH THE WORK. CORRECTIONS OF THESE CONFLICTS ARE TO BE INCLUDED IN THE WORK AND IN THE PROPOSAL.
- 2. CONTRACTOR SHALL OBTAIN LATEST SET OF DRAWINGS, INCLUDING ANY REVISIONS, BEFORE STARTING CONSTRUCTION.
- 3. NO CHANGES OR SUBSTITUTIONS SHALL BE MADE WITHOUT THE WRITTEN APPROVAL OF THE ARCHITECT.
- 4. DRAWINGS ARE TO BE ISSUED TO THE SUBCONTRACTORS IN COMPLETE SETS SO THAT ALL ARCHITECTURAL DETAILS AFFECTING THEIR WORK ARE INCLUDED.
- 5. ALL DIMENSIONS MUST BE VERIFIED BY THE CONTRACTOR IN THE FIELD. ANY MAJOR DISCREPANCIES MUST BROUGHT TO THE ATTENTION OF THE ARCHITECT.
- 6. WRITTEN DIMENSIONS TAKE PRECEDENCE OVER SCALED DIMENSIONS. DO NOT SCALE DRAWINGS UNLESS AUTHORIZED BY THE ARCHITECT.
- 7. THE ARCHITECT RESERVES THE RIGHT TO REJECT ALL WORK THAT IS DEFECTIVE AND/OR OF POOR WORKMANSHIP OR WORK THAT DEVIATES FROM THE SPECIFICATIONS OF THESE DOCUMENTS.
- 8. THIS OFFICE DOES NOT ACCEPT ANY RESPONSIBILITY FOR THE INTERPRETATION OF THESE PLANS BY OTHERS, UNLESS REQUESTED IN WRITING, AND IT IS GIVEN THE AUTHORITY TO CHECK AND APPROVE SHOP DRAWINGS.
- 9. ALL SECTIONS AND DETAILS SHALL BE CONSIDERED TYPICAL AND APPLY FOR SIMILAR SITUATIONS THROUGHOUT THE PROJECT, UNLESS OTHERWISE SPECIFICALLY NOTED.
- 10. REFER TO FINISH SCHEDULE, AT THE TIME OF BIDDING, FOR SPECIFICATIONS OF FINISHES, MATERIALS, COLOR, TREATMENTS, ETC. ALL OF THE ABOVE SHALL BE SPECIFIED BY THE ARCHITECT IF NOT NOTED THEREIN.

DEMOLITION NOTES

- REMOVE ALL EXISTING CONSTRUCTION AND FINISHES NECESSARY FOR THE COMPLETION OF THE WORK AS DEPICTED ON THE DRAWINGS. INCLUDING BUT NOT LIMITED TO ITEMS SHOWN ON THE PLANS WITH DASHED LINES. NECESSARY DISCONNECTS AND ALTERATIONS TO EXISTING MECHANICAL AND ELECTRICAL SYSTEMS SHALL BE INCLUDED. PATCH AS REQUIRED ALL CONSTRUCTION TO REMAIN IN ACCORDANCE WITH THE CONTRACT DRAWINGS. WHERE CONTRACTOR IS DESIGNATED TO MAKE REMOVALS, DISPOSITION OF MATERIALS IS THE RESPONSIBILITY OF THE CONTRACTOR. VERIFY WITH OWNER, THE DISPOSITION AND REMOVAL OF ANY COMPONENTS OF SALVAGEABLE VALUE
- 2. ALL REMOVALS, UNLESS SPECIFICALLY NOTED OR REQUESTED BY THE OWNER SHALL BECOME THE PROPERTY OF THE CONTRACTOR.
- 3. REMOVE ONLY NON-LOAD BEARING CONSTRICTION AND PARTITIONS. CONTRACTOR TO VERIFY, PRIOR TO REMOVAL, THAT NO STRUCTURAL COMPONENTS, I.E. BEARING WALLS, BEAMS, HEADERS, ETC.. SUPPORTING FLOOR, ROOF OR CEILING JOISTS ARE DESIGNATED FOR REMOVAL. CONTACT THE ARCHITECT PRIOR TO REMOVAL OF ANY CONSTRUCTION IN QUESTION OR DEVIATING FROM THE DESIGN INTENT. CONTRACTOR'S NON CONTACT OF ARCHITECT PRIOR TO REMOVAL OF ANY WORK INDICATES HIS COMPLETE UNDERSTANDING THAT NO LOAD BEARING OR STRUCTURAL WORK IS BEING ALTERED UNDER THIS CONTRACT.
- 4. PATCH ALL FINISHES TO MATCH EXISTING, INCLUDING BUT NOT LIMITED TO, GYPSUM BOARD, PLASTER, ACOUSTIC SYSTEMS, WOOD TRIM, COVERS, BASE, PANELS, RAILS AND WAINSCOT. VERIFY MATCH OF NEW FINISH MATERIALS TO EXISTING IN COLOR, TEXTURE, PROVIDE OTHER MATERIALS TO MATCH EXISTING WHEN REQUIRED. TO BE APPROVED BY OWNER.
- 5. PATCH EXISTING WALLS GYPSUM DRYWALL OR PLASTER TO MATCH EXISTING OF SUFFICIENT THICKNESS TO MAINTAIN UNIFORM WALL THICKNESS.
- 6. WHERE APPLICABLE LEVEL ALL EXISTING FLOORS AS REQUIRED TO RECEIVE NEW FLOOR FINISHES. INSTALL REQUIRED TRANSITION PIECES BETWEEN VARIOUS FLOOR FINISHES SUITABLE FOR CONDITIONS AND ACCEPTABLE TO THE OWNER. MATCH EXISTING WHEREVER POSSIBLE.

GLAZING NOTE

- GLAZING IN FIXED OR OPERABLE PANEL ADJACENT TO OR WITHIN 48" FROM EDGE OF DOOR & WHERE BOTTOM EDGE OF GLAZING IS LESS THAT 60" ABOVE FLOOR SHALL BE SAFETY GLASS CAT I IF LITE IS LESS 9 SQ. FT.
- IF GLAZING IS MORE THAN 9 SQ. FT. GLASS CAT II SHALL BE PROVIDED.

LEVEL NOTE

• MAX. ½" DIFFERENCE ON LEVEL AT ANY FLOOR LEVEL.

CEILING AND SOFFIT HEIGHT NOTE

• NEW CEILING AND SOFFIT HEIGHTS SHALL BE 7'-0" MIN. ABOVE FINISH FLOOR IN COMPLIANCE WITH 701.3 FBCE.

SHOWER NOTE

- BATHTUB AND SHOWER FLOORS AND WALLS ABOVE BATHTUBS WITH INSTALLED SHOWER HEADS AND IN SHOWER COMPARTMENTS SHALL BE FINISHED WITH A NONABSORBENT SURFACE. SUCH WALL SURFACES SHALL EXTEND TO A HEIGHT OF NOT LESS THAN 6 FEET (1829 MM) ABOVE THE FLOOR TO COMPLY WITH FBC 2020 R 307.2.
- FIBER-CEMENT, FIBER-MAT REINFORCED CEMENTITIOUS BACKER UNITS, GLASS MAT GYPSUM BACKERS OR FIBER-REINFORCED GYPSUM BACKERS IN COMPLIANCE WITH ASTM C 1288, C 1325, C 1178 OR C 1278, RESPECTIVELY, AND INSTALLED IN ACCORDANCE WITH MANUFACTURERS' RECOMMENDATIONS SHALL BE USED AS BACKERS FOR WALL TILE IN TUB AND SHOWER AREAS AND WALL PANELS IN SHOWER AREAS TO COMPLY WHIT FBC 2020 R 702.4.2
- PROVIDE TEMPERED SAFETY GLASS CLASS II FOR SHOWER ENCLOSURES
- 22" MIN. CLEARANCE FOR SHOWER ACCESS

FINAL CLEANING

- A. CLEAN SUBSTRATE, FILL CRACKS, HOLES, AND DEPRESSIONS, AND LEVEL FLOOR WITHIN 1/8" IN 10 FEET BEFORE THE LAYING OF THE WOOD FLOORING.
- B. IN AREAS WHERE THE FLOORS WILL BE FINISHED BY OTHERS, THE CONTRACTOR IS TO BROOM CLEAN THE FLOOR ONE DAY BEFORE THE INSTALLATION OF FINISH FLOORING.
- C. GENERAL CONTRACTOR SHALL REMOVE FROM SITE ALL DEBRIS LEFT BY SUBCONTRACTORS PRIOR TO TENANT'S OCCUPANCY.

- A. REMOVE GREASE, MASTIC, ADHESIVE, DUST, DIRT, STAINS, FINGERPRINTS, LABELS, AND OTHER FOREIGN MATERIALS FROM THE SITE, AND FROM ANY OTHER EXPOSED FINISHED INTERIOR OR EXTERIOR SURFACES.
- B. WASH GLASS, AND MIRRORS AS PER MANUFACTURER'S SPECIFIC INSTRUCTIONS.
- C. POLISH GLOSSY SURFACES.
- D. CLEAN PERMANENT FILTERS, AND REPLACE FILTERS IN VENTILATING SYSTEMS, IF UNITS ARE OPERATED DURING CONSTRUCTION. CLEAN DUCTS, BLOWERS, AND COILS, IF UNITS OPERATED WITHOUT FILTERS DURING CONSTRUCTION.
- E. PRIOR TO OWNER OCCUPANCY, CONTRACTOR SHALL INSPECT THE SITE, AND EXPOSED INTERIOR AND EXTERIOR SURFACES, TO VERIFY THAT THE ENTIRE WORK IS CLEAN AND SATISFACTORY TO THE ARCHITECT.

PERMIT AND APPLICABLE RESOLUTIONS

- APPLICANT WILL COMPLY WITH ALL ORDINANCES OF THE PALM BEACH COUNTY AND CITY BUILDING CODE PRIOR TO STARTING CONSTRUCTION.
- IN ADDITION TO THE REQUIREMENTS OF THIS PERMIT, THERE MAY BE ADDITIONAL RESTRICTIONS APPLICABLE TO THIS PROPERTY THAT MAYBE FOUND IN THE PUBLIC RECORDS OF PALM BEACH COUNTY.

FLAME SPREAD NOTE

 FLAME SPREAD FOR WALL CEILING FINISHES MAX. 200. SOME DEVELOPED MAX. TO COMPLY WITH 450 FBC 2020 R 302.9 AND FLAME SPREAD FOR INSULATION MAX. 25, SMOKE DEVELOPED MAX. 450 TO COMPLY FBC 2020 R 302.10

CODE REFERENCES

FLORIDA BUILDING CODE 2020 7TH EDITION (EXISTING) FLORIDA FIRE PREVENTION CODE 2018 NATIONAL ELECTRIC CODE 2017

BUILDING DATA					
FOLIO NUMBER	00032260-000400				
ADDRESS	1215 GRINNELL St D, KEY WEST, FL. 33040				
FLOORS	2				
LEGAL DESCRIPTION	G G WATSON SUB I-209 PT LOTS 6, 8 AND 10 SQR 9 TR 13 (A/K/A PARCEL D GRINNELL GARDENS) OR1119-1645 OR1119-1652 OR1119-1653 OR1195-1827 OR1760-322 OR1760-3250R2357-2172 OR2399-2143 OR2807-2318 OR2839-2459 OR3140-0329				
TYPE OF CONSTRUCTION	IV-B				
YEAR OF BUILT	1990				
ZONING CODE	HMDR (Historic Medium Density Residential)				
STRUCTURE	HARDIE BD WALL CONC BLOCK FOUNDATION METAL ROOF				

ZONING DATA	Sq.Ft.
LOTE AREA	2,823
EXISTING BUILDING AREA	1,228
NEW BALCONY AREA	79
AREA OF WORK	800


ALTERATION LEVEL LEVEL OF ALTERATION II

SCOPE OF WORK

- EXISTING ELECTRIC METER TO REMAIN NEW ELECTRIC PANEL A
- NEW PLUMBING FIXTURES AS PER LAYOUT
- NEW FLOORING & SOUNDPROOFING NEW LIGHTING & POWER AS PER LAYOUT
- NEW DOORS AND WINDOWS (SEE DOOR SCHEDULE)
- NEW PARTITION WALL AS PER LAYOUT EXISTING AIR CONDITIONING SYSTEM #1, 2 TO REMAIN
- NEW AIR CONDITIONING SYSTEM #3, 4 AS PER LAYOUT.
- NEW TANKLESS WATER HEATER

•	NEW	WOOD	ADDITION	BALCONY	
•	NEW	WOOD	ROOF IN	BALCONY	AREA


	SHEET INDEX	01-25-2023 PERMIT SET	04-25-2023 BUILDING COMM	05-11-2023 BUILDING COMM	06-14-2023 OWNER MODIFIC.	
	ARCHITECTURAL		0	\ <u>2</u> \	3 0	
A-1	ARCHITECTURAL NOTES	•	•	•	•	
A-2	DEMOLITION FLOOR PLAN	•		•	•	
A-3	PROPOSED FLOOR PLAN	•		•	•	
A-4	ROOF PLAN - EXISTING - PROPOSED	•		•		
A-5	ELEVATIONS - PROPOSED	•				
A-6	SECTIONS & DETAILS	•			•	
A-7	DETAILS	•			•	
SP-1	SITE PLAN — EXISTING	•	•	•		
SP-2	SITE PLAN — PROPOSED		•	•		
	ELECTRICAL					
E-1	ELECTRICAL GENERAL NOTES	•		•		
E-2	ELECTRICAL FLOOR PLAN	•		•	•	
	MECHANICAL					
M-1	MECHANICAL GENERAL NOTES	•				
M-2	MECHANICAL FLOOR PLAN	•			•	
	PLUMBING					
P-1	PLUMBING GENERAL NOTES & DETAILS	•				
P-2	PLUMBING SANITARY & DOMESTIC WATER FLOOR PLAN	•			•	
	STRUCTURAL					
S-1	STRUCTURAL GENERAL NOTES & DETAILS	•			•	
S-2	STRUCTURAL 1ST & 2ND FLOOR PLAN	•			•	
S-3	STRUCTURAL ROOF PLAN AND SECTION	•			$ \bullet $	

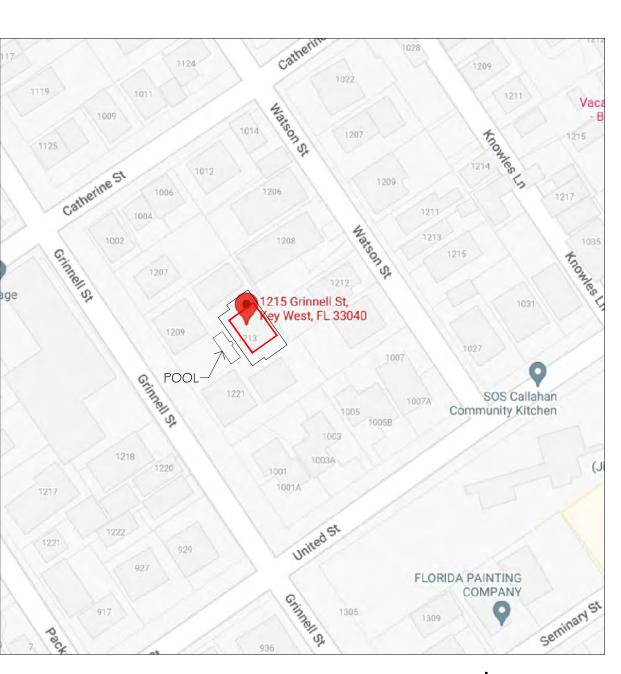

N.T.S.

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ODELING REM(SIDE) Grinist, Fl \triangleleft

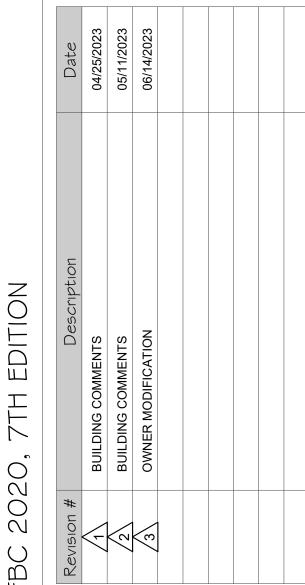

ARCHITECTURAL NOTES

01/25/2023

Project Number 22609

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Sheet DESIGN A- I Drawn By

As Shown

JLO

EXISTING CONCRETE BLOCK WALL TO REMAIN


EXISTING EXTERIOR WOOD WALL TO REMAIN

EXISTING DRYWALL PARTITION WALL TO REMAIN


EXISTING TO BE REMOVED

DEMOLITION KEY NOTES

- 1. EXISTING PLUMBING FIXTURE TO BE REMOVED AND CAP OFF
- 2. EXISTING KITCHEN CABINETS AND APPLIANCES TO BE REMOVED AND DISPOSE FOR A DEMO SET
- 3. EXISTING PARTITION WALL TO BE DEMOLISHED AND DISPOSE FOR A DEMO SET
- 4. EXISTING DOOR TO BE REMOVED AND DISPOSE FOR A DEMO SET
- 5. EXISTING WINDOWS TO BE REMOVED AND DISPOSE FOR A DEMO SET
- 6. EXISTING WALL MOUNTED A/C TO BE REMOVED
- 7. EXISTING ELECTRIC PANEL TO BE REMOVED
- 8. EXISTING FLOORING TO BE REMOVED AND DISPOSE FOR A DEMO SET
- 9. EXISTING SPIRAL STAIRCASE TO BE REMOVED AND DISPOSE FOR A DEMO SET
- 10. EXISTING WATER HEATER TO BE REMOVED AND DISPOSE FOR A DEMO SET
- 11. EXISTING EXTERIOR DECK TO BE REMOVED AND DISPOSE FOR A DEMO SET
- 12. CUT FRAMING WALL TO CREATE NEW OPENING

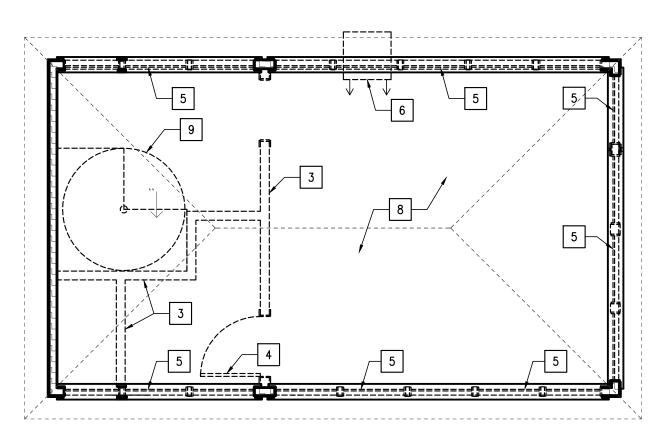

2 | DEMOLITION 2nd FLOOR PLAN | SCALE 1/4"=1'-0"

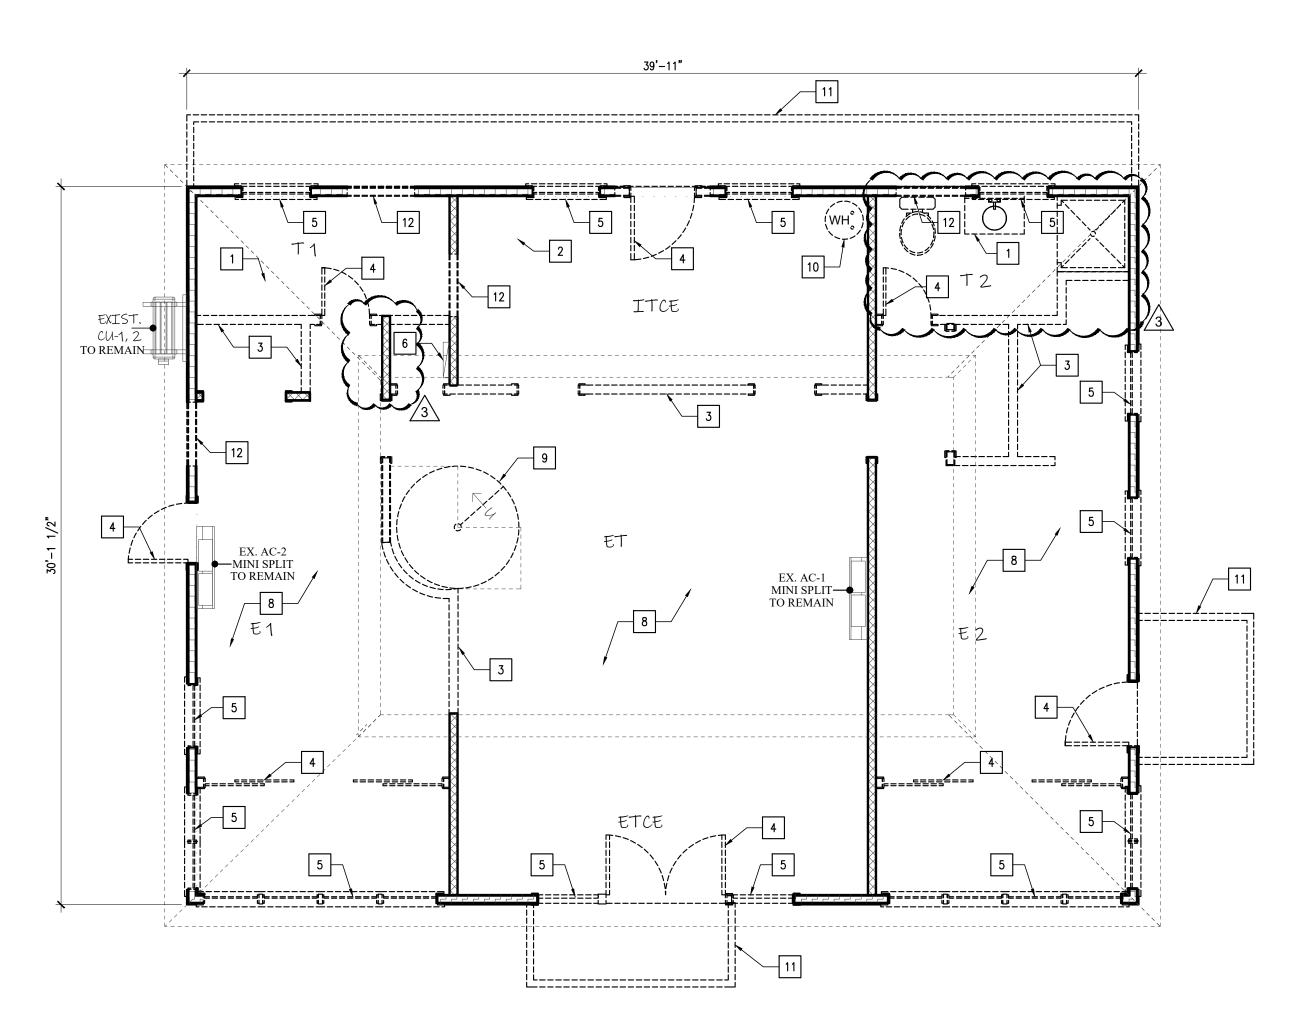

1 DEMOLITION 1st FLOOR PLAN
SCALE 1/4"=1'-0"



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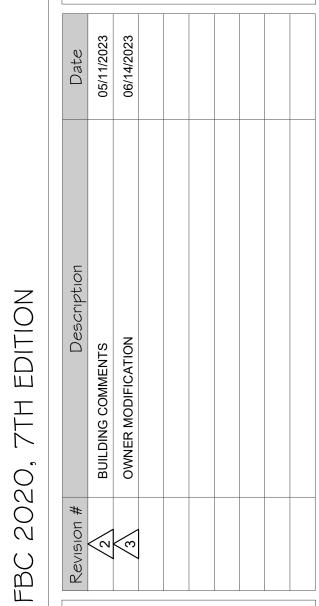
ENGINEERING BUSINESS

CA CERTIFICATION: 32566

MASOOD HAJALI P.E

LIC #82038

ADDITION & REMODELING FOR RESIDENT @ 1215 Grinnell St, Key West, FL 33040



DEMOLITION FLOOR PLAN


Date 01/25/2023
Project Number 22609

Sheet

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A-2

Scale Drawn By
As Shown JLO

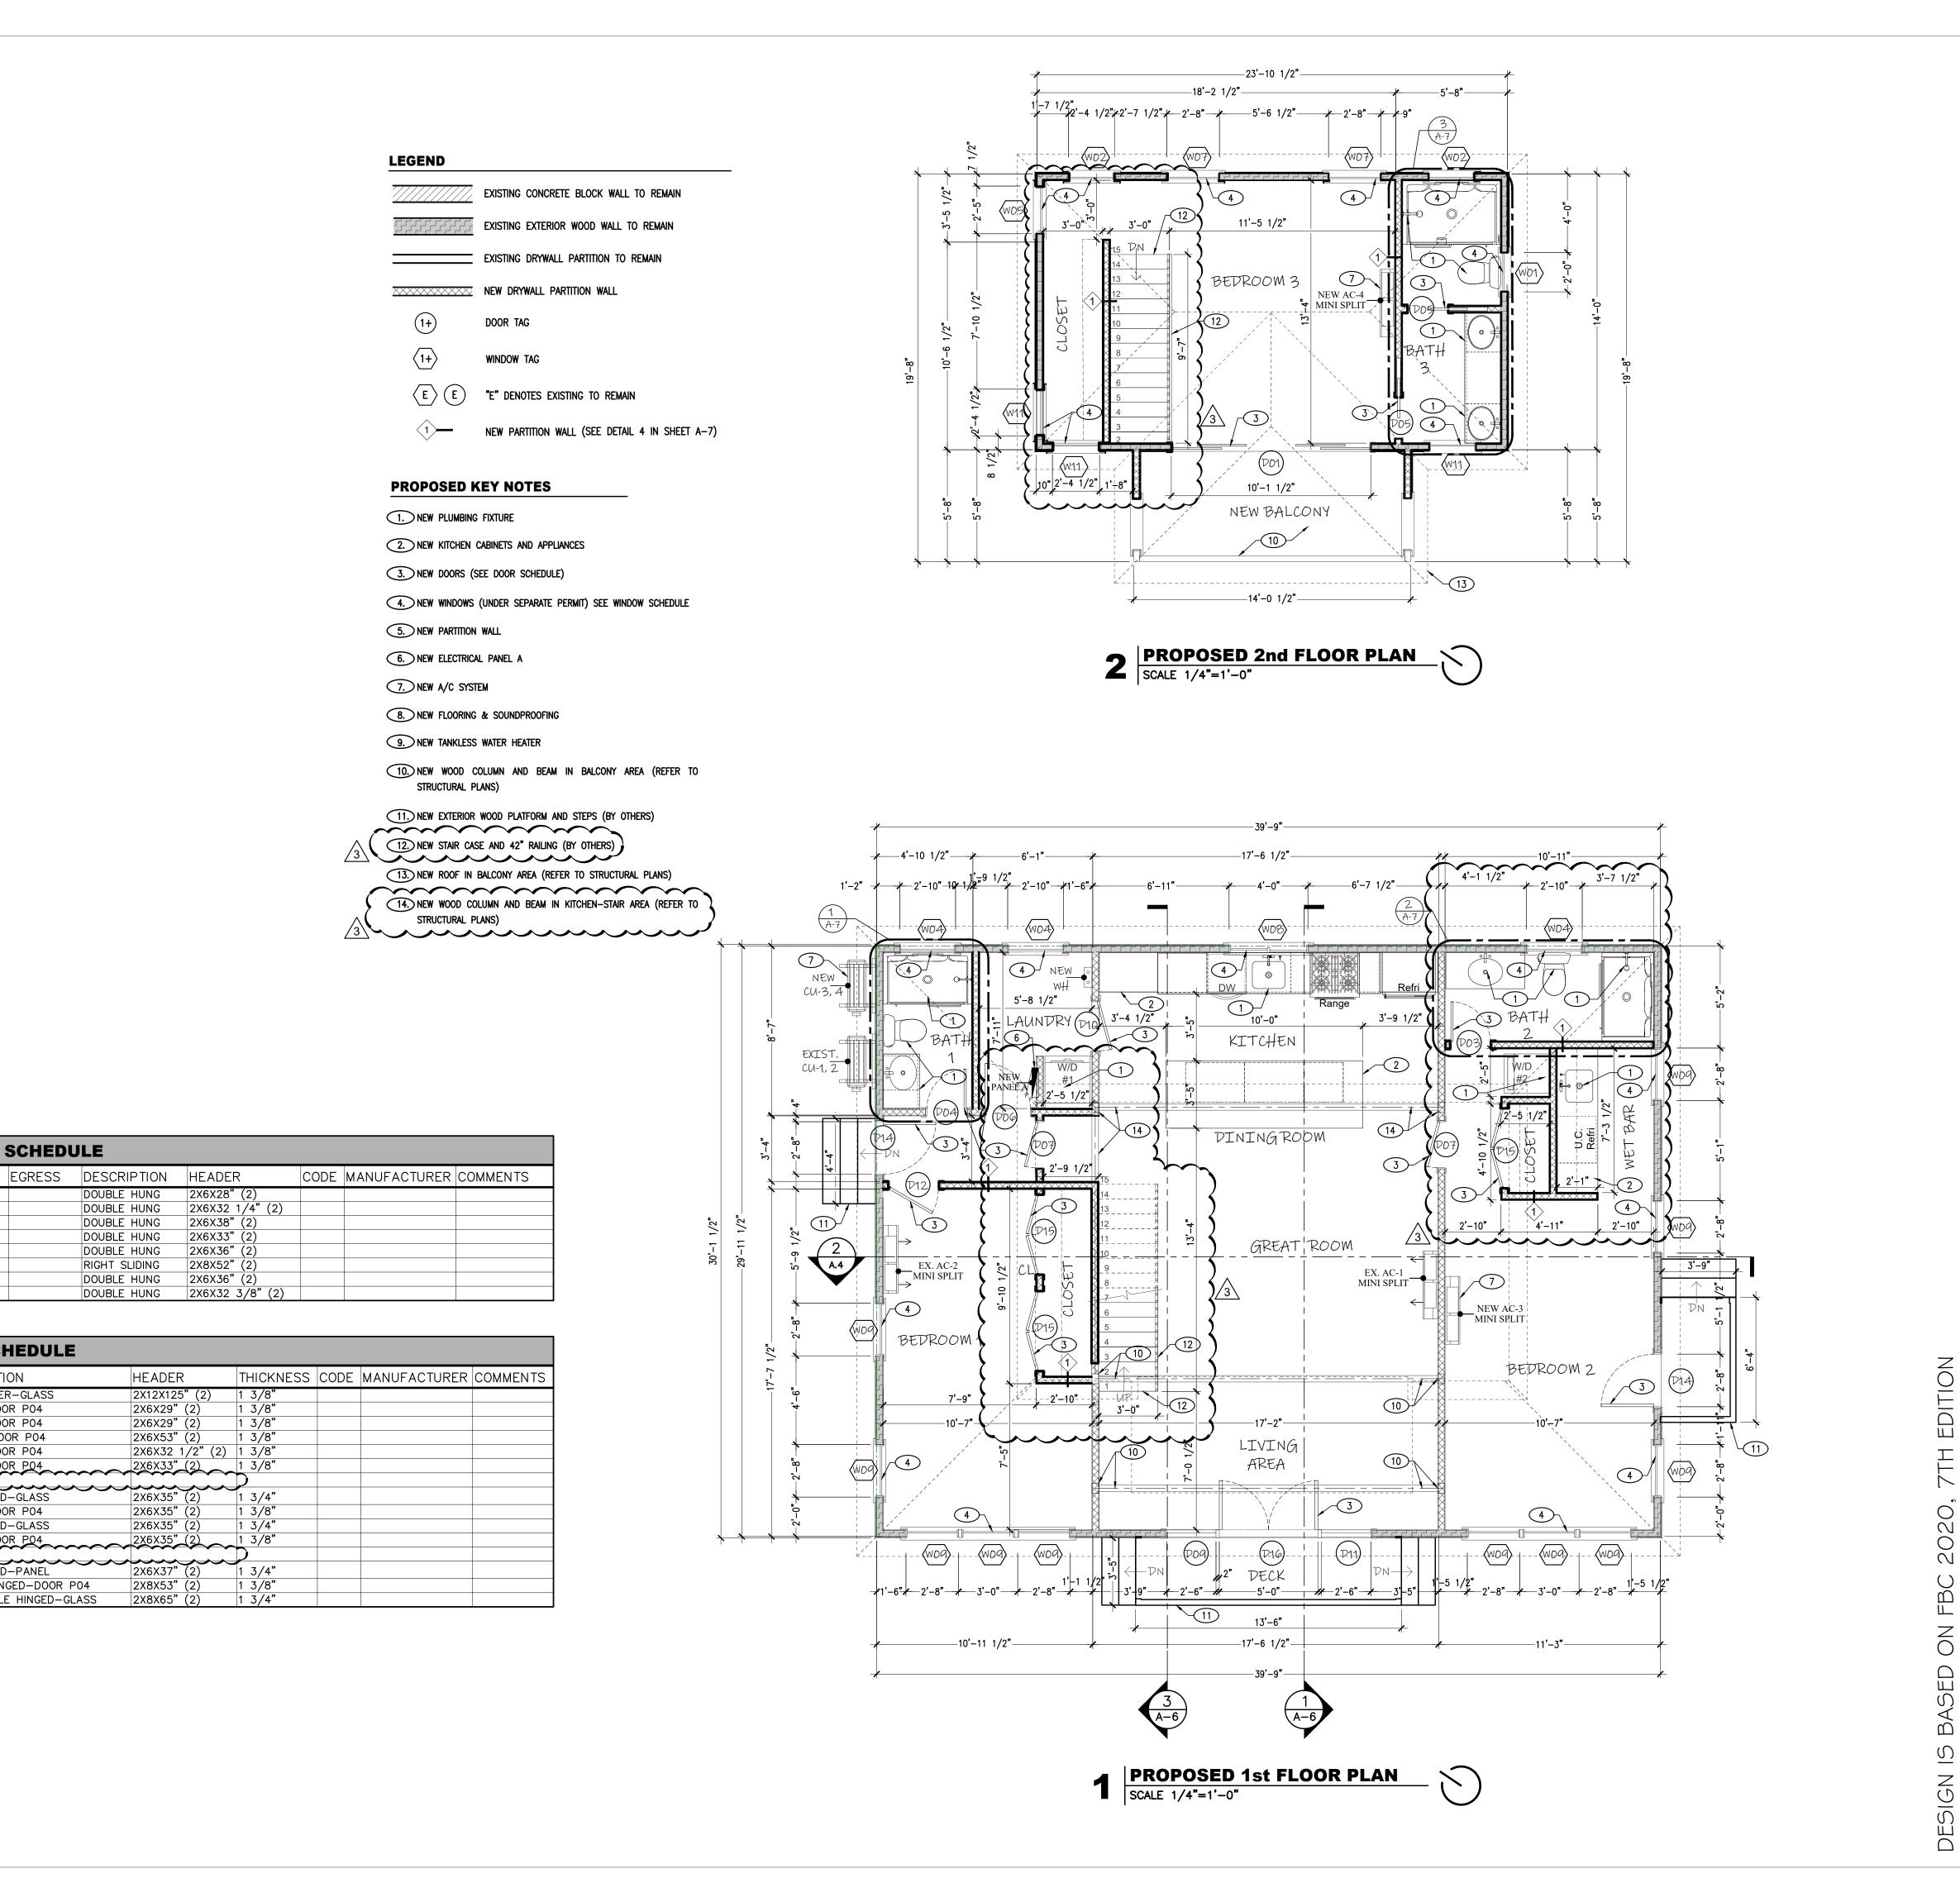

W_ WINDOW SCHEDULE

DOOR SCHEDULE

QUAD SLIDER-GLASS

HINGED-DOOR P04

HINGED-DOOR P04

POCKET-DOOR PO4

EXT. HINGED-GLASS

HINGED-DOOR PO4

EXT. HINGED-GLASS

EXT. HINGED-PANEL

DOUBLE HINGED-DOOR PO4

EXT. DOUBLE HINGED-GLASS

DESCRIPTION

QTY FLOOR SIZE

11 1

2068 R IN

2668 R EX

2427DH

21021DH

2527DH

2827DH

4021RS

28510DH

2427DH

30"

NUMBER LABEL

W02

W04

2030AW TMPRI

NUMBER LABEL QTY |FLOOR |SIZE

2427DH

21021DH

2527DH

2827DH

4021RS

28510DH

2427DH

2068

2068

2068

WIDTH

WIDTH HEIGHT R/O

HEIGHT R/O

122"X82 1/2

26"X82 1/2

26"X82 1/2"

50"X82 1/2"

32"X82 1/2"

50"X82 1/2"

32"X83"

62"X83"

29 1/4"X32"

35"X26"

30"X32"

33"X32"

49"X26"

33"X71"

29 1/2"X82 1/2" HINGED-DOOR P04


29 3/8"X32"

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REMODELING

ADDI



FLOOR PLAN

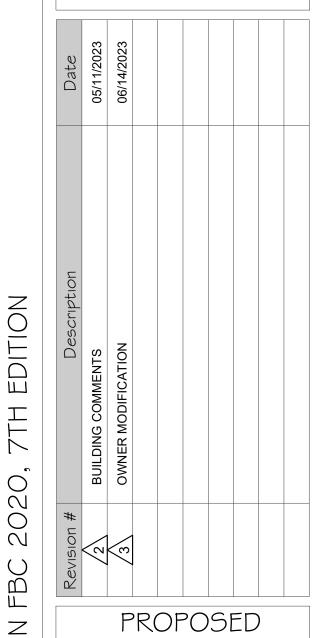22609

A-3


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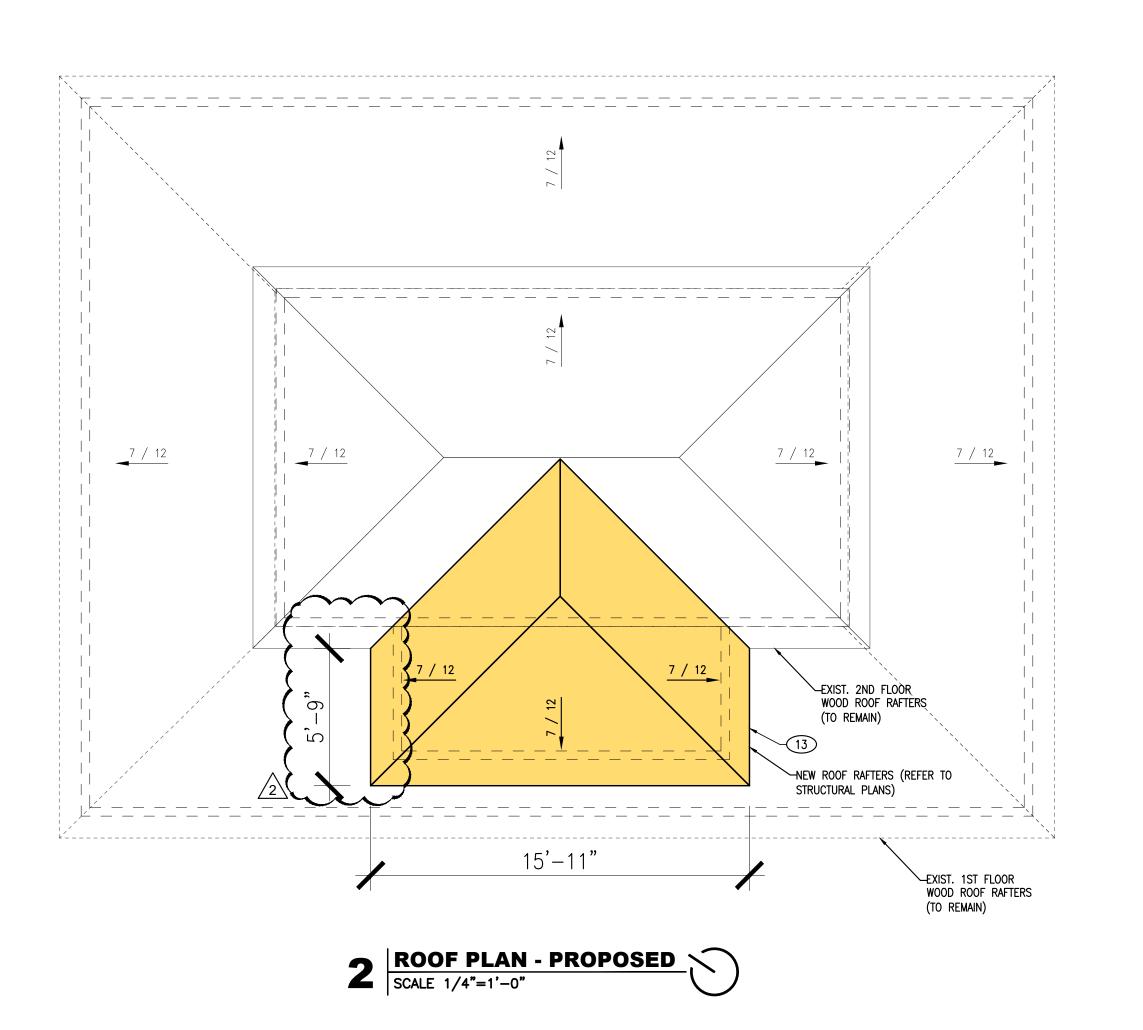
JLO

Project Number

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01/25/2023





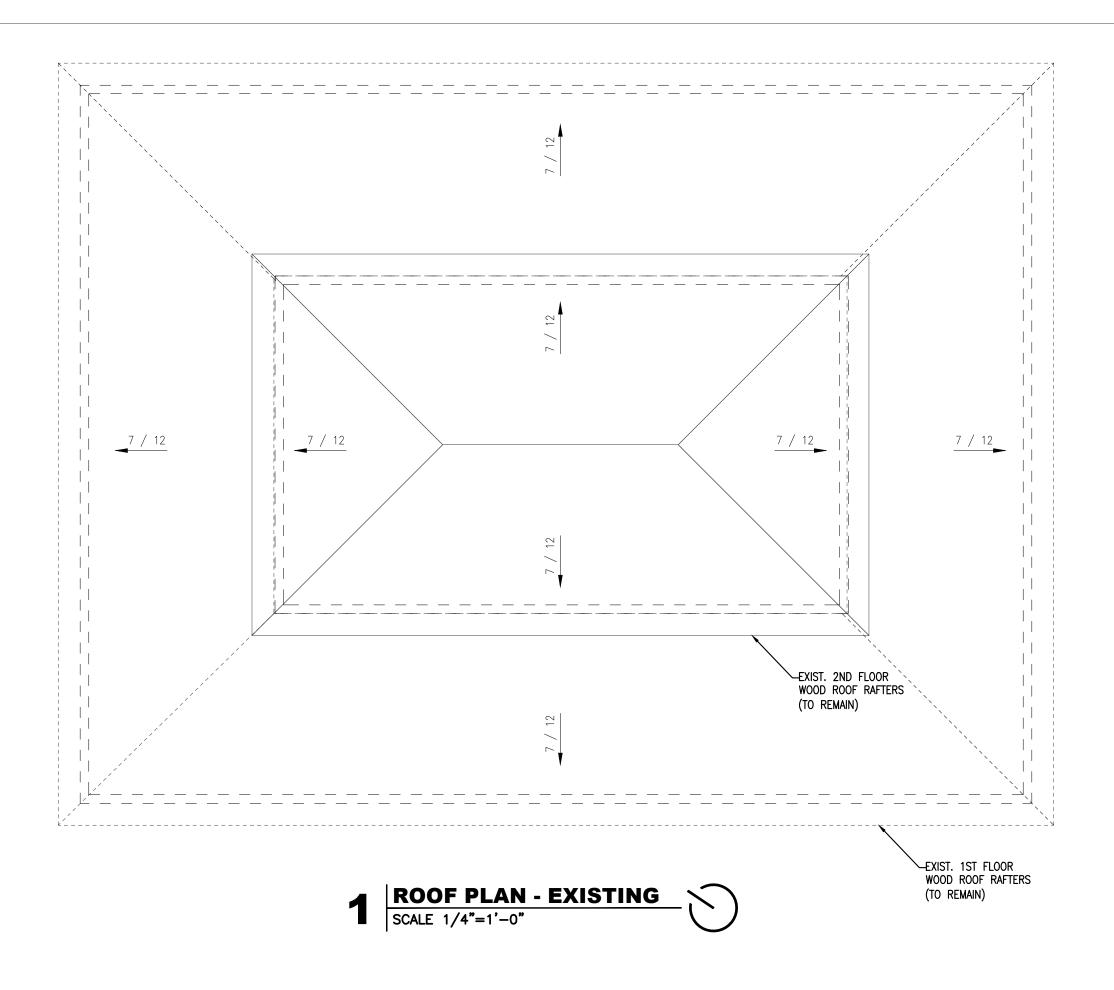

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MASOOD HAJALI P.E
LIC #82038

REMODELING F ESIDENT @ 5 Grinnell St, est, FL 33040 ADDITION

	l									
		Date	05/11/2023							
		Description	BUILDING COMMENTS							
		Revision #	$\sqrt{2}$							
ROOF PLA					N	S S	=n			
	EXISTING - PROPOSED					ーレ				


01/25/2023

22609

A-4

Drawn By

DESIGN IS BASED Date Project Number

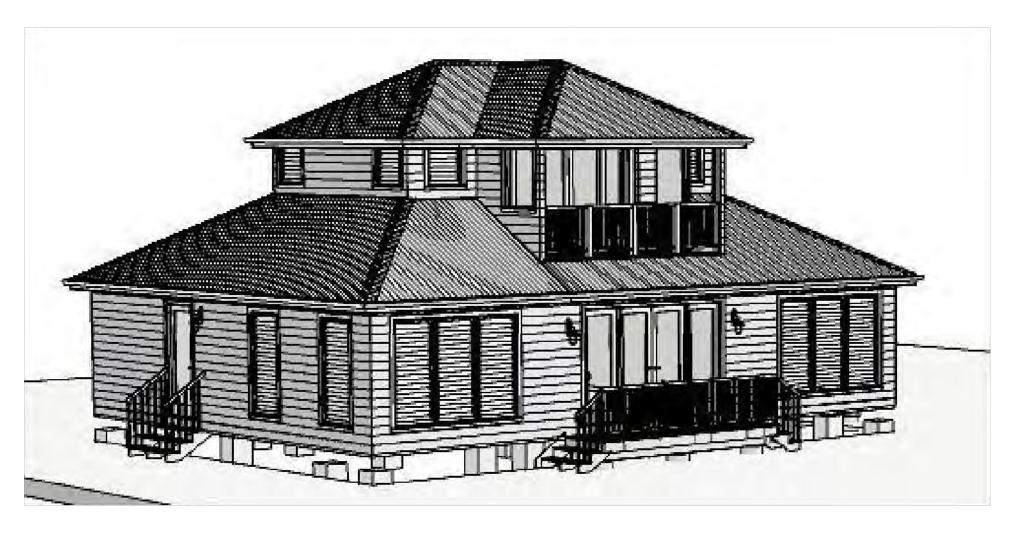


5 | ISOMETRIC VIEW (FRONT)
| SCALE NTS

EXISTING ROOF


EXISTING WALL NEW WINDOWS NEW DOOR

EXISTING WALL
NEW WINDOWS


EXISTING ROOF

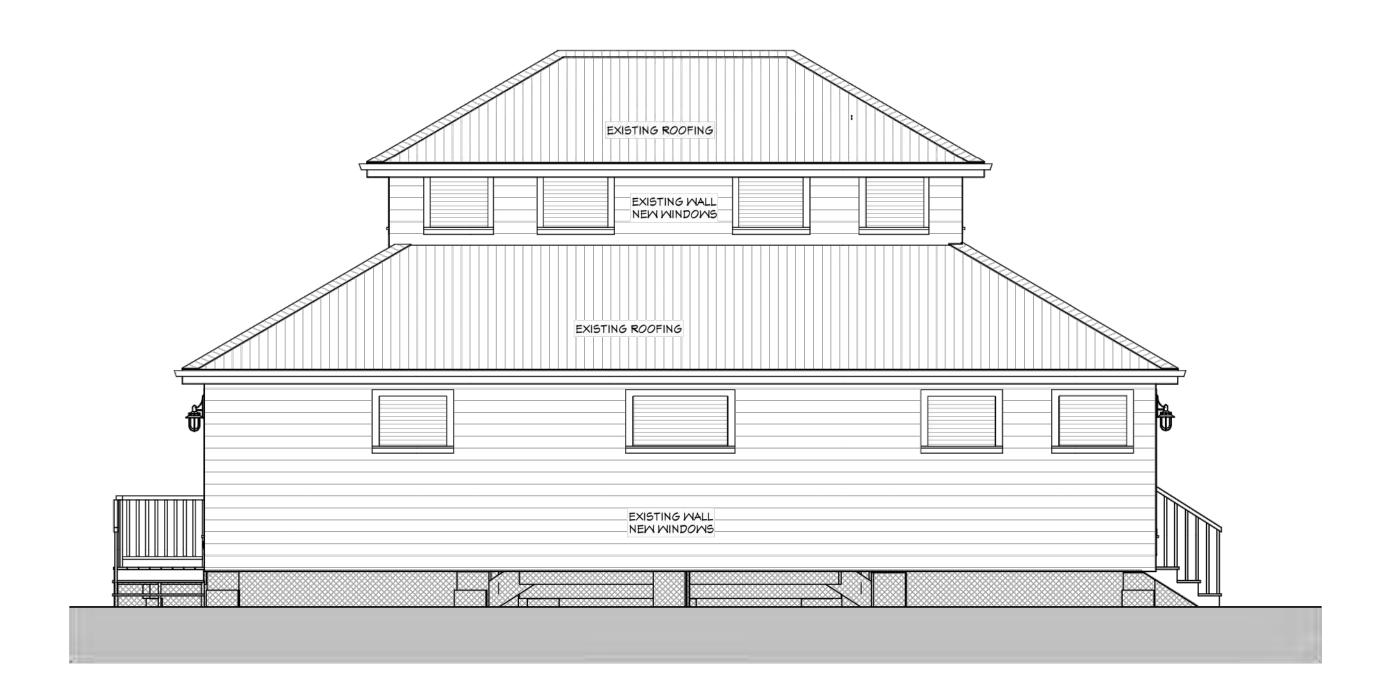


1 REAR ELEVATION
SCALE 1/4"=1'-0"

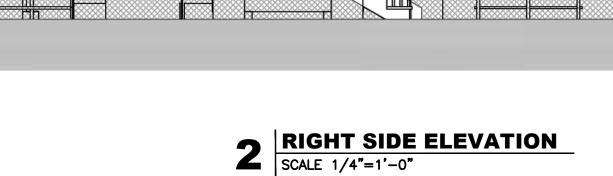

PROPOSED ROOF EXTENSION

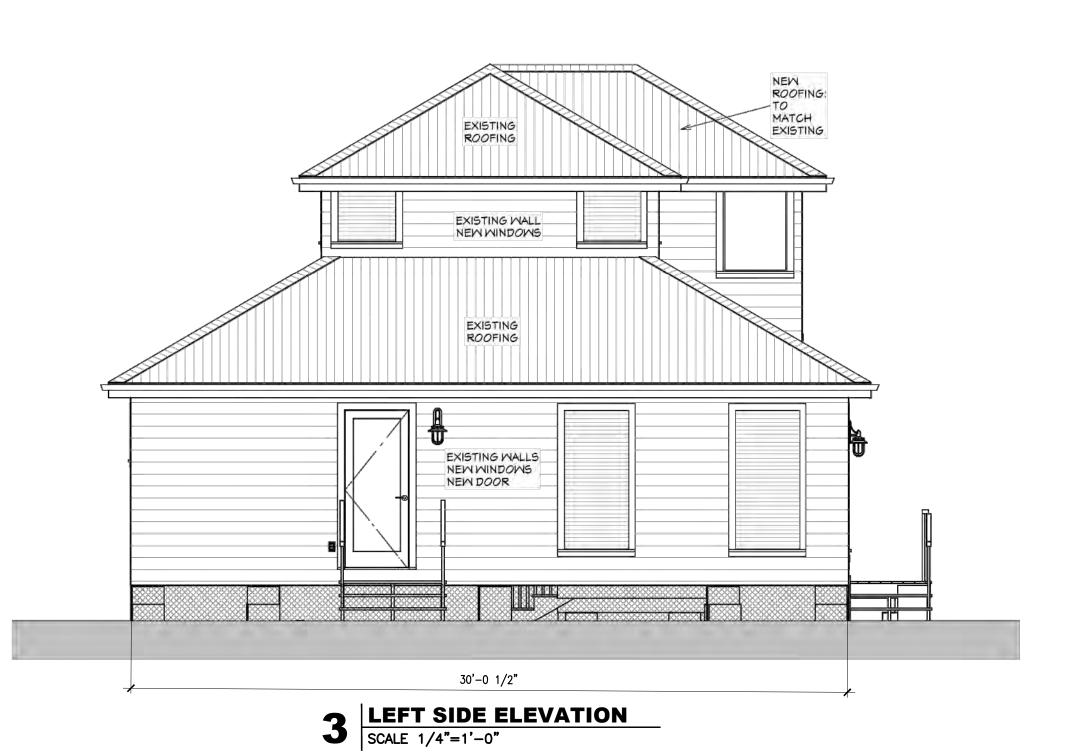

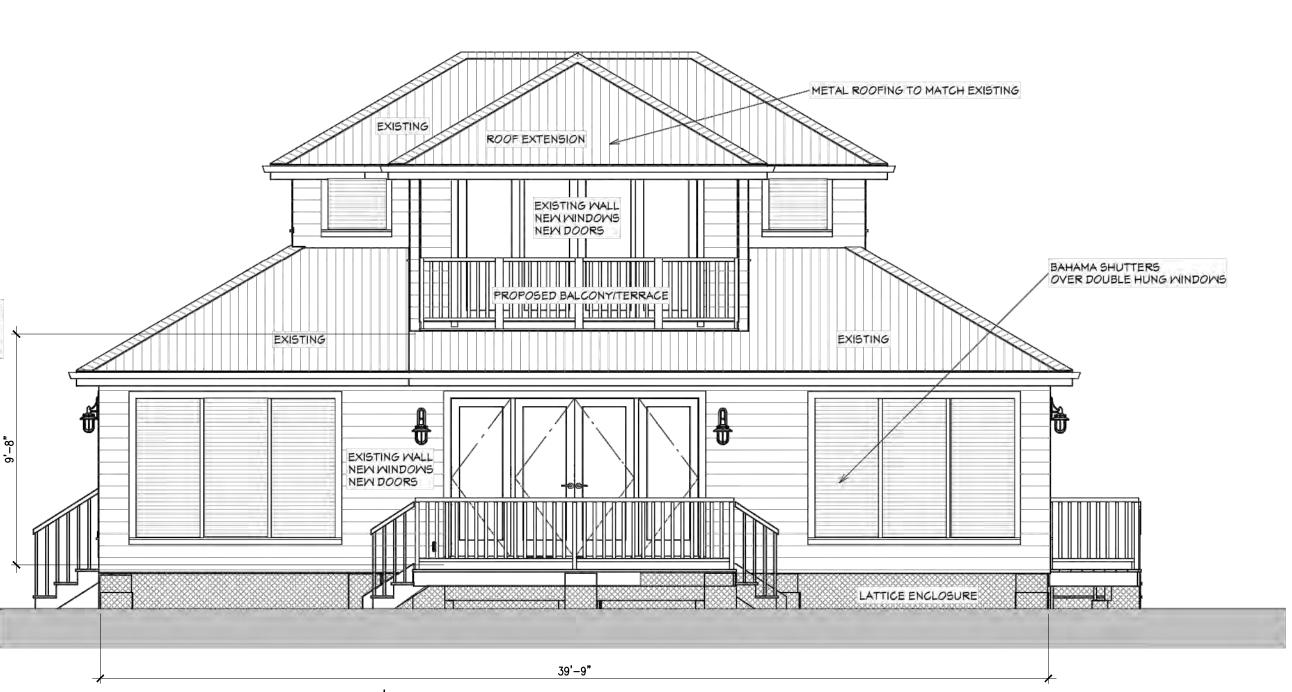

4 | FRONT ELEVATION (POOL ELEVATION) | SCALE 1/4"=1'-0"

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> ESIDENT @ 5 Grinnell St, est, FL 33040 ADDITION


Date	
Revision # Description	
Revision #	
_	


ELEVATIONS PROPOSED DESIGN IS BASED


01/25/2023 Project Number 22609


Sheet A-5

Drawn By JLO As Shown

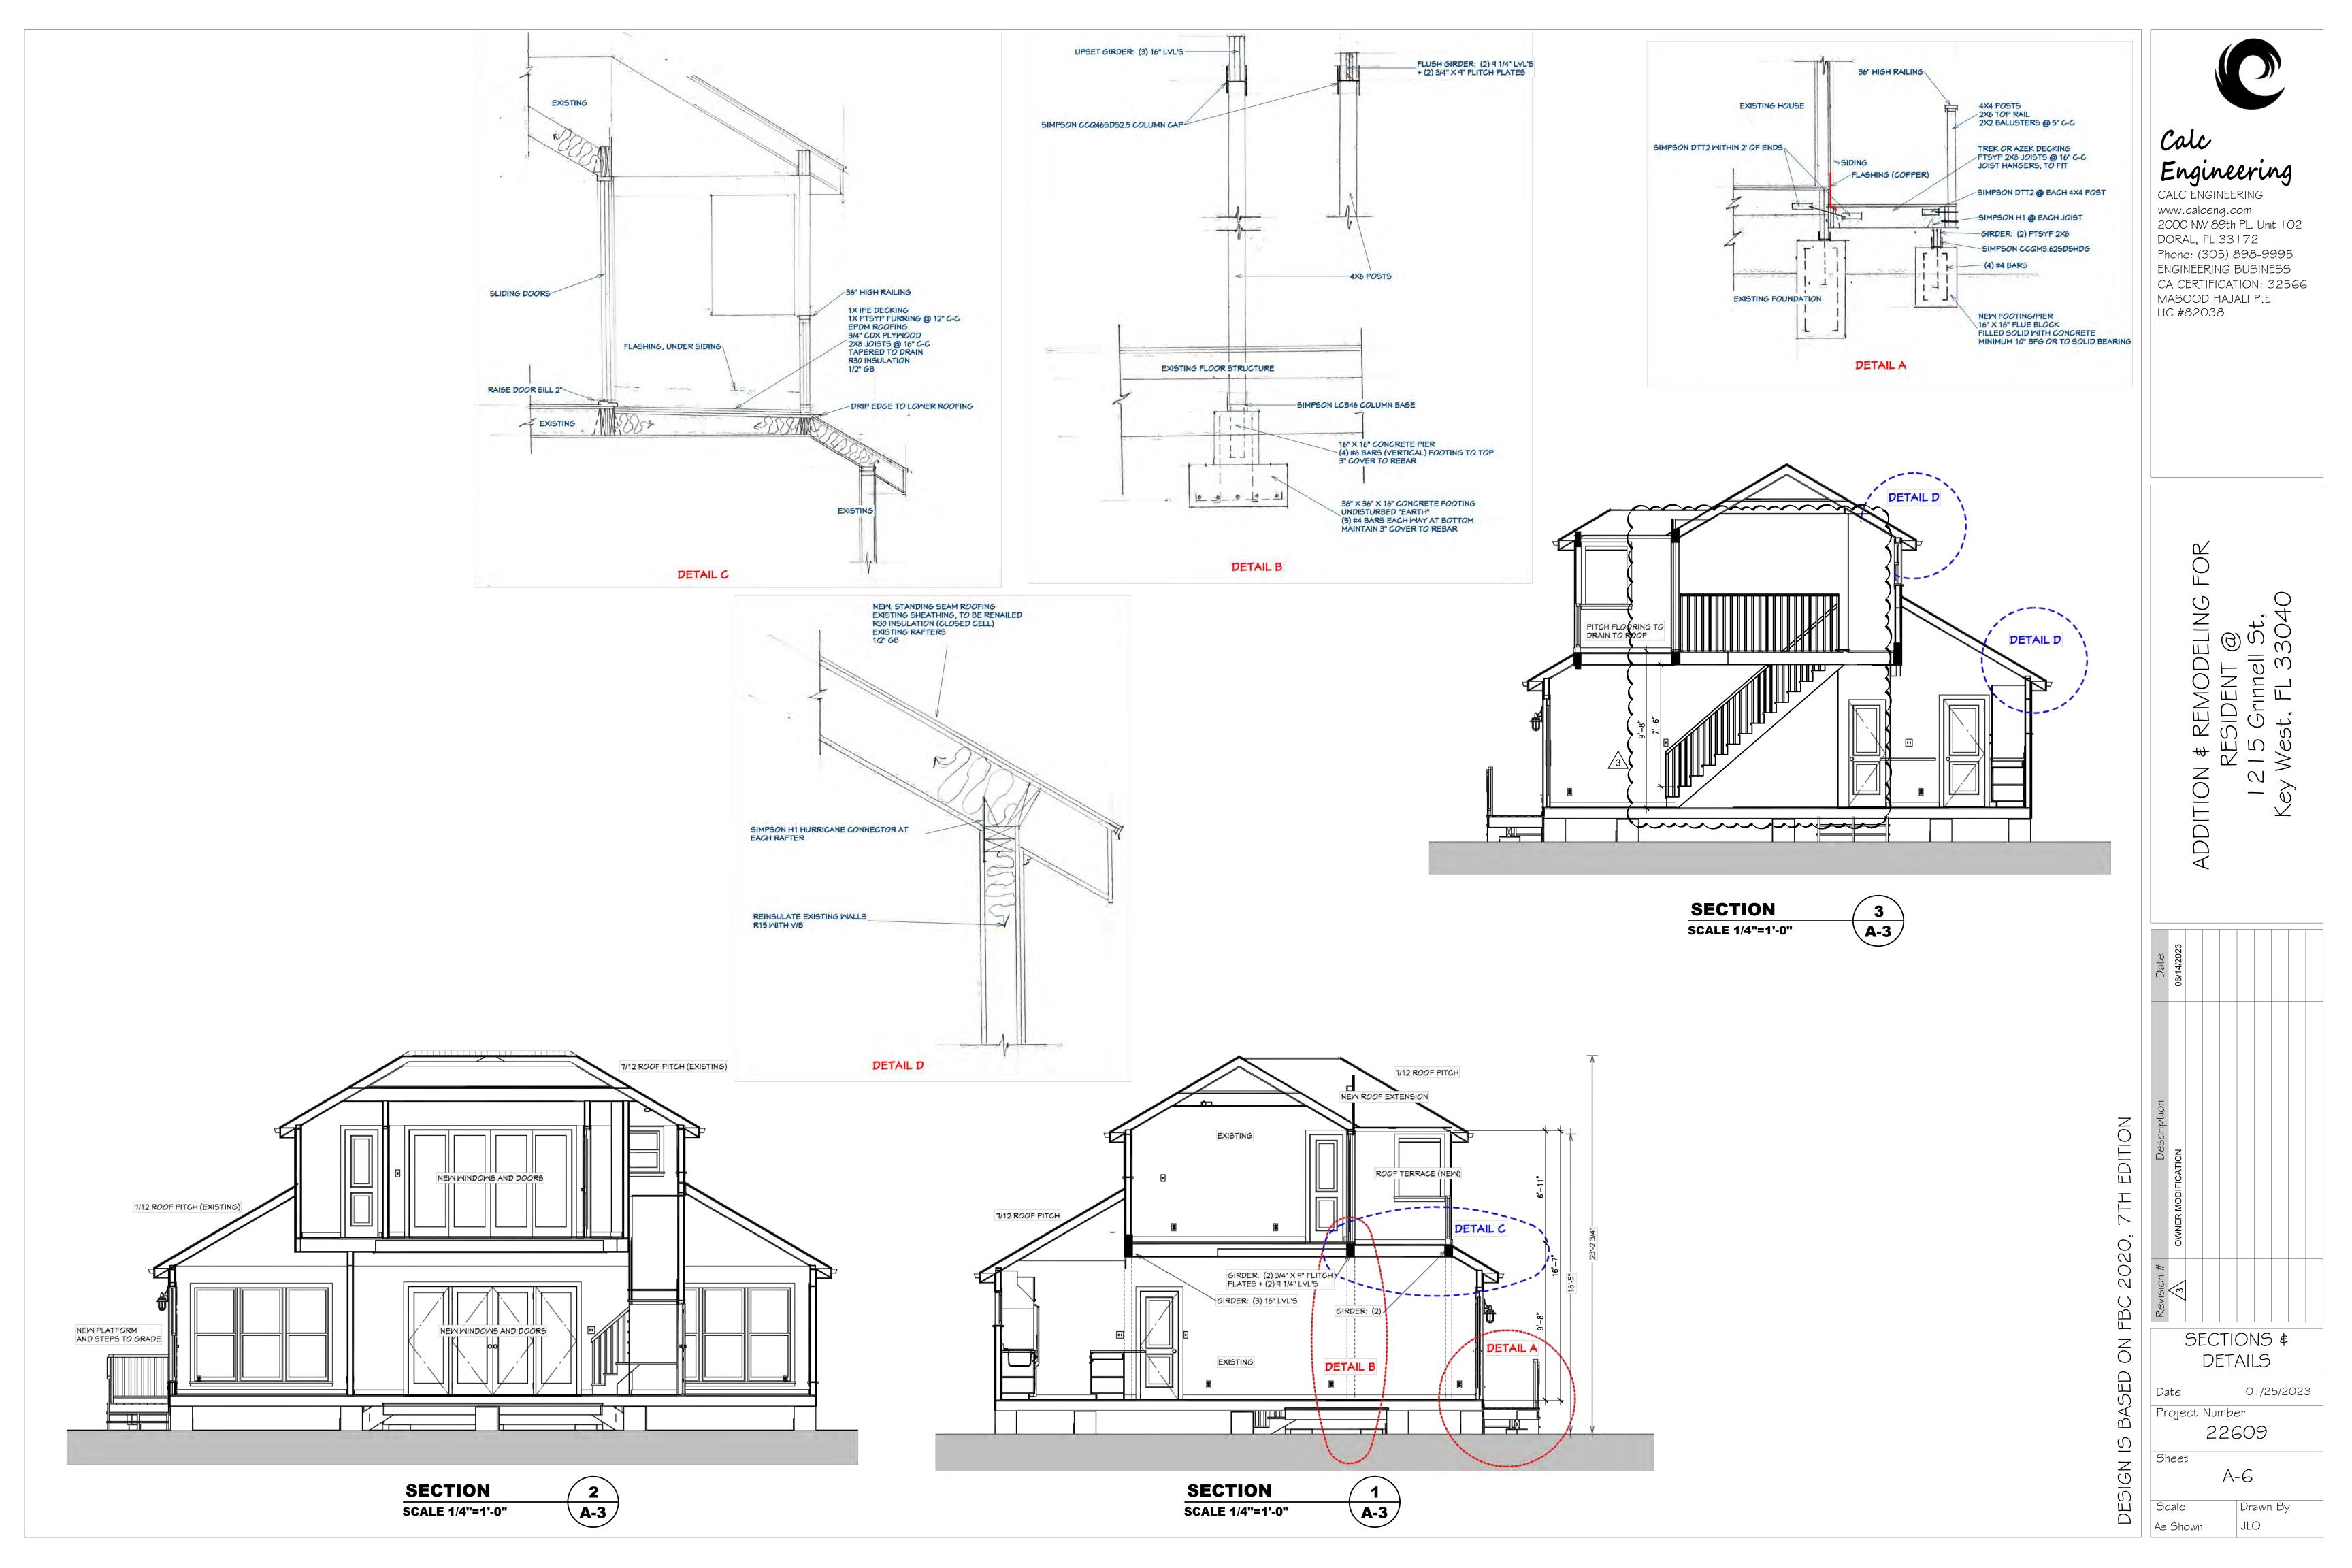

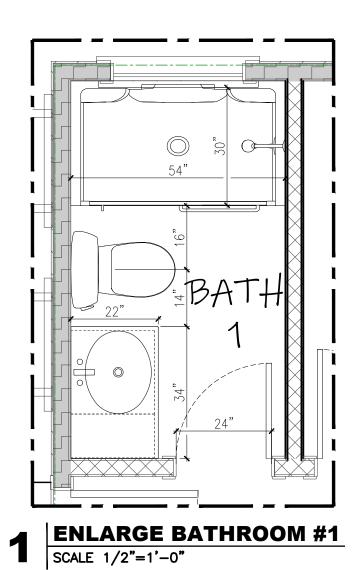


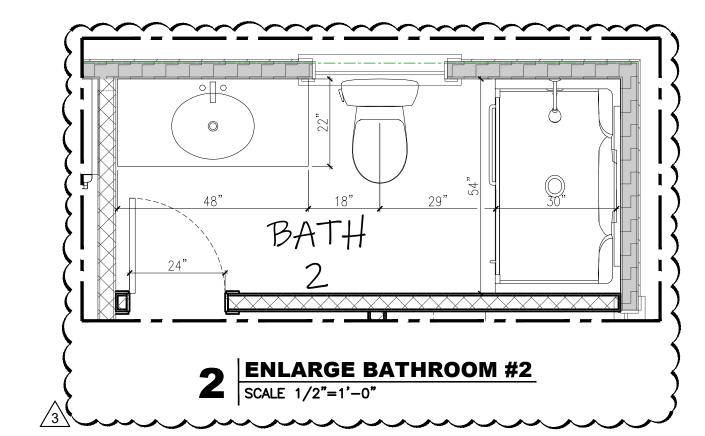

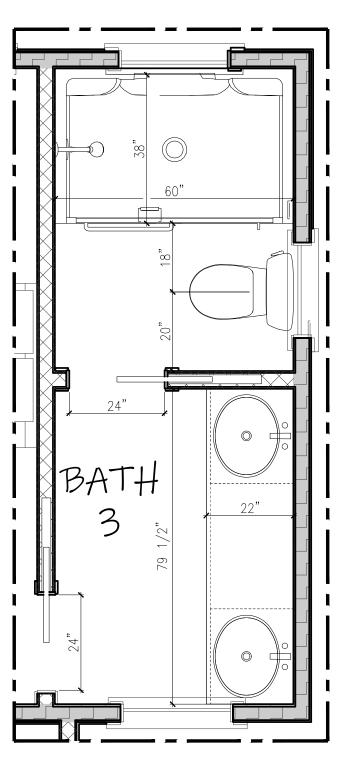

3 ENLARGE BATHROOM #3
SCALE 1/2"=1'-0"



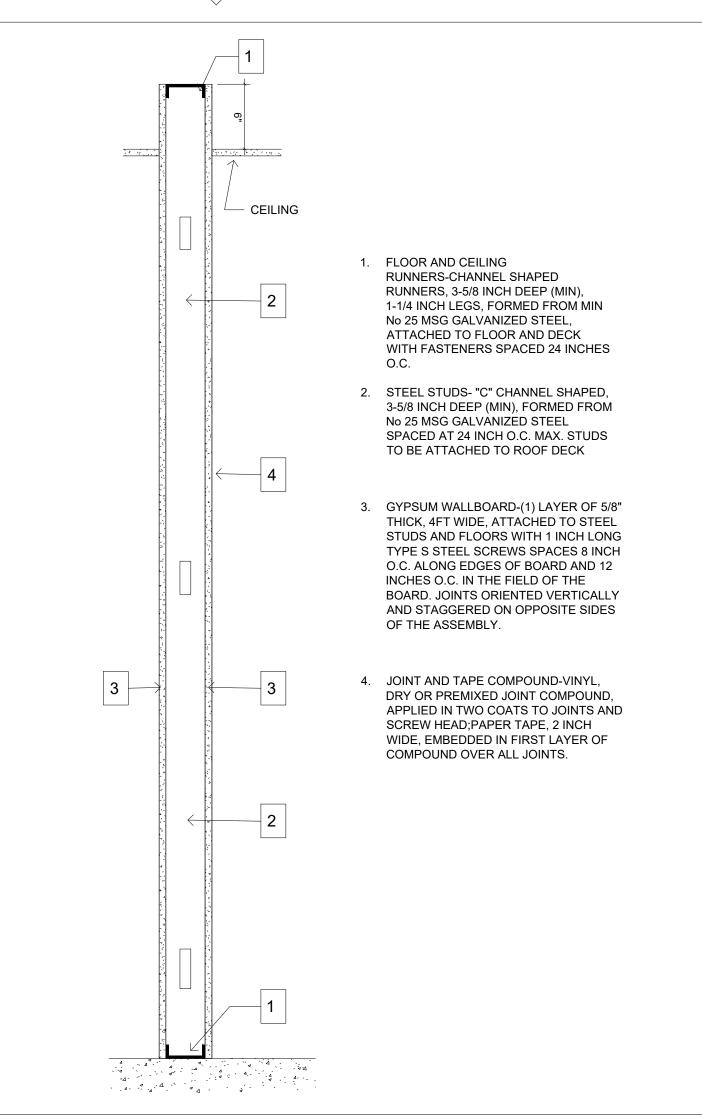


DRYWALL PARTITION DETAIL TYP.

SCALE 1 1/2"=1'-0"

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> ADDITION & REMODELING F(RESIDENT @ 1215 Grinnell St, Key West, FL 33040

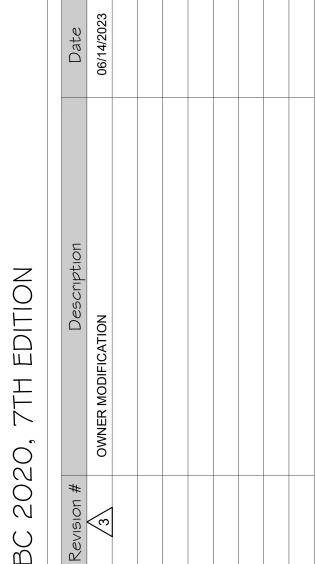

Revision 3					
DE	ETAILS				
Date	01/25/2023				
Project Number 22609					
Sheet	A-7				
Scale	Drawn By				
As Shown	JIO				

APPLICABLE CODES

- FLORIDA BUILDING CODE 2020
- ASCE 7-16 FOR WIND ANALYSIS AND DESIGN ACI 318-14 - BUILDING CODE REQUIREMENTS FOR STRUCTURAL CONCRETE.

DESIGN CRITERIA AND LOADS

WIND: MEAN ROOF HEIGHT

23'-4" BASIC WIND VELOCITY: 180 MPH (ULT) RISK CATEGORY: **EXPOSURE**

0.85 PARTIALLY ENCLOSED BUILDING INTERNAL PRESSURE COEFFICIENT: +/-0.55

60 PSF

ROOF DESIGN LOADS:

LIVE LOADS:

SUPERIMPOSED DEAD LOAD: 20 PSF LIVE LOADS: 30 PSF FLOOR DESIGN LOADS: SUPERIMPOSED DEAD LOAD: 20 PSF

FOUNDATIONS

1. SOIL STATEMENT: VISUAL INSPECTION OF THE SITE SHOWS A SOIL OF LIMESTONE WITH SANDY POCKETS AND WITH LAYER OF TOPSOIL. THE LIMESTONE HAS A SAFE BEARING CAPACITY IN EXCESS OF 2,000PSF. AT THE TIME OF CONSTRUCTION, A LICENSED ENGINEER SHALL SUBMIT TO THE BUILDING OFFICIAL A LETTER ATTESTING THAT THE SITE HAS BEEN OBSERVED AND THE FOUNDATION CONDITIONS ARE SIMILAR TO THOSE UPON WHICH THE DESIGN IS BASED.

2. SHOULD ORGANIC SILT, CLAY POCKETS OR OTHER UNSUITABLE BEARING CONDITIONS BE ENCOUNTERED DURING EXCAVATIONS, NOTIFY THE ENGINEER BEFORE CONTINUING WITH CONSTRUCTION.

3. TOP OF FOOTINGS SHALL BE AT 2'-0" BELOW GRADE AT ALL POINTS U.N.O.

4. CONTRACTOR SHALL PROVIDE SURFACE DRAINAGE AND PUMPS TO PROTECT EXCAVATIONS FROM FLOODING AFTER APPROVAL.

CONCRETE AND REINFORCING

1. ALL NORMAL—WEIGHT CONCRETE MUST BE MIXED IN ACCORDANCE WITH ACI 301 TO ACHIEVE A MINUMUM 28—DAY COMPRESSIVE STRENGTH OF 3000PSI. WATER/CEMENT RATIO MUST BE 0.40 MAX. BY WEIGHT UON ON PLANS AND 0.15 MAX. WATER-SOLUBLE CHLORIDE ION CONTENT IN CONCRETE (PERCENT BY WEIGHT OF CEMENT) IN ACCORDANCE TO TABLE 4.3.1 OF ACI 318-14.

2. SLUMP SHALL BE 4" (±1). 3. CONTRACT AN INDEPENDENT TESTING LABORATORY TO PERFORM THE CONCRETE CYLINDER SAMPLING AND TESTING AS REQUIRED FLORIDA BUILDING CODE, 2020. SUBMIT TEST REPORTS TO ENGINEER.

4. AGGREGATES TO BE CLEAN AND WELL GRADED, MAX. SIZE 1". VERTICAL DROP NOT TO EXCEED 8'-0".

5. NO ADDITIONAL WATER SHALL BE ADDED TO THE CONCRETE MIX AT THE JOBSITE UNLESS PREVIOUSLY APPROVED.

6. PROVIDE ALL FORMING AND TEMPORARY SHORING.

REINFORCING STEEL:

- 1. STANDARD: ASTM A-615, GRADE 60, ASTM A185 FOR WELDED WIRE FABRIC.
- 2. REINFORCEMENT PLACEMENT TOLERANCES MUST COMPLY WITH SECTION 2.2 OF ACI 117.
- 3. SHALL BE DEFORMED BARS, FREE FROM LOOSE RUST AND SCALE.

4. CONTRACTOR TO PROVIDE CHAIRS BOLSTERS, SPACERS ETC. IN ORDER TO CORRECTLY ASSEMBLE, PLACE AND SUPPORT ALL REINFORCING IN PLACE.

5. ALL REINFORCING SHALL CONFORM TO THE "MANUAL OF STANDARD PRACTICE FOR DETAILING REINFORCED CONCRETE STRUCTURES" (ACI - 315)

6. CONCRETE COVER FOR REINFORCEMENT:

- FOOTINGS 3" CLEAR ALL AROUND

WOOD MEMBERS

- 1. ALL WOOD TO BE SOUTHERN YELLOW PINE No. 2.
- 2. WOOD IN CONTACT WITH CONCRETE OR MASONRY, AND AT OTHER LOCATIONS AS SHOWN ON STRUCTURAL DRAWINGS, SHALL BE
- PROTECTED WITH 30 # FELT OR PRESSURE TREATED IN ACCORDANCE WITH AITC-109. 3. MEMBER SIZE SHOWN ARE NORMAL UNLESS NOTED OTHERWISE.
- 4. GIRDERS SHALL BE SECURED WITH APPROVED METAL TIES, CLIPS AND ANCHORS TO BOND BEAMS OR BEARING WALLS.
- 5 ALL METAL CONNECTORS USED IN LOCATIONS EXPOSED TO WEATHER SHALL BE GALVANIZED.
- 6. NAILS SHALL PENETRATE THE SECOND MEMBER A DISTANCE EQUAL TO THE THICKNESS OF THE MEMBER BEING NAILED THERE TO. 7. THERE SHALL BE NOT LESS THAN 2 NAILS IN ANY CONNECTION.
- 8. PLYWOOD ROOF DECKING SHALL BE 5/8" MINIMUM THICKNESS, AND SHALL BE CONTINUOUS OVER TWO OR MORE SPANS, WITH FACE GRAIN PERPENDICULAR TO THE SUPPORTS.
- 9. PLYWOOD FLOOR DECKING SHALL BE 3/4" MINIMUM THICKNESS, AND SHALL BE CONTINUOUS OVER TWO OR MORE SPANS, WITH FACE GRAIN PERPENDICULAR TO THE SUPPORTS.


10. EXTERIOR WOOD WALLS SHALL CONSIST OF 2X6 STUDS @ 16" MAX. O/C U.N.O.

CONTRACTORS

- CONTRACTOR SHALL BE RESPONSIBLE FOR PROTECTION OF EXISTING AND/OR ADJACENT STRUCTURES, STREETS, AND SIDEWALKS DURING
- CONTRACTOR SHALL VERIFY ALL DIMENSIONS IN THE FIELD. SHOULD A DISCREPANCY BE FOUND STOP WORK IMMEDIATELY AND NOTIFY OUR OFFICE.
- CONTRACTOR SHALL WORK THE STRUCTURAL PLANS IN CONJUNCTION WITH THE ARCHITECTURAL, MECHANICAL, ELECTRICAL, AND PLUMBING DRAWINGS.
- 4. EXISTING STRUCTURE: CONTRACTOR SHALL REVIEW THE ORIGINAL CONSTRUCTION DRAWINGS OF THE EXISTING BUILDING PRIOR TO BIDDING AND DURING CONSTRUCTION TO VERIFY THE EXISTING MEMBERS AFFECTED BY THE NEW CONSTRUCTION. 5. THE USE OF SCALE TO OBTAIN DIMENSIONS NOT SHOWN ON THESE PLANS IS STRICTLY FORBIDDEN. THE ENGINEER WILL NO BE
- RESPONSIBLE FOR ERRORS RESULTING FROM SUCH ACTION. 6. IN CASE OF DISCREPANCIES BETWEEN THE ARCHITECTURAL AND STRUCTURAL PLANS, THE ARCHITECTURAL PLANS SHALL GOVERN UNLESS STRENGTH IS AFFECTED.
- 7. ALL SPECIFIED MATERIALS AND CONNECTORS CAN BE SUBSTITUTED WITH EQUAL OR BETTER, WITH THE APPROVAL OF ENGINEER OF
- 8. CONTRACTO SHALL BE THE ONLY PARTY RESPONSIBLE FOR THE DESIGN, INSTALLATION AND DISMANTLING OF TEMPORARY SHORING.


TERMITE PROTECTION STATEMENT

-TERMITE PROTECTION SHALL BE PROVIDED BY REGISTERED TERMITICEDES, INCLUDING SOIL APPLIED PESTICIDES, BAITING SYSTEMS, AND PESTICIDES APPLIED TO WOOD, OR OTHER APPROVED METHODS OF TERMITE PROTECTION LABELED FOR USE AS A PREVENTATIVE TREATMENT TO NEW CONSTRUCTION. UPON COMPLETION OF THE APPLICATION OF THE TERMITE PROTECTIVE TREATMENT, A CERTIFICATE OF COMPLIANCE SHALL BE ISSUED TO THE BUILDING DEPARTMENT BY THE LICENSED PEST CONTROL COMPANY THAT CONTAINS THE FOLLOWING STATEMENT: "THE BUILDING HAS RECEIVED A COMPLETE TREATMENT FOR THE PREVENTION OF SUBTERRANEAN TERMITES. TREATMENT IS IN ACCORDANCE WITH RULES AND LAWS ESTABLISHED BY THE FLORIDA DEPARTMENT OF AGRICULTURE AND CONSUMER SERVICES" IN COMPLIANCE WITH FBC 2014 R318

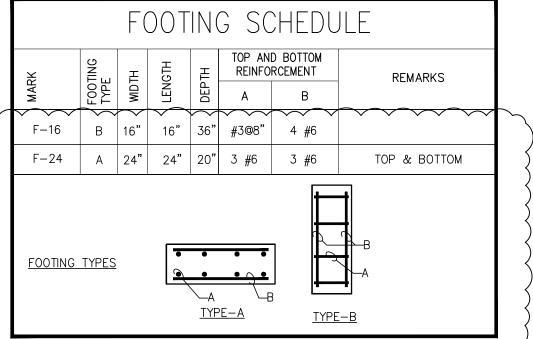


	ROOF STRAP/HANGER SCHEDULE							
	LABEL	TYPE	QUANTITY	NOA No./ FL. APPROVAL	ALLOWABLE LOAD	NAILING		
	А	NU-VUE NVRT-20	1	MD-NOA 23-0210.02	U=1135#	(7*2=14) 16d @ BOTH MEMBERS		
	В	USP RT16A	1	FL 17236	U=1029#	(9) 10d @ LDGR (8) 10d @ TOP PL		
	С	NU-VUE NVRT-20	4	MD-NOA 23-0210.02	U=4540#	(7*2=14) 16d @ BOTH MEMBERS @ EA STRAP		
	D	NU-VUE NVRT-20	6	MD-NOA 23-0210.02	U=6840#	(7*2=14) 16d @ BOTH MEMBERS @ EA STRAP		
	E	USP HUS26	1	FL 17232-R2	U=2045# G=2760#	(14) 16d @ HEADER (6) 16d @ RFIR		
	F	USP HUS28	1	FL 17232-R2	U=2990# G=4170#	(22) 16d @ BEAM (8) 16d @ JOIST		
	G	USP RT16-2	1	FL-17236	U=1060# Flat=410#	(8) 10d @ LDGR (8) 10d @ TOP PL		
	Н	NOT USED						
	J	NU-VUE NV458-22	1	MD 23-0210.01	U=3367#	(16) 10dX3" @ STRAP (8) 10dX3" @ SEAT		
}	K	SIMPSON HHUS5.50/10	1	FL 17232-R2	U=2170# G=2390#	(8) 16d @ LDGR (8) 16d @ RFTR		

		COLUMN SCHEDULE		
MARK	SIZE AND MATERIAL	BASE PLATE	TYPE	COMMENTS
WC	TRIPLE 2X6 P.T. WOOD	USP CBE44 W/(12)16 INTO POST AND 6½" EMB. INTO FTG ALL. UPLIFT= 2770LB, ALL. GRAVITY= 16835LB. FL- 22052	1	SYP. No.2

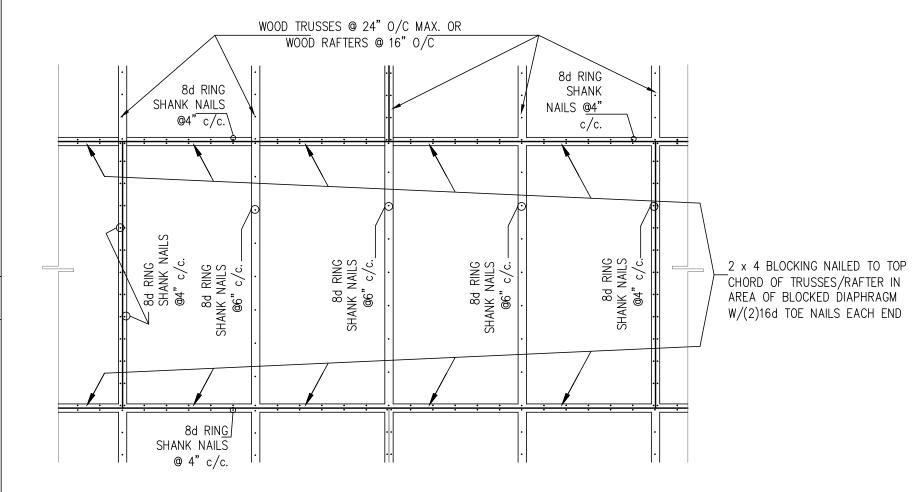

ROOF SHEATING BOARDS NAILING DIAGRAM AT BLOCKING

3/4"=1'-0"

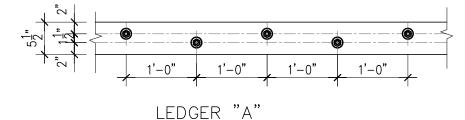

(2) 2x6 P.T. WOOD LEDGER W/ 1/2"ø HILTI KB3 @ 12" O.C. (4" MIN. EMB.) STAGGERED

TYP. LEDGER DETAILS

3/4"=1'-0"



AERIAL VIEW - SCOPE OF WORK

SCOPE OF WORK: NEW WOOD ADDITION AND REMODELING IN THIS AREA (REFER TO ENLARGED PLAN) Calc

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2000 NW 89th PL. Unit 102

Phone: (305) 898-9995

ENGINEERING BUSINESS

MASOOD HAJALI P.E


LIC #82038

REMODELING

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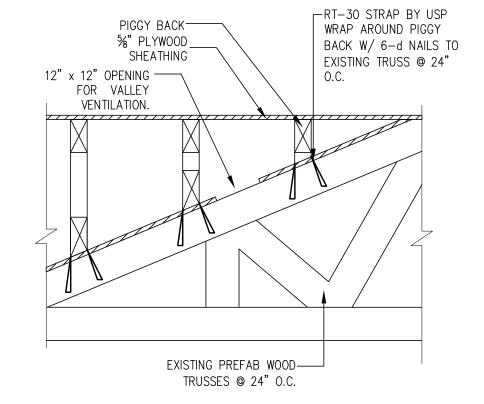
CA CERTIFICATION: 32566



ZONE 2r= -110.7 PSF ZONE 3e= -176.6 PSF -ALL ROOFING UPLIFT PROVIDED ARE PER

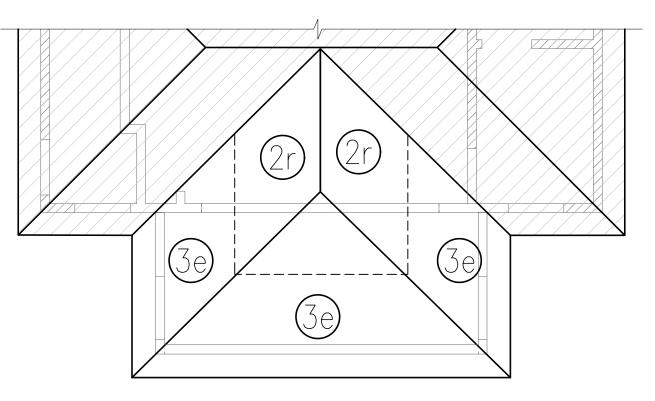ASCE 7-16, SERVICE LOADS.

ROOF PRESSURE DIAGRAM NTS



PIGGY BACK TRUSS DETAIL 3/4"=1'-0"

 \Box


EDITION \mathcal{O} N O

12/15/2022


22609

S-1


AS SHOWN

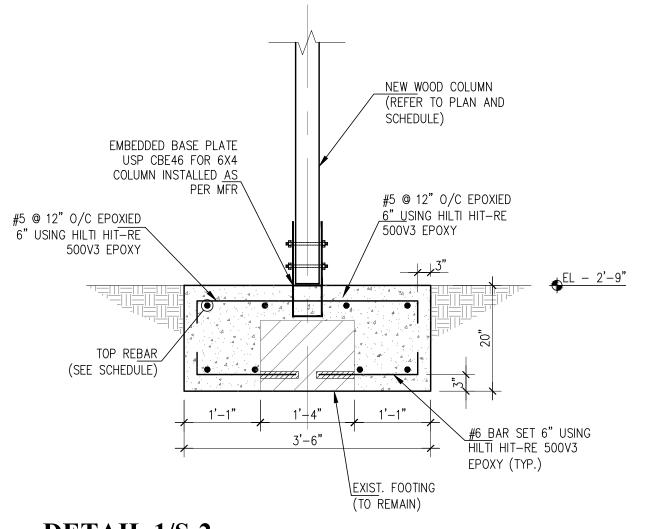


DETAIL 1/S-2 3/4"=1'-0"

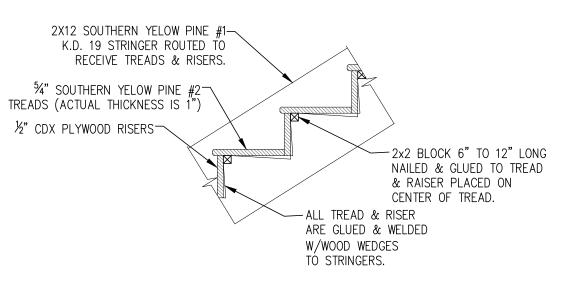

DETAIL 2/S-2 1/2"=1'-0"

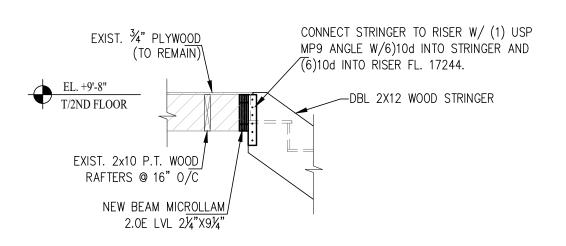

DETAIL 3/S-2 1/2"=1'-0"

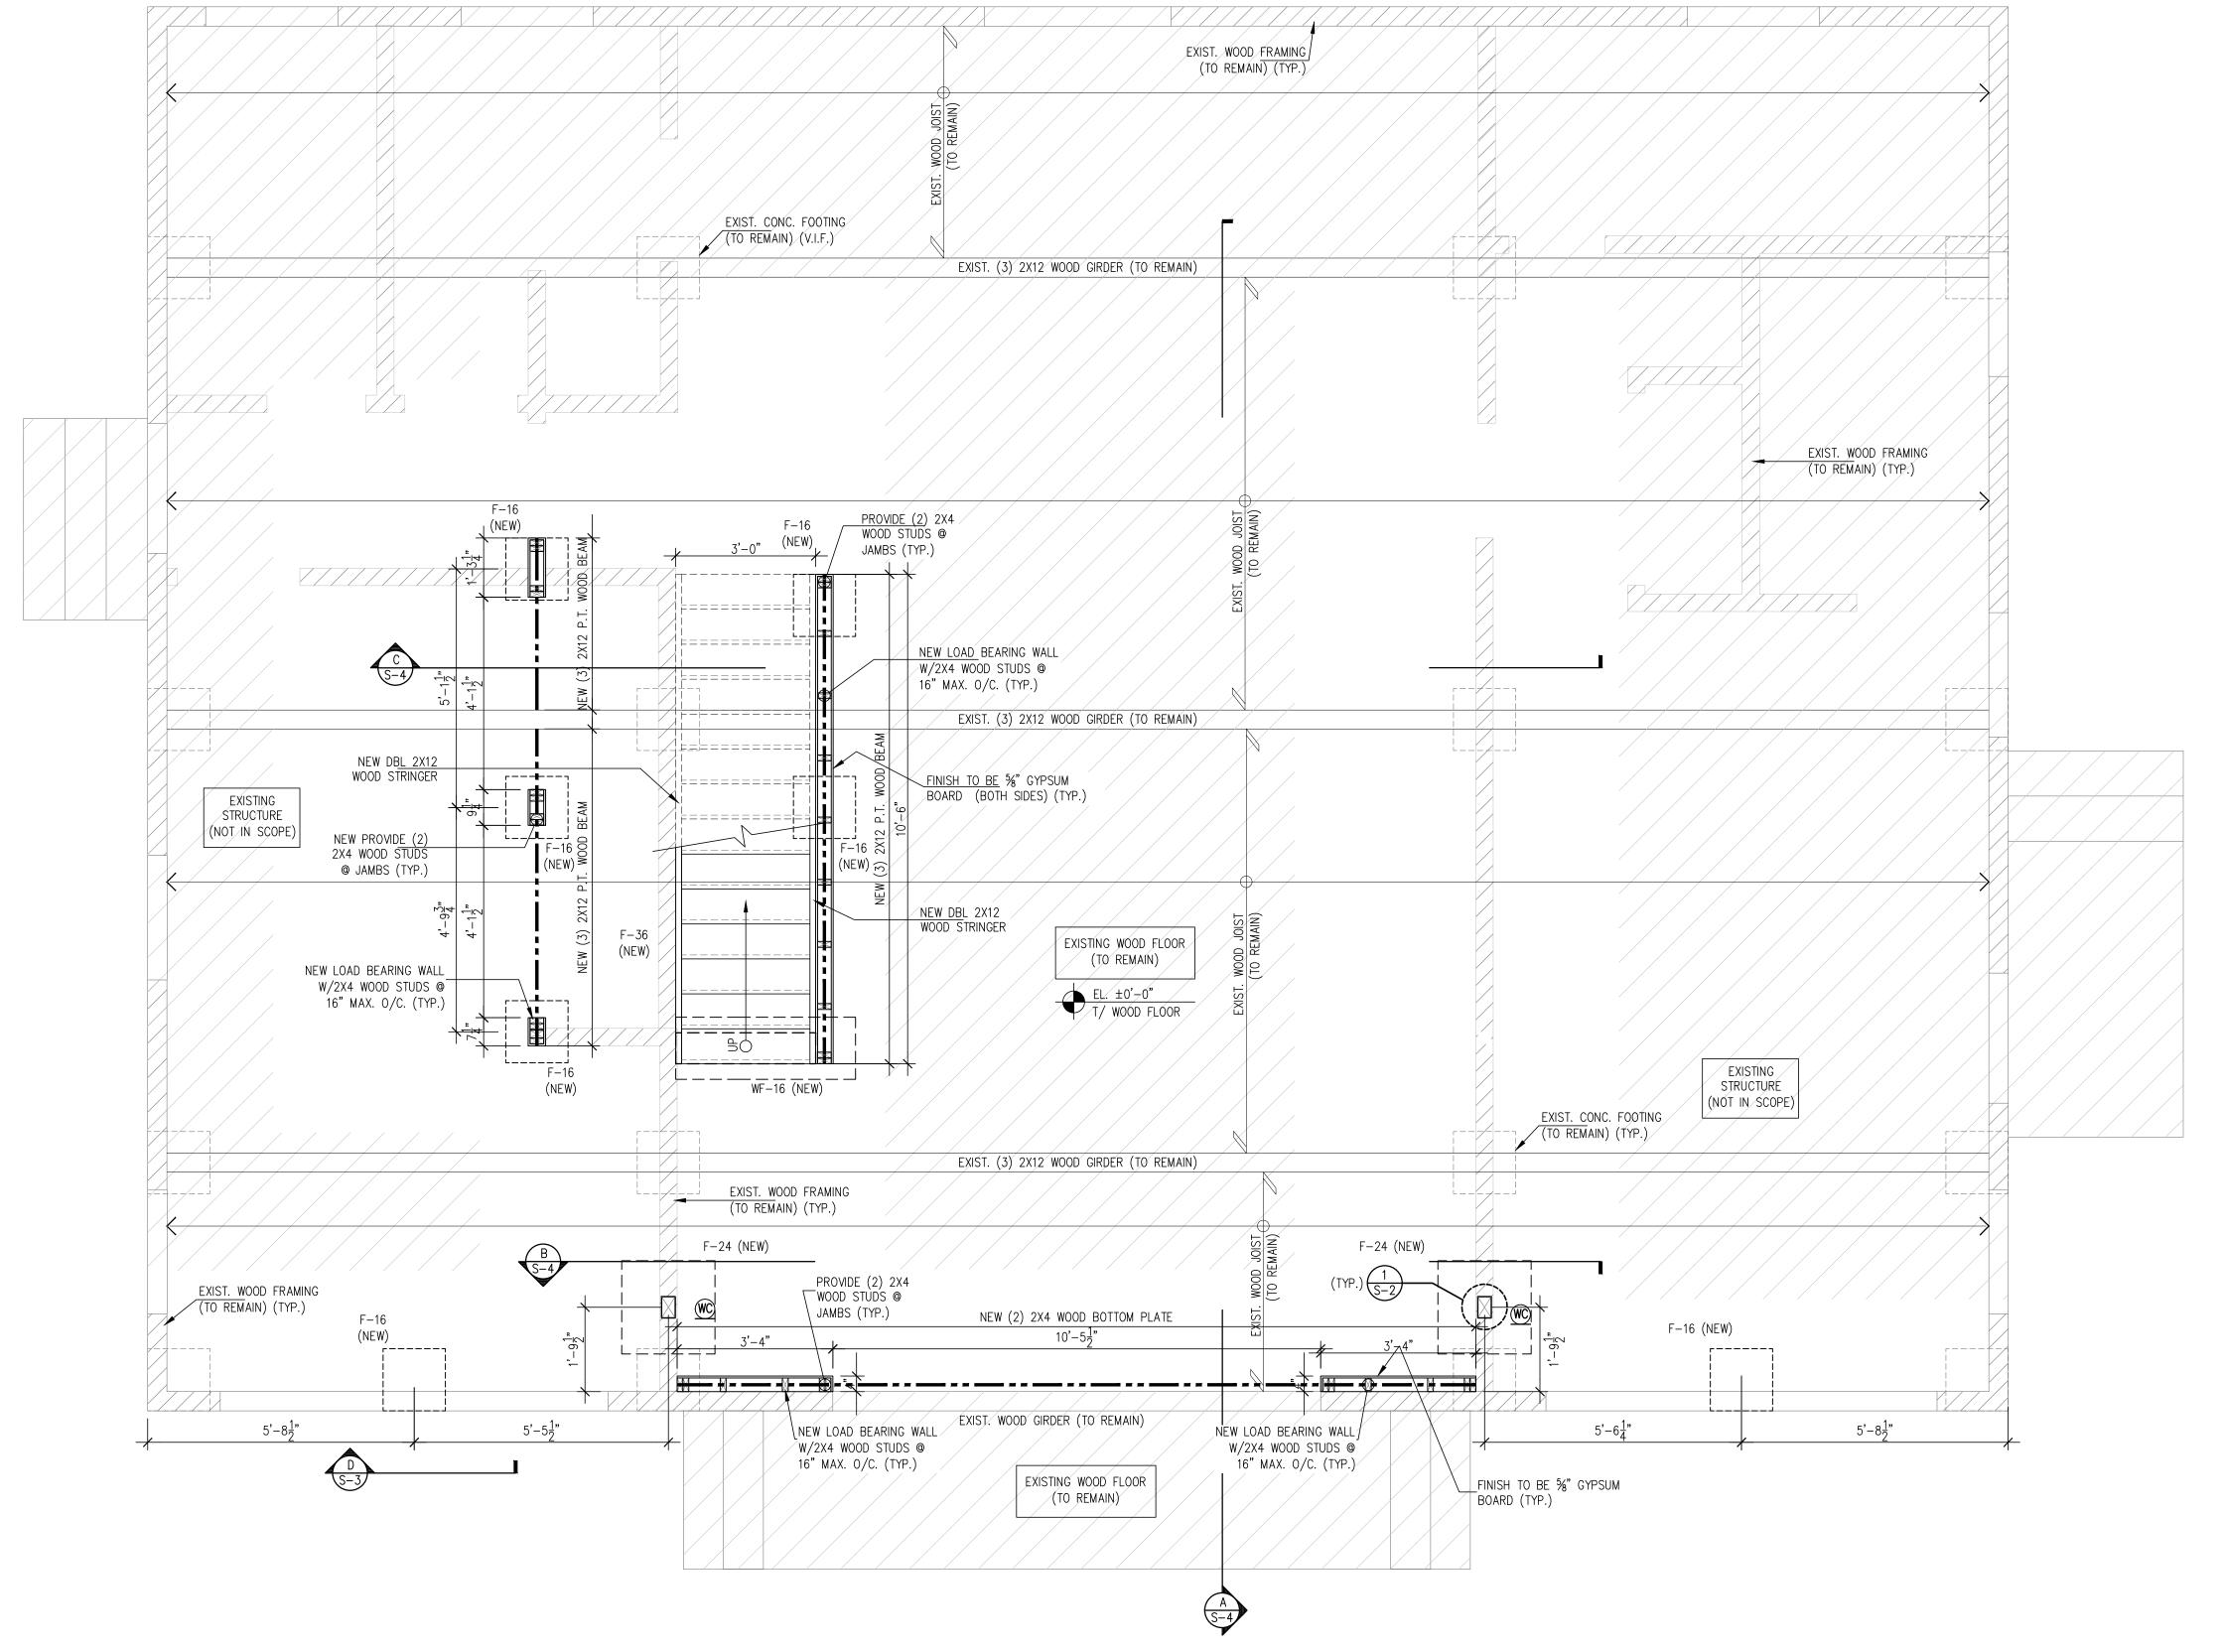

PROPOSED FOUNDATION/FLOOR PLAN

1/2"=1'-0"

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REMODELING | SSIDENT @ St., FL 33040

ADDI

2020,

EDITION

FBC

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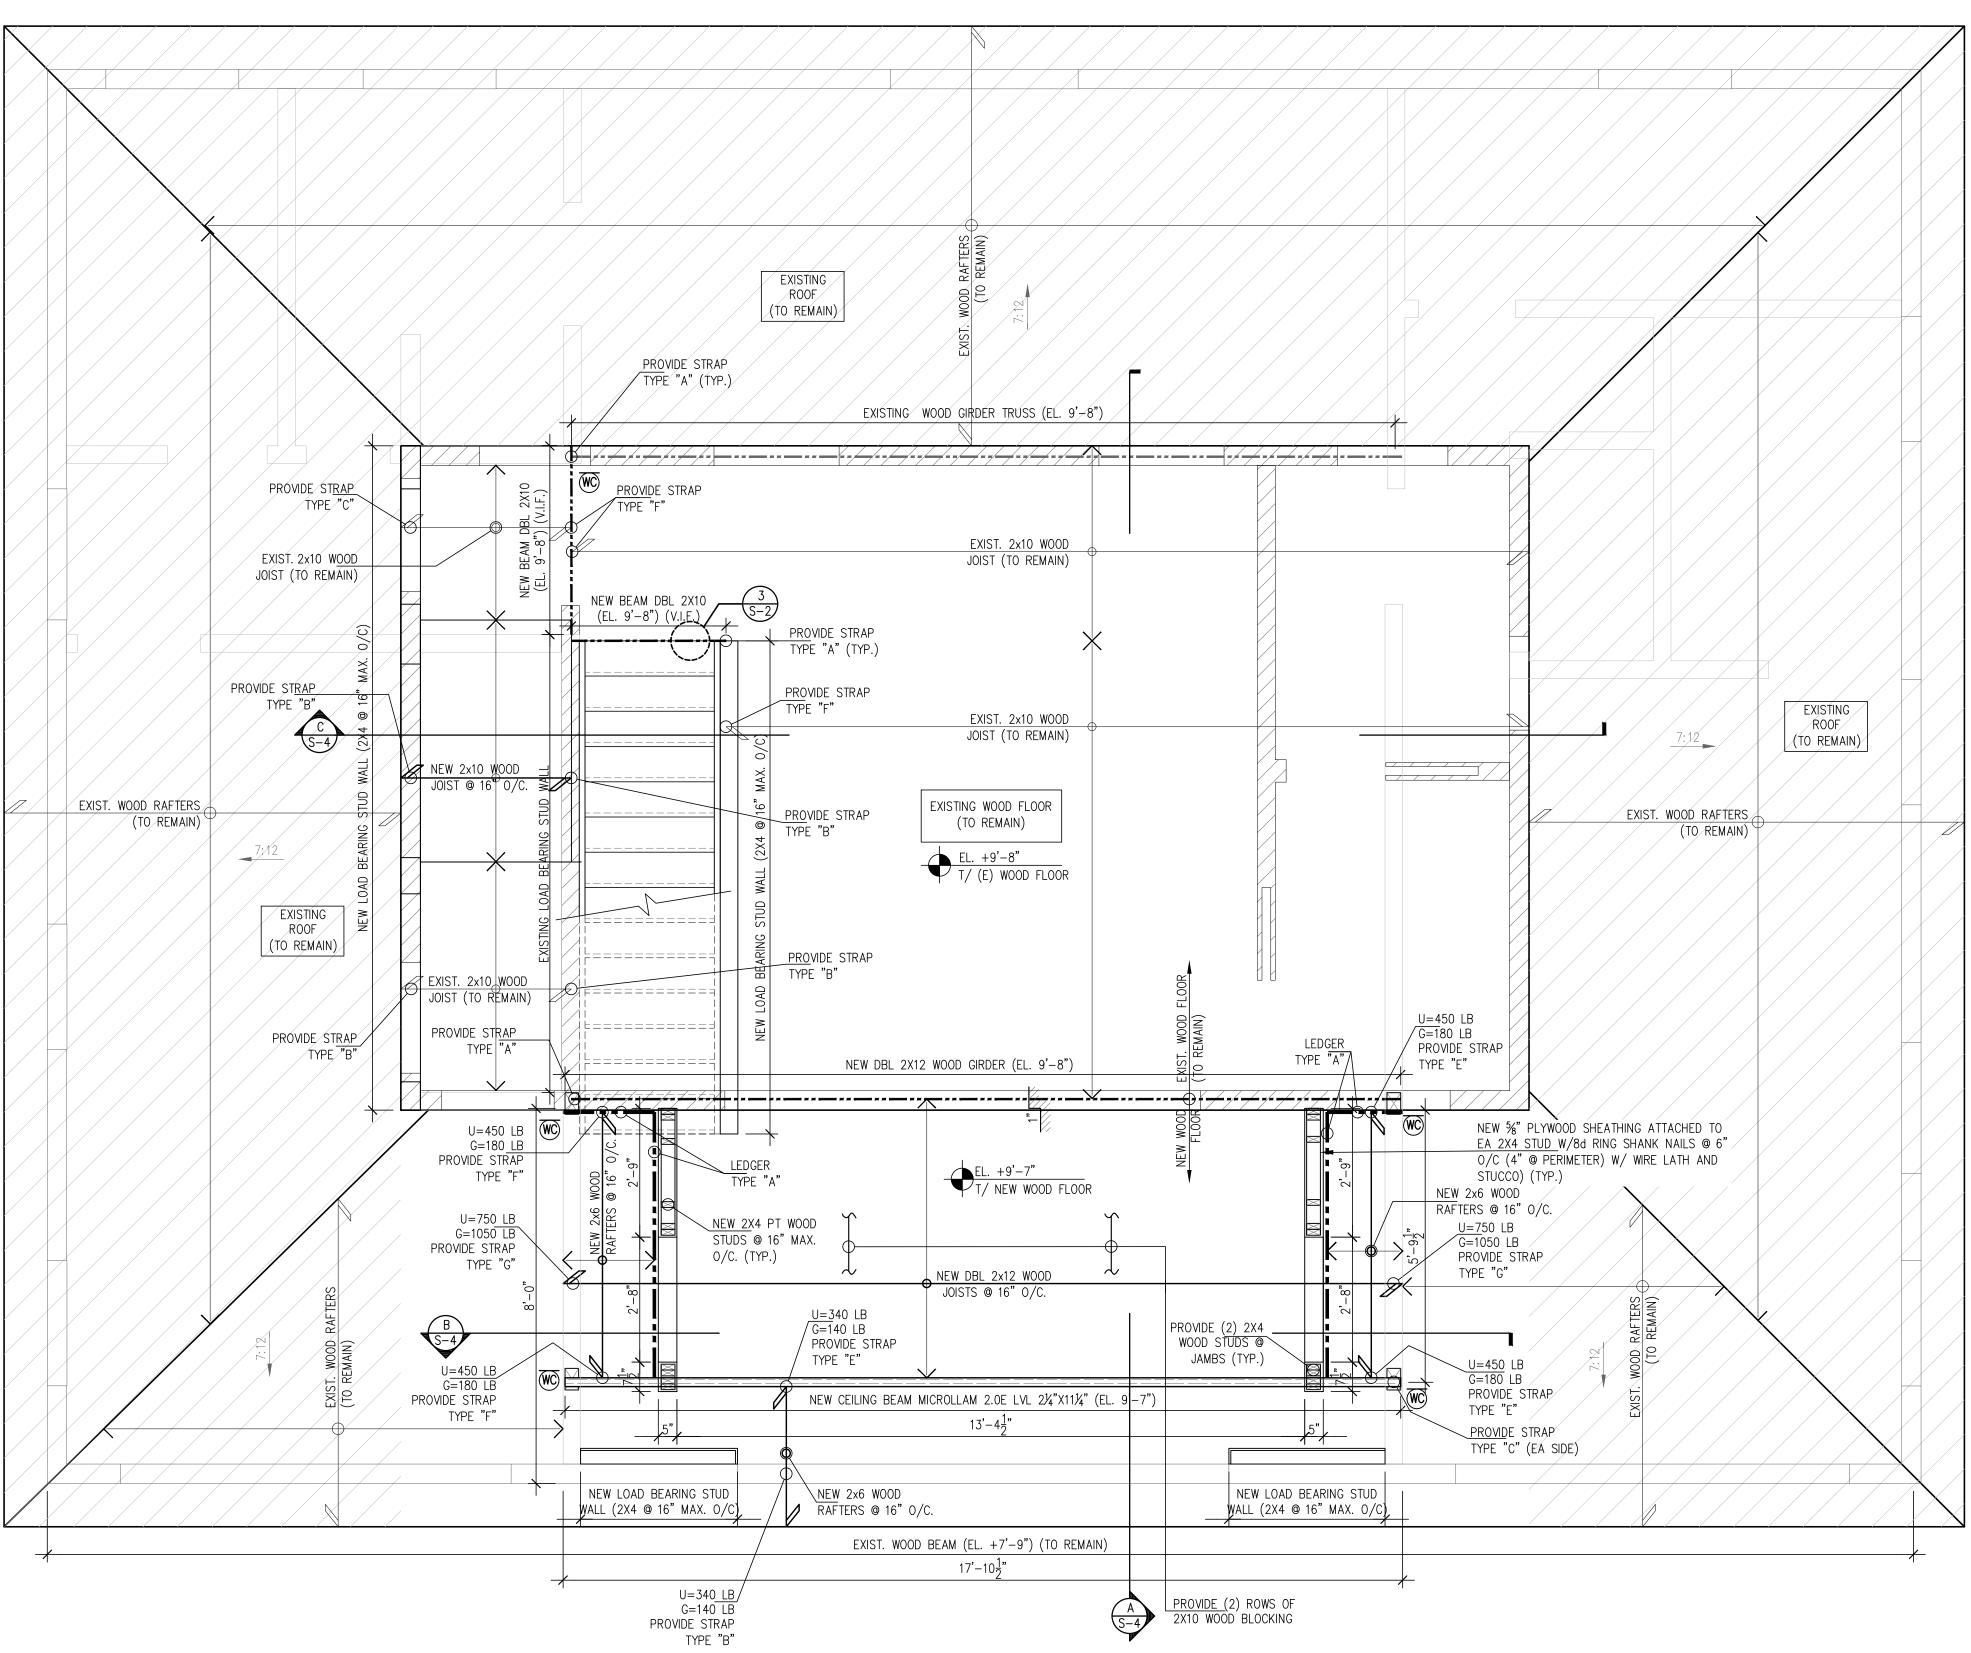
DESIGN


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5-2

AS SHOWN





SECTION D/S-3

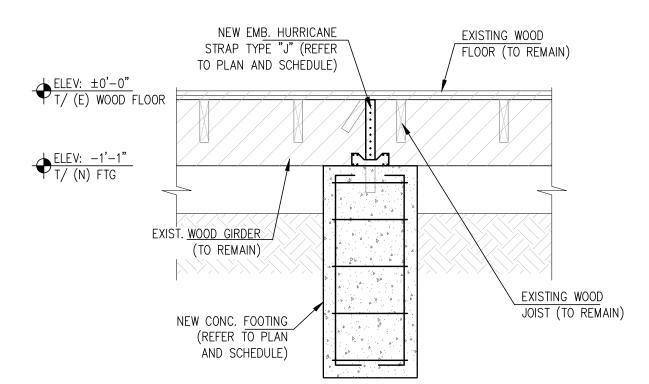3/4"=1'-0"

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> N & REMODELING F RESIDENT @ 215 Grinnell St, West, FL 33040 ADDI

EDITION 2020,

FBC

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DESIGN


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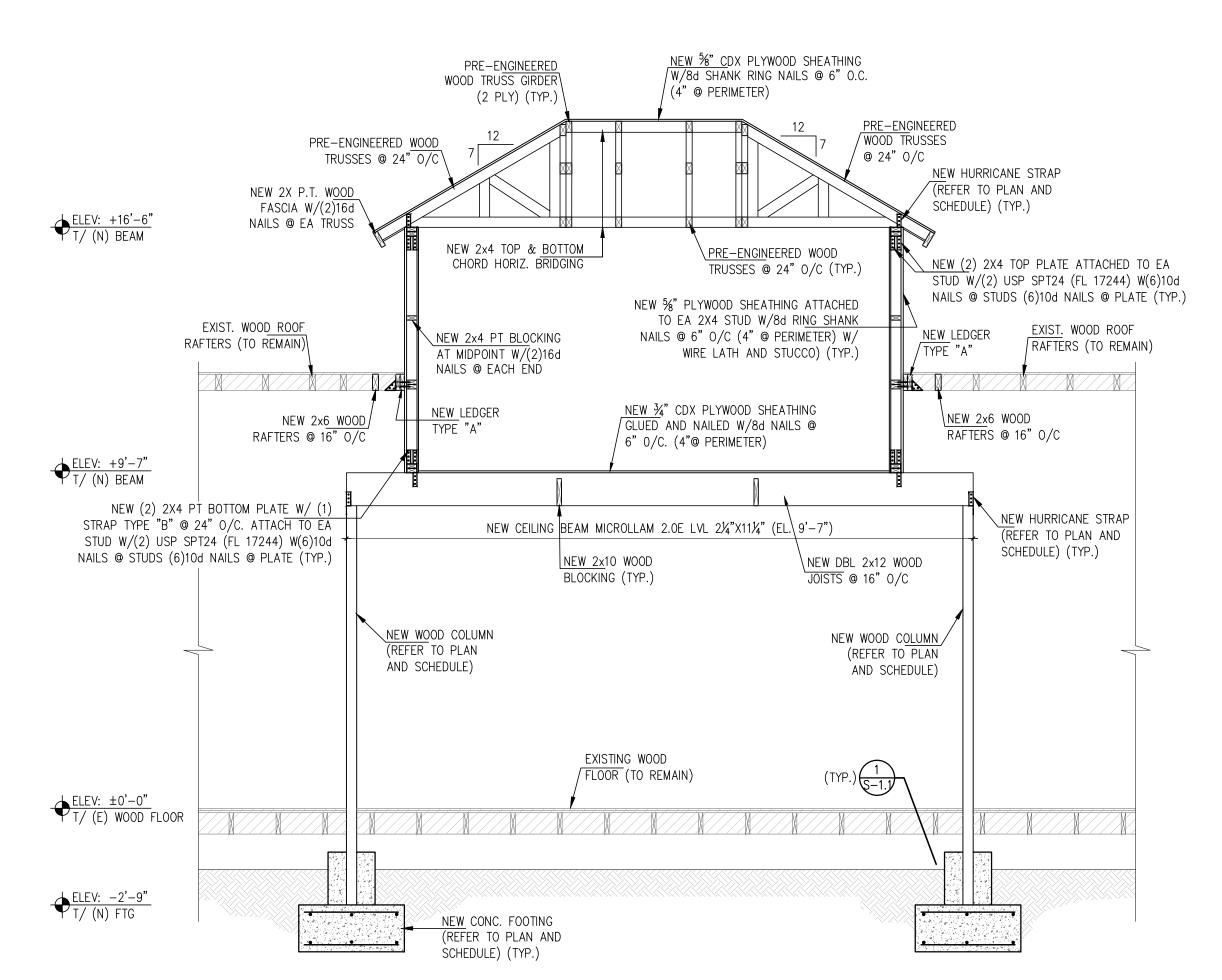
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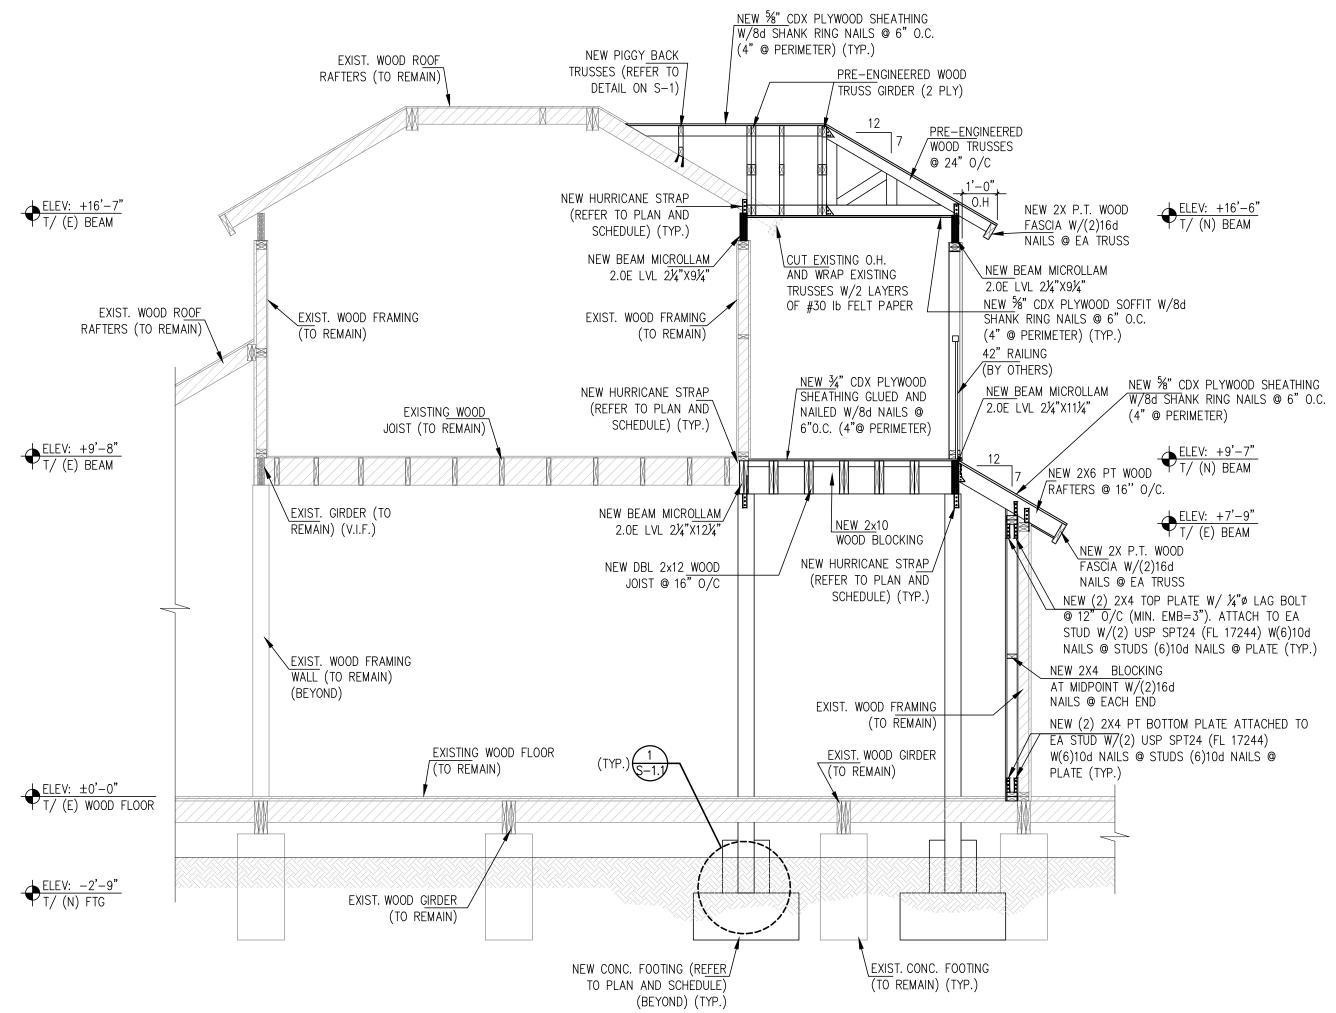
AS SHOWN Scale

PROPOSED 2ND FLOOR PLAN






SECTION B/S-4 3/8"=1'-0"

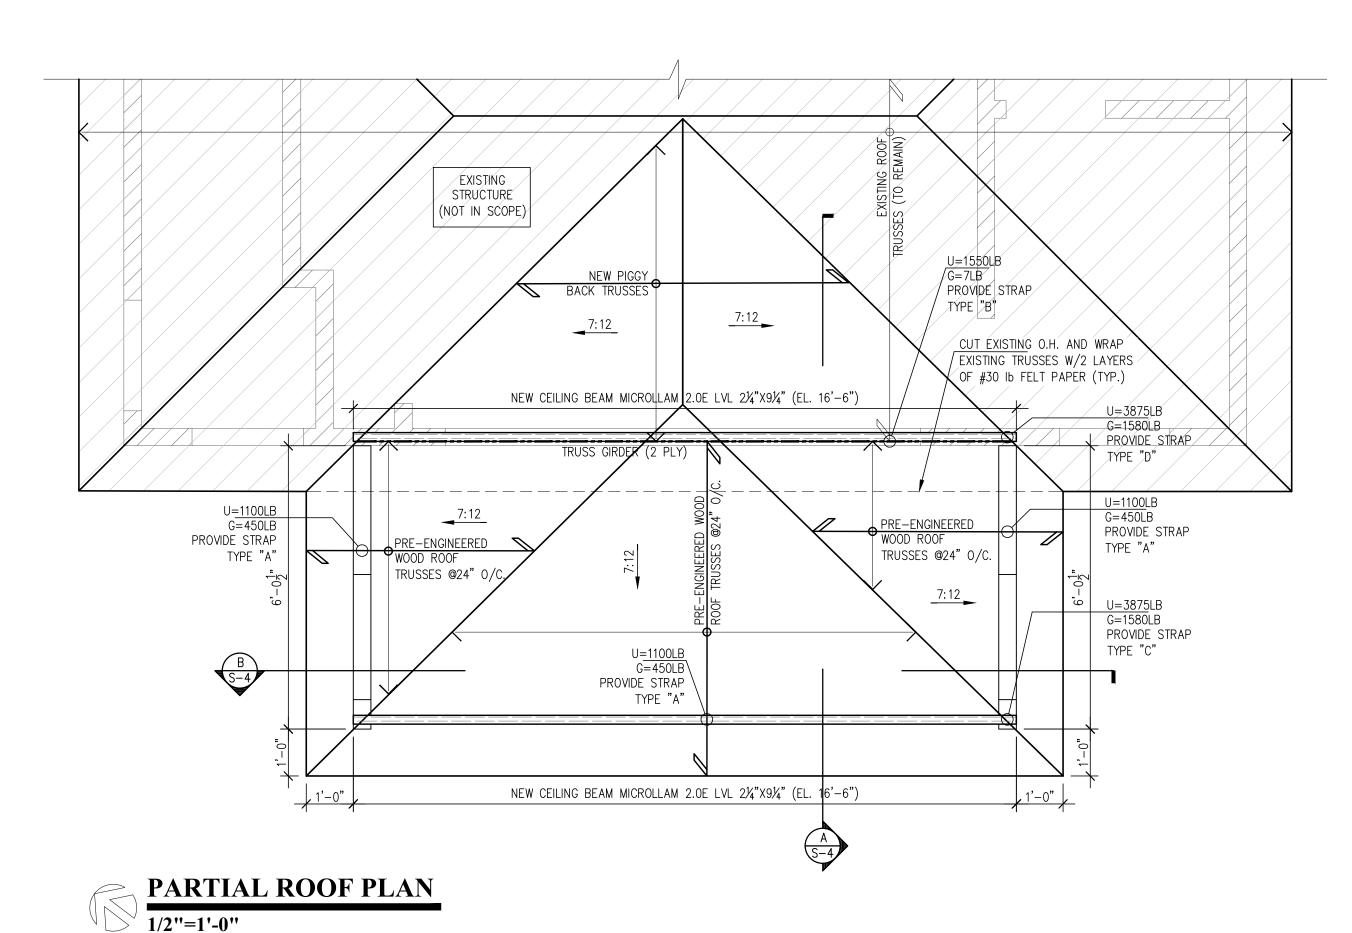

SECTION A/S-4

3/8"=1'-0"

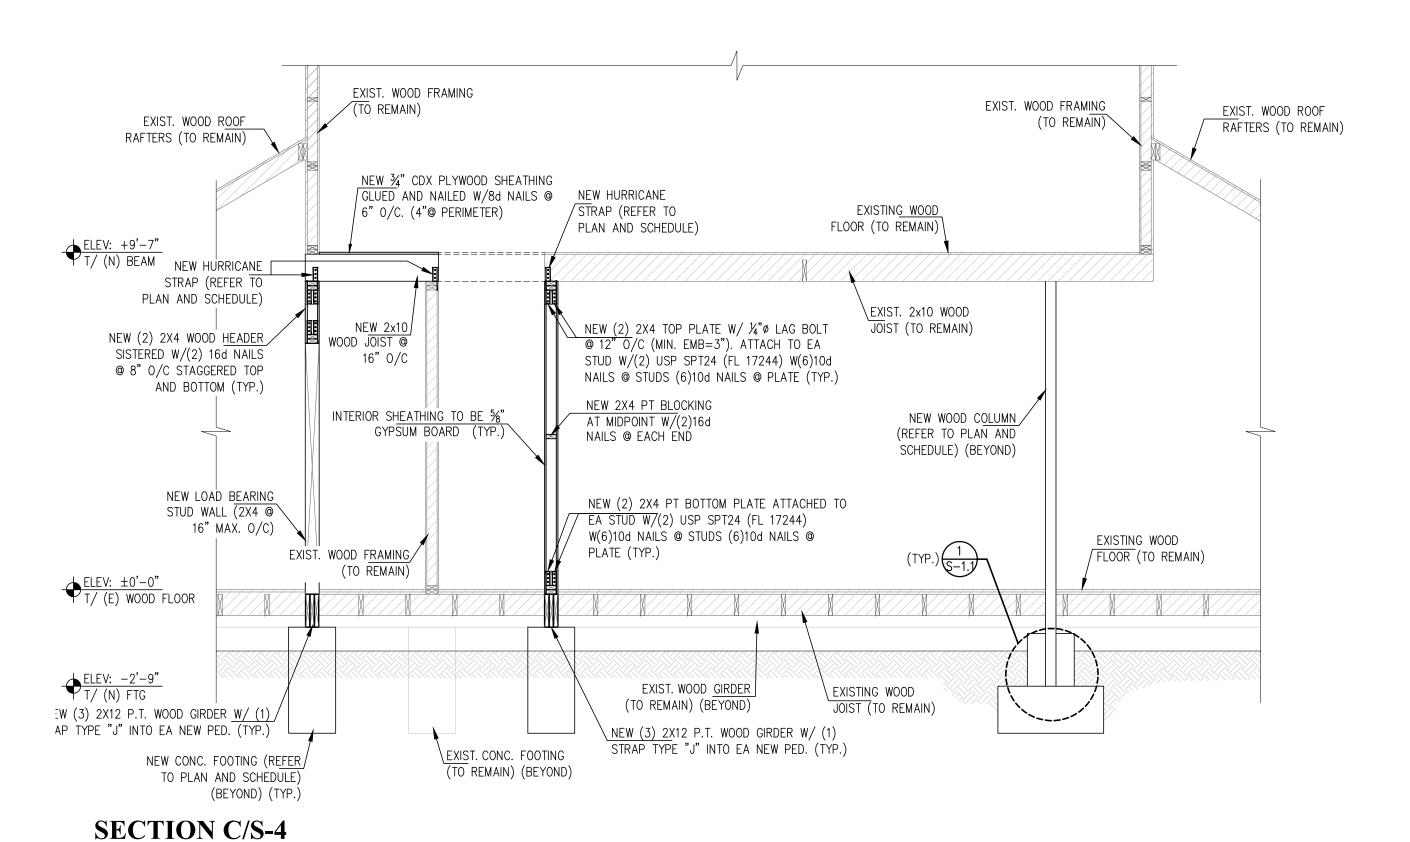

DESIGN IS BASED ON FBC 2020, 7TH EDITION

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LIC #82038

ADDITION & REMODELING FO RESIDENT @

- Jt, 304(

irinnell FL33

Societion # Description Date

BuilDing COMMENTS 06/26/2023

Date | 12 / 15 / 2022

22609 S-4

Scale AS SHOWN

GENERAL ELECTRICAL NOTES

- 1. THE NATURE OF THIS CONTRACT INVOLVES REMODELING OF EXISTING FACILITIES. THE ELECTRICAL CONTRACTOR, PRIOR TO BID, SHALL INSPECT THE EXISTING CONDITIONS AT THE JOB SITE AND ACQUAINT HIMSELF WITH THE CONDITIONS THAT WILL AFFECT HIS WORK.
- 2. WORK SHALL BE PERFORMED TO MEET THE REQUIREMENTS OF THE NATIONAL ELECTRICAL CODE (N.E.C) 2017, FLORIDA BUILDING CODE 2020 7TH EDITION, LOCAL AND STATE CODES AND STANDARDS.
- 3. SHALL COMPLY WITH FLORIDA FIRE PREVENTION CODE 6TH EDITION.
- 4. ALL WIRING SHALL BE COPPER (CU) THWN INSULATION. IF ALUMINUM WIRES ARE USED:
 - A. TO PREVENT OVERHEATING AT CONNECTION POINTS USE OXIDE INHIBITING COMPOUND FOR STRIPPED PORTION OF CONDUCTORS INSIDE CONNECTORS.
 - B. A PREVENTIVE MAINTENANCE PLAN IS NECESSARY TO ENSURE A RELIABLE SERVICE INCLUDING VISUAL INSPECTIONS AND TESTS FOR SPLICES AND CONNECTION POINTS. (CORROSION AND TIGHTNESS PRINCIPALLY). INSPECTION INTERVALS OF 2 YEARS MAXIMUM ARE STRONGLY RECOMMENDED.
- 4. ALL NEW CIRCUIT BREAKERS SHALL BE RATED AT MINIMUM OF 10,000
- 5. PRIOR TO INSTALLATION OF ROUGH ELECTRICAL WIRING, CHECK NAMEPLATE DATA OF ALL EQUIPMENT FOR REQUIRED VOLTAGES, MINIMUM CIRCUIT AMPACITY, AND OVERCURRENT PROTECTION.
- 6. ALL BRANCH CIRCUITS SHALL BE PROPERLY PHASE BALANCED.
- 7. ALL NEW CONDUCTORS SHALL BE RUN IN CONDUIT (METALLIC TYPE)
 UNLESS THAT NONMETALLIC SHEATHED CABLE CAN BE USED IN DRY
 LOCATIONS AS PER NEC 336-6.
- 8. IF PVC CONDUITS ARE USED FOR UNDERGROUND FEEDERS, A GROUNDING CONDUCTOR SIZED IN ACCORDANCE WITH N.E.C. 250–122 MUST BE INSTALLED AND CONDUIT SIZE INCREASED AS REQUIRED.
- 9. TYPEWRITING PANEL TALLY SHALL BE FURNISHED AFTER JOB IS COMPLETED REFLECTING ALL CHANGES AND ADDITIONS FOR NEW CIRCUITS
- 10. RISERS ARE DIAGRAMMATIC ONLY. THEY DO NOT SHOW EVERY BEND REQUIRED FOR THE INSTALLATION. ELECTRICAL CONTRACTOR TO FIND THE BEST POSSIBLE ROUTE FOR ALL CIRCUITS.
- 11. THIS DRAWING IS A GUIDE FOR THE INSTALLATION OF ELECTRICAL SERVICE. THE ELECTRICAL CONTRACTOR IS RESPONSIBLE TO PROVIDE A FUNCTIONING SYSTEM.
- 12. ALL NEW OUTLETS IN ROOMS TO BE PROTECTED BY AFCI BREAKERS,
- 13. ALL ELECTRICAL LIGHTING FIXTURES & RECEPTACLES ARE EXISTING TO REMAIN UNLESS OTHERWISE SPECIFIED.
- 14. ELECTRICAL CONTRACTOR SHALL COORDINATE WITH ARCHITECT/OWNER TO FIELD VERIFY INSTALLATION FOR OUTLETS AND LIGHTING FIXTURES.
- 15. BEFORE INSTALLING FLOOR OUTLETS CONTRACTOR SHALL COORDINATE EXACT LOCATION OF RECEPTACLES / LIGHTING FIXTURES WITH OWNER.
- 16. ROMEX TO BE USED WHERE ALLOWED BY NEC UNLESS

ELECTRICAL DEMOLITION NOTES

- 1. WITHIN THE AREA IDENTIFIED, UNLESS SPECIFICALLY NOTED OTHERWISE, CONTRACTOR SHALL DISCONNECT AND REMOVE ALL EXISTING UNUSED ELECTRICAL EQUIPMENT INCLUDING BUT NOT LIMITED TO LIGHTING FIXTURES, WIRING DEVICES, PANELBOARDS, MOTOR CONNECTIONS AND ASSOCIATED CONTROLS, ETC. REMOVE ALL UNUSED WIRING COMPLETELY INCLUDING CONDUIT AND CONDUCTORS BACK TO POWER SOURCE OR NEXT ACTIVE OUTLET. WHERE CONDUIT IS INACCESSIBLE, REMOVE CONDUCTORS AND CUT BACK CONDUIT FLUSH WITH SLAB OR WALL. PATCH OPENING TO MATCH EXISTING FINISH. WHERE EXISTING WIRING EXTENDS OUTSIDE OF THE AREA BY NATURE OF THE ORIGINAL INSTALLATION, CONTRACTOR SHALL MODIFY EXISTING WIRING AS REQUIRED TO MAINTAIN CONTINUITY OF EXISTING CIRCUITRY SUCH THAT NO EQUIPMENT TO REMAIN IS LEFT WITHOUT SERVICE.
- 2. SALVAGED MATERIALS, EQUIPMENT, AND LIGHT FIXTURES SHALL BE DELIVERED TO THE OWNER AT HIS PROPERTY AND STORED WITHIN THE BUILDING WHERE DIRECTED. ANY REMOVED MATERIALS OR EQUIPMENT WHICH THE OWNER DOES NOT WISH TO KEEP SHALL BE DISPOSED OF BY THE CONTRACTOR, WITHOUT ADDITIONAL COST TO THE OWNER.
- 3. THE CONTRACTOR SHALL VISIT THE SITE AND EXAMINE THE EXISTING CONDITIONS PRIOR TO COMMENCING WORK AND SHALL NOTIFY THE ARCHITECT AND/OR ENGINEER IF A CONDITION EXISTS WHICH PREVENTS HIM FROM ACCOMPLISHING THE WORK INDICATED AND INTENDED BY THESE DRAWINGS.
- 4. PRIOR TO BID, THE EXTENT AND UNDERSTANDING OF THE WORK TO BE PERFORMED SHALL BE CLEARLY ESTABLISHED SUCH THAT NO ADDITIONAL COSTS WILL BE INCURRED BY THE OWNER. ANY WORK, OTHER THAN AS DESCRIBED ON ANY ITEM OR SYSTEMS SHALL BE QUALIFIED WITH THE BID. THESE DRAWINGS REQUIRED TO PROVIDE AND INSTALL
- 5. PRIOR TO COMMENCING WORK, CONTRACTOR SHALL DISCONNECT POWER IN THE DEMOLITION AREA INCLUDING POWER FOR THE LOW-VOLTAGE SYSTEMS SUCH AS FIRE ALARM, CONTROL WIRING, ETC.
- 6. CONTRACTOR SHALL EXERCISE EXTREME CAUTION DURING DEMOLITION WORK. EXISTING FEEDERS AND PANELS ARE SHOWN SCHEMATIC FOR REFERENCE PURPOSES ONLY. CONTRACTOR SHALL VERIFY IN FIELD ROUTING OF ALL EXISTING FEEDERS PRIOR TO DEMOLITION.
- 7. CONTRACTOR SHALL PROVIDE TEMPORARY POWER WHERE REQUIRED DURING DEMOLITION AND CONSTRUCTION SCOPE OF WORK.
- 8. THE ELECTRICAL CONTRACTOR SHALL BE RESPONSIBLE TO COORDINATE THE SERVICE INTERRUPTIONS WITH THE OWNER AND GENERAL CONTRACTOR.

ARC FAULT PROTECTION NOTE

 ALL NEW, EXTENDED OR MODIFIED CIRCUITS SHALL BE AFCI (ARC FAULT CIRCUIT INTERRUPTER) PROTECTION IN ACCORDANCE WITH 2017 EDITION OF THE N.E.C. 210.12b

SMOKE DETECTORS NOTE

• ALL SMOKE DETECTORS SHALL BE 120V WITH BATTERY BACKUP, HARDWIRED AND INTERCONNECTED AND LOCATED 36" MIN. FROM ANY A/C

V.P. FIXTURES NOTE

VAPOR PROOF FIXTURES SHALL COMPLY WITH N.E.C. 410-4 (a) AND SHALL BE MARKED SUITABLE FOR DAMP LOCATIONS.

NOTES

- ALL NEW OUTLETS SHALL BE TAMPER RESISTANCE DEVICES AS PER NEC 2017
 406.12
- OFF THE LAMPS SHALL HAVE AN EFFICACY OF AT LEAST 45 LUMENS WITH OR NOT LESS THAN 65 LUMENS WITH FBC RE R404
- LIGHT FIXTURES FOR CLOTH CLOSETS TO COMPLY WITH NEC 410.1
- NOT LESS THAN 90% OF THE LAMPS SHALL HAVE AN EFFICACY OF AT LEAST 45 LUMENS/W OR NOT LESS THAN 65 LUMENS/W. FBC RE R404

IC RATED NOTE

• RECESSED LUMINAIRES INSTALLED IN THE BUILDING THERMAL ENVELOPE SHALL BE SEALED TO LIMIT AIR LEAKAGE BETWEEN CONDITIONED AND UNCONDITIONED SPACES. ALL RECESSED LUMINAIRES SHALL BE IC—RATED AND LABELED AS HAVING AN AIR LEAKAGE RATE OF NOT MORE THAN 2.0 CFM (0.944 L/S) WHEN TESTED IN ACCORDANCE WITH ASTM E 283 AT A 1.57 PSF (75 PA) PRESSURE DIFFERENTIAL. ALL RECESSED LUMINAIRES SHALL BE SEALED WITH A GASKET OR CAULK BETWEEN THE HOUSING AND INTERIOR WALL OR CEILING COVERING.

ELECTRICAL SCOPE OF WORK

- 1. NEW LIGHTING AND POWER AS PER LAYOUT
- EXISTING ELECTRICAL METER TO REMAIN
 NEW PANEL A
- 4. NEW AIR CONDITIONER SYSTEM AS PER LAYOUT

	LOADCENTER A				
1	RESIDENCE @ 3WATTS/ SF (S.F. X 3W)	1625.0 F2		4.875	KVA
2	2 SMALL APPLIANCE CKT @ 1.5 KVA EA.			3.00	KVA
3	APPLIANCES			26.94	KVA
4	SUBTOTAL			34.82	KVA
5	FIRST 10 KW @ 100%			10.00	KVA
6	REMAINDER @ 40%: 11.17 KW x .40	24.82 KVA		9.93	KVA
7	AC-1 SPLIT SYSTEM			2.80	KVA
8	AC-2 SPLIT SYSTEM			2.80	KVA
9	AC-3 SPLIT SYSTEM			2.80	KVA
10	AC-4 SPLIT SYSTEM			2.80	KVA
11	WATER HEATER			11.00	KVA
12	TOTAL			42.13	KVA
	(TOTAL) x 1,000/240	42.13	1000		
		240		VVV	VV
				175.53	AMPS

	NEW LO	ADCEN	ITER A					120/240/1/60		NEMA 1	
								200 AMP		3W	
								10,000 AIC			
KVA	TRIP POLE	WIRE	DESCRIPTION	СКТ			СКТ	DESCRIPTION	WIRE	TRIP POLE	KVA
2.80	30/2	10	AC-1 SPLIT SYSTEM	3	X	X	2	-COOKTOP #1	10	50/2	9.0
2.80	30/2	10	AC-2 SPLIT SYSTEM	5	X	v	6	SPACE			
2.80	30/2	10	AC-3 SPLIT SYSTEM	9	X	X	10	**SMALL APLIANCES	12	20/1	1.5
1000		12.3		11	X	X	12 14	**SMALL APLIANCES **DISHWASHER	12	20/1	1.5
2.80	30/2	10	AC-4 SPLIT SYSTEM	15		X	16	**DISPOSAL	12	20/1	1.0
241	20/1	12	*GREAT ROOM LIGHTS & RECEPTACLES	17	X		18	**MICROWAVE	12	20/1	1.0
191	20/1	12	*DINING ROOM LIGHTS	19		X	20	**REFRIGERATOR #1	12	20/1	0.8
141	20/1	12	*DINING ROOM RECEPTACLES	21	X		22	*KITCHEN LIGHTS	12	20/1	-
12	20/1	12	*EXTERIOR/BALCONY LIGHTS	23		X	24	*BEDROON 1 LIGHTS & RECEPTACLES	12	20/1	4
-	20/1	12	**EXTERIOR WP GFI RECEPTACLES	25	X		26	*BEDROON 2 LIGHTS & RECEPTACLES	12	20/1	1 2
7-1	20/1	12	**LAUNDRY/HALL RECEPTACLE	27		X	28	*BEDROON 3 LIGHTS & RECEPTACLES	12	20/1	-
151	20/1	12	*LAUNDRY/HALL LIGHTS	29	X		30	**BATH GFI RECEPTACLES	12	20/1	-
11.00	60/2	6	WATER HEATER	31		X	32	*BATH LIGHTS	12	20/1	-
	~~~	~~	mmm	33	X		34	*KITCHEN HOOD	12	20/1	1.0
0.87	20/1	12	**U.C. REFRI #2	35)		X	36	SPACE			
1.00	20/1	12	**WASHER#2	37	X		38	**WASHER #1	12	20/1	1.0
5.00	30/2	10	DRYER #2	39 41	X	X	40 42	DRYER #1	10	30/2	5.0
	MAIN DISC	200 AMP	s					*ARC FAULT CIRCUIT			
	FEDEER							**ARC FAULT + GFI CIRCUIT			

ELECTRICAL LEGEND					
SYMBOL	DESCRIPTION	SYMBOL	DESCRIPTION		
<del>-</del>	DUPLEX RECEPTACLE	Ю	SCONCE LIGHT FIXTURE		
0	SINGLE RECEPTACLE	<del>+</del>	CEILING MOUNTED LIGHT FIXTURE		
<b>-</b> ©:	GFI RECEPTACLE	(JB)	JUNCTION BOX		
	ELECTRICAL LOADCENTER	N	(BOLD) DENOTES NEW		
(Sp)	SMOKE DETECTOR	E	(LIGHT) DENOTES EXISTING		
\$	SWITCH	EL	EXISTING TO BE LEGALIZED		
\$3	THREE WAY SWITCH	•	DATA		
0	RECESSED NEW LIGHT FIXTURE	~	EXHAUST FAN.		



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MASOOD HAJALI P.E
LIC #82038

# ADDITION & REMODELING FO RESIDENT @ 1215 Grinnell St,

		Date	05/11/2023				
		Description	BUILDING COMMENTS				
7		Revision #	$\sqrt{2}$				
-				 _	 		

DESIGN IS BASED ON FBC 2020, 7TH E


ELECTRICAL GENERAL NOTES

Date 01/25/2023
Project Number 22609


Sheet
E- |
Scale Drawn By

As Shown

JLO

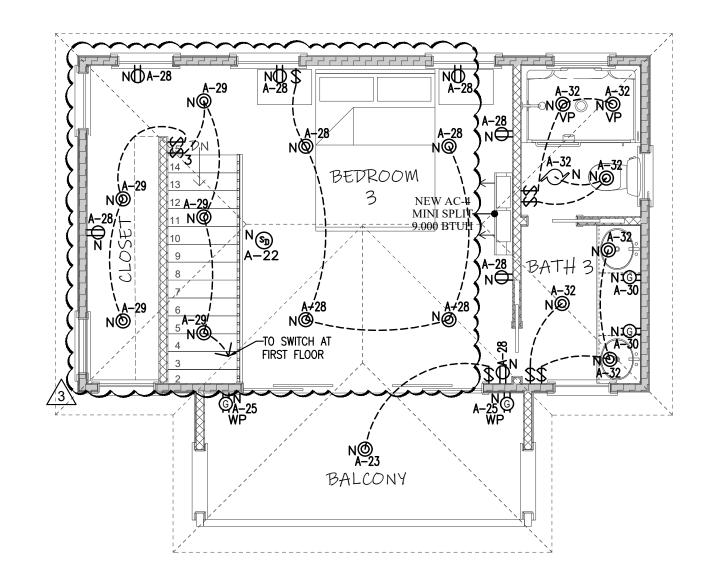



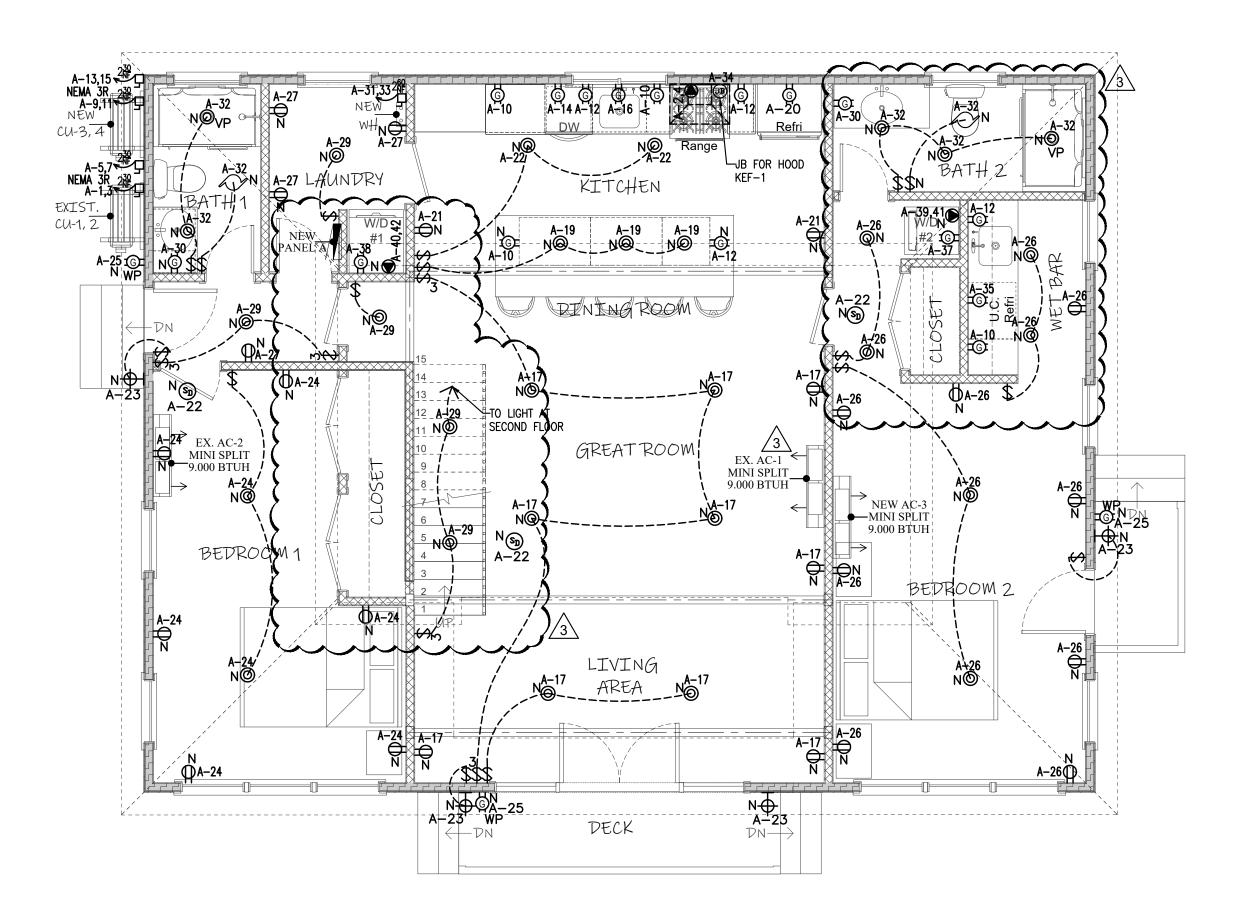

1 | ELECTRICAL 1st FLOOR PLAN | SCALE 1/4"=1'-0"



# Calc Engineering

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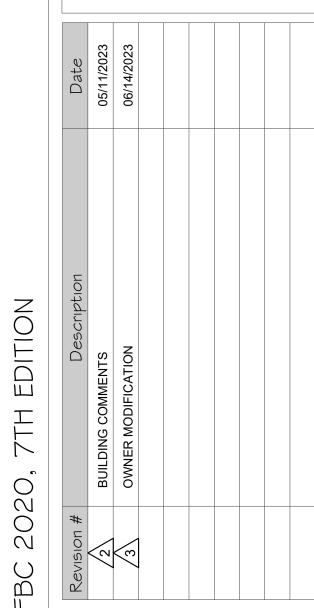
ENGINEERING BUSINESS

CA CERTIFICATION: 32566

MASOOD HAJALI P.E

LIC #82038

# ADDITION & REMODELING FOR RESIDENT @ 1215 Grinnell St,



# Dat

ELECTRICAL
FLOOR PLAN

Date 01/25/2023

Project Number 22609

Sheet

E-2

Scale Drawn By
As Shown JLO

DESIGN IS BASED ON FBC

# **AIR-CONDITIONING GENERAL NOTES**

- 1. THE ABBREVIATION "A.C." USED HENCEFORTH IN THIS GENERAL AIR CONDITIONING SPECIFICATION SHALL BE CONSTRUED TO MEAN AIR CONDITIONING CONTRACTOR.
- 2. THE "GENERAL CONDITIONS OF THE CONTRACT", CURRENT EDITION, PUBLISHED IN STANDARD FROM BY THE AMERICAN INSTITUTE OF ARCHITECTS SHALL BE PART OF THIS CONTRACT.
- 3. ALL WORK AND MATERIALS SHALL BE IN FULL ACCORDANCE WITH OSHA AND ALL STATE AND LOCAL CODES THAT APPLY.
- 4. THE A.C. SHALL CHECK ALL EQUIPMENT FOR CORRECT VOLTAGE RATING BEFORE INSTALLATION.
- 5. THE A.C. SHALL TAKE OUT PERMITS, PROCURE CERTIFICATES, AND PAY ALL FEES ASSOCIATED WITH THE WORK. HE SHALL ALSO BE RESPONSIBLE FOR MAKING ALL INSPECTIONS AND TESTS.
- 6. THE DRAWINGS ARE DIAGRAMMATIC AND ARE INTENDED TO SHOW APPROXIMATE LOCATIONS. THE A.C. SHALL NOT SCALE THE DRAWINGS.
- 7. BIDDERS SHALL VISIT THE SITE AND FAMILIARIZE THEMSELVES WITH ALL CONDITIONS INVOLVING THE WORK.
- 8. IT SHALL BE THE RESPONSIBILITY OF THE A.C. FOR THE ADVANCE ORDERING OF LONG LEAD ITEMS SO AS NOT TO DELAY OTHER TRADES RESULTING IN ANY DOWN OR LAG TIME.
- 9. THE G.C. SHALL FURNISH ALL EQUIPMENT, LABOR, MATERIALS AND SUPERVISION TO INSTALL A COMPLETE AND PROPERLY OPERATING AIR-CONDITIONING SYSTEM AS DESCRIBED HEREIN AND AS SHOWN AND/OR NOTED ON THE DRAWINGS.
- 10. THE A.C. SHALL FURNISH AND INSTALL ALL MINOR ITEMS WHICH ARE OBVIOUSLY AND REASONABLE NECESSARY TO COMPLETE THE INSTALLATION WHETHER OR NOT SPECIFIED AS SHOWN ON THE PLANS.
- 11. THE A.C. SHALL BE A LICENSED MECHANICAL CONTRACTOR.
- 12. THE A.C. IS REFERRED TO THE ARCHITECTURAL, FIRE PROTECTION PLANS AND SPECIFICATIONS. SUCH PLANS AND SPECIFICATIONS ARE CONTRACT DOCUMENTS. VERIFY ALL REQUIREMENTS PRIOR TO INSTALLATION.
- 13. THE A.C. SHALL EXAMINE THESE SPECIFICATIONS AND THE WHOLE CONTRACT BY SECURING A COMPLETE SET OF DRAWINGS OF THE WHOLE CONTRACT.
- 14. THE A.C. SHALL BE RESPONSIBLE FOR THE FULL COORDINATION OF HIS WORK WITH THAT OF THE GENERAL CONTRACTOR AND OTHER SUBCONTRACTORS TO MUTUALLY AVOID CONFLICT.
- 15. THE A.C. SHALL BE RESPONSIBLE FOR VERIFICATION OF CEILING CONSTRUCTION BEFORE INSTALLING DIFFUSERS.
- 16. ALL AIR CONDITIONING WORK SHALL NOT INTERFERE WITH CLEARANCES REQUIRED FOR GENERAL AND MECHANICAL CONSTRUCTION. SHOULD AIR CONDITIONING WORK BE INSTALLED WHICH INTERFERES WITH THE WORK OF OTHER CONTRACTORS, SUCH WORK SHALL BE CHANGED AT NO ADDITIONAL COST TO THE OWNER.
- 17. THE A.C. SHALL VERIFY ALL NOTES AND DIMENSIONS PRIOR TO PROCEEDING WITH BID. ANY DISCREPANCIES SHALL BE BROUGHT TO THE ATTENTION OF THE ARCHITECT.
- 18. THE A.C. SHALL SUBMIT REQUESTS FOR SUBSTITUTIONS IN WRITING.
- 19. THE A.C. SHALL TOUCH UP OR REFINISH THE FACTORY FINISH OF EQUIPMENT MARRED DURING SHIPMENT OR INSTALLATION. THE IS RESPONSIBLE TO REPAIR TO ORIGINAL CONDITION ANY AND ALL DAMAGES TO BUILDING SURFACES, EQUIPMENT, AND FURNISHINGS CAUSED DURING PERFORMANCE OR WORK.
- 20. THE A.C. SHALL FURNISH AND INSTALL DISCONNECT SWITCHES, WIRING AND CONNECTIONS ON AIR-CONDITIONING SYSTEM AS SHOWN ON PLANS. MOTOR STARTERS AND CONTROLS ARE TO BE SUPPLIED BY A.C. CONTRACTOR AND CONNECTED BY ELECTRICAL CONTRACTOR. CONTROL WIRING SHALL BE PROVIDED BY THE ELECTRICAL CON TRACTOR.
- 21. ALL PENETRATIONS SHALL BE PROPERLY FLASHED AND SEALED BY THE GENERAL CONTRACTOR.
- 22. NO CONDUITS OR PIPES ARE TO BE RUN IN DUCTWORK.
- 23. THE ELECTRICAL CONTRACTOR IS RESPONSIBLE TO PROVIDE TYPE WRITTEN PANEL SCHEDULES FOR ALL PANELS. THE A.C. SHALL COORDINATE WITH THE ELECTRICAL CONTRACTOR IN ORDER THAT THE SAME NOMENCLATURE IS USED AS PROVIDED ON THE A/C PLANS.
- 24. ALL MATERIALS SHALL BE NEW, OF AMERICAN MANUFACTURE, AND IN COMPLIANCE WITH UNDERWRITERS LABORATORIES OR OTHER RECOGNIZED TESTING AGENCY, UNLESS SPECIFIED OTHERWISE.
- 25. THE A.C. SHALL BE RESPONSIBLE FOR ANY DAMAGE TO MECHANICAL EQUIPMENT DUE TO REMOVAL OR INSTALLATION OF ANY WORK.
- 26. ALL STRUCTURAL CUTTING AND PATCHING SHALL BE DONE BY THE GENERAL CONTRACTOR.

1. F)	KTERIOR WALL:
,	WOOD FRAMING EXTERIOR WALL INSULATION R-11
2. R	00F:
	WOOD TRUSSES, INSULATION BELLOW ROOF R-30

# **CLEAN-UP NOTES**

- 1. CLEAN UP OF SITE: UPON COMPLETION OF THE PROPOSED WORK, THE PERMIT HOLDER SHALL LEAVE THE SITE CLEARED OF RUBBISH, DEBRIS, CONSTRUCTION SHEDS OR MATERIALS OF CONSTRUCTION. IN THE EVENT THERE HAS BEEN DAMAGE TO PUBLIC PROPERTY OR THAT RUBBISH, DEBRIS, CONSTRUCTION SHEDS OR MATERIALS OF CONSTRUCTION HAVE BEEN LEFT AT THE SITE, THEN THE BUILDING OFFICIAL SHALL REFUSE TO MAKE FINAL INSPECTION AND SHALL NOTIFY THE PERMIT HOLDER TO CORRECT THE CONDITION OF VIOLATION WITHIN FIVE DAYS. FOR FAILURE TO COMPLY WITH SUCH NOTICE AFTER SUCH PERIOD OF FIVE DAYS, THE PERMIT HOLDER IS SUBJECT TO THE PENALTIES SPECIFIED BY THE DADE COUNTY CODE, AND THE BUILDING OFFICIAL SHALL HAVE THE CLEAN-UP NOTES: WORK DONE AND PUBLIC PROPERTY RESTORED AND SHALL NOTIFY THE 1. R = W/2LEGAL AUTHORITIES, WHO SHALL INSTITUTE THE NECESSARY ACTION TO 2. HAVE THE COSTS PLACED AS A LIEN AGAINST THE PROPERTY IN RELATION 3. DEPTH OF DUCT SHALL INCREASE TO WHICH THE PERMIT WAS ISSUED.
- 2. THE A.C. SHALL KEEP ALL AREAS IN WHICH WORK IS BEING PERFORMED 5. FREE FROM DEBRIS AT ALL TIMES, AND SAID AREA SHALL BE LEFT BROOM CLEAN AT THE END OF EACH WORKING DAY.
- 3. AT THE COMPLETION OF THE WORD, THE A.C. SHALL REMOVE ALL RUBBISH CAUSED BY HIS WORK, AND SHALL THOROUGHLY CLEAN ALL FIRE PROTECTION EQUIPMENT.

# **GUARANTEE**

- 1. ALL WORK, MATERIAL ETC. SHALL BE FULLY GUARANTEED FOR (1) YEAR BY THE A.C. CONTRACTOR. THE 1 YEAR PERIOD SHALL COMMENCE AFTER FINAL APPROVAL BY THE ARCHITECT/ENGINEER.
- 2. THE A.C. SHALL FURNISH A WRITTEN GUARANTEE COVERING A ONE (1) YEAR PERIOD FOR ALL EQUIPMENT AND AN ADDITIONAL FOUR (4) YEAR PERIOD FOR THE COMPRESSORS.

# MECHANICAL SCOPE OF WORK

- 1. EX. AIR CONDITIONING SYSTEM #1, 2
- 2. NEW AIR CONDITIONING SYSTEM #3 & 4
- 3. NEW EXHAUST FANS IN BATH
- 4. NEW DRYER VENT PIPE AS PER LAYOUT
- 5. NEW COOKTOP HOOD

Auto-Restart

Line Length

Auto Oscillation


Dehumidifier Mode

Refrigerant Connection Type | Flare

# ANGLE RIVETED OR SPOT STANDARD DUCT MADE WELDED AS REQUIRED WATER TIGHT METAL SCREEN FRAME 1/2" SCREEN —— X = DUCT SIZE + 25%FLASHING ----12" MIN. ROOFING ——— ROOF DECK ----SEAL ALL JOINTS. 6" FOR EACH ADDITIONAL 4" DIA. EXIST. ROOF JOIST EXHAUST DUCT. 4. W = WIDTH OF SPECIFIED DUCT. ATTACH CURB TO STEEL ANGLES & PREFAB ROOF CURB TOP CHORD STEEL JOIST W/ 3/8" 4" CANT STRIP CARRIAGE BOLTS AT EACH CORNER. **GOOSENECK DETAIL (TYP.)** D M-1 N.T.S.

LEGEND			
	REFRIGERANT LINE		
CD	CONDENSATE LINE		
	ROUND DUCT		
0	ROUND DUCT UP		
С	ROUND DUCT DOWN		

		Fan Schedule					
AIR CONDITIONING & HEAT PUMP SYS	STEMS	Mark	EF-	-			
Power Supply	220-240v, 60Hz		Service	Exhaust			
Max Cooling Wattage	1,087 Watts		Area Served	Bathroom			
Max Heating Wattage	1,100 Watts	DESCRIPTION	Design Manufacturer	Greenheck			
Rated Cooling Capacity	9,000 BTU		Model #	SP-B70			
Energy Efficiency Ratio	11.5 (18 Seasonal)		Mounting Type	Inline Cabinet			
Rated Heating Capacity	10,000 BTU		<u> </u>				
SEER	21.5		Fan Weight	9.00 lbs.			
Heating HSPF	10	Fan	Total CFM	70			
Refrigerant Type	R410a		Total Ext. Stat. Pr	1/4			
Factory Precharge	16ft.		Dive Type	Direct			
Suitable Area	400 sq.ft		Motor Capacity	N/A			
Wifi Capable	Yes		Watts	45.1			
Indoor Unit Data	AC-1, 2, 3, 4		Electric Service	120/1/60			
Model	WS009GMFI20HLD		Fan RPM	675			
Max Air Flow	247 CFM		Sound Level (Sones)	0.4			
Sound Level	24.5db min. 39db max.		Backdraft Damper	Yes			
Net Dimensions (WxDxH)	28.5" x 7.3" x 11.3"		Brid Screen	Yes			
Fan Only Mode	Yes	Accesories					
Fan Speeds	3		Service Switch	Yes			
Weight	16.5lbs.		Firestat	No			
Outdoor Unit Data	CU-1, 2, 3, 4		Notes:				
Model	YN009GMFI20RPD	1	Fan shall be rated	for air and sound			
Sound Level	56db	2	SSSC Solid State	e Speed Control			
Net Dimensions (WxDxH)	30.3" x 11.8 x 21.8"						
Mounting Type	Wall						
Net /Gross Weight	67lbs.		Г	– CEILING METAL FRAMING			
Remote Control	Yes	MOUNTING FLANGE					
Programmable Timer	Yes						
			\ <u>\</u>	<u> </u>			

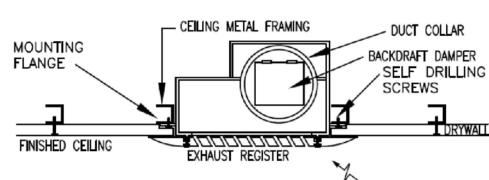

# DUCT CONSTRUCTION MINIMUM SHEET METAL THICKNESS FOR SINGLE


DWELLING UNITS^a

TABLE M1601.1.1

80ft.

	STATIC PRESSURE						
ROUND DUCT DIAMETER	1/2 inch w	ater gage	1 inch water gage Thickness (inches)				
(inches)	Thickness	(inches)					
	Galvanized	Aluminum	Galvanized	Aluminum			
<12	0.013	0.018	0.013	0.018			
12 to 14	0.013	0.018	0.016	0.023			
15 to 17	0.016	0.023	0.019	0.027			
18	0.016	0.023	0.024	0.034			
19 to 20	0.019	0.027	0.024	0.034			

N.T.S.			M-1
TYPICAL	EXHAUST FAN	DETAIL	C
FINISHED CEILING	EXHAUST REGISTER	7x	

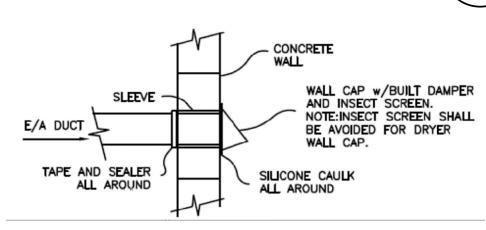

# **WALL CAP MOUNTING DETAIL** N.T.S.



# **Universal Bracket**

N.T.S.

WBB500 Wall Bracket Product Code 87735

3" to 31"

500 lbs

RECTORSEAL

A CSW Industrials Company

Min/Max Mounting Width:

Max Load Capacity:

A CSW Industrials Company			
(Sec. II) Product Specifications:		(Sec. I) Ordering Info	rmation:
Sheet Gauge: Class of Galvanized Sheet: Type of Stainless Steel:	14 gauge GALVALUME N/A	Product Code Model	87735 WBB50
Load Rated Safety Factor: Testing Load Rating to a Specific	3	Carton Qty Carton Weight	1 13 lbs
Testing Method: Seismic Approval:	Yes No	(Sec. III) Carton Conte	ents:
Hurricane Approval: Type of Rubber Used for Isolator: UV Resistant:	No TPE rubber Yes	2 x Bracket Arm 1 x Crossbar 6 x Hex Lag Screw	
Powder Coating: Color of Powder Coating:	Yes Beige	6 x 10 mm Concrete A 4 x 1" Bolt and Clip N	
Overall Length: Overall Height: Overall Depth:	33.50" 17.75" 26.57"	1 x Liquid Level 2 x M6*16 Philip Head 1 x Installation Instru	
Min/Max Mounting Depth:	10 3/8" to 19.5"	1 A moderation motion	COOL

# NOA 21-1012.03

A/C COMPRESSOR MUST BE ABOVE THE MINIMUM

ELEVATION REQUIRED AS PER CHAPTER 11C-5(f)(4)

-3/8" Ø TURN BUCKLE

WITH FMC 3031.13

CONDENSER WALL MOUNTED

—BRACKET SYSTEM.


NOA 21-1012.03

**OUTDOOR MINI SPLIT UNIT CU-4 MTD DETAIL** 

SECURE CONDENSING UNITS TO RESIST HURRICANE


CABLE AND FASTENING TO STRUCTURE TO COMPLY


WIND FORCE BY CROSS WRAPPING WITH 1/8" STEEL

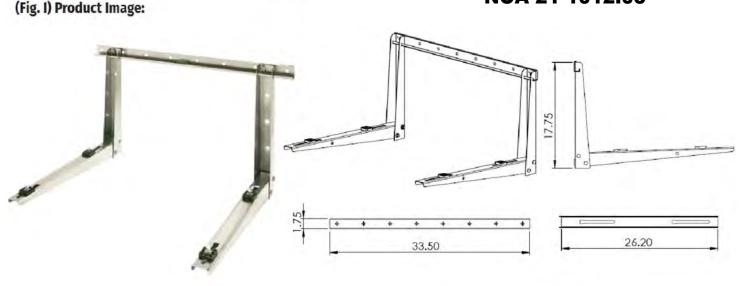

2 CONDENSER CU-5 - WALL MOUNTED DETAIL

N.T.S

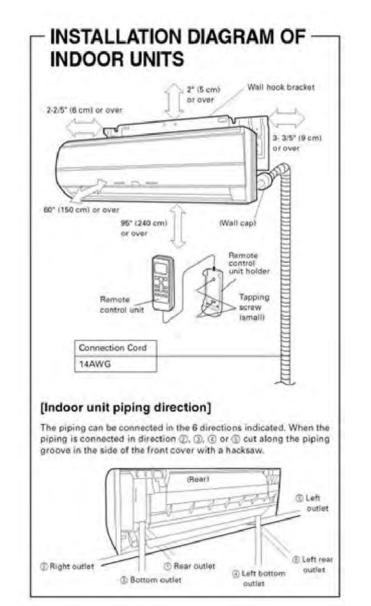

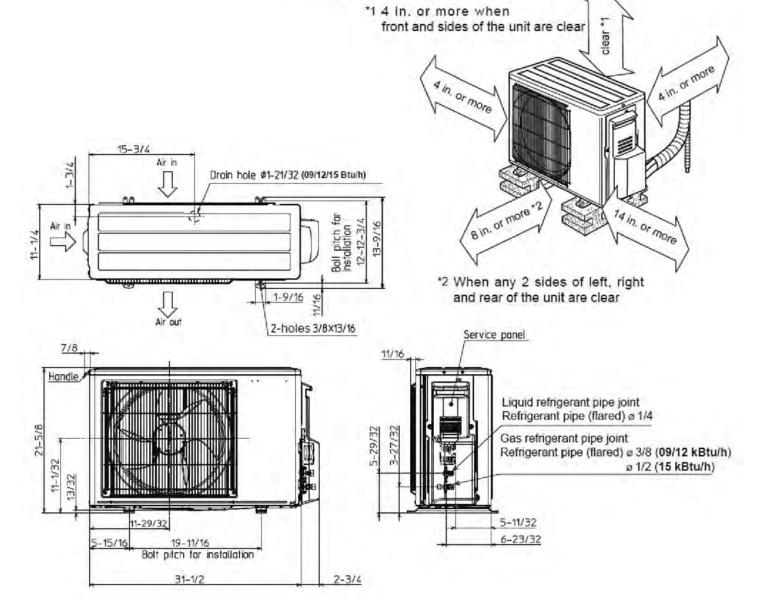

REQUIRED SPACE

NOTES:

STEEL STAND MTD-

G

**∖M-1** 

NGLE-ZONE

One outdoor unit

connects to one

indoor unit

**SECTION** 

RECEPTACLES.

4. ALL HARDWARE SHALL BE GALVANIZED

WRAP WIRE ROPE AROUND CONDENSING UNIT IN TWO DIRECTIONS.

SEE ELECTRICAL DRAWINGS FOR DISCONNECT SWITCH & DUPLEX

—FOOT INTEGRATED CLIPS

-3/8" DIA THRUBOLT SS 316 WITH

NUT AND WASHER, PER CLIP, TYP.

AS PER TECHNICAL REPORT

TER 21-38260


2. SEE MECHANICAL SITE PLAN FOR EQUIPMENT LAYOUT.

Calc

Engineering CALC ENGINEERING

www.calceng.com 2000 NW 89th PL. Unit 102 DORAL, FL 33172 Phone: (305) 898-9995 ENGINEERING BUSINESS CA CERTIFICATION: 32566 MASOOD HAJALI P.E LIC #82038

> REMODELING SIDENT @ AD

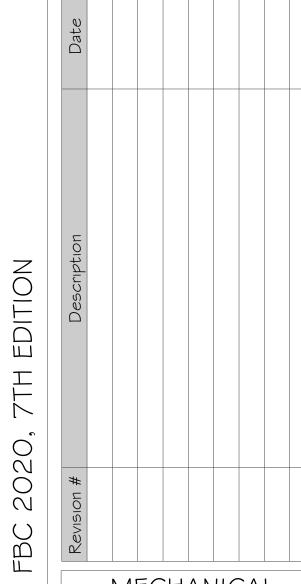

MECHANICAL FLOOR PLAN 01/25/2023

Project Number 22609 Sheet

ASED

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ESIGN M-1 Scale Drawn By


As Shown

JLO

MINI SPLIT INDOOR INSTALLATION DETAIL

# SAMSUNG NK30R5000W

30" Range Hood

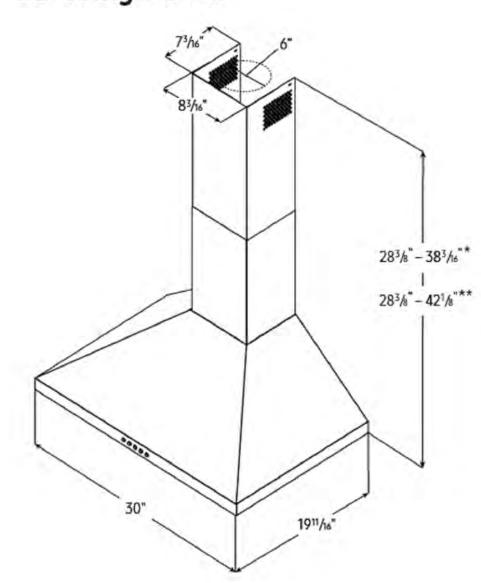

# KEF-1

**Total Power** 

Power Source 120V / 60 Hz / 15A

# Range Hood


- 30" Stainless Steel Chimney Hood
- Vent Fan: 390 CFM • Front-Centered, Mechanical Controls
- 3 Fan Speeds
- 70 dBA (7.0 sones) Noise Level
- Removable Filters
- LED Lighting

# Warranty

283/6" - 421/6"** One (1) Year All Parts and Labor

Product Dimensions & Weight (WxHxD)

Outside (Max) Hood Dimensions: 30" x 283/8" x 1911/16" Weight: 25.4 lbs

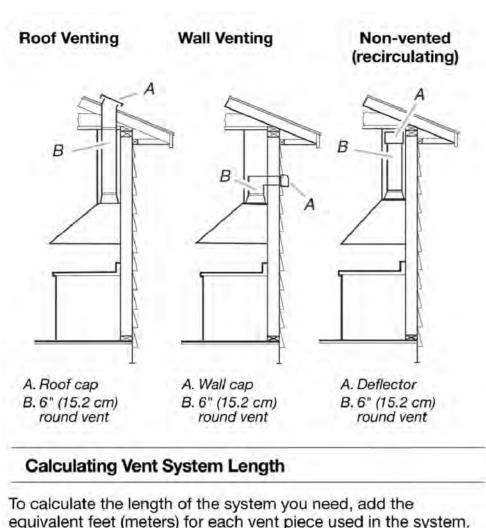



o calculate the length of the system you need, add the		
quivalent feet (meters) Vent Piece	for each vent piece used 6" (15.2 cm) F	
45° elbow	2.5 ft (0.8 m)	
90° elbow	5.0 ft	â

Maximum equivalent vent length is 35 ft (10.7 m).


# **ISLAND KITCHEN HOOD MOUNTING DTL**

N.T.S.

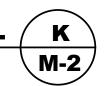

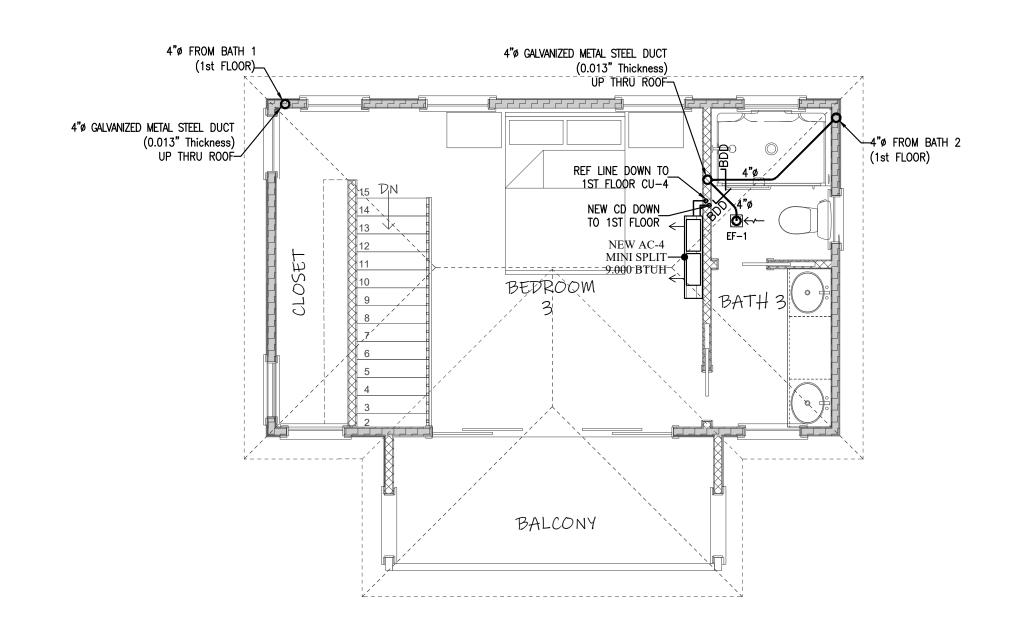

# 1 MECHANICAL 2nd FLOOR PLAN | SCALE 1/4"=1'-0"

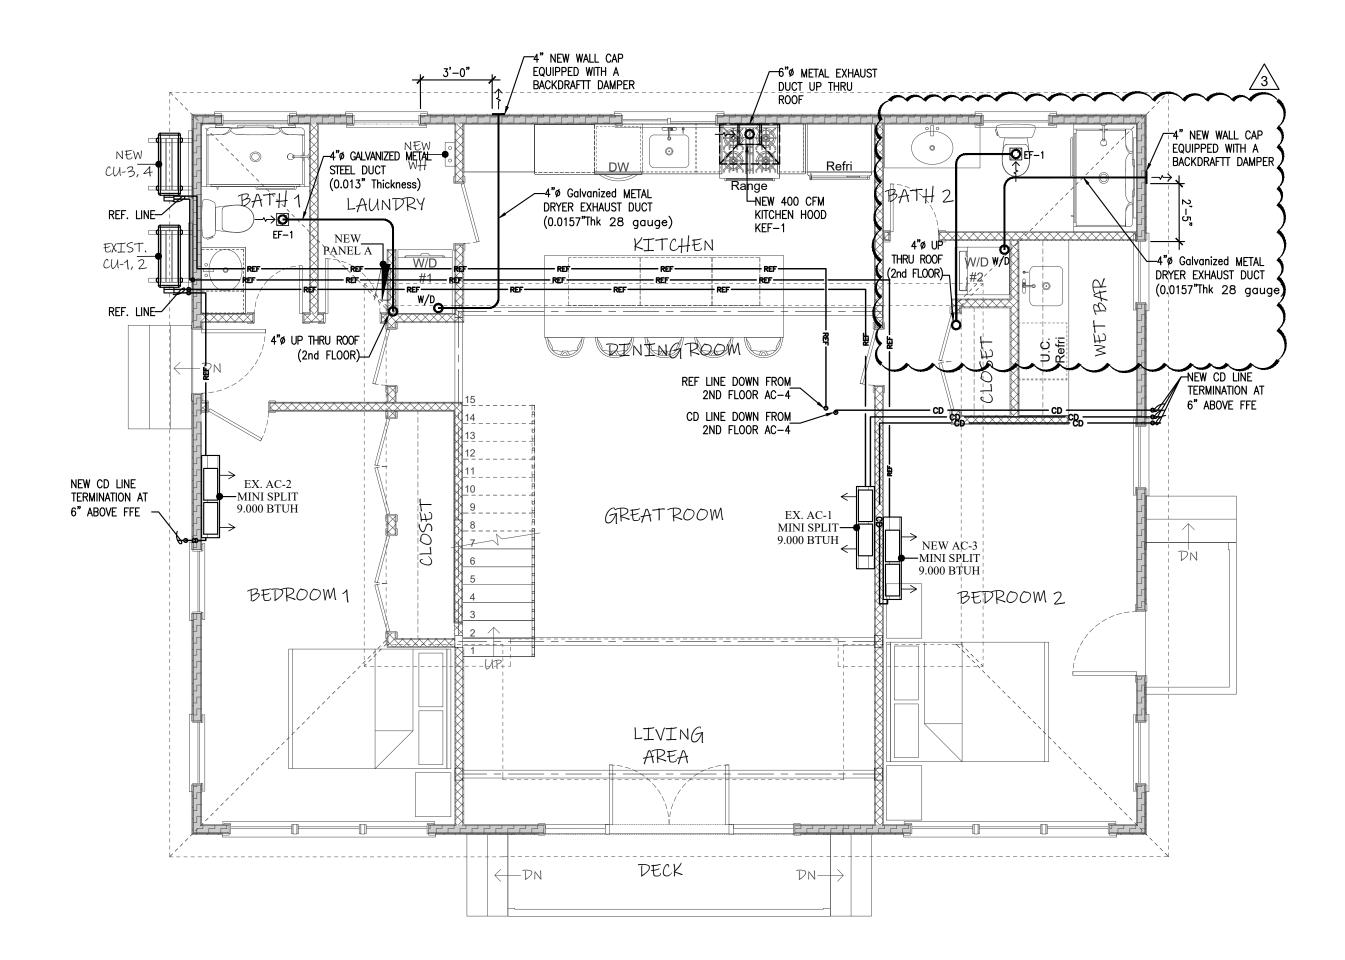






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# REMODELING F SIDENT @ ADDI



- 11					
ON	MECHANICAL FLOOR PLAN				
SED	Date	01/25/2023			
S BAS		ect Number 22609			
ESIGNI	Sheet	M-2			
Ę(	Scale	Drawn By			
ш	As Shown	ПО			

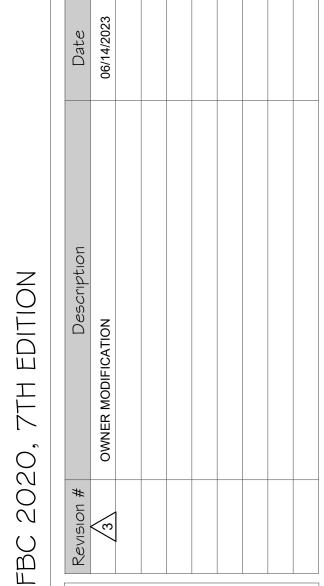As Shown

# PLUMBING GENERAL NOTES

- 1. THE ABBREVIATION "P.C." USED HENCEFORTH IN THIS GENERAL PLUMBING SPECIFICATION SHALL BE CONSTRUED TO MEAN PLUMBING CONTRACTOR ON THE MECHANICAL, ELECTRICAL AND FIRE PROTECTION DRAWINGS.
- 2. ALL WORK AND MATERIALS SHALL BE IN FULL ACCORDANCE WITH THE FLORIDA BUILDING CODE 2017, OSHA, AND ALL STATE AND LOCAL CODES
- 3. THE P.C. SHALL PAY PARTICULAR ATTENTION TO THE STATE OF FLORIDA "ENERGY EFFICIENCY CODE FOR BUILDING CONSTRUCTION". ALL WORK SHALL BE IN ACCORDANCE WITH THIS CODE, CHAPTER 5, SECTIONS 504.1, 504.2, 504.3, 504,4 AND 504.5.
- 4. THE P.C. SHALL TAKE OUT ALL PERMITS, PROCURE CERTIFICATES, AND PAY ALL FEES ASSOCIATED WITH HIS WORK.
- 5. THE DRAWINGS ARE DIAGRAMMATIC AND INTENDED TO SHOW APPROXIMATE LOCATIONS. THE P.C. SHALL NOT SCALE THE DRAWINGS.
- 6. THE BIDDERS SHALL VISIT THE SITE AND FAMILIARIZE THEMSELVES WITH ALL CONDITIONS ASSOCIATED WITH THE WORK.
- 7. IT SHALL BE THE RESPONSIBILITY OF THE P.C. FOR THE ADVANCE ORDERING OF LONG LEAD ITEMS SO AS NOT TO DELAY OTHER TRADES RESULTING IN ANY DOWN OR LAG TIME.
- 8. THE P.C. SHALL FURNISH ALL EQUIPMENT, LABOR, MATERIALS, AND SUPERVISION TO INSTALL A COMPLETE AND PROPERLY OPERATING PLUMBING SYSTEM AS DESCRIBED HEREIN AND AS SHOWN AND/OR NOTED ON THE DRAWINGS.
- 9. THE P.C. SHALL FURNISH AND INSTALL ALL MINOR ITEMS WHICH ARE OBVIOUSLY AND REASONABLY NECESSARY TO COMPLETE THE INSTALLATION WHETHER OR NOT SPECIFIED OR SHOWN ON THE PLANS.
- 10. THE P.C. SHALL BE A LICENSED MASTER PLUMBER.
- 11. WORKMANSHIP SHALL BE FIRST CLASS AS NORMALLY PERFORMED BY JOURNEYMAN PLUMBERS.
- 12. THE P.C. IS REFERRED TO THE ARCHITECTURAL, ELECTRICAL, AND MECHANICAL PLANS AND SPECIFICATIONS. SUCH PLANS AND SPECIFICATIONS ARE CONTRACT DOCUMENTS. VERIFY ALL REQUIREMENTS PRIOR TO INSTALLATION. ANY DISCREPANCIES IN THE DRAWINGS OR FIELD COORDINATION PROBLEMS SHALL BE BROUGHT TO THE ATTENTION OF THE ENGINEER PRIOR TO COMMENCEMENT OF WORK.
- 13. THE P.C. SHALL EXAMINE THE SPECIFICATIONS AND THE WHOLE CONTRACT BY SECURING A COMPLETE SET OF DRAWINGS AND SPECIFICATIONS OF THE WHOLE CONTRACT.
- 14. THE P.C. SHALL BE RESPONSIBLE FOR THE FULL COORDINATION OF HIS WORK WITH THAT OF THE GENERAL CONTRACTOR AND OTHER SUBCONTRACTORS TO MUTUALLY AVOID CONFLICT.
- 15. ALL PLUMBING WORK SHALL NOT INTERFERE WITH CLEARANCES REQUIRED FOR GENERAL AND MECHANICAL CONSTRUCTION. SHOULD PLUMBING WORK BE INSTALLED WHICH INTERFERES WITH THE WORK OF THE OTHER CONTRACTORS, SUCH WORK SHALL BE CHANGED AT NO ADDITIONAL COST TO THE OWNER.
- 16. THE P.C. SHALL VERIFY ALL NOTES AND DIMENSIONS PRIOR TO PROCEEDING WITH BID. ANY DISCREPANCIES SHALL BE BROUGHT TO THE ATTENTION OF THE ARCHITECT/ENGINEER.
- 17. THE P.C. SHALL PROVIDE SHOP DRAWINGS FOR APPROVAL PRIOR TO PURCHASE OR INSTALLATION OF ALL EQUIPMENT CALLED FOR IN THE PLANS OR SPECIFICATIONS.
- 18. THE P.C. SHALL SUBMIT REQUESTS FOR SUBSTITUTIONS IN WRITING.
- 19. THE P.C. SHALL PROVIDE AS-BUILT DRAWINGS.
- 20. THE PLUMBING INSTALLATION SHALL MEET THE APPROVAL OF THE ARCHITECT/ENGINEER BEFORE ACCEPTANCE BY THE OWNER.
- 21. ALL WORK SHALL BE GUARANTEED FREE FROM DEFECTS FOR A PERIOD OF ONE (1) YEAR FROM DATE OF CERTIFICATE OF OCCUPANCY.
- 22. THE P.C. SHALL TOUCH UP OR REFINISH THE FACTORY FINISH TO ORIGINAL CONDITION OF EQUIPMENT MARRED DURING SHIPMENT OR INSTALLATION. HE IS RESPONSIBLE TO REPAIR TO ORIGINAL CONDITION FURNISHINGS CAUSED DURING PERFORMANCE OF WORK.
- 23. THE P.C. SHALL KEEP ALL AREAS IN WHICH WORK IS BEING PER-FORMED FREE FROM DEBRIS AT ALL TIMES, AND SAID AREA SHALL BE LEFT BROOM CLEAN AT THE END OF EACH WORKING DAY.
- 24. AT THE COMPLETION OF THE WORK, THE P.C. SHALL REMOVE ALL RUBBISH CAUSED BY HIS WORK, AND SHALL THOROUGHLY CLEAN ALL PLUMBING EQUIPMENT.
- 25. THE P.C. SHALL VERIFY ALL EXISTING CONDITIONS ASSOCIATED WITH WORK AND REPORT ANY DISCREPANCIES TO ARCHITECT/ENGINEER PRIOR TO BID.
- 26. CONTRACTOR SHALL VERIFY ALL DIMENSIONS, SPACES AND CONDITIONS PRIOR TO FABRICATION AND INSTALLATION OF EQUIPMENT AND MATERIAL.
- 27. A MINIMUM OF 20" IS REQUIRED BETWEEN ANY TWO ITEMS PENETRATING THE ROOF DECK.
- 28. DIELECTRIC UNIONS SHALL BE PROVIDED WHEREVER DISSIMILAR METALS ARE JOINED.
- 29. AT ALL INSPECTIONS MADE EITHER BY A REPRESENTATIVE OF THE BUILDING DEPARTMENT OR BY THE ARCHITECT OR ENGINEER, THE P.C. SHALL PROVIDE A LADDER OF SUFFICIENT SIZE IN ORDER THAT THE INSPECTOR CAN PROPERLY LOOK AT ALL ITEMS TO BE INSPECTED. THE LADDER SHALL BE IN GOOD REPAIR AND BE POSITIONED IN PLACE BY THE P.C. TO MEET ALL OSHA REQUIREMENTS. THE P.C. SHALL ALSO PROVIDE A COMPLETE SET OF CONTRACT DOCUMENTS, AVAILABLE AT THE

JOB SITE, AT THE TIME OF INSPECTION. THE CONTRACT DOCUMENTS SHALL INCLUDE:

- A. WORKING DRAWINGS
- B. SPECIFICATIONS
- C. ALL APPROVED SHOP DRAWINGS
- D. ALL ADDENDA, CHANGE ORDERS AND CORRESPONDENCE. IF A LADDER AND CONTRACT DOCUMENTS ARE NOT AVAILABLE AT THE TIME OF INSPECTION, THE P.C. SHALL PAY THE ARCHITECT OR ENGINEER FOR THE VISIT TO THE SITE AND A NEW INSPECTION TIME SHALL BE AGREED UPON.

# **PLUMBING PRODUCTS**

- 1. SANITARY SEWER: PVC SCH.40
- 2. FIXTURE DRAINAGE ARMS: DWV COPPER.
- 3. WATER PIPE: CPVC
- 4. ALL BALL VALVES ASSOCIATED WITH WATER PIPING SHALL BE FULL PORT.
- 5. VENT LINES SHALL BE PVC.

# **VALVES NOTE**

INDIVIDUAL SHOWER AND TUB-SHOWER COMBINATION VALVES SHALL BE BALANCED-PRESSURE, THERMOSTATIC BALANCED-PRESSURE/THERMOSTATIC VALVES THAT CONFORM TO THE REQUIREMENTS OF ASSE 1016/ASME A112.1016/CSA B125.16 OR ASME A112.18.1/CSA B125.1 AND SHALL BE INSTALLED AT THE POINT OF USE. SHOWER AND TUB-SHOWER COMBINATION VALVES REQUIRED BY THIS SECTION SHALL BE EQUIPPED WITH A MEANS TO LIMIT THE MAXIMUM SETTING OF THE VALVE TO 120°F (49°C), WHICH SHALL BE FIELD ADJUSTED IN ACCORDANCE WITH THE MANUFACTURER'S INSTRUCTIONS. IN-LINE THERMOSTATIC VALVES SHALL NOT BE UTILIZED FOR COMPLIANCE WITH THIS SECTION AS PER SECTION 424.3 FBC

# PLUMBING SCOPE OF WORK

- 1. NEW PLUMBING FIXTURES AS PER LAYOUT
- 2. NEW TANKLES WATER HEATER #1

Kitchen sink

TABLE 604.4 MAXIMUM FLOW CONSUMP FOR PLUMBING FIXTURES	TION
PLUMBING FIXTURE OR FIXTURE FITTING	MAXIMUM FLOW RATE OR QUANTITY
Lavatory (hand wash)	1.5 gpm at 60 psi
Water closet	1.28 gallons per flushing cycle
Shower head	1.5 gpm at 80 psi

PLUMBING FIXTURES SHALL COMPLY WITH THE NEW WATER CONSUMPTION RATES IN ORDINANCE 08-14 (TABLE 604.4) & FBC, PLUMBING CHAPTER 4 REFERENCE STANDARDS.

ANTI SCALD VALVE REQUIRED FOR TUB/SHOWER

1.5 gpm at 60 psi

TABLE 909.1 MAXIMUM DISTANCE OF FIXTURE TRAP FROM VENT									
SIZE OF TRAP "inches"	SLOPE (inch per foot)	DISTANCE FROM TRAP (feet)							
1 1/4	1/4	5							
1 1/2	1/4	6							
2	1/4	8							
3	1/8	12							
4	1/8	16							
ANTI SCALD VALVE REQUIRED FOR TUB/SHOWER									

1. PLASTIC WASHING MACHINE OUTLET BOX WITH FACE PLATE MODEL No. W4700 HACP AS MANUFACTURED BY

- IPS CORPORATION.
- 2. CENTER 2" DRAIN. 3. BALL VALVE WITH CHROME 1/4 TURN HANDLES.

ANGLE RIVETED OR SPOT

WELDED AS REQUIRED

METAL SCREEN FRAME -

X = DUCT SIZE + 25%

FLASHING

ROOFING ---

ROOF DECK ----

EXIST. ROOF JOIST

PREFAB ROOF CURB

ADDITIONAL 4" DIA. EXHAUST DUCT.

4. W = WIDTH OF SPECIFIED DUCT.

3. DEPTH OF DUCT SHALL INCREASE 6" FOR EACH

5. ATTACH CURB TO STEEL ANGLES & TOP CHORD

STEEL JOIST W/ 3/8" CARRIAGE BOLTS AT EACH CORNER.


GOOSENECK DETAIL (TYP.)

1/2" SCREEN


1. R = W/2

2. SEAL ALL JOINTS.


- 4. WATER HAMMER ARRESTERS.
- 5. ½" SWEAT CONNECTION.
- 6. COLD WATER SUPPLY PIPE.
- 7. HOT WATER SUPPLY PIPE. 8. THIS OUTLET BOX CAN BE ORDERED WITH THE COLD &
- HOT WATER LINES TO ENTER THE TOP OF THE BOX.
- 9. CONTACT SUNBELT MARKETING AT 1-800-257-5566. 10. FOR PIPING OTHER THAN COPPER FOR HOT & COLD WATER SUPPLY, CONTACT SUNBELT MARKETING FOR

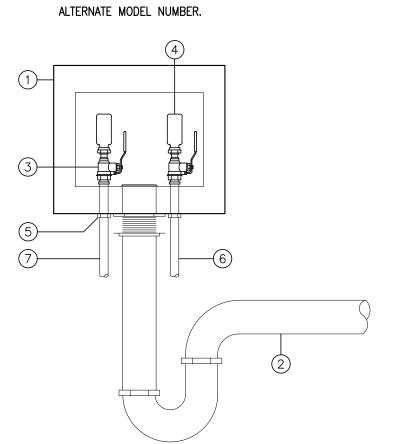

**WASHER HOOK DETAIL** 

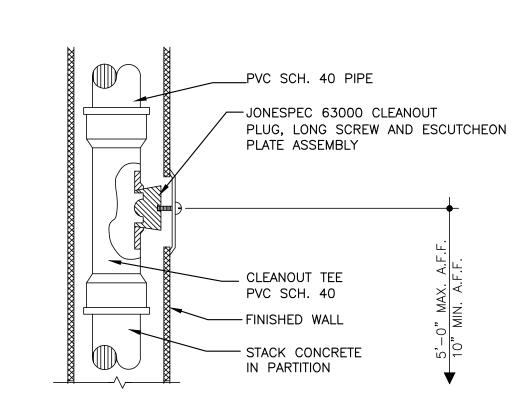


WALL CLEANOUT DETAIL TYP.

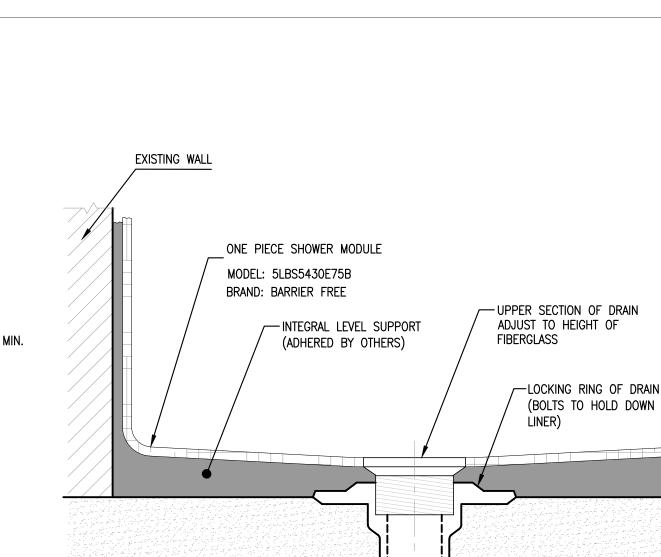

EXISTING DRAIN PIPE


- STANDARD DUCT MADE

WATER TIGHT

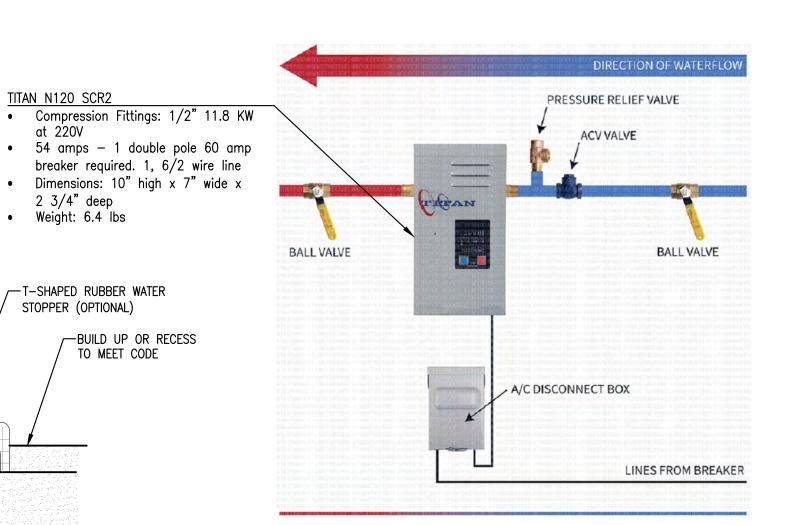

3 WATER HEATER CONNECTION DETAIL
SCALE 1/4"=1'-0"

2 SHOWER DETAIL NTS

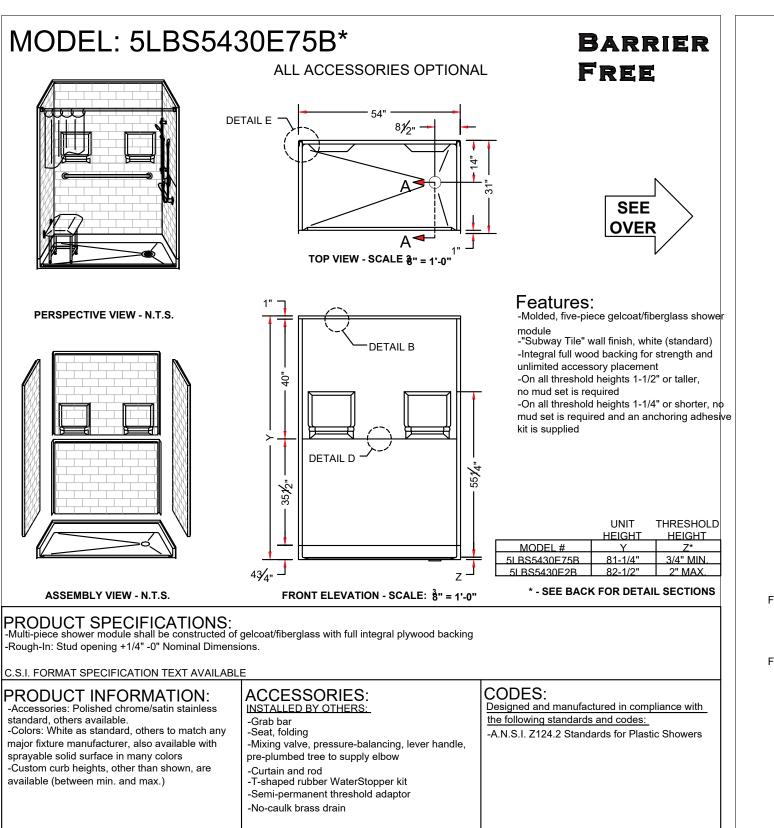

PRODUCT SPECIFICATIONS:
-Multi-piece shower module shall be constructed of gelcoat/fiberglass with full integral plywood backing -Rough-In: Stud opening +1/4" -0" Nominal Dimensions. .S.I. FORMAT SPECIFICATION TEXT AVAILABLE PRODUCT INFORMATION: standard, others available. -Colors: White as standard, others to match any major fixture manufacturer, also available with sprayable solid surface in many colors -Custom curb heights, other than shown, are available (between min. and max.) NOTICE OF LIMITATION: Does not meet: -I.P.C. International Plumbing Code -U.P.C. Uniform Plumbing Code BARRIER FREE ARCHITECTURALS INC. in the design of fixtures or in packaging unless this right has specifically been waived at the time the order www.barrierfree.org (877) 717-7027 page 1 of 2


5LBS5430E75B SEMI-PERMANENT THRESHOLD ADAPTOR (OPTIONAL) -T-SHAPED RUBBER WATER STOPPER (OPTIONAL) INTEGRAL LEVEL SUPPORT (ADHERED BY OTHERS) 8" DIA. DRAIN CUT-OUT **SECTION A-A - SCALE: 3" = 1'-0"** 5LBS5430E2B SEMI-PERMANENT THRESHOLD ADAPTOR (OPTIONAL) T-SHAPED RUBBER WATER STOPPER (OPTIONAL) **SECTION A-A - SCALE: 3" = 1'-0"** **OTHER THRESHOLD HEIGHTS AVAILABLE UPON REQUEST** GELCOAT 7 (COLOR) BARRIER \(\nabla_{\text{i}}\) COAT FIBERGLASS -SKIN LAMINATE **INDEXING** FIBERGI ASS PIN LAMINATE 5" MIN -DETAIL B - SCALE: 3" = 1'-0" **DETAIL D - SCALE: NTS WALL SECTION DETAIL BACKWALL JOINT DETAIL** CONSTRUCTION **ADHESIVE** SPRING CLIP BARRIER FREE ARCHITECTURALS INC. DETAIL E - SCALE: NTS WALL JOINT DETAIL www.barrierfree.org (877) 717-7027 page 2 of 2

DETAL & SPECIFICATIONS SHOWER (OR SIMILAR)

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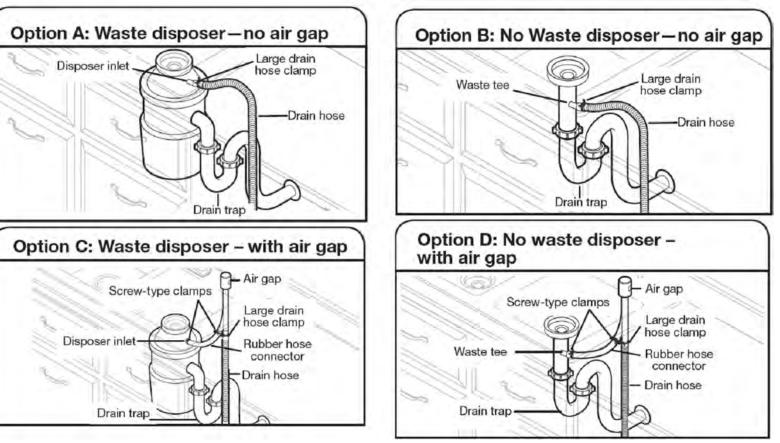
GENERAL NOTES SANITARY RISER

01/25/2023 Project Number 22609 Sheet


GN

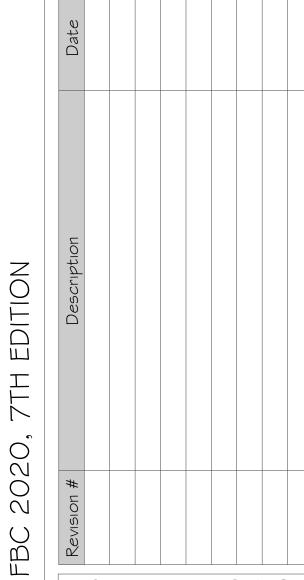Scale Drawn By JLO As Shown


2 SANITARY 2nd FLOOR PLAN SCALE 1/4"=1'-0"






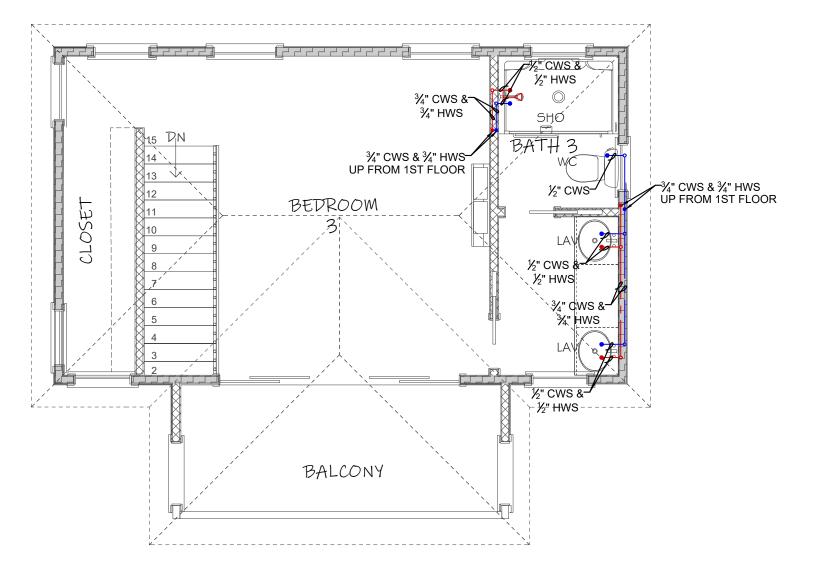



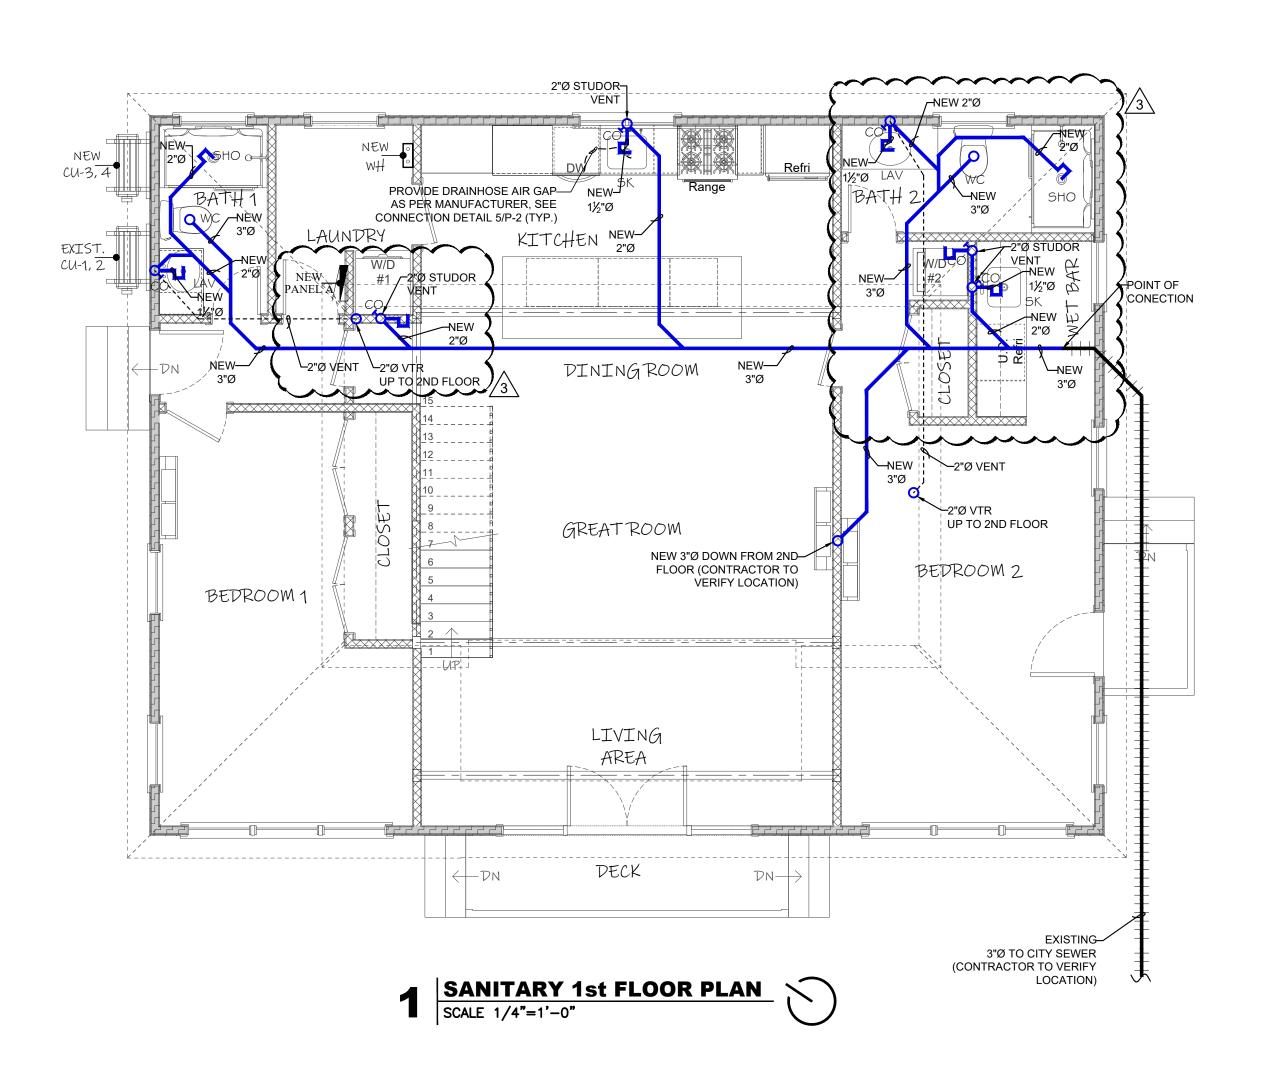

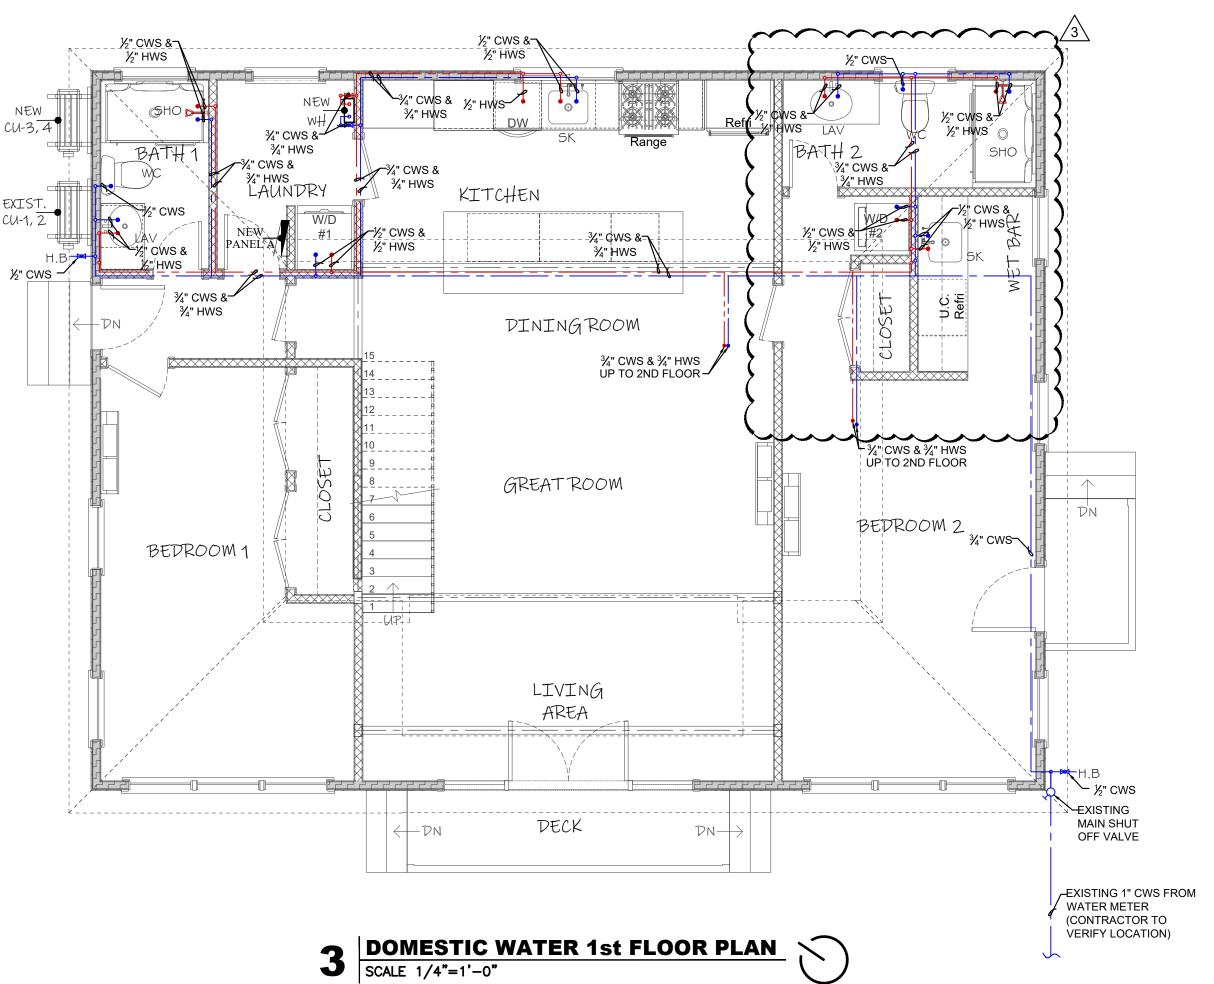



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DORAL, FL 33172

Phone: (305) 898-9995


ENGINEERING BUSINESS

CA CERTIFICATION: 32566

MASOOD HAJALI P.E

LIC #82038

DDITION & REMODELING FC RESIDENT @ 1215 Grinnell St,

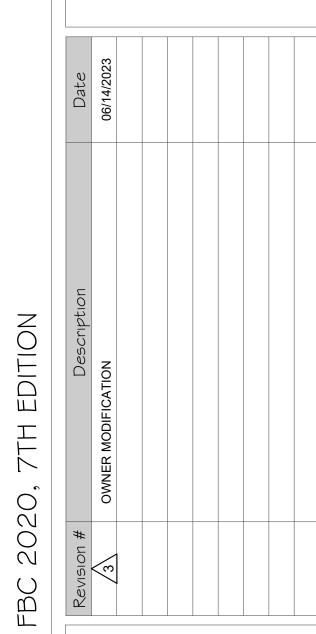

SANITARY&DOMESTIC WATER FLOOR PLAN

WATER FLOOR PLAN

Date 01/25/2023

Project Number 22609

Sheet P-2

Scale Drawn By

As Shown

The Historic Architectural Review Commission will hold a public meeting at <u>5:00 p.m.</u>, <u>September 26, 2023, at City Hall, 1300 White Street</u>, Key West, Florida. To view the live feed of the meeting, you can tune in to Comcast channel 77, AT&T U-verse channel 99. If you wish to participate virtually, please contact HARC staff at 305-809-3973. The purpose of the hearing will be to consider a request for:

# NEW SECOND STORY PORCH. PARTIAL DEMOLITION OF NON-HISTORIC FRONT WALL AT SECOND FLOOR. #1215 GRINNELL STREET

Applicant – Johnathan Herold Application #H2023-0026

If you wish to see the application or have any questions, you may visit the Planning Department during regular office hours at 1300 White Street, call 305-809-3973 or visit our website at <a href="https://www.cityofkeywest-fl.gov">www.cityofkeywest-fl.gov</a>.

THIS NOTICE CAN NOT BE REMOVED FROM THE SITE UNTIL HARC FINAL DETERMINATION

**ADA ASSISTANCE:** It is the policy of the City of Key West to comply with all requirements of the Americans with Disabilities Act (ADA). Please call the TTY number at 800-955-8771 or 800-955-8770 (Voice) or the ADA Coordinator at 305-809-3811 at least five business days in advance for sign language interpreters, assistive listening devices, or materials in accessible format.

# PROPERTY APPRAISER INFORMATION

# Monroe County, FL

### Disclaimer

The Monroe County Property Appraiser's office maintains data on property within the County solely for the purpose of fulfilling its responsibility to secure a just valuation for ad valorem tax purposes of all property within the County. The Monroe County Property Appraiser's office cannot guarantee its accuracy for any other purpose. Likewise, data provided regarding one tax year may not be applicable in prior or subsequent years. By requesting such data, you hereby understand and agree that the data is intended for ad valorem tax purposes only and should not be relied on for any other purpose.

By continuing into this site you assert that you have read and agree to the above statement.

### Summary

 Parcel ID
 00032260-000400

 Account#
 8761945

 Property ID
 8761945

 Millage Group
 10KW

**Location** 1215 GRINNELL St D, KEY WEST Address

 Legal
 G G WATSON SUB I-209 PT LOTS 6, 8 AND 10 SQR 9 TR 13 (A/K/A PARCEL D

 Description
 GRINNELL GARDENS) OR1119-1645 OR1119-1652 OR1119-1653 OR1195-1827

OR1760-322 OR1760-325 OR2357-2172 OR2399-2143 OR2807-2318 OR2839-

2459 OR3140-0329

(Note: Not to be used on legal documents.)

Neighborhood 6110

Property Class COMPOUNDS (0700)

Subdivision

Sec/Twp/Rng 05/68/25 Affordable No

Housing



### Owner

B3D1 LLC 3499 Hunters HILL Youngstown OH 44514

### Valuation

	2023 Preliminary Values	2022 Certified Values	2021 Certified Values	2020 Certified Values
+ Market Improvement Value	\$232,166	\$238,276	\$336,463	\$344,670
+ Market Misc Value	\$7,524	\$7,524	\$12,949	\$13,216
+ Market Land Value	\$675,852	\$675,852	\$511,859	\$509,374
= Just Market Value	\$915,542	\$921,652	\$861,271	\$867,260
= Total Assessed Value	\$915,542	\$921,652	\$861,271	\$859,807
- School Exempt Value	\$O	\$0	\$0	\$0
= School Taxable Value	\$915,542	\$921,652	\$861,271	\$867,260

### **Historical Assessments**

Year	Land Value	<b>Building Value</b>	Yard Item Value	Just (Market) Value	Assessed Value	Exempt Value	Taxable Value	Maximum Portability
2022	\$675,852	\$238,276	\$7,524	\$921,652	\$921,652	\$0	\$921,652	\$0
2021	\$511,859	\$336,463	\$12,949	\$861,271	\$861,271	\$0	\$861,271	\$0
2020	\$509,374	\$344,670	\$13,216	\$867,260	\$859,807	\$0	\$867,260	\$0
2019	\$464,524	\$303,638	\$13,481	\$781,643	\$781,643	\$0	\$781,643	\$0
2018	\$480,946	\$311,844	\$12,741	\$805,531	\$805,531	\$0	\$805,531	\$0

The Maximum Portability is an estimate only and should not be relied upon as the actual portability amount. Contact our office to verify the actual portability amount.

### Land

Land Use	Number of Units	Unit Type	Frontage	Depth
RESIDENTIAL DRY (010D)	2,823.58	Square Foot	0	0

# **Buildings**

Building ID Style Building Type Building Name Gross Sq Ft Finished Sq Ft Stories Condition Perimeter Functional Obs Economic Obs Depreciation %	33932 2 STORY ELEV FOUNE S.F.R R1 / R1 1596 1536 2 Floor GOOD 216 0 0	DATION		Exterior Walls Year Built EffectiveYearBuilt Foundation Roof Type Roof Coverage Flooring Type Heating Type Bedrooms Full Bathrooms Half Bathrooms Grade	HARDIE BD 1990 2005 CONC BLOCK IRR/CUSTOM METAL CERM/CLAY TILE FCD/AIR NON-DC 3 3 0 500	
Interior Walls Code De	WALL BD/WD WAL escription	Sketch Area	Finished Area	Number of Fire PI Perimeter	I 0	
	OOR LIV AREA	1,536	1,536	0		
	P PR UNFIN LL	20	0	0		
	P PRCH FIN LL	40	0	0		
TOTAL	1,596 1,536 0			0		

### **Yard Items**

Description	Year Built	Roll Year	Size	Quantity	Units	Grade
CUSTOM PATIO	1989	1990	0 x 0	1	471 SF	4
FENCES	1989	1990	6 x 84	1	504 SF	5
WOOD DECK	1989	1990	2 x 40	1	80 SF	1
WOOD DECK	1991	1992	0 x 0	1	35 SF	3
FENCES	1992	1993	6 x 22	1	132 SF	2

# Sales

Sale Date	Sale Price	Instrument	Instrument Number	Deed Book	Deed Page	Sale Qualification	Vacant or Improved	Grantor	Grantee
11/23/2021	\$905,000	Warranty Deed	2350510	3140	0329	01 - Qualified	Improved		
2/6/2017	\$100	Quit Claim Deed	2111061	2839	2459	11 - Unqualified	Improved	GRAY ROBERT S AND TRACY A	
4/23/2008	\$900,000	Warranty Deed		2357	2172	Q - Qualified	Improved		


# **Permits**

Notes <b>≑</b>	Permit Type <b>♦</b>	Date Completed Amount	Date Issued <b>\$</b>	Number <b>♦</b>
Demolition of interior partition walls and finishes as noted. Demo partial interior finishes in kitchen and bathrooms.	Residential	\$0	2/10/2023	22-2989
Interior remodel, new porch addition *requires corrections to application see notes *	Residential	\$0	2/10/2023	23-0010
Interior remodel. New paint, flooring, cabinets This is for interior work only.	Residential	\$0	2/10/2023	23-0443
Remove existing metal roof from the main house, top and bottom. Install new MFM underlayment. Install new 5V Metal crimp roofing system to top and bottom roof, approx. 1200 sq ft. Separate contractor will be installing deck/balcony on the 2nd floor, he will apply for his own permit. We will then install new TPO roofing system on the flat roof part, approx. 200 sq ft.	Residential	\$25,000	11/7/2022	22-3224

# **View Tax Info**

View Taxes for this Parcel

Sketches (click to enlarge)

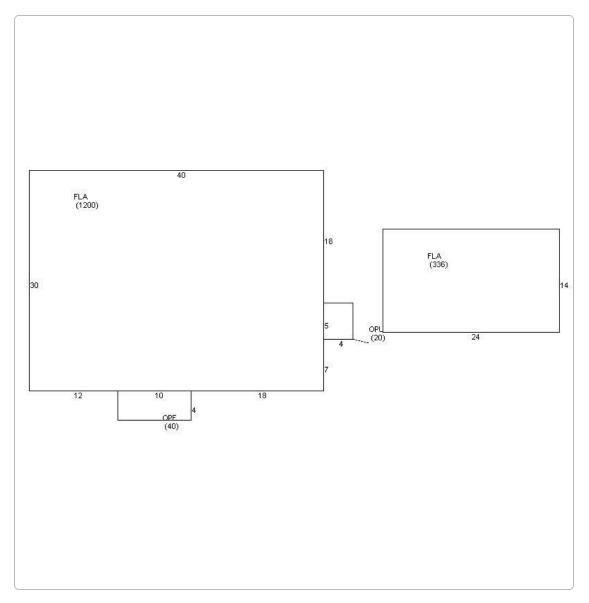

# **Photos**



### Map



# **TRIM Notice**

2023 TRIM Notice (PDF)

The Monroe County Property Appraiser's office maintains data on property within the County solely for the purpose of fulfilling its responsibility to secure a just valuation for ad valorem tax purposes of all property within the County. The Monroe County Property Appraiser's office cannot guarantee its accuracy for any other purpose. Likewise, data provided regarding one tax year may not be applicable in prior or subsequent years. By requesting such data, you hereby understand and agree that the

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