

Historic Architectural Review Commission Staff Report for Item 4

To: Chairman Haven Burkee and Historic Architectural Review

Commission Members

From: Daniela Salume, MFA

Historic Preservation Manager

Meeting Date: April 22, 2025

Applicant: Kyle Kalwary

Application Number: C2025-0025

Address: 525 Southard Street

Description of Work:

New diesel generator with pad and fence.

Site Facts:

The building on this property is a historic and contributing structure to the historic district built in 1940. There are three consecutive lots owned by the same owner which consist of a one-story historic structure, a monopole tower, and a parking area located in the corner of Southard Street and Bahama Street.

Currently the properties are located within an X flood zone.




Photo of property under review. Monroe County Library 1965.



Photo of property under review. Monroe County Library circa 1960 before it was demolished.



Photo of property under review.

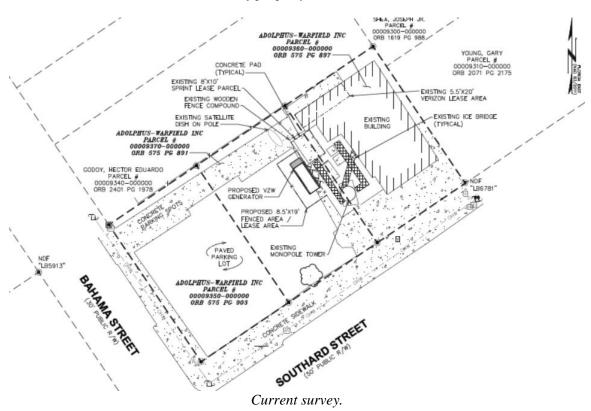


Guidelines Cited on Review:


- Guidelines for New Construction (pages 38a-38q), specifically guidelines 1, 2, 5, 6 (first three sentences), 7 (last sentence), 8, 11, 12, 13 (first sentence), 14, 22, and 23
- Guidelines for Outbuildings (pages 40-41), specifically guidelines 1, 3, 4, 9, 10, 11, and 12.
- Guidelines for Fences & Walls (pages 41-42), specifically the first paragraph, guidelines 1, 2, 3, 4, 6, 7, 8, 9, and 10.
- U.S. Secretary of the Interior's Standards for Rehabilitation (pages 16-17), specifically 9 and 10.

Staff Analysis:


A Certificate of Appropriateness is currently under review for a new 200 KW diesel generator with a 693 gallon tank. No work will be done on the principal historic structure. An 8' by 18' concrete pad will be installed where the generator will sit on, and metal fencing will conceal the generator. The fence will be an 8' tall chain link fence with three strand barbed wire on top, per the drawings provided. However, when speaking to the applicant they mentioned that it would match the existing square lattice fence on site. The fence will have some sort of green screening over it.

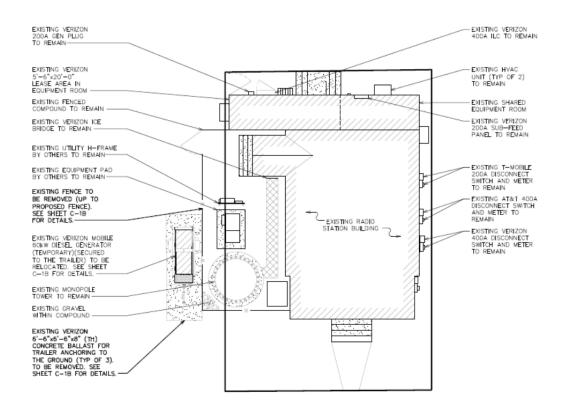

Existing Site Plan.

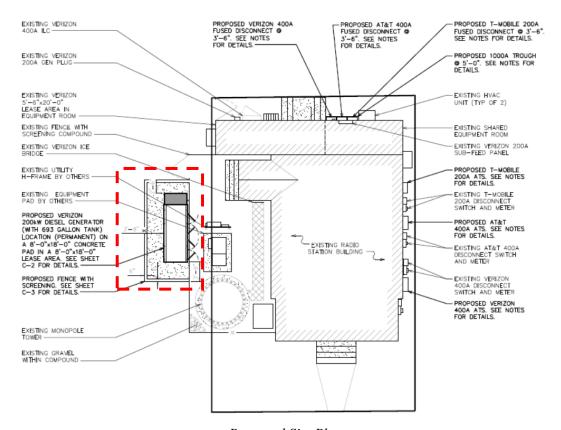

Proposed Site Plan.

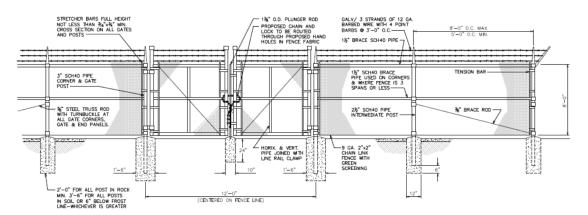

Proposed Fencing.

Consistency with Cited Guidelines:

The generator and concrete pad are located away from the principal historic structure. The use of a standard 8' chain link fence with barbed wire would not typically be considered compatible with the visual character of a historic district. However, if the final fencing matches the existing square lattice design on site and includes appropriate green screening to soften its visual impact, the installation would better comply with the guidelines that call for mechanical equipment to be screened in a manner that is visually compatible with the surrounding environment.

APPLICATION

HARC MAJOR PROJECTS CERTIFICATE OF APPROPRIATENESS



ADDRESS OF PROPOSED PROJECT:

HARC COA #	REVISION #	INITIAL & DATE
FLOOD ZONE	ZONING DISTRICT	BLDG PERMIT #

A PRE-APPLICATION MEETING WITH HARC STAFF IS REQUIRED PRIOR TO SUBMITTAL

525 SOUTHARD STREET, KEY WEST, FL 33040


NAME ON DEED:	ADOLPHUS-WARFIELD INC	PHONE NUMBER (407) 724-2626
OWNER'S MAILING ADDRESS:	523 SOUTHARD ST, KEY WEST, FL 33040	EMAIL SJOHNSON@TEPGROUP.NET
APPLICANT NAME:	KYLE KALWARY	PHONE NUMBER (813) 374-2225
APPLICANT'S ADDRESS:	221 S 78 ST, TAMPA, FL 33619	EMAIL KKALWARY@MYAIRNOW.COM
APPLICANT'S SIGNATURE:		DATE
FLORIDA STATUTE 837.06: WHOEVER KN SERVANT IN THE PERFORMANCE OF H PUNISHABLE PER SECTION 775.082 OR DESCRIBED IN THE APPLICATION SHALI APPLICANT FURTHER STIPULATES THA DESCRIPTION OF WORK, AS DESCRIBED AND THE SUBMITTED PLANS, THE AFORE PROJECT INCLUDES: REPLACEMENT PROJECT INVOLVES A CONTRIBUTING S PROJECT INVOLVES A STRUCTURE THA DETAILED PROJECT DESCRIPTION GENERAL: GROUND SCOPE OF WORK: RI REMOVE COMPOUND FENCE INSTALL (1) 200KW DIESEL GE	ON INCLUDING MATERIALS, HEIGHT, DIMENSIONS, SO EMOVE (1) MOBILE 60kW DIESEL GENERATO (AS SHOWN IN PLANS) · REMOVE GENERAT NERATOR OR PAD (PERMANENT) · INSTALL FENCE WIT	ID WITH THE INTENT TO MISLEAD A PUBLIC MISDEMEANOR OF THE SECOND-DEGREE VLEDGES THAT THE SCOPE OF WORK AS DO BY THE APPLICANT AND THE CITY. THE TY FOR EXCEEDING THE SCOPE OF THE DN BETWEEN THE DESCRIPTION OF WORK PROLLING. ELEVATION OF A STRUCTURE NO X_BITCH STRUCTURE; YES NO X_BITCH STER: YES NO DUARE FOOTAGE, LOCATION, ETC.

APPLICATIONS MUST BE SUBMITTED IN PERSON WITH HARD COPIES BY 3PM ON THE SCHEDULED DEADLINE PLEASE SEND AN ELECTRONIC COPY OF ALL DOCUMENTS CITY_HARC@CITYOFKEYWEST-FL.GOV


ACCESSORY STRUCTURE(S):

PAVERS:		FENCES:	
DECKS:		PAINTING:	
SITE (INCLUDING GRADIN	IG, FILL, TREES, ETC):	POOLS (INCLUDING EQUIPMENT):	
ACCESSORY EQUIPMENT	(GAS, A/C, VENTS, ETC):	OTHER:	
GENERATOR			
OFFICIAL USE ONLY:	HARC COMMISSION REVIEW		EXPIRES ON:
MEETING DATE:			INITIAL:
MEETING DATE:	APPROVED NOT APPROVED _	_ DEFERRED FOR FUTURE CONSIDERATION	INUTIAL
MEETING DATE:		_ DEFERRED FOR FUTURE CONSIDERATION _ DEFERRED FOR FUTURE CONSIDERATION	INITIAL:
MEETING DATE: MEETING DATE:	APPROVED NOT APPROVED _	_ DEFERRED FOR FUTURE CONSIDERATION	INITIAL:
MEETING DATE:	APPROVED NOT APPROVED _		
	APPROVED NOT APPROVED _	_ DEFERRED FOR FUTURE CONSIDERATION	
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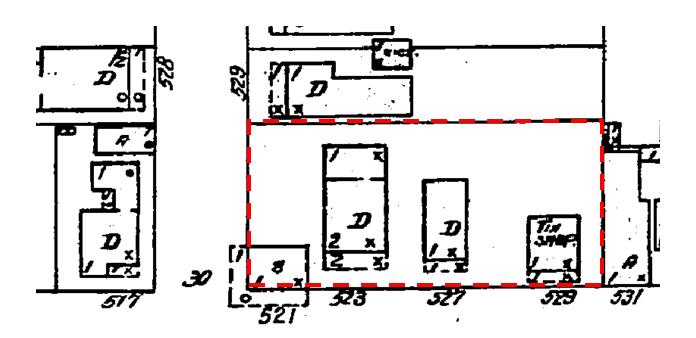
THIS APPLICATION MAY BE REVIEWED BY PLANNING DEPARTMENT STAFF.

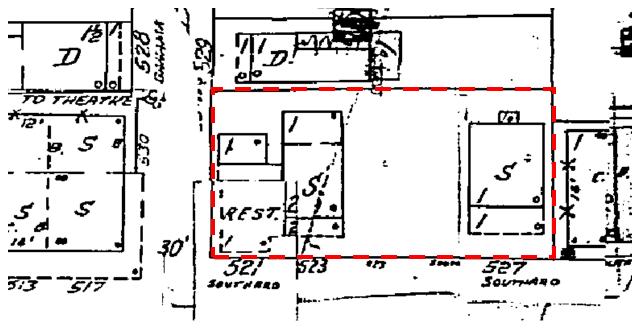


1962 Sanborn Map.

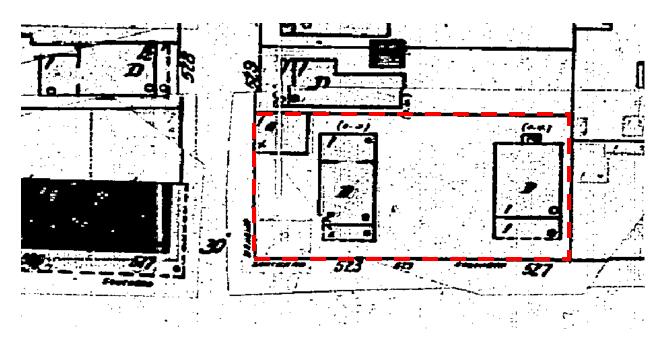

1948 Sanborn Map.



1926 Sanborn Map.

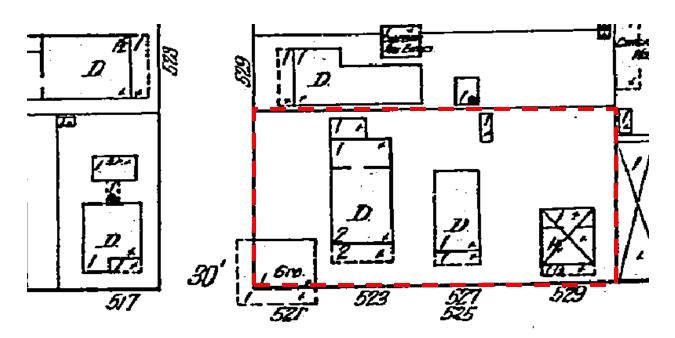

1912 Sanborn Map.

PROJECT PHOTOS









Proposed fence area - 8' x 18' - New fenced area will be rectangular (8' x 18'); fencing materials will match existing fence materials. The new fence will also be dressed in live greenery ("green wall").

*(image above not to scale - for illustration only)



Proposed fence area - 8' x 18' - wide
*(image above not to scale - for illustration only)

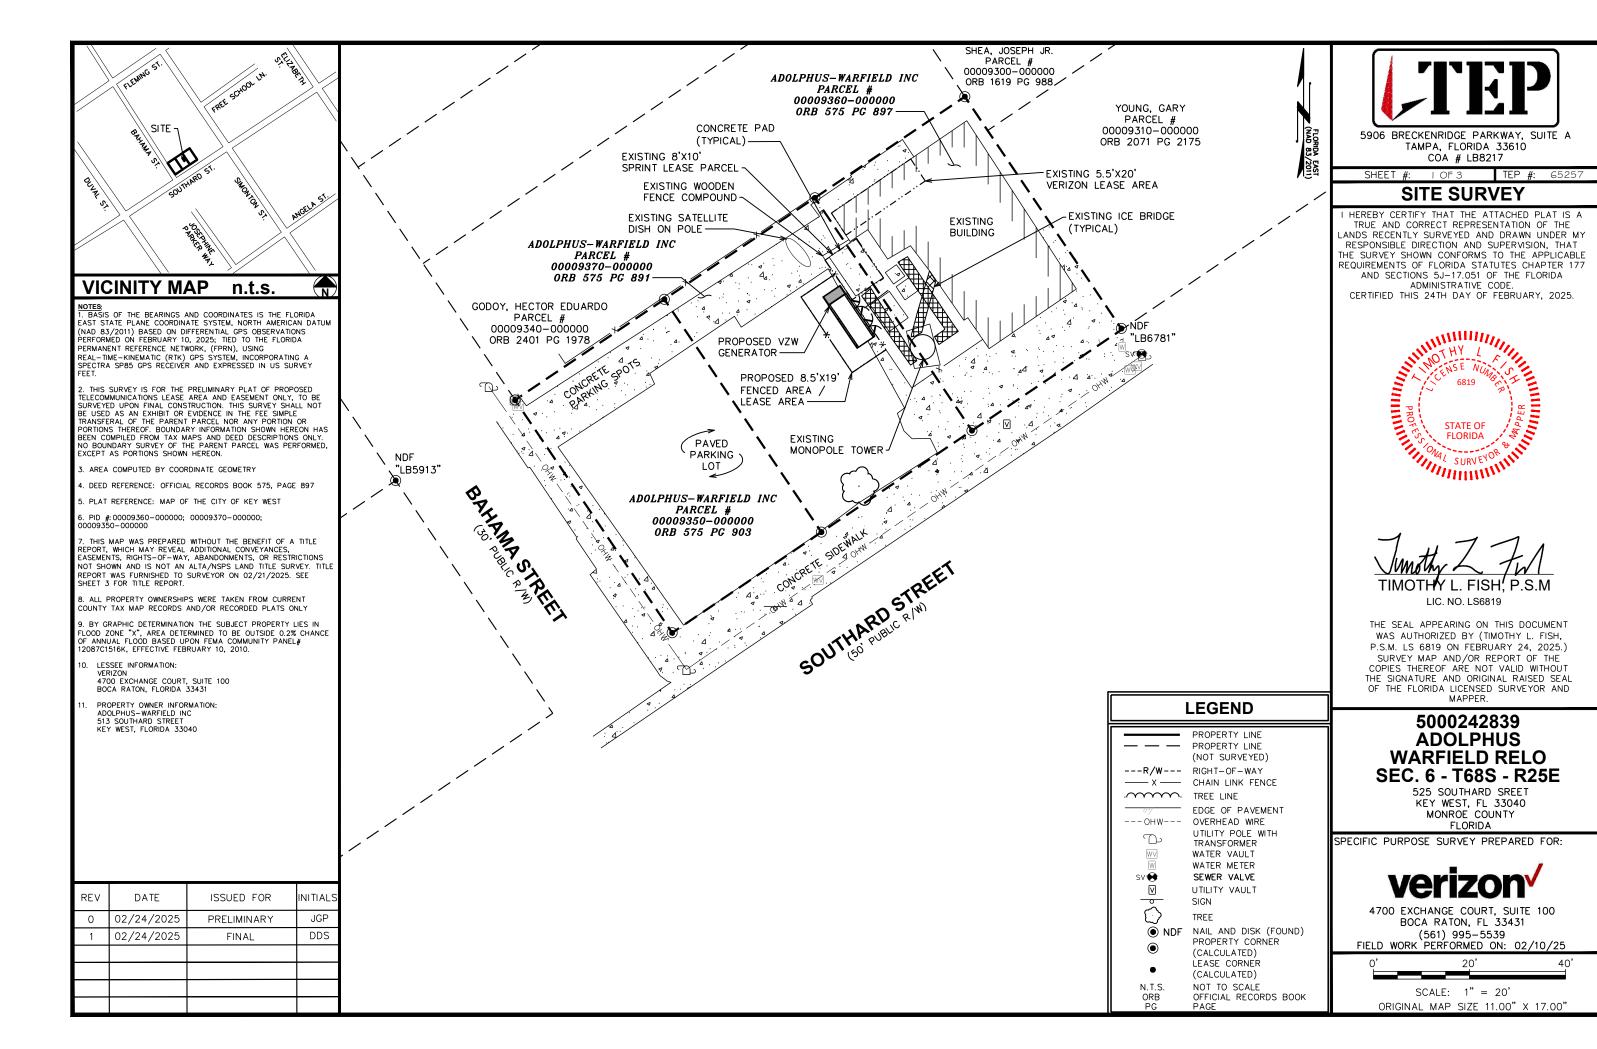

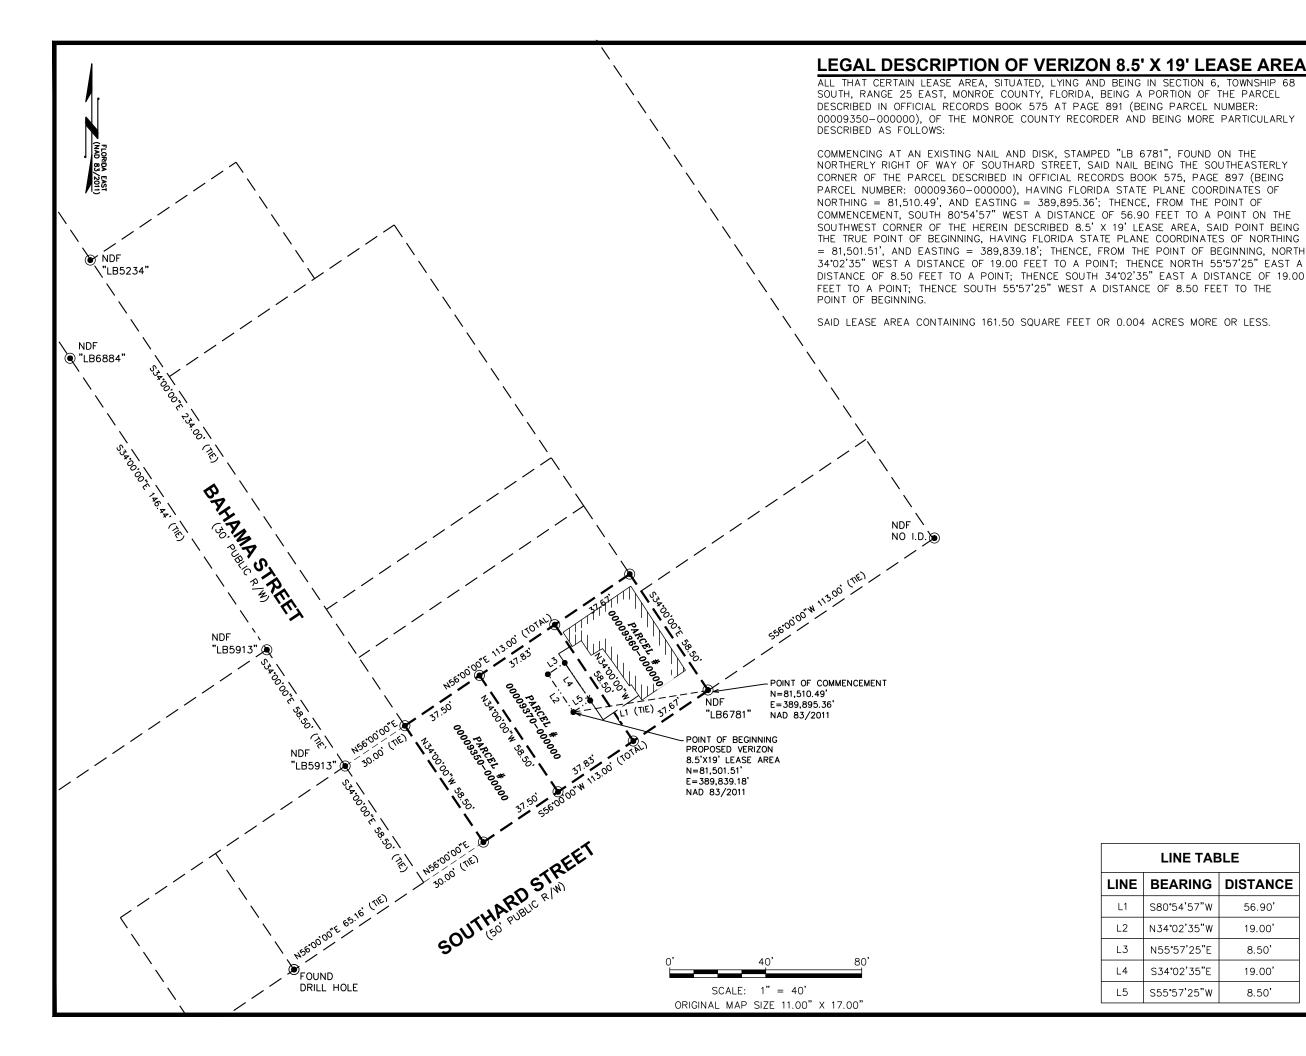




5906 BRECKENRIDGE PARKWAY, SUITE A TAMPA, FLORIDA 33610 COA # LB8217

SHFFT #: 2 OF 3

HEREBY CERTIFY THAT THE ATTACHED PLAT IS A TRUE AND CORRECT REPRESENTATION OF THE ANDS RECENTLY SURVEYED AND DRAWN UNDER MY RESPONSIBLE DIRECTION AND SUPERVISION, THAT THE SURVEY SHOWN CONFORMS TO THE APPLICABLE REQUIREMENTS OF FLORIDA STATUTES CHAPTER 177 AND SECTIONS 5J-17.051 OF THE FLORIDA ADMINISTRATIVE CODE.

CERTIFIED THIS 24TH DAY OF FEBRUARY, 2025.

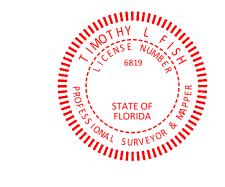

LIC. NO. LS6819

THE SEAL APPEARING ON THIS DOCUMENT WAS AUTHORIZED BY (TIMOTHY L. FISH, P.S.M. LS 6819 ON FEBRUARY 24, 2025.) SURVEY MAP AND/OR REPORT OF THE COPIES THEREOF ARE NOT VALID WITHOUT THE SIGNATURE AND ORIGINAL RAISED SEAL OF THE FLORIDA LICENSED SURVEYOR AND MAPPER.

5000242839 **ADOLPHUS WARFIELD RELO SEC. 6 - T68S - R25E**

525 SOUTHARD SREET KEY WEST, FL 33040 MONROE COUNTY FLORIDA

SPECIFIC PURPOSE SURVEY PREPARED FOR:



4700 EXCHANGE COURT, SUITE 100 BOCA RATON, FL 33431 (561) 995-5539 FIELD WORK PERFORMED ON: 02/10/25

LINE TABLE

DISTANCE

56.90'

19.00'

8.50

19.00'

8.50

BEARING

S80°54'57"W

N34°02'35"W

N55°57'25"E

S34°02'35"E

S55°57'25"W

LINE

L1

L2

L3

L4

L5

REV	DATE	ISSUED FOR	INITIALS
0	02/24/2025	PRELIMINARY	JGP
1	02/24/2025	FINAL	DDS

SCHEDULE B - SECTION II EXCEPTIONS

CHICAGO TITLE INSURANCE COMPANY
COMMITMENT FOR TITLE INSURANCE
COMMITMENT NO: FL2502188
COMMITMENT EFFECTIVE DATE: JANUARY 14, 2025
SCHEDULE B — SECTION II

- 1. ANY DEFECT, LIEN, ENCUMBRANCE, ADVERSE CLAIM, OR OTHER MATTER THAT APPEARS FOR THE FIRST TIME IN THE PUBLIC RECORDS OR IS CREATED, ATTACHES, OR IS DISCLOSED BETWEEN THE COMMITMENT DATE AND THE DATE ON WHICH ALL OF THE SCHEDULE B, PART I—REQUIREMENTS ARE MET. (AFFECT PARENT PARCEL. NONE OBSERVED.)
- 2. TAXES AND ASSESSMENTS FOR THE YEAR 2025 AND SUBSEQUENT YEARS, WHICH ARE NOT YET DUE AND PAYABLE. (AFFECT PARENT PARCEL. NOT SURVEY RELATED.)
- 3. STANDARD EXCEPTIONS:
- A. EASEMENTS, CLAIMS OF EASEMENTS, BOUNDARY LINE DISPUTES, OVERLAPS, ENCROACHMENTS OR OTHER MATTERS NOT SHOWN BY THE PUBLIC RECORDS WHICH WOULD BE DISCLOSED BY AN ACCURATE SURVEY OF THE LAND.
- B. RIGHTS OR CLAIMS OF PARTIES IN POSSESSION NOT SHOWN BY THE PUBLIC RECORDS.
 C. ANY LIEN. OR RIGHT TO A LIEN. FOR SERVICES, LABOR, OR MATERIALS HERETOFORE OR HEREAF
- C. ANY LIEN, OR RIGHT TO A LIEN, FOR SERVICES, LABOR, OR MATERIALS HERETOFORE OR HEREAFTER FURNISHED, IMPOSED BY LAW AND NOT SHOWN BY THE PUBLIC RECORDS.
- D. TAXES OR ASSESSMENTS WHICH ARE NOT SHOWN AS EXISTING LIENS IN THE PUBLIC RECORDS. (AFFECT PARENT PARCEL. ITEMS DO NOT AFFECT THIS SURVEY.)
- 4. ANY CLAIM THAT ANY PORTION OF THE INSURED LAND IS SOVEREIGN LANDS OF THE STATE OF FLORIDA, INCLUDING SUBMERGED, FILLED OR ARTIFICIALLY EXPOSED LANDS ACCRETED TO SUCH LAND. (AFFECT PARENT PARCEL. DOES NOT AFFECT THIS SURVEY.)
- 5. ANY LIEN PROVIDED BY CHAPTER 159, FLORIDA STATUTES, IN FAVOR OF ANY CITY, TOWN, VILLAGE OR PORT AUTHORITY FOR UNPAID SERVICE CHARGES FOR SERVICE BY ANY WATER, SEWER OR GAS SYSTEM SUPPLYING THE INSURED LAND. (AFFECT PARENT PARCEL. DOES NOT AFFECT THIS SURVEY.)
- 6. SUBJECT TO CODE OF ORDINANCES OF THE CITY OF KEY WEST, SECTION 74, WHICH PROVIDES FOR THE ASSESSMENT AND COLLECTION OF SEWER CHARGES. (AFFECT PARENT PARCEL. DOES NOT AFFECT THIS SURVEY.)
- 7. SUBJECT TO UNRECORDED CITY ORDINANCE NO. 81-43 AND AMENDMENT 82-5 THEREOF, WHICH PROVIDES FOR THE ASSESSMENT AND COLLECTION OF WASTE IN THE CITY OF KEY WEST, FLORIDA. (AFFECT PARENT PARCEL. DOES NOT AFFECT THIS SURVEY.)
- 8. CITY OF KEY WEST AREA OF CRITICAL STATE CONCERN, RULE 27F-15 OF THE FLORIDA ADMINISTRATIVE CODE, ADOPTED BY THE ADMINISTRATION COMMISSION PURSUANT TO SECTION 380.05, F.S., ON FEBRUARY 7, 1984, EFFECTIVE FEBRUARY 28, 1984 RECORDED IN OFFICIAL RECORDS BOOK 906, PAGE 200. (AFFECT PARENT PARCEL, DOES NOT AFFECT THIS SURVEY.)
- 9. TERMS AND PROVISIONS SET FORTH IN COMMUNICATIONS SITE LEASE AGREEMENT DATED AUGUST 23, 2005 BY AND BETWEEN ADOLPHUS-WARFIELD, INC., A FLORIDA CORPORATION, LESSOR, AND NEXTEL SOUTH CORP., A GEORGIA CORPORATION, LESSEE, AS MEMORIALIZED BY MEMORANDUM OF AGREEMENT RECORDED DECEMBER 8, 2005 IN OFFICIAL RECORDS BOOK 2185, PAGE 1049. (AFFECT PARENT PARCEL. BLANKET RIGHTS.)
- 10. TERMS AND PROVISIONS SET FORTH IN TOWER LEASE AGREEMENT DATED AUGUST 1, 2013 BY AND BETWEEN ADOLPHUS-WARFIELD, INC., A FLORIDA CORPORATION, LESSOR, AND VERIZON WIRELESS PERSONAL COMMUNICATIONS LP, A DELAWARE LIMITED PARTNERSHIP D/B/A VERIZON WIRELESS, LESSEE, AS MEMORIALIZED BY MEMORANDUM OF TOWER LEASE AGREEMENT RECORDED DECEMBER 17, 2013 IN OFFICIAL RECORDS BOOK 2663, PAGE 1046. (AFFECT PARENT PARCEL.)
- 11. TERMS, COVENANTS, CONDITIONS AND OTHER MATTERS CONTAINED IN ANY UNRECORDED LEASE(S) AND ALL RIGHTS THEREUNDER OF THE LESSEE(S) AND OF ANY PERSON CLAIMING BY, THROUGH OR UNDER THE LESSEE(S). (AFFECT PARENT PARCEL, SPRINT LEASE PARCEL, AS SHOWN HEREON)

TITLE LEGAL DESCRIPTION (AS FURNISHED)

ON THE ISLAND OF KEY WEST, KNOWN ON WILLIAM A. WHITEHEAD'S MAP OF SAID ISLAND, DELINEATED IN FEBRUARY, A.D. 1829, AS A PART OF LOT 1, IN SQUARE 50, BUT NOW BETTER KNOWN AS A PART OF SUBDIVISION 16 ACCORDING TO GORDON'S DIAGRAM OF SAID SQUARE 50, RECORDED IN DEED BOOK F, PAGE 131, OF THE PUBLIC RECORDS OF MONROE COUNTY, FLORIDA, ALSO KNOWN ON CHARLES W. TIFT'S MAP OF THE CITY OF KEY WEST, DELINEATED IN JULY, 1874, AS PART OF SUBDIVISION 16, LOT 1, SQUARE 50. SAID LOT BEING DESCRIBED BY METES AND BOUNDS AS FOLLOWS: COMMENCING AT A POINT ON THE NORTHWESTERLY SIDE OF SOUTHARD STREET A DISTANCE OF 75 FEET, 4 INCHES FROM THE CORNER OF BAHAMA AND SOUTHARD STREETS, AND RUNNING THENCE IN A NORTHEASTERLY DIRECTION ALONG SOUTHARD STREET 37 FEET, 8 INCHES; THENCE AT RIGHT ANGLES IN A SOUTHWESTERLY DIRECTION 37 FEET, 8 INCHES; THENCE AT RIGHT ANGLES IN A SOUTHWESTERLY DIRECTION 37 FEET, 8 INCHES; THENCE AT RIGHT ANGLES IN A SOUTHWESTERLY DIRECTION 37 FEET, 8 INCHES; THENCE AT RIGHT ANGLES IN A SOUTHWESTERLY DIRECTION 58 FEET, 6 INCHES BACK TO THE POINT OF BEGINNING.




5906 BRECKENRIDGE PARKWAY, SUITE A TAMPA, FLORIDA 33610 COA # LB8217

SHEET #: 3 OF 3

TEP #: 65257

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CERTIFIED THIS 24TH DAY OF FEBRUARY, 2025.

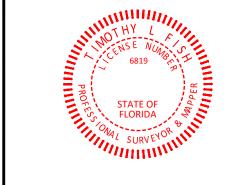

TIMOTHY I FISH PSM

LIC. NO. LS6819

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5000242839 ADOLPHUS WARFIELD RELO SEC. 6 - T68S - R25E

525 SOUTHARD SREET KEY WEST, FL 33040 MONROE COUNTY FLORIDA

SPECIFIC PURPOSE SURVEY PREPARED FOR:



4700 EXCHANGE COURT, SUITE 100 BOCA RATON, FL 33431 (561) 995-5539 FIELD WORK PERFORMED ON: 02/10/25

REV	DATE	ISSUED FOR	INITIALS
0	02/24/2025	PRELIMINARY	JGP
1	02/24/2025	FINAL	DDS

PROPOSED DESIGN

VERIZON SITE NUMBER: 5000242839

ADOLPHUS WARFIELD RELO VERIZON SITE NAME:

PROJECT DESCRIPTION: GENERATOR ADD

(PERMANENT)

TOWER TYPE: MONOPOLE

SITE ADDRESS: **525 SOUTHARD STREET**

> KEY WEST. FL 33040 (MONROE COUNTY)

JURISDICTION: MONROE COUNTY

PRESENT

OCCUPANCY TYPE: ONE STORY OFFICE (1700)

CURRENT ZONING: HNC-1


PARCEL ID #: 00009360-000000

PROJECT INFORMATION

N 24° 33' 19.72" * LONGITUDE: W 81° 48' 04.30" * **GROUND ELEVATION:** 9.8'± (AMSL) *

*INFORMATION PROVIDED BY GOOGLE EARTH

SITE COORDINATES

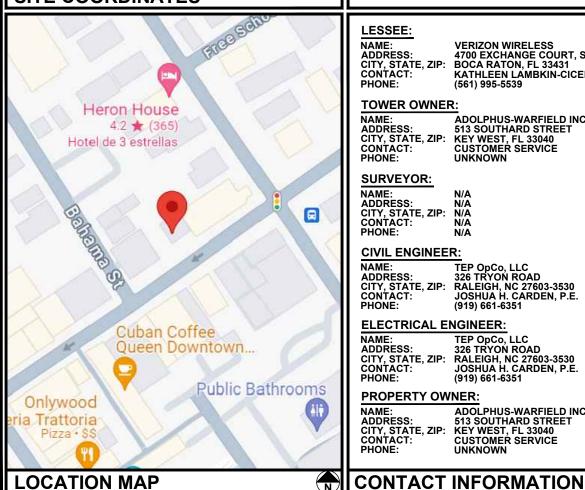

Verizon

4700 EXCHANGE COURT, SUITE 100 BOCA RATON, FL 33431 (561) 995-5539

VZW SITE #: 5000242839 VZW SITE NAME: ADOLPHUS WARFIELD RELO (PERMANENT)

> **525 SOUTHARD STREET** KEY WEST, FL 33040

NOT CONFORMING TO THE LATEST EDITIONS OF THE FOLLOWING

CODE COMPLIANCE

2023 FLORIDA BUILDING 4. 2020 NATIONAL ELECTRIC CODE

LESSEE:

NAME: VERIZON WIRELESS
ADDRESS: 4700 EXCHANGE COURT, SUITE 100
CITY, STATE, ZIP: BOCA RATON, FL 33431
CONTACT: KATHLEEN LAMBKIN-CICERO

(561) 995-5539

TOWER OWNER:

NAME: ADDRESS: 513 SOUTHARD STREET CITY, STATE, ZIP: KEY WEST, FL 33040 CONTACT:

ADOLPHUS-WARFIELD INC CUSTOMER SERVICE

SURVEYOR:

ADDRESS: N/A CITY, STATE, ZIP: N/A CONTACT: N/A

CIVIL ENGINEER:

NAME: ADDRESS: 326 TRYON ROAD
CITY, STATE, ZIP: RALEIGH, NC 27603-3530
CONTACT: JOSHUA H. CARDEN, P.E.

ELECTRICAL ENGINEER:

TEP OpCo, LLC 326 TRYON ROAD NAME: ADDRESS: CITY, STATE, ZIP: RALEIGH, NC 27603-3530 CONTACT: JOSHUA H. CARDEN, P.E JOSHUA H. CARDEN, P.E. (919) 661-6351

PROPERTY OWNER:

NAME: ADOLPHUS-WARFIELD IN ADDRESS: 513 SOUTHARD STREET CITY, STATE, ZIP: KEY WEST, FL 33040 CUSTOMER SERVICE **ADOLPHUS-WARFIELD INC** PHONE:

UTILITIES:

POWER COMPANY: CONTACT: METER # NEAR SITE:

TELEPHONE COMPANY: PHONE: PHONE # NEAR SITE:

CODE, 8TH EDITION LOCAL BUILDING CODE

ANSI/TIA-222-H-2-2017

UNKNOWN UNKNOWN UNKNOWN

KEYS ENERGY SERVICES CUSTOMER SERVICE

THE PURPOSE OF THIS PROJECT IS AS FOLLOWS: ALL WORK AND MATERIALS SHALL BE PERFORMED AND INSTALLED CODES AS ADOPTED BY THE LOCAL GOVERNING AUTHORITIES.

> REMOVE (1) MOBILE 60kW DIESEL GENERATOR (TEMPORARY) REMOVE COMPOUND FENCE (AS SHOWN IN PLANS) REMOVE GENERATOR PAD (TEMPORARY)

INSTALL (1) 200kW DIESEL GENERATOR INSTALL 8'-0"x18'-0" GENERATOR PAD (PERMANENT) INSTALL FENCE WITH SCREENING (AS SHOWN IN PLANS)

SCOPE OF WORK

SHEET	DESCRIPTION	REV
T-1	TITLE SHEET	2
N-1	PROJECT NOTES	2
C-1	SITE PLAN	2
C-1A	EXISTING EQUIPMENT LAYOUT	2
C-1B	INSTALLATION EQUIPMENT LAYOUT	2
C-1C	PROPOSED EQUIPMENT LAYOUT	2
C-2	GENERATOR DETAILS	2
C-3	FENCE DETAILS	2
E-1	ELECTRICAL NOTES	2
E-2	MAIN PANEL SCHEDULE	2
E-2A	SUB-FEED PANEL SCHEDULE	2
E-3	ONE-LINE DIAGRAM	2
E-3A	ONE-LINE DIAGRAM	2
E-4	POWER ROUTING PLAN	2
E-5	GROUNDING PLAN	2
G-1	GROUNDING DETAILS	2
IND	EX OF SHEETS	




326 TRYON ROAD RALEIGH. NC 27603-3530 OFFICE: (919) 661-6351 www.tepgroup.net FL COA # 31011

2	02-26-25	CONSTRUCTION
- 1	02-05-25	PRELIMINARY
0	12-11-24	PRELIMINARY
REV	DATE	ISSUED FOR:

DRAWN BY: SKK CHECKED BY: JHJ

DIGITAL SEAL:

THIS ITEM HAS BEEN DIGITALLY SIGNED AND SEALED BY JOSHUA H. CARDEN ON THE DATE ADJACENT TO THE SEAL. PRINTED COPIES OF THIS DOCUMENT ARE NOT CONSIDERED SIGNED AND SEALED AND THE SIGNATURE MUST BE VERIFIED ON ANY ELECTRONIC COPIES.

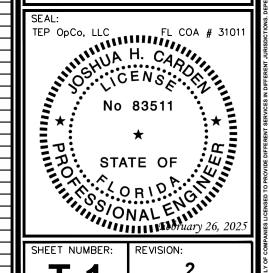

1-1

TEP#: 65257.9566

PROJECT NOTES:

- 1. ALL REFERENCES TO THE OWNER AND/OR LESSEE IN THESE DOCUMENTS SHALL BE CONSIDERED VERIZON OR ITS DESIGNATED REPRESENTATIVE.
- 2. WORK SHALL BE COMPLETED IN ACCORDANCE WITH THE 2023 FLORIDA BUILDING CODE, 8TH EDITION.
- 3. UNLESS SHOWN OR NOTED OTHERWISE ON THE CONTRACT DRAWINGS, OR IN THE SPECIFICATIONS, THE FOLLOWING NOTES SHALL APPLY TO THE MATERIALS LISTED HEREIN, AND TO THE PROCEDURES TO BE USED ON THIS PROJECT.
- 4. ALL HARDWARE ASSEMBLY MANUFACTURER'S INSTRUCTIONS SHALL BE FOLLOWED EXACTLY AND SHALL SUPERSEDE ANY CONFLICTING NOTES ENCLOSED HEREIN.
- 5. ALL DIMENSIONS, ELEVATIONS, AND EXISTING CONDITIONS SHOWN ON THE DRAWINGS SHALL BE FIELD VERIFIED BY THE CONTRACTOR PRIOR TO BEGINNING ANY MATERIALS ORDERING, FABRICATION OR CONSTRUCTION WORK ON THIS PROJECT. CONTRACTOR SHALL NOT SCALE CONTRACT DRAWINGS IN LIEU OF FIELD VERIFICATIONS. ANY DISCREPANCIES SHALL BE IMMEDIATELY BROUGHT TO THE ATTENTION OF THE OWNER AND THE OWNER'S ENGINEER. THE DISCREPANCIES MUST BE RESOLVED BEFORE THE CONTRACTOR IS TO PROCEED WITH THE WORK. THE CONTRACT DOCUMENTS DO NOT INDICATE THE METHOD OF CONSTRUCTION. THE CONTRACTOR SHALL SUPERVISE AND DIRECT THE WORK AND SHALL BE SOLELY RESPONSIBLE FOR ALL CONSTRUCTION MEANS, METHODS, TECHNIQUES, SEQUENCES, AND PROCEDURES. OBSERVATION VISITS TO THE SITE BY THE OWNER AND/OR THE ENGINEER SHALL NOT INCLUDE INSPECTION OF THE PROTECTIVE MEASURES OR THE PROCEDURES.
- 6. ALL MATERIALS AND EQUIPMENT FURNISHED SHALL BE NEW AND OF GOOD QUALITY, FREE FROM FAULTS AND DEFECTS AND IN CONFORMANCE WITH THE CONTRACT DOCUMENTS. ANY AND ALL SUBSTITUTIONS MUST BE PROPERLY APPROVED AND AUTHORIZED IN WRITING BY THE OWNER AND ENGINEER PRIOR TO INSTALLATION. THE CONTRACTOR SHALL FURNISH SATISFACTORY EVIDENCE AS TO THE KIND AND QUALITY OF THE MATERIALS AND EQUIPMENT BEING SUBSTITUTED.
- 7. THE CONTRACTOR SHALL BE RESPONSIBLE FOR INITIATING, MAINTAINING, AND SUPERVISING ALL SAFETY PRECAUTIONS AND PROGRAMS IN CONNECTION WITH THE WORK. THE CONTRACTOR IS RESPONSIBLE FOR ENSURING THAT THIS PROJECT AND RELATED WORK COMPLIES WITH ALL APPLICABLE LOCAL, STATE, AND FEDERAL SAFETY CODES AND REGULATIONS GOVERNING THIS WORK.
- 8. ACCESS TO THE PROPOSED WORK SITE MAY BE RESTRICTED. THE CONTRACTOR SHALL COORDINATE INTENDED CONSTRUCTION ACTIVITY, INCLUDING WORK SCHEDULE AND MATERIALS ACCESS, WITH THE RESIDENT LEASING AGENT FOR APPROVAL.
- 9. ALL PERMITS THAT MUST BE OBTAINED ARE THE RESPONSIBILITY OF THE CONTRACTOR. THE CONTRACTOR WILL BE RESPONSIBLE FOR ABIDING BY ALL CONDITIONS AND REQUIREMENTS OF THE PERMITS.
- 10. IF APPLICABLE, ALL CONCRETE WORK SHALL COMPLY TO LOCAL CODES AND THE ACI 318-14, "BUILDING REQUIREMENTS FOR STRUCTURAL CONCRETE".
- 11. ALL TOWER DIMENSIONS SHALL BE VERIFIED WITH THE PLANS (LATEST REVISION) PRIOR TO COMMENCING CONSTRUCTION. NOTIFY THE ENGINEER IMMEDIATELY IF ANY DISCREPANCIES ARE DISCOVERED. A DESIGNATED RESPONSIBLE EMPLOYEE SHALL BE AVAILABLE FOR CONTACT BY GOVERNING AGENCY INSPECTORS.
- 12. ALL TOWER MODIFICATION WORK SHALL BE IN ACCORDANCE WITH TIA-1019-A STANDARD FOR INSTALLATION, ALTERATION AND MAINTENANCE OF ANTENNA SUPPORTING STRUCTURES AND ANTENNAS.

PLANS PREPARED FOR:



4700 EXCHANGE COURT, SUITE 100 BOCA RATON, FL 33431 (561) 995-5539

PROJECT INFORMATION:

VZW SITE #: 5000242839 VZW SITE NAME: ADOLPHUS WARFIELD RELO

525 SOUTHARD STREET KEY WEST, FL 33040 (MONROE COUNTY)


PLANS PREPARED BY:



326 TRYON ROAD RALEIGH, NC 27603-3530 OFFICE: (919) 661-6351 www.tepgroup.net FL COA # 31011

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- 1	02-05-25	PRELIMINARY
2	02-26-25	CONSTRUCTION

DRAWN BY: SKK CHECKED BY: JHJ

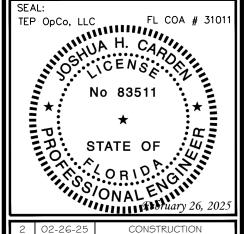SHEET TITLE:


PROJECT NOTES

SHEET NUMBER:

N-1

REVISION:

TEP#: 65257.956655

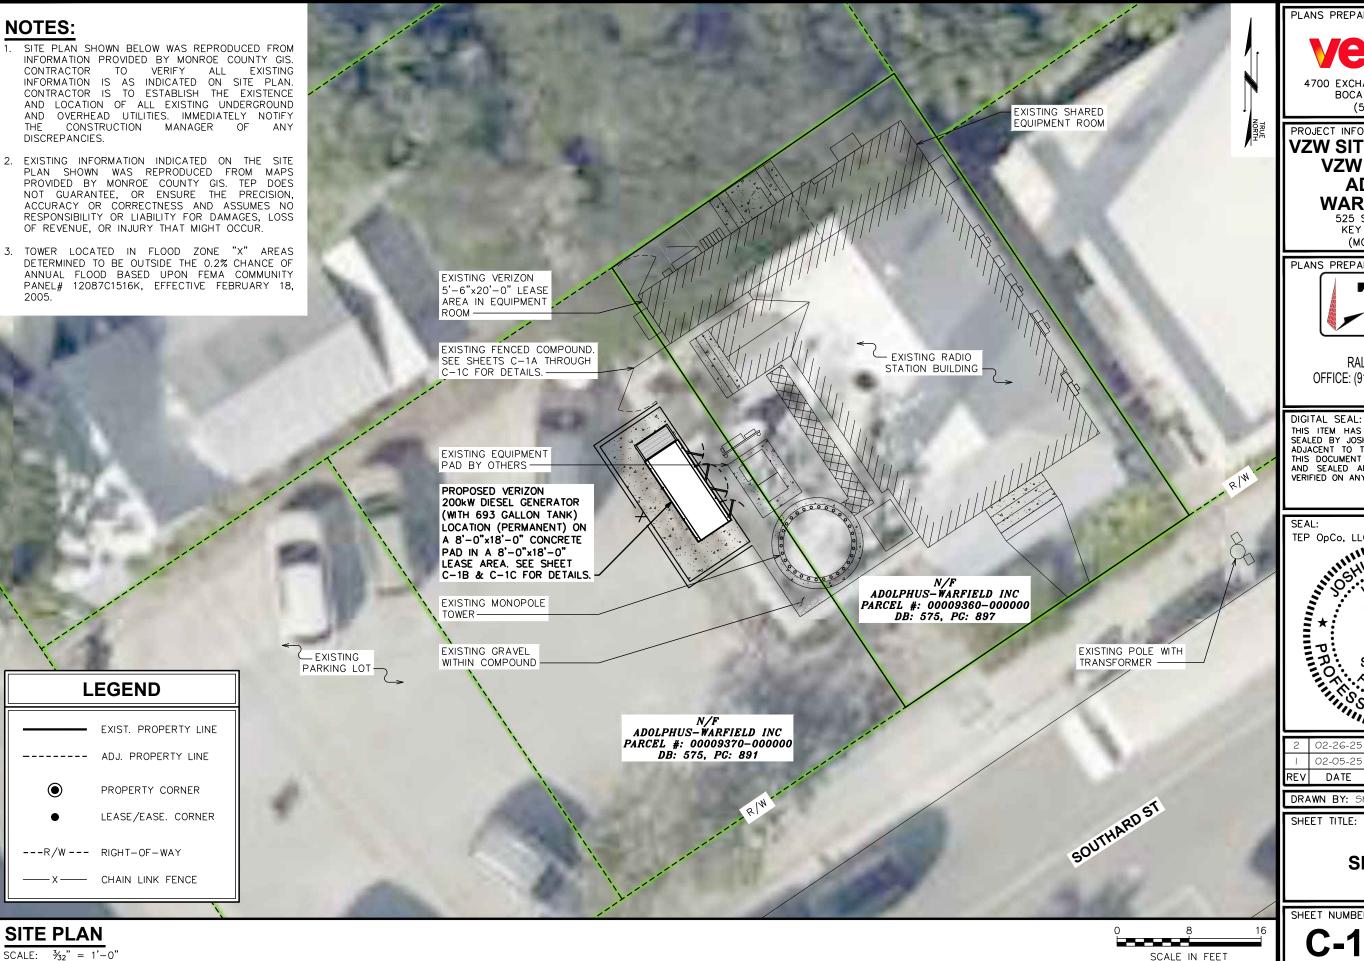

PLANS PREPARED FOR:

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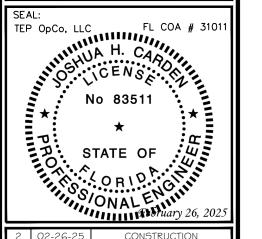
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SITE PLAN


SHEET NUMBER:

REVISION:

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EQUIPMENT LAYOUT SHOWN BELOW BASED ON DOCUMENTS PROVIDED BY VERIZON WIRELESS.



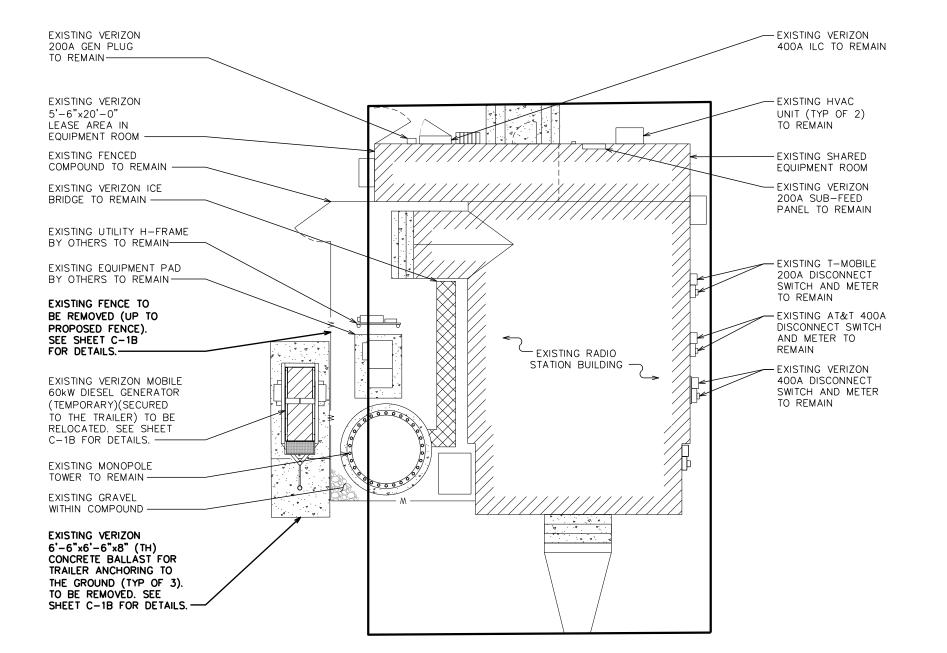

PLANS PREPARED FOR:



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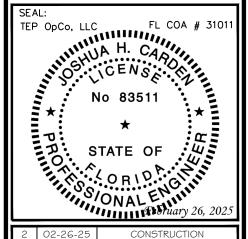
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EXISTING EQUIPMENT LAYOUT

SHEET NUMBER:

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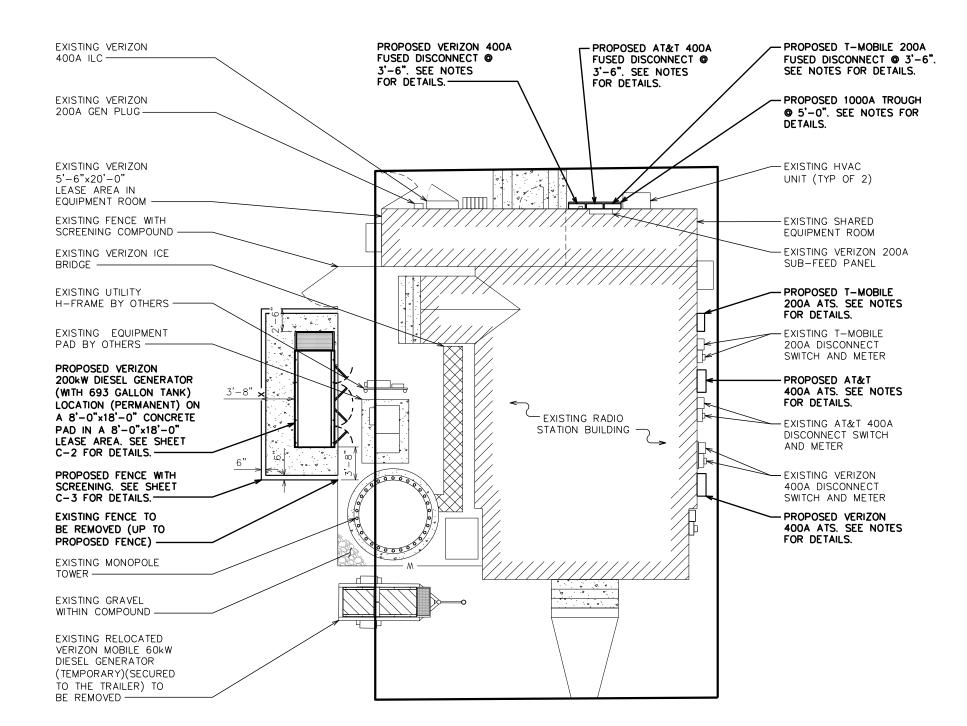
EXISTING EQUIPMENT LAYOUT

SCALE IN FEET

SCALE: $\frac{3}{32}$ " = 1'-0"

- . EQUIPMENT LAYOUT SHOWN BELOW BASED ON DOCUMENTS PROVIDED BY VERIZON WIRELESS.
- 2. CONTRACTOR TO INSTALL EQUIPMENT PER MANUFACTURER'S SPECIFICATIONS.





PLANS PREPARED FOR:



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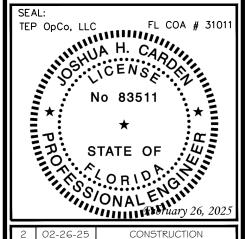


RALEIGH, NC 27603-3530 OFFICE: (919) 661-6351 www.tepgroup.net FL COA # 31011

326 TRYON ROAD

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SHEET TITLE:

INSTALLATION EQUIPMENT LAYOUT

SHEET NUMBER:

REVISION:

-1B

TEP#: 65257.9566

INSTALLATION EQUIPMENT LAYOUT


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COALE IN EEET

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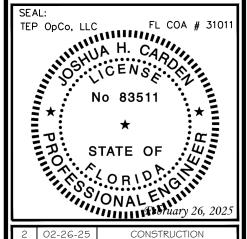
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PROPOSED EQUIPMENT LAYOUT

SHEET NUMBER:

REVISION:

TEP#: 65257.956655

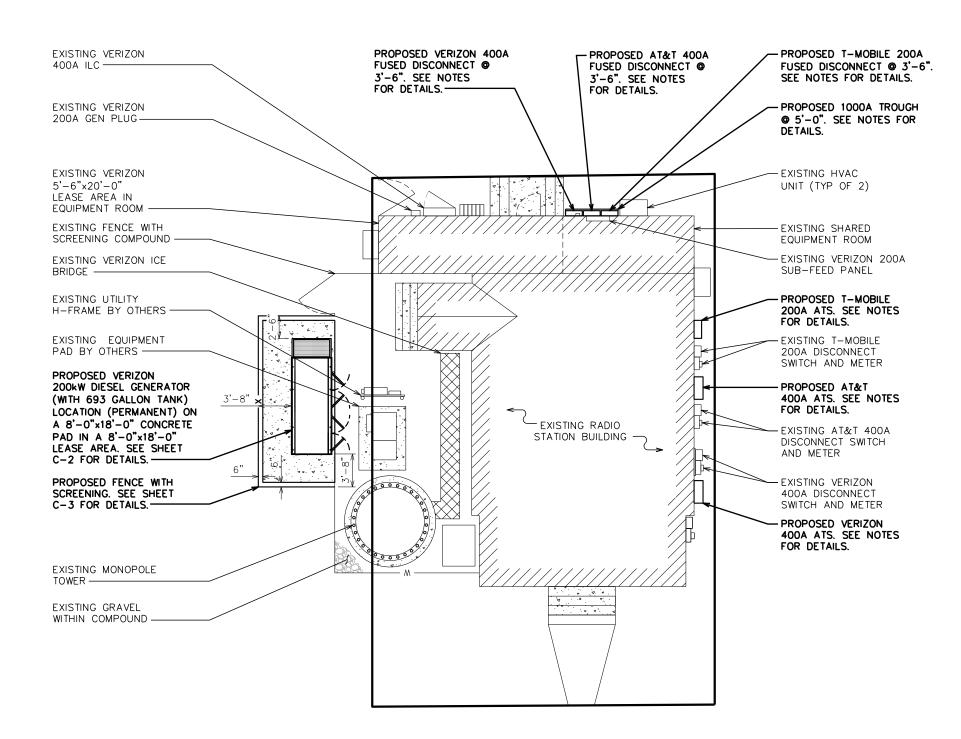PROPOSED EQUIPMENT LAYOUT

SCALE: $\frac{3}{32}$ " = 1'-0

0 8 1

SCALE IN FEET

200kW DIESEL GENERATOR BY GENERAC INDUSTRIAL POWER (P/N: SD200). CONTRACTOR TO VERIFY DIMENSIONS WITH MANUFACTURER.

> SD200 | 8.7L | 200 kW INDUSTRIAL DIESEL GENERATOR SET

GENERAC INDUSTRIAL

EPA Certified Stationary Emergency

Standby Power Rating 200 kW, 250 kVA, 60 Hz

Prime Power Rating* 180 kW, 225 kVA, 60 Hz





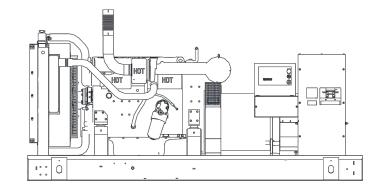


Image used for illustration purposes only

Codes and Standards

Generac products are designed to the following standards:



UL2200, UL508, UL142, UL489



CSA 22.2



BS5514 and DIN 6271



SAE J1349



NFPA 37, 70, 99, 110



NEC700, 701, 702, 708



ISO 3046, 7637, 8528, 9001



NEMA ICS10, MG1, 250, ICS6, AB1



ANSI C62.41



IBC 2009, CBC 2010, IBC 2012, os pd ASCE 7-05, ASCE 7-10, ICC-ES AC-156 (2012)

Powering Ahead

For over 50 years, Generac has provided innovative design and superior manufacturing.

Generac ensures superior quality by designing and manufacturing most of its generator components, including alternators, enclosures and base tanks, control systems and communications software.

Generac gensets utilize a wide variety of options, configurations and arrangements, allowing us to meet the standby power needs of practically every application.


Generac searched globally to ensure the most reliable engines power our generators. We choose only engines that have already been proven in heavy-duty industrial applications under adverse conditions.


Generac is committed to ensuring our customers' service support continues after their generator purchase.

SD200 | 8.7L | 200 kW INDUSTRIAL DIESEL GENERATOR SET


EPA Certified Stationary Emergency


DIMENSIONS AND WEIGHTS*

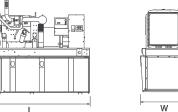

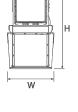



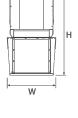

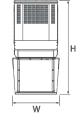



OPEN SET (Includes Exhaust Flex)

Time Hours	Capacity Gal (L)	L x W x H (in (mm)	Weight lbs (kg)
No Tank	-	128 (3,251) x 54 (1,372) x 58 (1,473)	4,465 (2,025)
10	153 (579.2)	128 (3,251) x 54 (1,372) x 71 (1,803)	5,470 (2,481)
25	372 (1,407)	128 (3,251) x 54 (1,372) x 83 (2,108)	5,892 (2,673)
40	589 (2,227)	128 (3,251) x 54 (1,372) x 95 (2,413)	6,309 (2,862)
47	693 (2,623.3)	136 (3,454) x 54 (1,372) x 95 (2,413)	6,060 (2,749)
64	946 (3,581)	208 (5,283) x 54 (1,372) x 99 (2,515)	7,490 (3,397)
90	1.325 (5.015.7)	278 (7.061) x 54 (1.372) x 99 (2.515)	8.505 (3.858)

GENERAC INDUSTRIAL

STANDARD ENCLOSURE

Run Time	Usable	LxWxH (in (mm)		lbs (kg) ure Only
Hours	Capacity Gal (L)		Steel	Aluminum
No Tank	-	155 (3,937) x 54 (1,372) x 70 (1,778)		
10	153 (579.2)	155 (3,937) x 54 (1,372) x 83 (2,108)		
25	372 (1,407)	155 (3,937) x 54 (1,372) x 95 (2,413)	0.14	474
40	589 (2,227)	155 (3,937) x 54 (1,372) x 107 (2,718)	941 (427)	474 (215)
47	693 (2,623.3)	155 (3,937) x 54 (1,372) x 107 (2,718)	(721)	(2.10)
64	946 (3,581)	208 (5,283) x 54 (1,372) x 111 (2,819)		
90	1,325 (5,015.7)	278 (7,061) x 54 (1,372) x 111 (2,819)		

LEVEL 1 ACOUSTIC ENCLOSURE

Run Time	Usable Capacity Gal (L)	L x W x H (in (mm)		: lbs (kg) ure Only
Hours	Gapacity Gai (L)		Steel	Aluminum
No Tank	-	180 (4,572) x 54 (1,372) x 70 (1,778)		
10	153 (579.2)	180 (4,572) x 54 (1,372) x 83 (2,108)		
25	372 (1,407)	180 (4,572) x 54 (1,372) x 95 (2,413)	4.040	000
40	589 (2,227)	180 (4,572) x 54 (1,372) x 107 (2,718)	1,246 (565)	606 (275)
47	693 (2,623.3)	180 (4,572) x 54 (1,372) x 107 (2,718)	(000)	(210)
64	946 (3,581)	234 (5,944) x 54 (1,372) x 111 (2,819)		
90	1,325 (5,015.7)	304 (7,722) x 54 (1,372) x 111 (2,819)		

LEVEL 2 ACCUIGNIC ENCLOSURE

Run Time	Usable Capacity Gal (L)	L x W x H (in (mm)		lbs (kg) ure Only
Hours	GapaGity Gai (L)		Steel	Aluminum
No Tank	-	155 (3,937) x 54 (1,372) x 93 (2,362)		
10	153 (579.2)	155 (3,937) x 54 (1,372) x 106 (2,692)		
25	372 (1,407)	155 (3,937) x 54 (1,372) x 118 (2,997)	4 400	=00
40	589 (2,227)	155 (3,937) x 54 (1,372) x 130 (3,302)	1,482 (672)	708 (321)
47	693 (2,623.3)	155 (3,937) x 54 (1,372) x 130 (3,302)	(012)	(02.1)
64	946 (3,581)	208 (5,283) x 54 (1,372) x 132 (3,353)		
90	1,325 (5,015.7)	278 (7,061) x 54 (1,372) x 132 (3,353)		

All measurements are approximate and for estimation purposes only.

Specification characteristics may change without notice. Dimensions and weights are for preliminary purposes only. Please consult a Generac Power Systems Industrial Dealer for detailed installation drawings

Generac Power Systems, Inc. | P.O.Box 8 | Waukesha, WI 53189 P: (262) 544-4811 @2017 Generac Power Systems, Inc. All rights reserved. All specifications are subject to change without notice Part No. 0K5097 Rev. B 08/14/17 PLANS PREPARED FOR:



4700 EXCHANGE COURT, SUITE 100 BOCA RATON, FL 33431 (561) 995-5539

PROJECT INFORMATION:

VZW SITE #: 5000242839 **VZW SITE NAME: ADOLPHUS WARFIELD RELO**

525 SOUTHARD STREET KEY WEST, FL 33040 (MONROE COUNTY)


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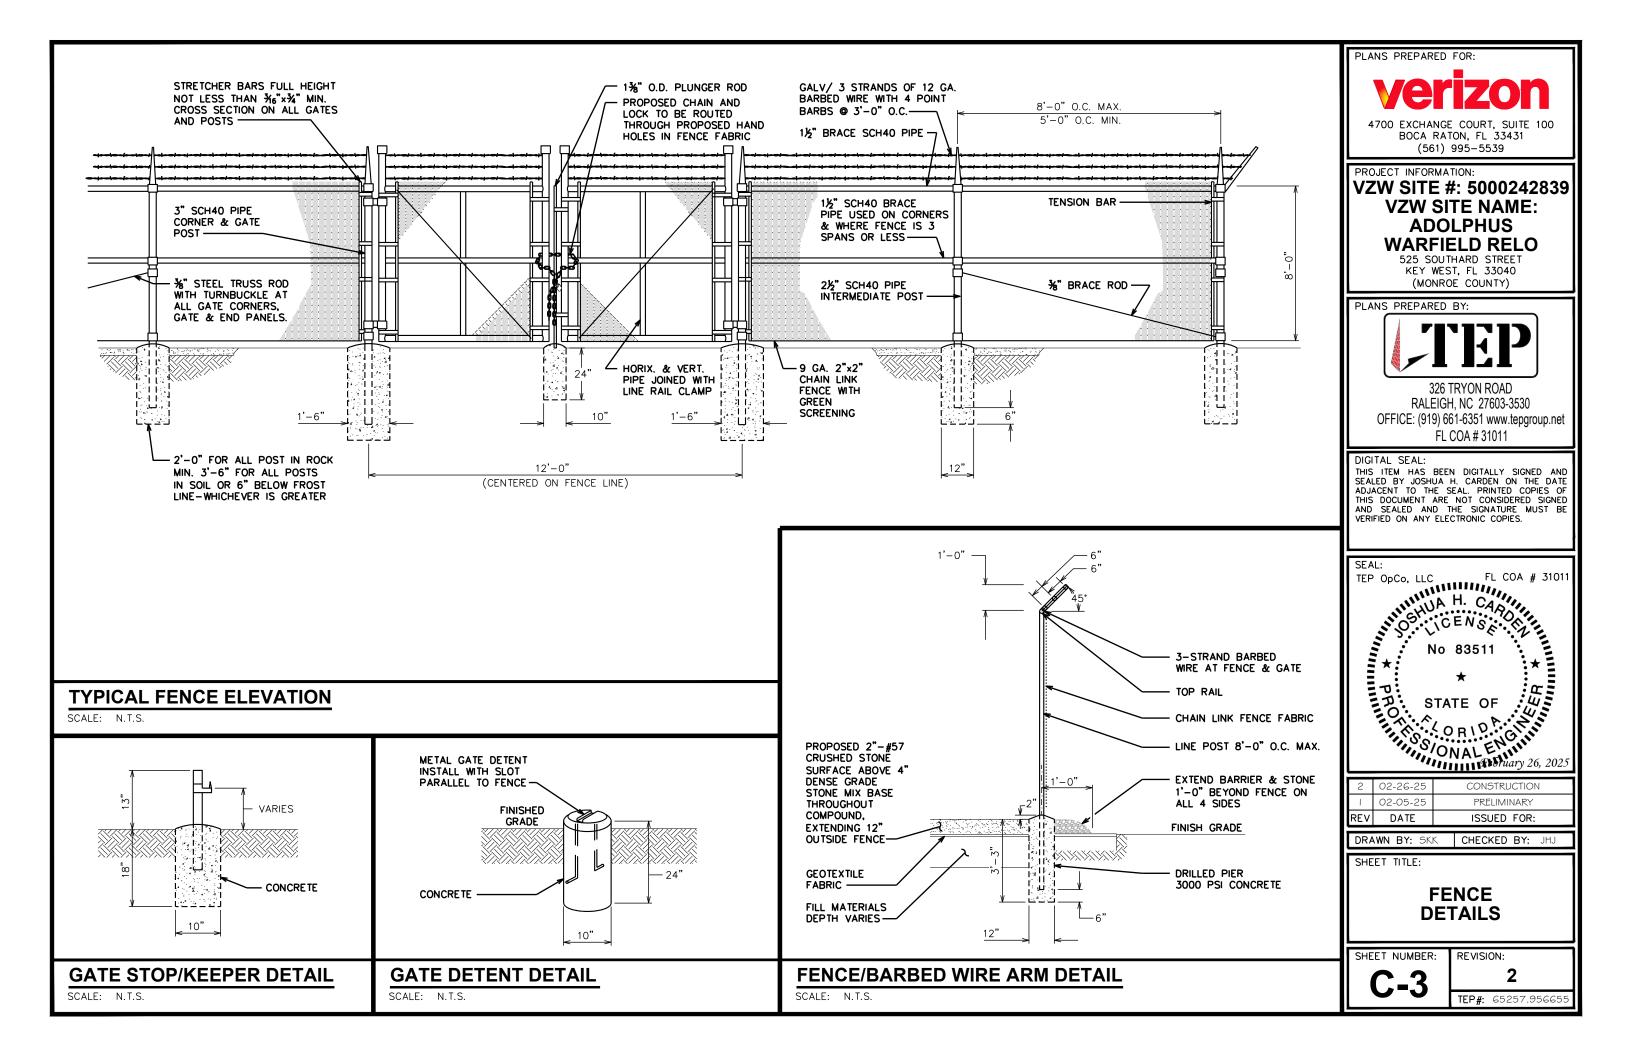
GENERATOR DETAILS

SHEET NUMBER:

REVISION:

TEP#: 65257.9566

GENERATOR DETAILS

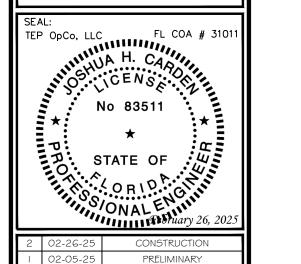

ELECTRICAL NOTES:

SCOPE:

1. PROVIDE LABOR, MATERIALS, INSPECTION, AND TESTING TO PROVIDE CODE COMPLIANCE FOR ELECTRIC, TELEPHONE, AND GROUNDING/LIGHTNING SYSTEMS.

- 1. THE INSTALLATION SHALL COMPLY WITH APPLICABLE LAWS AND CODES. THESE INCLUDE BUT ARE NOT LIMITED TO THE LATEST ADOPTED EDITIONS OF:
 - A. THE NATIONAL ELECTRICAL SAFETY CODE B. THE NATIONAL ELECTRIC CODE - NFPA-70 C. REGULATIONS OF THE SERVING UTILITY COMPANY
- D. LOCAL AND STATE AMENDMENTS E. THE INTERNATIONAL ELECTRIC CODE -IEC (WHERE APPLICABLE)
- 2. PERMITS REQUIRED SHALL BE OBTAINED BY THE CONTRACTOR.
- 3. AFTER COMPLETION AND FINAL INSPECTION OF THE WORK, THE OWNER SHALL BE FURNISHED A CERTIFICATE OF COMPLETION AND APPROVAL.

TESTING:

1. UPON COMPLETION OF THE INSTALLATION, OPERATE AND ADJUST THE EQUIPMENT AND SYSTEMS TO MEET SPECIFIED PERFORMANCE REQUIREMENTS. THE TESTING SHALL BE DONE BY QUALIFIED PERSONNEL.

GUARANTEE:

- 1. IN ADDITION TO THE GUARANTEE OF THE EQUIPMENT BY THE MANUFACTURER, EACH PIECE OF EQUIPMENT SPECIFIED HEREIN SHALL ALSO BE GUARANTEED FOR DEFECTS OF MATERIAL OR WORKMANSHIP OCCURRING DURING A PERIOD OF ONE (1) YEAR FROM FINAL ACCEPTANCE OF THE WORK BY THE OWNER AND WITHOUT EXPENSE TO THE OWNER
- 2. THE WARRANTEE CERTIFICATES & GUARANTEES FURNISHED BY THE MANUFACTURERS SHALL BE TURNED OVER TO THE OWNER.

UTILITY CO-ORDINATION:

1. CONTRACTOR SHALL COORDINATE WORK WITH THE POWER AND TELEPHONE COMPANIES AND SHALL COMPLY WITH THE SERVICE REQUIREMENTS OF EACH UTILITY COMPANY.

EXAMINATION OF SITE:

PRIOR TO BEGINNING WORK, THE CONTRACTOR SHALL VISIT THE SITE OF THE JOB AND SHALL FAMILIARIZE HIMSELF WITH THE CONDITIONS AFFECTING THE PROPOSED ELECTRICAL INSTALLATION AND SHALL MAKE PROVISIONS AS TO THE COST THEREOF. FAILURE TO COMPLY WITH THE INTENT OF THIS SECTION WILL IN NO WAY RELIEVE THE CONTRACTOR OF PERFORMING THE WORK NECESSARY FOR A COMPLETE AND WORKING SYSTEM OR SYSTEMS.

CUTTING, PATCHING AND EXCAVATION:

- COORDINATION OF SLEEVES, CHASES, ETC., BETWEEN SUBCONTRACTORS WILL BE REQUIRED PRIOR TO THE CONSTRUCTION OF ANY PORTION OF THE WORK. CUTTING AND PATCHING OF WALLS, PARTITIONS, FLOORS, AND CHASES IN CONCRETE, WOOD, STEEL OR MASONRY SHALL BE DONE AS PROVIDED ON THE DRAWINGS.
- 2. NECESSARY EXCAVATIONS AND BACKFILLING INCIDENTAL TO THE ELECTRICAL WORK SHALL BE PROVIDED BY THE ELECTRICAL CONTRACTOR UNLESS SPECIFICALLY NOTED OTHERWISE ON THE DRAWING.
- 3. SEAL PENETRATIONS THROUGH RATED WALLS, FLOORS, ETC., WITH APPROVED METHOD AS LISTED BY UL.

RACEWAYS / CONDUITS GENERAL:

- CONDUCTORS SHALL BE INSTALLED IN LISTED RACEWAYS. CONDUIT SHALL BE RIGID STEEL, EMT, SCH40 PVC, OR SCH80PVC AS INDICATED ON THE DRAWINGS. THE RACEWAY SYSTEM SHALL BE COMPLETE COMPLETE BEFORE INSTALLING CONDUCTORS.
- 2. EXTERIOR RACEWAYS AND GROUNDING SLEEVES SHALL BE SEALED AT POINTS OF ENTRANCE AND EXIT. THE RACEWAY SYSTEM SHALL BE BONDED PER NEC.

EXTERIOR CONDUIT:

- 1. EXPOSED CONDUIT SHALL BE NEATLY INSTALLED AND RUN PARALLEL OR PERPENDICULAR TO STRUCTURAL ELEMENTS. SUPPORTS AND MOUNTING HARDWARE SHALL BE HOT DIPPED GALVANIZED STEEL.
- 2. THE CONDUIT SHALL BE RIGID STEEL AT GRADE TRANSITIONS OR WHERE EXPOSED TO DAMAGE
- 3. UNDERGROUND CONDUITS SHALL BE RIGID STEEL, SCH40 PVC, OR SCH80 PVC AS INDICATED ON THE DRAWINGS.
- 4. BURIAL DEPTH OF CONDUITS SHALL BE AS REQUIRED BY CODE FOR EACH SPECIFIC CONDUIT TYPE AND APPLICATION, BUT SHALL NOT BE LESS THAN THE FROST DEPTH AT THE SITE.
- 5. CONDUIT ROUTES ARE SCHEMATIC. CONTRACTOR SHALL FIELD VERIFY ROUTES BEFORE BID. COORDINATE ROUTE WITH WIRELESS CARRIER AND/OR BUILDING OWNER.

INTERIOR CONDUIT:

- 1. CONCEALED CONDUIT IN WALLS OR INTERIOR SPACES ABOVE GRADE MAY BE EMT OR PVC.
- 2. CONDUIT RUNS SHALL USE APPROVED COUPLINGS AND CONNECTORS. PROVIDE INSULATED BUSHING FOR ALL CONDUIT TERMINATIONS, CONDUIT RUNS IN A WET LOCATION SHALL HAVE WATERPROOF FITTINGS.
- 3. PROVIDE SUPPORTS FOR CONDUITS IN ACCORDANCE WITH NEC REQUIREMENTS. CONDUITS SHALL BE SIZED AS REQUIRED BY NEC.

EQUIPMENT:

- 1. DISCONNECT SWITCHES SHALL BE SERVICE ENTRANCE RATED, HEAVY DUTY TYPE.
- 2. CONTRACTOR SHALL VERIFY MAXIMUM AVAILABLE FAULT CURRENT AND COORDINATE INSTALLATION WITH THE LOCAL UTILITY BEFORE STARTING WORK. CONTRACTOR WILL VERIFY THAT EXISTING CIRCUIT BREAKERS ARE RATED FOR MORE THAN AVAILABLE FAULT CURRENT AND REPLACE AS NECESSARY.
- 3. NEW CIRCUIT BREAKERS SHALL BE RATED TO WITHSTAND THE MAXIMUM AVAILABLE FAULT CURRENT AS DETERMINED BY THE LOCAL UTILITY.

CONDUCTORS:

- 1. FURNISH AND INSTALL CONDUCTORS SPECIFIED IN THE DRAWINGS. CONDUCTORS SHALL BE COPPER AND SHALL HAVE TYPE THWN (MIN) (75°C) INSULATION, RATED FOR 600 VOLTS.
- 2. THE USE OF ALUMINUM CONDUCTORS SHALL BE LIMITED TO THE SERVICE FEEDERS INSTALLED BY THE UTILITY.
- 3. CONDUCTORS SHALL BE PROVIDED AND INSTALLED AS FOLLOWS:
 - A. MINIMUM WIRE SIZE SHALL BE #12 AWG.
 - CONDUCTORS SIZE #8 AND LARGER SHALL BE STRANDED. CONDUCTORS SIZED #10 AND #12 MAY BE SOLID OR STRANDED.
 - CONNECTION FOR #10 AWG #12 AWG SHALL BE BY TWISTING TIGHT AND INSTALLING INSULATED PRESSURE OR WIRE NUT CONNECTIONS.
 - CONNECTION FOR #8 AWG AND LARGER SHALL BE BY USE OF STEEL CRIMP-ON SLEEVES WITH NYLON INSULATOR.
- 3. CONDUCTORS SHALL BE COLOR CODED IN ACCORDANCE WITH NEC STANDARDS.

UL COMPLIANCE:

ELECTRICAL MATERIALS, DEVICES, CONDUCTORS, APPLIANCES, AND EQUIPMENT SHALL BE LABELED/LISTED BY UL OR ACCEPTED BY JURISDICTION (I.E., LOCAL COUNTY OR STATE) APPROVED THIRD PARTY TESTING AGENCY.

GROUNDING:

GEN

GPS

KW

PCS

PH

PNL

GENERATOR

GROUND

KILOWATTS

PHASE

PANEL

- GLOBAL POSITIONING SYSTEM

INTERIOR GROUND RING (HALO)

- PERSONAL COMMUNICATION SYSTEM

ISOLATED GROUND BAR

- NATIONAL ELECTRIC CODE

- 1. ELECTRICAL NEUTRALS, RACEWAYS AND NON-CURRENT CARRYING PARTS OF ELECTRICAL EQUIPMENT AND ASSOCIATED ENCLOSURES SHALL BE GROUNDED IN ACCORDANCE WITH NEC ARTICLE 250. THIS SHALL INCLUDE NEUTRAL CONDUCTORS, CONDUITS, SUPPORTS, CABINETS, BOXES, GROUND BUSSES, ETC. THE NEUTRAL CONDUCTOR FOR EACH SYSTEM SHALL BE GROUNDED AT A SINGLE POINT.
- 2. PROVIDE GROUND CONDUCTOR IN RACEWAYS PER NEC.
- 3. PROVIDE BONDING AND GROUND TO MEET NFPA 780 "LIGHTNING PROTECTION" AS A MINIMUM.
- PROVIDE GROUNDING SYSTEM AS INDICATED ON THE DRAWINGS, AS REQUIRED BY THE NATIONAL ELECTRIC CODE, RADIO EQUIPMENT MANUFACTURERS, AND MOTOROLA R56 (AS APPLICABLE).

ABBREVIATIONS AND LEGEND

PNLBD - PANELBOARD AMPERE AFG ABOVE FINISHED GRADE - RIGID NON-METALLIC CONDUIT AUTOMATIC TRANSFER SWITCH - RIGID GALVANIZED STEEL CONDUIT ATS RGS AWG AMERICAN WIRE GAUGE SWITCH BCW BARE COPPER WIRE TGB TOWER GROUND BAR BFG BELOW FINISHED GRADE UL - UNDERWRITERS LABORATORIES BKR BREAKER V VOLTAGE C CONDUIT W WATTS CKT CIRCUIT XFMR - TRANSFORMER DISC XMTR TRANSMITTER DISCONNECT EGR EXTERNAL GROUND RING EMT ELECTRIC METALLIC TUBING FSC FLEXIBLE STEEL CONDUIT

 \boxtimes

---E--- UNDERGROUND ELECTRICAL CONDUIT ---T--- UNDERGROUND TELEPHONE CONDUIT KILOWATT-HOUR METER UNDERGROUND BONDING AND GROUNDING CONDUCTOR Ø GROUND ROD CADWELD

GROUND ROD WITH INSPECTION WELL

SHEET NUMBER: **E**-'

REVISION:

TEP#: 65257.9566

4700 EXCHANGE COURT, SUITE 100 BOCA RATON, FL 33431 (561) 995-5539

PROJECT INFORMATION:

PLANS PREPARED FOR:

VZW SITE #: 5000242839 **VZW SITE NAME: ADOLPHUS** WARFIELD RELO


525 SOUTHARD STREET KEY WEST, FL 33040 (MONROE COUNTY)



326 TRYON ROAD RALEIGH, NC 27603-3530 OFFICE: (919) 661-6351 www.tepgroup.net FL COA # 31011

DIGITAL SEAL:

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2	02-26-25	CONSTRUCTION
-	02-05-25	PRELIMINARY
REV	DATE	ISSUED FOR:

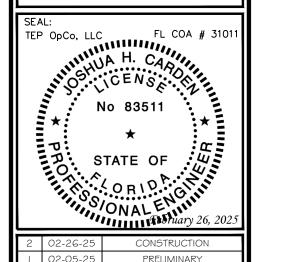CHECKED BY: JHJ DRAWN BY: SKK

SHEET TITLE:

ELECTRICAL NOTES

- 1. ALL CONDUCTORS ARE TYPE THWN (75°C) COPPER.
- 2. MAXIMUM LENGTH OF RUN FOR RECTIFIER CIRCUITS IS 50-FT.
- 3. IF ADDITIONAL FUTURE LOADS ARE ADDED WHICH CAUSE TOTAL DEMAND TO EXCEED GENERATOR BREAKER SIZE, BACKUP POWER SYSTEM SHALL BE EVALUATED AND UPGRADED AS NECESSARY.
- 4. CONFIRM THE BLOCK HEATER AND BATTERY CHARGER BREAKER REQUIREMENTS BEFORE ORDERING EQUIPMENT.

PROPOSED BREAKER/LOAD SHOWN IN BOLD

MAIN PA	NEL	SCH	EDU	LE	-	L(C I	WIT	H 40	0A I	ИСВ	120/240V
LOAD SERVED		MPERES TTS) L2	TRIP	CKT #	P	HAS	iΕ	CKT #	TRIP	VOLT A (WA L1	MPERES TTS) L2	LOAD SERVED
BATTERY CHARGER	1200		20A	1	$\overline{}$	Α	$\overline{\Lambda}$	2	2004	7850		CUD FEED DANIEL
GEN BLOCK HEATER		1500	20A	3		В	\bot	4	200A		7650	SUB-FEED PANEL
-	_		_	5		Α	$\overline{}$	6	_	_		_
_		-	-	7	$\ \ \ \ \ \ \ \ \ \ \ \ \ \ \ \ \ \ \ $	В	$\overline{}$	8	_		-	_
-	_		-	9	$]$ \wedge	Α	$\overline{}$	10	-	_		-
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_		-	1	27	$]$ \wedge	В	$\overline{}$	28	-		1	-
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-	_		ı	37]	Α	\setminus	38	-	_		-
-		-	-	39]	В	\setminus	40	-		1	-
	_		ı	41	\sim	Α	L	42	-	_		-
VOLT AMPS	1200	1500								7850	7650	VOLT-AMPS
	L1	VOLT A	MPERES	90	50		91	50	L2 VOL	T AMPER	RES	
		L	1 AMPS	75	.42		76	.25	L2 AMF	PS		
					7	76.2	5		MAX AN	MPS		
						95.3	1		MAX AN	MPS x12	5%	
									-			

PLANS PREPARED FOR:

4700 EXCHANGE COURT, SUITE 100 BOCA RATON, FL 33431 (561) 995-5539

PROJECT INFORMATION:

VZW SITE #: 5000242839 VZW SITE NAME: ADOLPHUS WARFIELD RELO

525 SOUTHARD STREET KEY WEST, FL 33040 (MONROE COUNTY)


PLANS PREPARED BY:



326 TRYON ROAD RALEIGH, NC 27603-3530 OFFICE: (919) 661-6351 www.tepgroup.net FL COA # 31011

DIGITAL SEAL:

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- 1	02-05-25	PRELIMINARY
REV	DATE	ISSUED FOR:

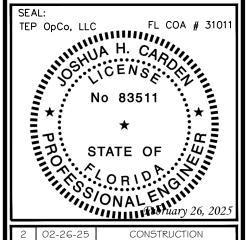DRAWN BY: SKK CHECKED BY: JHJ

SHEET TITLE:

MAIN PANEL SCHEDULE

SHEET NUMBER:

REVISION:

TEP#: 65257.95665

MAIN PANEL SCHEDULE

SCALE: N.T.S.

- 1. ALL CONDUCTORS ARE TYPE THWN (75°C) COPPER.
- 2. MAXIMUM LENGTH OF RUN FOR RECTIFIER CIRCUITS IS 50-FT.
- 3. IF ADDITIONAL FUTURE LOADS ARE ADDED WHICH CAUSE TOTAL DEMAND TO EXCEED GENERATOR BREAKER SIZE, BACKUP POWER SYSTEM SHALL BE EVALUATED AND UPGRADED AS NECESSARY.
- 4. EXISTING LOADING ON THE PANEL IS TAKEN FROM UTILITY BILLS.

SUB-FEED	PAN	EL S	CHE	DL	JLE	E - 2	200	120	/240	V 10	Ø 3W M.C.B.
LOAD SERVED		MPERES TTS) L2	TRIP	CKT #	PH	IASE	CKT #	TRIP	VOLT A (WA L1	MPERES TTS) L2	LOAD SERVED
LTE #1	260	260	20A	3		A B	2 4	20A	260	260	LTE #2
LTE #3	260	260	20A	5 7		A B	6 8	20A	260	260	LTE #4
1900	510	510	40A	9		A B	10	40A	510	510	SPARE
1900	510	510	40A	13 15		A B	14	40A	510	510	SPARE
UNKNOWN	260		20A	17	$\rfloor \wedge \downarrow$	<u> </u>	18	20A	260		SPARE
UNKNOWN		320	25A	19		В	20	20A		260	SPARE
AC/2	770	770	60A	21 23		A B	22	60A	770	770	AC/1
UNKNOWN	390	390	30A	25 27		A B	26	60A	-	_	SURGE (OFF)
POWER/LOSS	260			29		A _	30	20A	260		UNKNOWN
POWER/LUSS		260	20A	31		В	32	20A		260	UNKNOWN
UNKNOWN	260		20A	33		A	34	100A	1280		UNKNOWN
UNKNOWN		260	20A	35		В	36	TOUA		1280	UNKNOWN
-	_		_	37		A _	38	20A	260		UNKNOWN
-		-	_	39		В	40	1		_	-
VOLT AMPS	3480	3540							4370	4110	VOLT-AMPS
	L1	VOLT A	MPERES	78	50	7	'650	L2 VOL	T AMPER	RES	
		L	1 AMPS	65	.42	6	3.75	L2 AMF	PS .		
					65	5.42		MAX AN	MPS		
		81	1.77		MAX AN	MPS x12	5%				



PROJECT INFORMATION:

VZW SITE #: 5000242839 VZW SITE NAME: ADOLPHUS WARFIELD RELO

(561) 995-5539

525 SOUTHARD STREET KEY WEST, FL 33040 (MONROE COUNTY)

PLANS PREPARED BY:



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DRAWN BY: SKK CHECKED BY: JHJ

SHEET TITLE:

SUB-FEED PANEL SCHEDULE

SHEET NUMBER:

REVISION:

Δ 📖

TEP#: 65257.956655


SUB-FEED PANEL SCHEDULE

SCALE: N.T.S.

- 1. FOR COMPLETE INTERNAL WIRING AND ARRANGEMENT, REFER TO VENDOR PRINTS PROVIDED BY EQUIPMENT MANUFACTURER.
- 2. WHEN UTILITY COMPANY REQUIRES A SERVICE DISCONNECT OTHER THAN THE MAIN BREAKER IN POWER PANEL OF THE UTILITY CABINET, REMOVE BONDING JUMPER IN EQUIPMENT CABINETS AND BOND SERVICE DISCONNECT PER NEC REQUIREMENTS.
- 3. CONTRACTOR SHALL REVIEW AND COMPLY WITH MANUFACTURERS EQUIPMENT DRAWINGS FOR ADDITIONAL REQUIREMENTS THAT MAY NOT BE SHOWN
- 4. CONTRACTOR SHALL OBTAIN THE MAXIMUM AVAILABLE FAULT CURRENT AT THE UTILITY SERVICE POINT FROM THE ELECTRIC COMPANY IN WRITING PRIOR TO ORDERING MATERIALS AND ENSURE THE EQUIPMENT WILL HAVE HIGHER RATING WITH A MIN VALUE OF 10,000A.
- 5. THE GROUNDED SERVICE CONDUCTOR SHALL BE GROUNDED AT THE SERVICE DISCONNECT ONLY.
- 6. DO NOT BOND THE NEUTRAL TO GROUND AT THE GENERATOR.
- 7. SIGNAGE MUST BE DISPLAYED ON DISCONNECT "OPENING THE EQUIPMENT DISCONNECT WILL CAUSE THE EMERGENCY GENERATOR TO START. TO REMOVE POWER ENTIRELY FROM EQUIPMENT, THE GENERATOR MUST BE TURNED OFF USING THE GENERATOR STOP SWITCH."

ONE-LINE DIAGRAM NOTES:

- 1. ELECTRICAL SERVICE SHALL BE 200A, 240/120V, 1ø, 3W.
- 2. COMPLY WITH MANUFACTURER SPECIFICATIONS REGARDING WIRING REQUIREMENTS.
- 3. CONDUCTOR SIZES BASED ON TYPICAL CONFIGURATIONS. CONTRACTOR WILL VERIFY WITH MANUFACTURER SPECIFICATIONS BEFORE ORDERING OR INSTALLING PARTS.
- 4. WIRE COUNT IS BASED ON EQUIPMENT SPECIFICATIONS PROVIDED BY VERIZON WIRELESS.
- 5. NEUTRAL CONDUCTORS TO THE RECTIFIERS WERE LEFT OFF AT THE ADVICE OF VERIZON WIRELESS EQUIPMENT ENGINEER. CONTRACTOR TO VERIFY WIRING REQUIREMENTS WITH RECTIFIER MANUFACTURER SPECIFICATIONS.
- 6. EXISTING GROUNDING ELECTRODE CONDUCTOR & MAIN BONDING JUMPER. CONTRACTOR TO VERIFY EXISTENCE AND LOCATION.
- CONDUCTOR SIZED BASED ON A MAXIMUM GENERATOR BREAKER RATING OF 1000A.

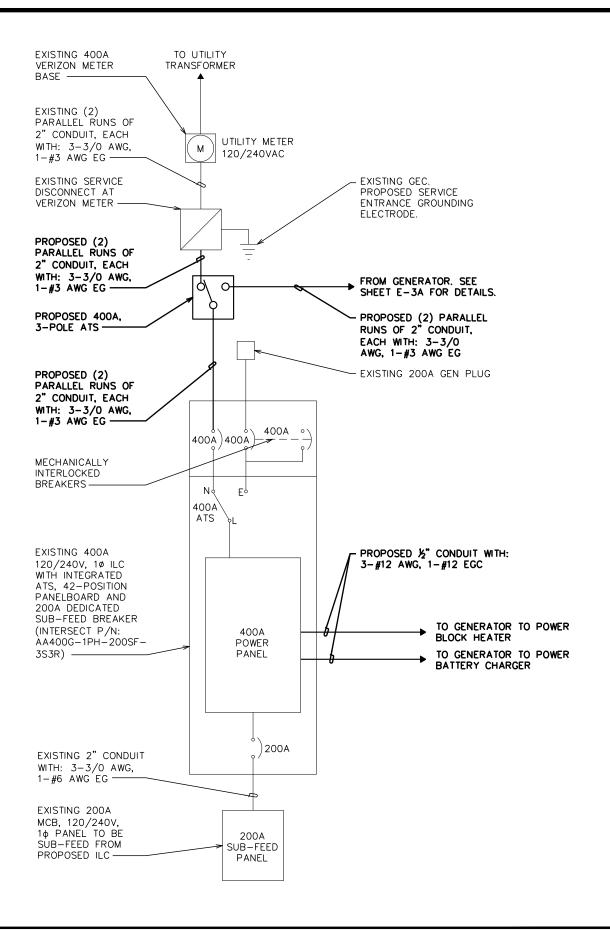

PLANS PREPARED FOR:



4700 EXCHANGE COURT, SUITE 100 BOCA RATON, FL 33431 (561) 995-5539

PROJECT INFORMATION:

VZW SITE #: 5000242839 VZW SITE NAME: ADOLPHUS WARFIELD RELO

525 SOUTHARD STREET KEY WEST, FL 33040 (MONROE COUNTY)

PLANS PREPARED BY:




RALEIGH, NC 27603-3530 OFFICE: (919) 661-6351 www.tepgroup.net FL COA # 31011

326 TRYON ROAD

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DRAWN BY: SKK CHECKED BY: JHJ

SHEET TITLE:

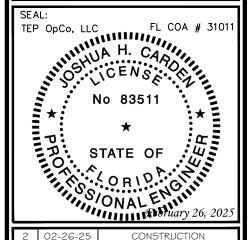ONE-LINE DIAGRAM

SHEET NUMBER:

REVISION:

E-3

TEP#: 65257.956655

ELECTRICAL ONE-LINE DIAGRAM


SCALE: N.T.S

NOTES:

- 1. FOR COMPLETE INTERNAL WIRING AND ARRANGEMENT, REFER TO VENDOR PRINTS PROVIDED BY EQUIPMENT MANUFACTURER.
- 2. WHEN UTILITY COMPANY REQUIRES A SERVICE DISCONNECT OTHER THAN THE MAIN BREAKER IN POWER PANEL OF THE UTILITY CABINET, REMOVE BONDING JUMPER IN EQUIPMENT CABINETS AND BOND SERVICE DISCONNECT PER NEC REQUIREMENTS.
- 3. CONTRACTOR SHALL REVIEW AND COMPLY WITH MANUFACTURERS EQUIPMENT DRAWINGS FOR ADDITIONAL REQUIREMENTS THAT MAY NOT BE SHOWN
- 4. CONTRACTOR SHALL OBTAIN THE MAXIMUM AVAILABLE FAULT CURRENT AT THE UTILITY SERVICE POINT FROM THE ELECTRIC COMPANY IN WRITING PRIOR TO ORDERING MATERIALS AND ENSURE THE EQUIPMENT WILL HAVE HIGHER RATING WITH A MIN VALUE OF 10,000A.
- 5. SIGNAGE MUST BE DISPLAYED ON DISCONNECT "OPENING THE EQUIPMENT DISCONNECT WILL CAUSE THE EMERGENCY GENERATOR TO START. TO REMOVE POWER ENTIRELY FROM EQUIPMENT, THE GENERATOR MUST BE TURNED OFF USING THE GENERATOR STOP SWITCH."

ONE-LINE DIAGRAM NOTES:

- 1. ELECTRICAL SERVICE SHALL BE 240/120V, 1ø, 3W,
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- CONDUCTOR SIZES BASED ON TYPICAL CONFIGURATIONS. CONTRACTOR WILL VERIFY WITH MANUFACTURER SPECIFICATIONS BEFORE ORDERING OR INSTALLING PARTS.
- 4. WIRE COUNT IS BASED ON EQUIPMENT SPECIFICATIONS PROVIDED BY VERIZON WIRELESS.
- 5. NEUTRAL CONDUCTORS TO THE RECTIFIERS WERE LEFT OFF AT THE ADVICE OF VERIZON WIRELESS EQUIPMENT ENGINEER. CONTRACTOR TO VERIFY WIRING REQUIREMENTS WITH RECTIFIER MANUFACTURER SPECIFICATIONS.
- 6. EXISTING GROUNDING ELECTRODE CONDUCTOR & MAIN BONDING JUMPER. CONTRACTOR TO VERIFY EXISTENCE AND LOCATION.
- 7. CONDUCTOR SIZED BASED ON A MAXIMUM GENERATOR BREAKER RATING OF 1000A. VERIFY THE GENERATOR BREAKER RATING BEFORE ORDERING EQUIPMENT.
- 8. ALL ATS MUST BE 3-POLE (SWITCHED NEUTRAL).

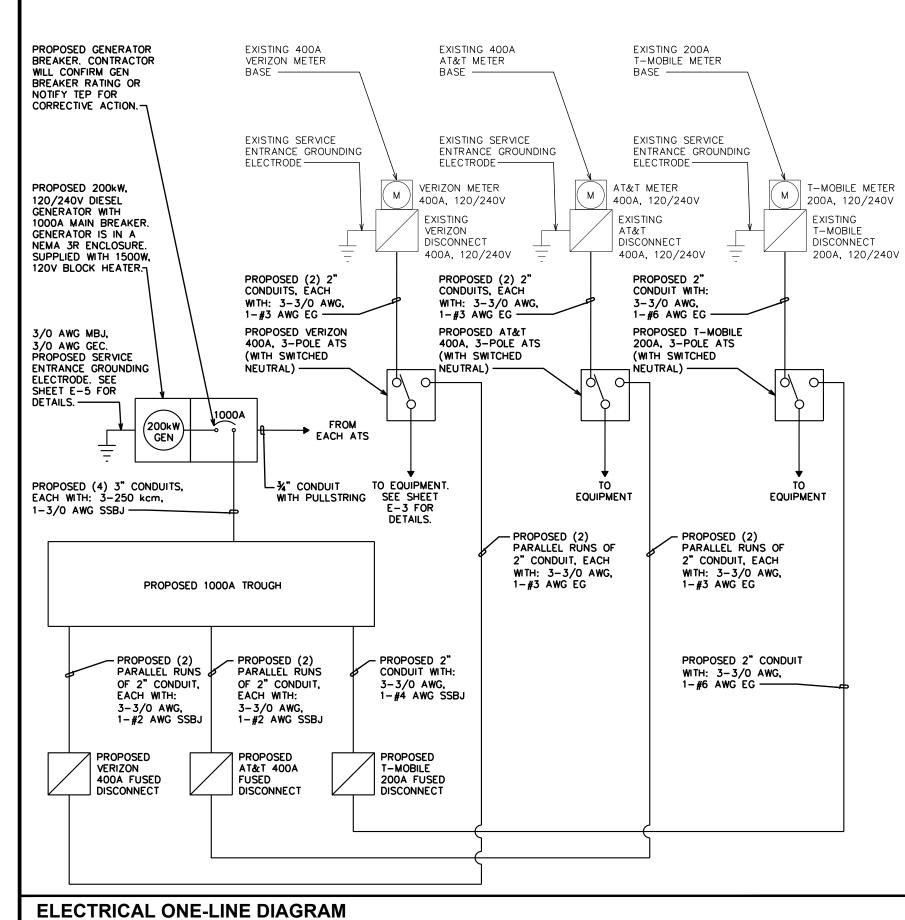

PLANS PREPARED FOR:



4700 EXCHANGE COURT, SUITE 100 BOCA RATON, FL 33431 (561) 995-5539

PROJECT INFORMATION:

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525 SOUTHARD STREET KEY WEST, FL 33040 (MONROE COUNTY)

PLANS PREPARED BY:

326 TRYON ROAD

RALEIGH, NC 27603-3530 OFFICE: (919) 661-6351 www.tepgroup.net FL COA # 31011

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 2
 02-26-25
 CONSTRUCTION

 I
 02-05-25
 PRELIMINARY

 REV
 DATE
 ISSUED FOR:

DRAWN BY: SKK CHECKED BY: JHJ

SHEET TITLE:

ONE-LINE DIAGRAM

SHEET NUMBER:

REVISION:

TEP#: 65257.956655

LABEL LIST:

- (4)-3" CONDUITS FOR POWER FROM GENERATOR TO 1000A TROUGH
- (2)-2" CONDUITS FOR POWER FROM 1000A TROUGH TO 400A VERIZON FUSED DISCONNECT
- (2)-2" CONDUITS FOR POWER FROM 1000A TROUGH TO 400A AT&T FUSED DISCONNECT
- (1)-2" CONDUIT FOR POWER FROM 1000A TROUGH TO 200A T-MOBILE FUSED DISCONNECT
- (2)-2" CONDUITS FOR POWER FROM 400A VERIZON FUSED DISCONNECT TO PROPOSED VERIZON 400A ATS
- (2)-2" CONDUITS FOR POWER FROM 400A VERIZON FUSED DISCONNECT TO PROPOSED VERIZON 400A ATS
- (1)-2" CONDUIT FOR POWER FROM 200A T-MOBILE FUSED DISCONNECT TO PROPOSED T-MOBILE 200A ATS
- (2)-2" CONDUITS FOR POWER FROM 200A T-MOBILE ATS TO EXISTING 200A T-MOBILE METER/DISCONNECT
- (2)-2" CONDUITS FOR POWER FROM 400A AT&T ATS TO EXISTING 400A AT&T METER/DISCONNECT
- (2)-2" CONDUITS FOR POWER FROM 400A VERIZON ATS TO EXISTING 400A VERIZON METER/DISCONNECT
- (2)-2" CONDUITS FOR POWER FROM 400A VERIZON ATS TO EXISTING 400A ILC
- $(2)-\frac{1}{2}$ " CONDUITS FOR BLOCK HEATER AND BATTERY CHARGER FROM 400A PANEL TO GENERATOR
- $(1)-\frac{3}{4}$ " CONDUIT WITH PULLSTRING FROM EACH ATS TO GENERATOR


NOTES:

- POWER AND TELCO CONDUITS RECEIVING CONDUCTORS BY OTHERS TO HAVE PULL ROPES.
- 2. ALL TELCO CONDUITS ARE TO BE STUBBED IN D-MARC LOCATION.
- ALL POWER CONDUITS ARE TO BE TERMINATED AT THE METER CENTER.
- THE CONTRACTOR SHALL LOCATE ALL EXISTING UTILITIES PRIOR TO TRENCHING. ANY DAMAGE CAUSED TO THE EXISTING UTILITIES SHALL BE REPAIRED AT THE CONTRACTOR'S EXPENSE.
- ALL CONDUITS SHALL BE INSTALLED PRIOR TO FINISH GRADING, GEOFABRIC, AND STONE INSTALLATION.

GENERATOR

- CONTRACTOR SHALL INSTALL SWEEPS AT ALL CONDUIT DIRECTION CHANGES UNLESS NOTED OTHERWISE.
- 7. RUN CONDUITS FROM ILC TO GENERATOR UNDERGROUND AND STUB UP CONDUITS MINIMUM 6" HIGH INSIDE GENERATOR BASE AND TERMINATE WITH MALE ADAPTER AND THREADED BUSHING.
- 8. WHEN ALL RRUS ARE GROUND MOUNTED, OMIT OVPS AND RUN FIBER/POWER FROM CONSOLIDATED POWER AND EQUIPMENT CABINET DIRECTLY TO RRUS.



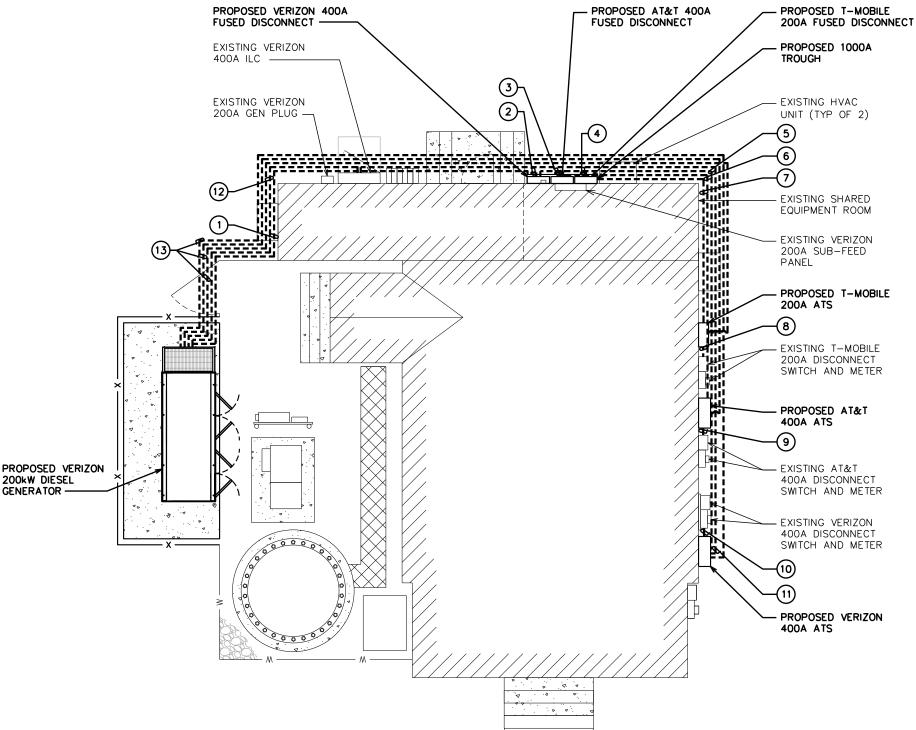

PLANS PREPARED FOR:

4700 EXCHANGE COURT, SUITE 100 BOCA RATON, FL 33431 (561) 995-5539

PROJECT INFORMATION:

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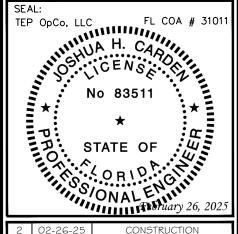
525 SOUTHARD STREET KEY WEST, FL 33040 (MONROE COUNTY)



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DRAWN BY: SKK CHECKED BY: JHJ

SHEET TITLE:

POWER ROUTING PLAN

SHEET NUMBER:

SCALE IN FEET

REVISION:

TEP#: 65257.9566

POWER ROUTING PLAN

LABEL LIST:

- EXISTING GROUND RING. CONTRACTOR TO VERIFY EXISTENCE AND DEPTH.
- 2 PROPOSED #2 SBTC GROUND WIRE FROM OUTDOORS EQUIPMENT TO GROUND RING OR GROUND ROD (TYP)
- (3) PROPOSED 3/0 AWG GEC FOR PROPOSED GENERATOR

NOTE:

THIS IS A GRAPHIC REPRESENTATION. CONTRACTOR TO VERIFY DIMENSIONS AND EQUIPMENT ON—SITE PRIOR TO CONSTRUCTION



PLANS PREPARED FOR:

verizon

4700 EXCHANGE COURT, SUITE 100 BOCA RATON, FL 33431 (561) 995-5539

PROJECT INFORMATION:

VZW SITE #: 5000242839 VZW SITE NAME: ADOLPHUS WARFIELD RELO

525 SOUTHARD STREET KEY WEST, FL 33040 (MONROE COUNTY)

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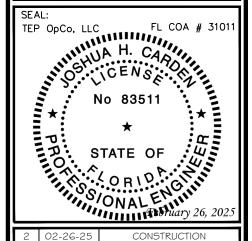


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SHEET TITLE:

GROUNDING PLAN

SHEET NUMBER:

REVISION:

E-5

2

TEP#: 65257.956655

CADWELD
GROUND ROD
GROUND ROD WITH
INSPECTION WELL

LUG FOR EQUIPMENT

LEGEND

GROUNDING
---- GROUND RING

GROUND BAR


GROUNDING PLAN

SCALE: $\frac{1}{8}$ " = 1'-0"

Ø

 \boxtimes

0 8 16 SCALE IN FEET

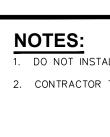


DO NOT INSTALL COAX GROUND KIT AT A BEND.


2. CONTRACTOR TO WEATHERPROOF COAX GROUND.

GROUNDING DETAILS

SCALE: N.T.S.

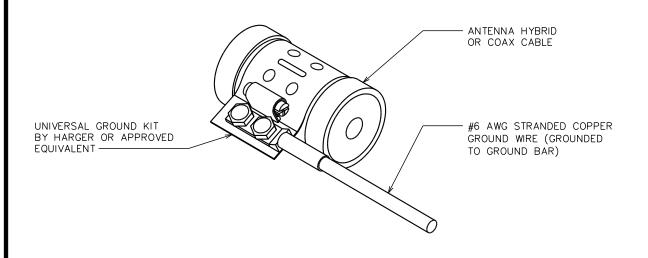

NOTE:

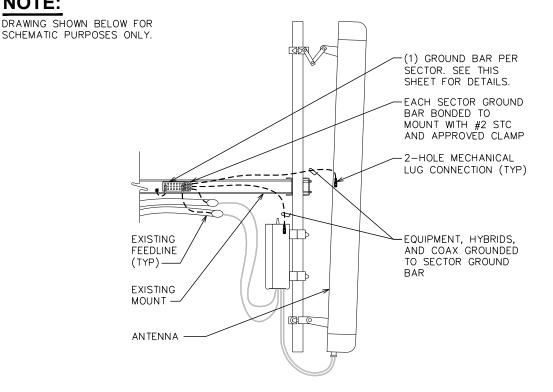

PLANS PREPARED FOR:



4700 EXCHANGE COURT, SUITE 100 BOCA RATON, FL 33431 (561) 995-5539

PROJECT INFORMATION:

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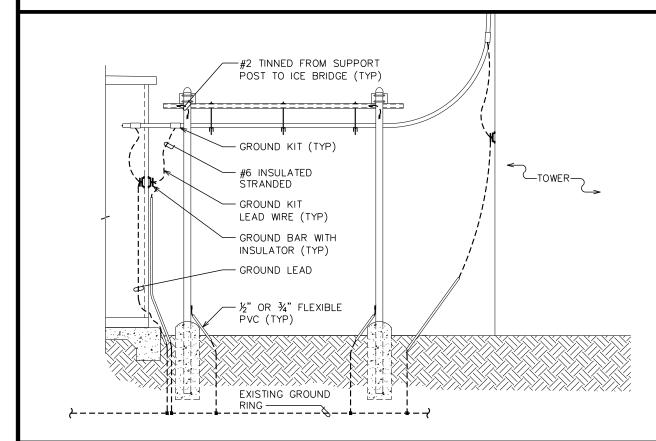
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ANTENNA & EQUIPMENT GROUNDING DETAIL

SCALE: N.T.S.



% - 11x1" H.H.C.S. BOLT, WALL MOUNTING BRACKET. NEWTON INSTRUMENT CO. NEWTON INSTRUMENT CO. (CAT.# 3012-1) -(CAT. # A-6056)INSULATORS, NEWTON INSTRUMENT CO. (CAT.# 3061-4) %" LOCKWASHER, NEWTON INSTRUMENT CO. (CAT.# 3015-8)-COPPER GROUND BAR 1/4"x4"x20" MIN. NEWTON INSTRUMENT CO. CAT.# B-6142. HOLE CENTERS TO MATCH NEMA DOUBLE LUG CONFIGURATION.

NOTES:

- GROUND BAR SHALL BE SIZED TO ACCOMMODATE ALL GROUNDING CONNECTIONS REQUIRED AS WELL AS PROVIDE 50% SPARE CAPACITY.
- ALL RACKS AND EQUIPMENT CABINETS ARE TO HAVE TWO GROUNDING LEADS. ALL EQUIPMENT INSTALLED IN RACKS MUST HAVE A CHASSIS GROUND ATTACHED TO A COMMON BUS BAR ON THE RACK. COMMON BUS BAR MUST BE GROUNDED TO MAIN GROUND BAR.

TEP OpCo, LLC FL COA # 310 A H. CAN No 83511 * STATE OF OR 10 ONAL

SEAL:

PRELIMINARY ISSUED FOR: DATE

DRAWN BY: SKK CHECKED BY: JHJ

SHEET TITLE:

GROUNDING DETAILS

SHEET NUMBER:

REVISION:

G-' TEP#: 65257.9566

STANDARD GROUND BAR DETAILS

ICE BRIDGE/HYBRID/COAX/GROUNDING BAR ELEVATION

Standby Power Rating 200 kW, 250 kVA, 60 Hz

Prime Power Rating*
180 kW, 225 kVA, 60 Hz





*EPA Certified Prime ratings are not available in the US or its Territories

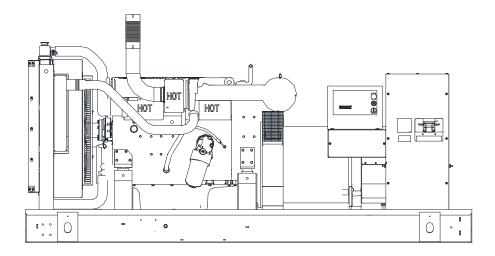


Image used for illustration purposes only

Codes and Standards

Generac products are designed to the following standards:





UL2200, UL508, UL142, UL489



CSA 22.2





BS5514 and DIN 6271



SAE J1349



NFPA 37, 70, 99, 110



NEC700, 701, 702, 708



ISO 3046, 7637, 8528, 9001



NEMA ICS10, MG1, 250, ICS6, AB1



ANSI C62.41



IBC 2009, CBC 2010, IBC 2012, ASCE 7-05, ASCE 7-10, ICC-ES AC-156 (2012)

Powering Ahead

For over 50 years, Generac has provided innovative design and superior manufacturing.

Generac ensures superior quality by designing and manufacturing most of its generator components, including alternators, enclosures and base tanks, control systems and communications software.

Generac gensets utilize a wide variety of options, configurations and arrangements, allowing us to meet the standby power needs of practically every application.

Generac searched globally to ensure the most reliable engines power our generators. We choose only engines that have already been proven in heavy-duty industrial applications under adverse conditions.

Generac is committed to ensuring our customers' service support continues after their generator purchase.

INDUSTRIAL DIESEL GENERATOR SET

EPA Certified Stationary Emergency

STANDARD FEATURES

ENGINE SYSTEM

- · Oil Drain Extension
- Air Cleaner
- Fan Guard
- Stainless Steel Flexible Exhaust Connection
- Factory Filled Oil
- Radiator Duct Adapter (Open Set Only)
- Critical Exhaust Silencer (Enclosed Only)

Fuel System

- · Fuel Lockoff Solenoid
- · Primary Fuel Filter

Cooling System

- · Closed Coolant Recovery System
- UV/Ozone Resistant Hoses
- · Factory-Installed Radiator
- Radiator Drain Extension
- 50/50 Ethylene Glycol Antifreeze
- 120 VAC Coolant Heater

Electrical System

- Battery Charging Alternator
- Battery Cables
- Battery Tray
- Rubber-Booted Engine Electrical Connections
- Solenoid Activated Starter Motor

ALTERNATOR SYSTEM

- GENprotect[™]
- 12 Leads (3-Phase, Non 600V)
- · Class H Insulation Material
- Vented Rotor
- 2/3 Pitch
- Skewed Stator
- Auxiliary Voltage Regulator Power Winding
- Permanent Magnet Excitation
- Sealed Bearings
- Automated Manufacturing (Winding, Insertion, Lacing, Varnishing)
- · Rotor Dynamically Spin Balanced
- · Amortisseur Winding
- Full Load Capacity Alternator
- · Protective Thermal Switch

GENERATOR SET

- Internal Genset Vibration Isolation
- Separation of Circuits High/Low Voltage
- Separation of Circuits Multiple Breakers
- Wrapped Exhaust Piping
- Standard Factory Testing
- 2 Year Limited Warranty (Standby Rated Units)
- 1 Year Limited Warranty (Prime Rated Units)
- Silencer Mounted in the Discharge Hood (Enclosed Only)

ENCLOSURE (If Selected)

- Rust-Proof Fasteners with Nylon Washers to Protect Finish
- High Performance Sound-Absorbing Material (Sound Attenuated Enclosures)
- Gasketed Doors
- · Stamped Air-Intake Louvers
- Upward Facing Discharge Hoods (Radiator and Exhaust)
- · Stainless Steel Lift Off Door Hinges
- Stainless Steel Lockable Handles
- RhinoCoat™ Textured Polyester Powder Coat

TANKS (If Selected)

- UL 142
- Double Wall
- Vents
- · Sloped Top
- Sloped Bottom
- Factory Pressure Tested (2 psi)
- Rupture Basin Alarm
- Fuel Level
- · Check Valve In Supply and Return Lines
- RhinoCoat™ Textured Polyester Powder Coat
- Stainless Steel Hardware

CONTROL SYSTEM



Digital H Control Panel—Dual 4x20 Display

Program Functions

- Programmable Crank Limiter
- 7-Day Programmable Exerciser
- Special Applications Programmable Logic Controller
- RS-232/485 Communications
- 3-Phase Sensing Digital Voltage Regulator
- · 2-Wire Start Capability
- Date/Time Fault History (Event Log)
- Isochronous Governor Control
- Waterproof/Sealed Connectors

- Audible Alarms and Shutdowns
- · Not in Auto (Flashing Light)
- Auto/Off/Manual Switch
- E-Stop (Red Mushroom-Type)
- NFPA110 Level I and II (Programmable)
- Customizable Alarms, Warnings, and Events
- Modbus[®] Protocol
- Predictive Maintenance Algorithm
- · Sealed Boards
- Password Parameter Adjustment Protection
- Single Point Ground
- 16 Channel Remote Trending
- 0.2 msec High Speed Remote Trending
- Alarm Information Automatically Annunciated on the Display

Full System Status Display

- Power Output (kW)
- Power Factor
- kW Hours, Total, and Last Run
- Real/Reactive/Apparent Power
- All Phase AC Voltage
- All Phase Currents

- Coolant Temperature
- Coolant Level
- Engine Speed
- Battery Voltage
- Frequency

Alarms and Warnings

- Oil Pressure
- Coolant Temperature
- Coolant Level
- Low Fuel Pressure Alarm
- Engine Overspeed
- Battery Voltage
- Alarms and Warnings Time and Date Stamped
- Snap Shots of Key Operation Parameters During Alarms and Warnings
- Alarms and Warnings Spelled Out (No Alarm Codes)

INDUSTRIAL DIESEL GENERATOR SET

EPA Certified Stationary Emergency

CONFIGURABLE OPTIONS

ENGINE SYSTEM

- Oil Make-Up System
- Oil Heater
- O Industrial Exhaust Silencer (Open Set)

FUEL SYSTEM

- O Flexible Fuel Lines
- O Primary Fuel Filter

ELECTRICAL SYSTEM

- O 10A UL Battery Charger
- O 2.5A Battery Charger
- O Battery Warmer

ALTERNATOR SYSTEM

- Alternator Upsizing
- O Anti-Condensation Heater
- O Tropical Coating

CIRCUIT BREAKER OPTIONS

- O Main Line Circuit Breaker
- O 2nd Main Line Circuit Breaker
- O Shunt Trip and Auxiliary Contact
- O Electronic Trip Breakers

GENERATOR SET

- O Gen-Link Communications Software (English Only)
- O Extended Factory Testing
- O IBC Seismic Certification
- 12 Position Load Center

ENCLOSURE

- O Standard Enclosure
- O Level 1 Sound Attenuation
- O Level 2 Sound Attenuation
- O Level 2 Sound Attenuation with Motorized Dampers
- O Steel Enclosure
- O Aluminum Enclosure
- O Up to 200 MPH Wind Load Rating*
- O AC/DC Enclosure Lighting Kit

CONTROL SYSTEM

- O 21-Light Remote Annunciator
- O Remote Relay Panel (8 or 16)
- Oil Temperature Sender with Indication Alarm
- O Remote E-Stop (Break Glass-Type, Surface Mount)
- Remote E-Stop (Red Mushroom-Type, Surface Mount)
- O Remote E-Stop (Red Mushroom-Type, Flush Mount)
- O Remote Communication-Modem
- O 10A Run Relay
- O Ground Fault Indication and Protection Functions

TANKS (Size On The Last Page)

- O Electric Fuel Level
- Mechanical Fuel Level
- O 8" Fill Extension
- O 13" Fill Extension
- O 19" Fill Extension

WARRANTY (Standby Gensets Only)

- 2 Year Extended Limited Warranty
- 5 Year Limited Warranty
- 5 Year Extended Limited Warranty
- 7 Year Extended Limited Warranty
- 10 Year Extended Limited Warranty

ENGINEERED OPTIONS

ENGINE SYSTEM

- O Coolant Heater Ball Valves
- O Fluid Containment Pans
- O Block Heaters

CONTROL SYSTEM

- O Spare Inputs (x4) / Outputs (x4)
- O Battery Disconnect Switch

ALTERNATOR SYSTEM

O 3rd Breaker System

GENERATOR SET

O Special Testing

ENCLOSURE

- O Door Switch for Intrusion Alarm
- O Enclosure Ambient Heaters

TANKS

- Overfill Protection Valve
- O UL2085 Tank
- O ULC S-601 Tank
- O Special Fuel Tanks
- Vent Extensions

INDUSTRIAL DIESEL GENERATOR SET

EPA Certified Stationary Emergency



APPLICATION AND ENGINEERING DATA

ENGINE SPECIFICATIONS

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Make	Iveco/FPT
EPA Emissions Compliance	Stationary Emergency
EPA Emissions Reference	See Emission Data Sheet
Cylinder #	6
Туре	In-Line
Displacement - L (cu. in)	8.7 (530.91)
Bore - mm (in)	117 (4.61)
Stroke - mm (in)	135 (5.31)
Compression Ratio	16.5:1
Intake Air Method	Turbocharged/Aftercooled
Cylinder Head	4-Valve
Piston Type	Aluminum
Crankshaft Type	Dropped Forged Steel
Engine Governing	
Governor	Electronic Isochronous
Frequency Regulation (Steady State)	±0.25%
Lubrication System	
Oil Pump Type	Gear
Oil Filter Type	Full Flow
Crankcase Capacity - L (gts)	28 (29.57)

Cooling System

Cooling System Type	Closed Recovery
Water Pump Type	Pre-Lubed, Self Sealing
Fan Type	Pusher
Fan Speed (rpm)	2,538
Fan Diameter - mm (in)	762 (30.0)

Fuel System

Fuel Type	Ultra Low Sulfur Diesel Fuel #2
Fuel Specifications	ASTM
Fuel Filtering (Microns)	5
Fuel Inject Pump Make	Electronic
Fuel Pump Type	Engine Driven Gear
Injector Type	Common Rail
Engine Type	Direct Injection
Fuel Supply Line - mm (in.)	12.7 (0.5) NPT
Fuel Return Line - mm (in.)	12.7 (0.5) NPT

Engine Electrical System

System Voltage	24 VDC
Battery Charger Alternator	Standard
Battery Size	See Battery Index 0161970SBY
Battery Voltage	(2) - 12 VDC
Ground Polarity	Negative

ALTERNATOR SPECIFICATIONS

Standard Model	Generac 520 mm
Poles	4
Field Type	Revolving
Insulation Class - Rotor	Н
Insulation Class - Stator	Н
Total Harmonic Distortion	<5% (3-Phase)
Telephone Interference Factor (TIF)	< 50

Standard Excitation	Permanent Magnet Excitation
Bearings	Single Sealed Cartridge
Coupling	Direct Via Flexible Disc
Prototype Short Circuit Test	Yes
Voltage Regulator Type	Digital
Number of Sensed Phases	All
Regulation Accuracy (Steady State)	±0.25%

INDUSTRIAL DIESEL GENERATOR SET

EPA Certified Stationary Emergency

OPERATING DATA

POWER RATINGS

Standby Single-Phase 120/240 VAC @1.0pf 200 kW Amps: 833 Three-Phase 120/208 VAC @0.8pf 200 kW Amps: 694 Three-Phase 120/240 VAC @0.8pf 200 kW Amps: 601 Three-Phase 277/480 VAC @0.8pf 200 kW Amps: 301 Three-Phase 346/600 VAC @0.8pf 200 kW Amps: 241

STARTING CAPABILITIES (sKVA)

sKVA vs. Voltage Dip

			277/	480 VAC							208	/240 VAC			
Alternator	kW	10%	15%	20%	25%	30%	35%	Alternator	kW	10%	15%	20%	25%	30%	35%
Standard	200	187	280	373	467	560	653	Standard	200	140	210	280	350	420	490
Upsize 1	300	303	454	605	757	908	1,059	Upsize 1	300	277	341	454	568	681	794
Upsize 2	350	383	575	767	958	1,150	1,342	Upsize 2	350	280	410	535	640	770	900

FUEL CONSUMPTION RATES*

Diesel - gal/hr (l/hr)

INDUSTRIAL

Fuel Pump Lift- ft (m)	Percent Load	Standby
3 (1)	25%	4.4 (16.7)
	50%	8.3 (31.4)
Total Fuel Pump Flow (Combustion + Return) - gal/hr (I/hr)	75%	11.9 (45)
26 (98)	100%	14.8 (56)

^{*} Fuel supply installation must accommodate fuel consumption rates at 100% load.

COOLING

		Standby
Coolant Flow per Minute	gal/min (l/min)	63.3 (240)
Coolant System Capacity	gal (I)	12.7 (49.2)
Heat Rejection to Coolant	BTU/hr	545,646
Inlet Air	cfm (m³/hr)	8,872 (251)
Maximum Operating Ambient Temperature	°F (°C)	122 (50)
Maximum Operating Ambient Temperature (Before Derate)	See Bulletin I	No. 0199280SSD
Maximum Radiator Backpressure	in H ₂ O (kPa)	0.5 (0.12)

COMBUSTION AIR REQUIREMENTS

	Standby	
Flow at Rated Power cfm (m ³ /min)	595 (16.8)	

ENGINE			EXHAUST	
		Standby		Standby
Rated Engine Speed	rpm	1,800	Exhaust Flow (Rated Output) cfm (m³/min)	1,345 (38.1)
Horsepower at Rated kW**	hp	320	Max. Backpressure (Post Silencer) inHg (Kpa)	1.5 (5.1)
Piston Speed	ft/min	1,593	Exhaust Temp (Rated Output - Post Silencer) °F (°C)	920 (493)
BMEP	psi	265		

^{**} Refer to "Emissions Data Sheet" for maximum bHP for EPA and SCAQMD permitting purposes.


Deration – Operational characteristics consider maximum ambient conditions. Derate factors may apply under atypical site conditions.

Please consult a Generac Power Systems Industrial Dealer for additional details. All performance ratings in accordance with ISO3046, BS5514, ISO8528 and DIN6271 standards. Standby - See Bulletin 0187500SSB

EPA Certified Stationary Emergency


DIMENSIONS AND WEIGHTS*



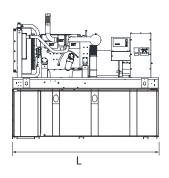





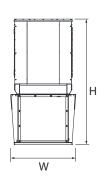


OPEN SET (Includes Exhaust Flex)

Run Time Hours	Usable Capacity Gal (L)	L x W x H (in (mm)	Weight lbs (kg)
No Tank	-	128 (3,251) x 54 (1,372) x 58 (1,473)	4,465 (2,025)
10	153 (579.2)	128 (3,251) x 54 (1,372) x 71 (1,803)	5,470 (2,481)
25	372 (1,407)	128 (3,251) x 54 (1,372) x 83 (2,108)	5,892 (2,673)
40	589 (2,227)	128 (3,251) x 54 (1,372) x 95 (2,413)	6,309 (2,862)
47	693 (2,623.3)	136 (3,454) x 54 (1,372) x 95 (2,413)	6,060 (2,749)
64	946 (3,581)	208 (5,283) x 54 (1,372) x 99 (2,515)	7,490 (3,397)
90	1,325 (5,015.7)	278 (7,061) x 54 (1,372) x 99 (2,515)	8,505 (3,858)

STANDARD ENCLOSURE


Run Time	Usable Capacity Cal (L)	L x W x H (in (mm)	Weight lbs (kg) Enclosure Only		
Hours	Capacity Gal (L)		Steel	Aluminum	
No Tank	-	155 (3,937) x 54 (1,372) x 70 (1,778)			
10	153 (579.2)	155 (3,937) x 54 (1,372) x 83 (2,108)	0.4.4		
25	372 (1,407)	155 (3,937) x 54 (1,372) x 95 (2,413)		474 (215)	
40	589 (2,227)	155 (3,937) x 54 (1,372) x 107 (2,718)	941 (427)		
47	693 (2,623.3)	155 (3,937) x 54 (1,372) x 107 (2,718)	(421)		
64	946 (3,581)	208 (5,283) x 54 (1,372) x 111 (2,819)			
90	1,325 (5,015.7)	278 (7,061) x 54 (1,372) x 111 (2,819)			

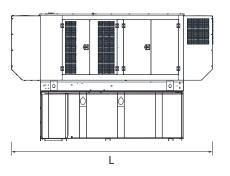




LEVEL 1 ACOUSTIC ENCLOSURE

Run Time	Usable Capacity Gal (L)	L x W x H (in (mm)	0	lbs (kg) ure Only
Hours	Gapacity Gai (L)		Steel	Aluminum
No Tank	-	180 (4,572) x 54 (1,372) x 70 (1,778)		
10	153 (579.2)	180 (4,572) x 54 (1,372) x 83 (2,108)		
25	372 (1,407)	180 (4,572) x 54 (1,372) x 95 (2,413)	— (505) -	606 (275)
40	589 (2,227)	180 (4,572) x 54 (1,372) x 107 (2,718)		
47	693 (2,623.3)	180 (4,572) x 54 (1,372) x 107 (2,718)		
64	946 (3,581)	234 (5,944) x 54 (1,372) x 111 (2,819)		
90	1,325 (5,015.7)	304 (7,722) x 54 (1,372) x 111 (2,819)		

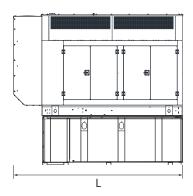

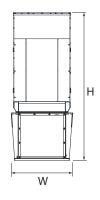

LEVEL 2 ACOUSTIC ENCLOSURE

Run Time	Usable Capacity Gal (L)	L x W x H (in (mm)	Weight H (in (mm) Enclos	
Hours	Gapacity Gai (L)		Steel	Aluminum
No Tank	-	155 (3,937) x 54 (1,372) x 93 (2,362)		
10	153 (579.2)	155 (3,937) x 54 (1,372) x 106 (2,692)		
25	372 (1,407)	155 (3,937) x 54 (1,372) x 118 (2,997)	1 100	700
40	589 (2,227)	155 (3,937) x 54 (1,372) x 130 (3,302)	1,482 (672)	708 (321)
47	693 (2,623.3)	155 (3,937) x 54 (1,372) x 130 (3,302)	(072)	(021)
64	946 (3,581)	208 (5,283) x 54 (1,372) x 132 (3,353)		
90	1,325 (5,015.7)	278 (7,061) x 54 (1,372) x 132 (3,353)		

^{*} All measurements are approximate and for estimation purposes only.

Specification characteristics may change without notice. Dimensions and weights are for preliminary purposes only. Please consult a Generac Power Systems Industrial Dealer for detailed installation drawings.

The Historic Architectural Review Commission will hold a public meeting at <u>5:00 p.m., April 22, 2025, at City</u> <u>Hall, 1300 White Street</u>, Key West, Florida. The purpose of the hearing will be to consider a request for:

NEW DIESEL GENERATOR WITH PAD AND FENCE. DEMOLITION OF EXISTING PAD AND FENCE STRUCTURE. REMOVAL OF TEMPORARY GENERATOR.

#525 SOUTHARD STREET

Applicant – Kyle Kalwary Application #C2025-0025

If you wish to see the application or have any questions, you may visit the Planning Department during regular office hours at 1300 White Street, call 305-809-3975 or visit our website at www.citvofkeywest-fl.gov.

THIS NOTICE CAN NOT BE REMOVED FROM THE SITE UNTIL HARC FINAL DETERMINATION

ADA ASSISTANCE: It is the policy of the City of Key West to comply with all requirements of the Americans with Disabilities Act (ADA). Please call the TTY number at 800-955-8771 or 800-955-8770 (Voice) or the ADA Coordinator at 305-809-3811 at least five business days in advance for sign language interpreters, assistive listening devices, or materials in accessible format.

PROPERTY APPRAISER INFORMATION

PROPERTY RECORD CARD

Disclaimer

The Monroe County Property Appraiser's office maintains data on property within the County solely for the purpose of fulfilling its responsibility to secure a just valuation for ad valorem tax purposes of all property within the County. The Monroe County Property Appraiser's office cannot guarantee its accuracy for any other purpose. Likewise, data provided regarding one tax year may not be applicable in prior or subsequent years. By requesting such data, you hereby understand and agree that the data is intended for ad valorem tax purposes only and should not be relied on for any other purpose.

By continuing into this site you assert that you have read and agree to the above statement.

Summary

Parcel ID 00009360-000000
Account# 1009610
Property ID 1009610
Millage Group 10KW

Legal Description 525 SOUTHARD St 1 AND 2, KEY WEST KW PT LOT 1 SQR 50 OR561-82 OR575-897 (Note: Not to be used on legal documents.)

Neighborhood 32040

Property Class ONE STORY OFFICE (1700)

Subdivision

Sec/Twp/Rng 06/68/25 Affordable Housing No



Owner

ADOLPHUS-WARFIELD INC 513 Southard St Key West FL 33040

Valuation

	2024 Certified Values	2023 Certified Values	2022 Certified Values	2021 Certified Values
+ Market Improvement Value	\$96,702	\$98,623	\$98,623	\$101,657
+ Market Misc Value	\$32,920	\$32,920	\$32,920	\$32,920
+ Market Land Value	\$1,067,354	\$1,067,354	\$878,997	\$690,641
= Just Market Value	\$1,196,976	\$1,198,897	\$1,010,540	\$825,218
= Total Assessed Value	\$992,553	\$902,321	\$820,292	\$745,720
- School Exempt Value	\$0	\$0	\$0	\$0
= School Taxable Value	\$1,196,976	\$1,198,897	\$1,010,540	\$825,218

Historical Assessments

Year	Land Value	Building Value	Yard Item Value	Just (Market) Value	Assessed Value	Exempt Value	Taxable Value	Maximum Portability
2024	\$1,067,354	\$96,702	\$32,920	\$1,196,976	\$992,553	\$0	\$1,196,976	\$0
2023	\$1,067,354	\$98,623	\$32,920	\$1,198,897	\$902,321	\$0	\$1,198,897	\$0
2022	\$878,997	\$98,623	\$32,920	\$1,010,540	\$820,292	\$0	\$1,010,540	\$0
2021	\$690,641	\$101,657	\$32,920	\$825,218	\$745,720	\$0	\$825,218	\$0
2020	\$552,512	\$101,657	\$32,920	\$687,089	\$677,928	\$0	\$687,089	\$0
2019	\$477,170	\$106,209	\$32,920	\$616,299	\$616,299	\$0	\$616,299	\$0
2018	\$472,984	\$96,317	\$32,920	\$602,221	\$602,221	\$0	\$602,221	\$0

The Maximum Portability is an estimate only and should not be relied upon as the actual portability amount. Contact our office to verify the actual portability amount.

Land

Land Use	Number of Units	Unit Type	Frontage	Depth
(1700)	2,203.00	Square Foot	37.7	58.5

Buildings

Building ID 39445

Style

OFF BLDG 1 STY-A / 17A

Building Type Building Name Gross Sq Ft 1104 Finished Sq Ft 1062 Stories 1 Floor Condition GOOD Perimeter 152 Functional Obs 0 Economic Obs 0 Depreciation % 38 Interior Walls

Exterior Walls AB AVE WOOD SIDING

0

Year Built 1940 EffectiveYearBuilt 1995

Foundation Roof Type Roof Coverage Flooring Type Heating Type Bedrooms Full Bathrooms

0 Half Bathrooms 0 Grade 400 Number of Fire PI 0

Code	Description	Sketch Area	Finished Area	Perimeter
FLA	FLOOR LIV AREA	1,062	1,062	0
OPF	OP PRCH FIN LL	42	0	0
ΤΟΤΔΙ		1 104	1 062	0

Yard Items

Description	Year Built	Roll Year	Size	Quantity	Units	Grade
CONC PATIO	1964	1965	4 x 8	1	32 SF	2
	1989	1990	0 x 0	1	1	1
WALL AIR COND	1989	1990	0 x 0	1	2 UT	1
WALL AIR COND	1990	1991	0 x 0	1	1 UT	2
FENCES	1990	1991	5 x 7	1	35 SF	2
FENCES	1990	1991	4 x 12	1	48 SF	2
FENCES	1996	1997	4 x 33	1	132 SF	2

Sales

Sale Date	Sale Price	Instrument	Instrument Number	Deed Book	Deed Page
2/1/1974	\$15,500	Conversion Code			897

Permits


				Permit	
Number	Date Issued	Status	Amount	Туре	Notes
BLD2024- 2041	11/04/2024	Completed	\$6,800	Commercial	Replace Damaged siding 30sqft patch and paint rear stucco, replace siding patch stucco (Paint White) replace 400 sf vinyl flooring with same *
BLD2024-	10/15/2024	Active	\$12,000	Commercial	Upgrade equipment at existing Wireless Comm Facility. Install 4 new antennas on existing mounts and 8
2656					50 amp DC breakers.
24-1782	07/12/2024	Completed	\$10,000	Commercial	Generator Add
BLD2023- 3204	11/16/2023	Completed	\$4,500	Commercial	INSTALL 1 NEW RADIO CABINET A REARRANGE EXISTING CABINETS
BLD2022- 2307	08/19/2023	Completed	\$43,000	Commercial	T-MOBILE UPGRADE ALTERATION; REMOVE AND REPLACE ANTENNAS UNMANNED ROOFTOP WIRELESS FACILITY
BLD2022- 2662	09/13/2022	Completed	\$21,000	Commercial	AT EXISTING TOWER, MODIFY 4 ANTENNAS AND SUPPORT DEVICES. AT GRADE, REPLACE CABINET AND SUPPORT DEVICES
BLD2021- 2178	08/16/2021	Completed	\$27,500	Commercial	UPGRADE LTE EQUIPMENT ON TELECOM TOWER.
BLD2021- 1665	06/09/2021	Completed	\$21,000	Commercial	AT GRADE, REMOVE CABINET. INSTALL SUPPORT DEVICES AT COMM. TOWER, INSTALL 3 ANTENNAS AND SUPPORT DEVICES.
BLD2019- 3305	09/16/2019	Completed	\$4,200	Commercial	REMOVE APPROX. 400 SQ/FT OF EXISTING MEMBRANE DOWN TO DECK. FURNISH AND INSTALL TAPERED INSULLATION FURNISH AND INSTALL 1 PLY MODIFIED BITUMEN BASE FURNISH AND INSTALL 1 PLY SELF ADHERING MODIFIED SMOOTH PLY. REMOVE SIDING AT WALL. FUENOSHAND INSTALL WALL FLASHING 1050 SQ/FT
13-0477	02/07/2013	Completed	\$18,580	Commercial	INSTALL CONDUIT TO RUN FIBER
13-0073	01/14/2013	Completed	\$1,060	Commercial	INSTALL NEW AWNING
12-4597	01/04/2013	Completed	\$15,078	Commercial	AT&T CELL SITE HVAC UNIT CHANGE OUT. REPLACE 3 TON WALL MOUNT UNIT WITH 5 TON UNIT
11-1573	09/12/2011	Completed	\$2,400	Commercial	INSTALL A NEW 3' X 3' ELECTRICAL EQUIPMENT CABINET ON EXISTING SLAB FOR UPGRADING WIRELESS COMMUNICATION FACILITY/SERVICE
11-0701	03/10/2011	Completed	\$30,000		ADDITION OF NEW ANTENNAS ON EXISTING CELL TOWER AND ASSOCIATED GROUP EQUIPMENT. NO CHANGE IN HEIGHT OF TOWER OR EXPANSION OF EXISTING COMPOUND.
11-0702	03/10/2011	Completed	\$6,500		INSTALLATION OF 100 AMP ELECTRICAL SERVICE, TELCO CONDUIT AND GROUNDING
06-6233	11/21/2006	Completed	\$1,000	Commercial	INSTALL ELECTRICAL CIRCUIT FOR NEW A/C UNIT
06-4821	08/15/2006	Completed	\$1,100	Commercial	INSTALL STORM SHUTTERS 2WINDOWS & 1 DOOR
06-4655	08/14/2006	Completed	\$4,500	Commercial	INSTALL 5 TON UNIT.
05-2956	11/23/2005	Completed	\$58,000	Commercial	COLLORATION OF 12 ANTENNAS TO EXISTING 83' TOWER
05-2957	11/23/2005	Completed	\$12,000	Commercial	INSTALL NEW 200AMP TEMP SERVICE
05-2451	06/22/2005	Completed	\$1,000	Commercial	UPGRADE PERMIT\$04-3831
04-1692	06/07/2004	Completed	\$28,000	Commercial	ADD ANTENNAS TO EXISTING TOWER

				Permit	
Number	Date Issued	Status	Amount	Type	Notes
04-1016	04/07/2004	Completed	\$2,500	Commercial	INSTALL ACCORIAN SHUTTERS
03-4139	12/16/2003	Completed	\$1,500	Commercial	REPAIRED ROOF
03-332	10/09/2003	Completed	\$281,000	Commercial	INTERIOR RENOVATIONS
03-1516	06/30/2003	Completed	\$4,500	Commercial	MOUNT ANTENNAS
02-3238	12/04/2002	Completed	\$1,000	Commercial	NEW AWNING
02-2818	10/18/2002	Completed	\$15,000	Commercial	REPAIR SIDING & PAINT
00-2920	09/19/2000	Completed	\$500	Commercial	CHANGE DISH SIZE
96-4481	11/01/1996	Completed	\$600	Commercial	REPAIR/REMODEL
M94996	04/01/1994	Completed	\$4,000	Commercial	4TON AC
B94765	03/01/1994	Completed	\$2,000	Commercial	DEMO INTERIOR
B94843	03/01/1994	Completed	\$30,000	Commercial	INTERIOR RENOVATION

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Photos



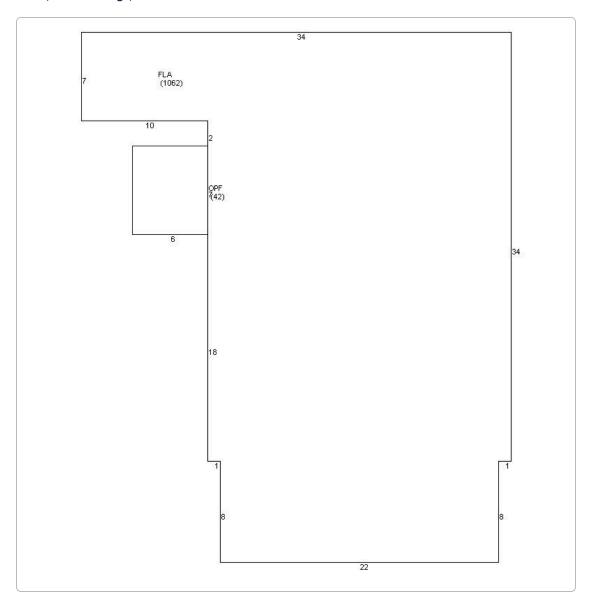

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TRIM Notice

2024 TRIM Notice (PDF)

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