

#### Historic Architectural Review Commission Staff Report for Item 5

**To:** Chairman Bryan Green and Historic Architectural Review

**Commission Members** 

**From:** Enid Torregrosa, MSHP

Historic Preservation Planner

Meeting Date: October 23, 2018

**Applicant:** Juan Contin, Architect

**Application Number:** H17-01-0058

Address: #1317 Grinnell Street

#### **Description of Work**

New one-story accessory structure and conversion of rear portion of house into a covered patio.

#### **Site Facts**

The building in review is a one and a half-story frame house not listed in the surveys. According to the Property Appraisers records, the house was built in 1963. The Monroe County Library does not have any photographs of the property. City records evidences that the one- story addition located on the north side of the house was an open deck; in 2007, a one-story roof over the deck was built under permit number 07-5290. Under Certificate of Appropriateness 13-01-0127, a request to enclose the cover porch received approval and plans were executed under permit number 13-691. One-story houses surrounds the house in questions.

#### **Guidelines Cited on Review**

- New construction (pages 38a-38q); specifically guideline 1, 2, 3, 11, 13, 14, 18, and 23.
- Outbuildings (pages 40-41); specifically guidelines 1, 3, and 9.

#### **Staff Analysis**

The Certificate of Appropriateness application in review includes the replacement of an existing accessory frame structure with a new one. The design also includes partial removal of north and east exiting walls in order to create a rear-covered patio.

The new proposed accessory structure will be one-story frame with a hipped roof extending approximately 14' from grade. The structure will be rectangular in footprint and will have board and batten siding, aluminum windows and doors, and metal v-crimp roofing. The structure will be located at the rear yard and behind the existing main house.

The plan also includes the removal of exterior walls of a latter addition in order to create an open patio. This will be at the northeast portion of the house, which faces the rear yard.

#### **Consistency with Guidelines**

It is staff's opinion that the proposed design is consistent with the cited guidelines. The new accessory structure will be lower than the main house and is similar in massing and scale with accessory structures found within the surrounding neighborhood. Staff also finds that the opening of the rear portion of the house to create a covered patio will not have any effect on the main house or its historic context.

## APPLICATION

#### HARC MAJOR PROJECTS CERTIFICATE OF APPROPRIATENESS

\$400 NON-REFUNDABLE BASE APPLICATION FEE - OTHER FEES MAY BE APPLICABLE



#### City of Key West 1300 WHITE STREET

A	INITIAL & DATE	
ZONING DISTRICT	BLDG PERMIT #	
	ZONING DISTRICT	

#### A PRE-APPLICATION MEETING WITH HARC STAFF IS REQUIRED PRIOR TO SUBMITTAL

THE THE STATE OF T	1311 Grinnell 31. Key	west Florida
NAME ON DEED:	Leohr Leslie SR 2002 Trust	PHONE NUMBER 330 - 416 - 0500
OWNER'S MAILING ADDRESS:	2247 Rolling wood Dr.	EMAIL dleohra prideone.cc
	Medina Oh 44256	or Heohr@prideone.cc
APPLICANT NAME:	Doug Leohr / Juan Contin.	PHONE NUMBER 330 416 0 500
APPLICANT'S ADDRESS:	2247 Rolling wood Dr.	EMAIL dleohr@prideone.cc
	Medina Oh 44256	
APPLICANT'S SIGNATURE:		DATE
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#### APPLICATIONS MUST BE SUBMITTED IN PERSON WITH HARD COPIES BY 3PM ON THE SCHEDULED DEADLINE PLEASE SEND AN ELECTRONIC COPY OF ALL DOCUMENTS TO HARC@CITYOFKEYWEST-FL.GOV

answin 15

ACCESSORY STRUCTURE	76).			
ACCESSORY STRUCTURE				
main bu	ulding	proposed	I accessory structure at a	ear of
PAVERS:			FENCES:	
DECKS:			PAINTING:	
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			structure will be painted to n	natch main bu
SITE (INCLUDING GRADING	G, FILL, TREES, ETC)	:	POOLS (INCLUDING EQUIPMENT):	
ACCESSORY EQUIPMENT	(GAS, A/C, VENTS, ET	rc.):	OTHER:	
OFFICIAL USE ONLY:		HARC COM	MMISSION REVIEW E	XPIRES ON:
MEETING DATE:	APPROVED _	NOT APPROV	/EDDEFERRED FOR FUTURE CONSIDERATION	INITIAL:
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THIS APPLICATION MAY BE REVIEWED BY PLANNING DEPARTMENT STAFF.

#### HARC Certificate of Appropriateness: Demolition Appendix




HARC COA #	INITIAL & DATE	
17-03-58		
ZONING DISTRICT	BLDG PERMIT #	


ADDRESS OF PROPOSED PROJECT:	1317 Grinnell S	- Von Wed Fl	
PROPERTY OWNER'S NAME:	lants larla CD	2007 Tourst	
ADDRESS OF PROPOSED PROJECT: 1317 Grinnell St Key West FL  PROPERTY OWNER'S NAME: Leohr Leshe SR 2002 Trust  APPLICANT NAME: Leshe Leohr			
I hereby certify I am the owner of record Appropriateness, I realize that this proje final inspection is required under this ap submitted for review.	ct will require a Building Permit appro	oval PRIOR to proceeding with the w	ork outlined above and that a
PROPERTY OWNER'S SIGNATURE		9/7/18 Leslie	Leoh DATE AND PRINT NAME
	DETAILED PROJECT DESCRI	IPTION OF DEMOLITION	
Demolition of	existing cabana o	it rear of main bui	Iding.
ODITED!	TOD DEMOLITION OF CONTRIE	DUTING OR HISTORIC STRUCTURE	0.
		BUTING OR HISTORIC STRUCTURE	
Before any Certificate of Appropria must find that the following requires			
(1) If the subject of the application is a irrevocably compromised by extreme of	contributing or historic building or s leterioration or it does not meet any	structure, then it should not be demolisy of the following criteria:	shed unless its condition is
(a) The existing condition	of the building or structure is irrevo	ocably compromised by extreme deter	ioration.
	1		
(2) Or explain how the building or struc	ture meets the criteria below:		
(a) Embodies no distinctiv	ve characteristics of a type, period,	or method of construction of aesthetic y whose components may lack individ	
MANAGEMENT			

provided in Section 102-218 of the Land Development Regulations and Chapter 14 of the Code of Ordinances
(b) Is not specifically associated with events that have made a significant contribution to local, state, or national history.
(c) Has no significant character, interest, or value as part fo the development, heritage, or cultural characteristics of the ci state or nation, and is not associated with the life of a person significant in the past.
state of fration, and is not associated with the life of a person significant in the past.
(d) Is not the site of a historic event with significant effect upon society.
(e) Does not exemplify the cultural, political, economic, social, or historic heritage of the city.
(f) Does not portray the environment in an era of history characterized by a distinctive architectural style.
(g) If a part of or related to a square, park, or other distinctive area, nevertheless should not be developed or preserved
according to a plan based on the area's historic, cultural, natural, or architectural motif.
(h) Does not have a unique location or singular physical characteristic which represents an established and familiar visual feature of its neighborhood or of the city, and does not exemplify the best remaining architectural type in a neighborhood.


Nothing in this application is intended to alter the authority of the Building Official to condemn for demolition dan as provided in Section 102-218 of the Land Development Regulations and Chapter 14 of the Code of Or	-
(i) Has not yielded, and is not likely to yield, information important in history.	
CRITERIA FOR DEMOLITION OF NON-CONTRIBUTING OR NON-HISTORIC STRUCTURES:	
The following criteria will also be reviewed by the Historic Architectural Review Commission for proposed de Commission shall not issue a Certificate of Appropriateness that would result in the following conditions (plea comment on each criterion that applies);	
(1) Removing buildings or structures that are important in defining the overall historic character of a district or neighborhood s character is diminished.	o that the
Existing cabana is not visible from Grinnell Street (minimally visible looking through neighbor's backyard on Seminan Therefore, removal of existing cabana would not seem to impact	and Street.
(2) Removing historic buildings or structures and thus destroying the historic relationship between buildings or structures and	open space.
Existing rebane is not historic. Removal of cabana wo not change historic relationship.	wd
(3) Removing an historic building or structure in a complex; or removing a building facade; or removing a significant later additional important in defining the historic character of a site or the surrounding district or neighborhood.	
Existing cabana is not important to the historic of the surrounding neighborhood.	character
(4) Removing buildings or structures that would otherwise qualify as contributing.	
Existing cabana is not a contributing factor to the hi character of the surrounding neighboor hood.	storie

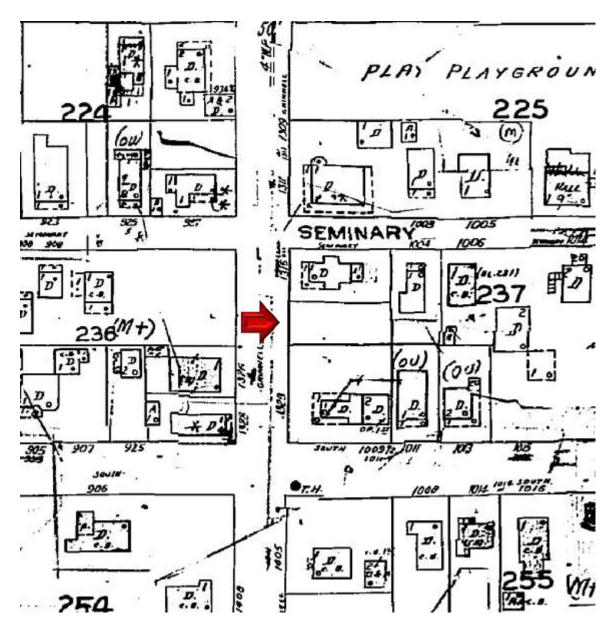

1962 Sanborn Map

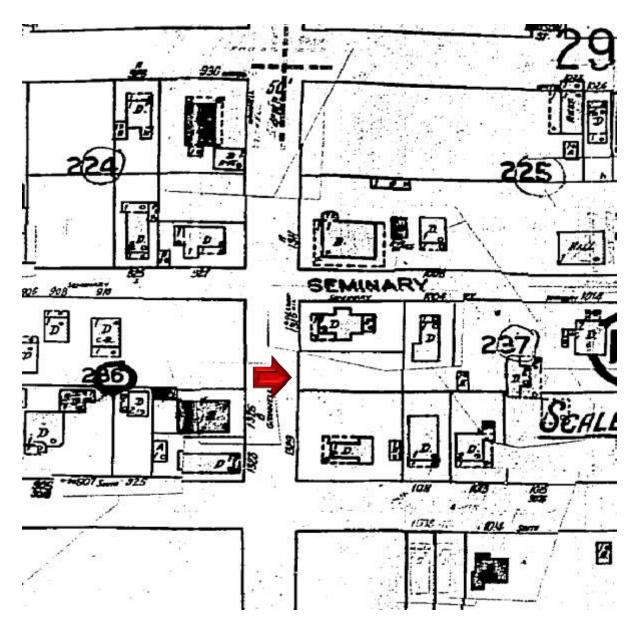


1948 Sanborn Map

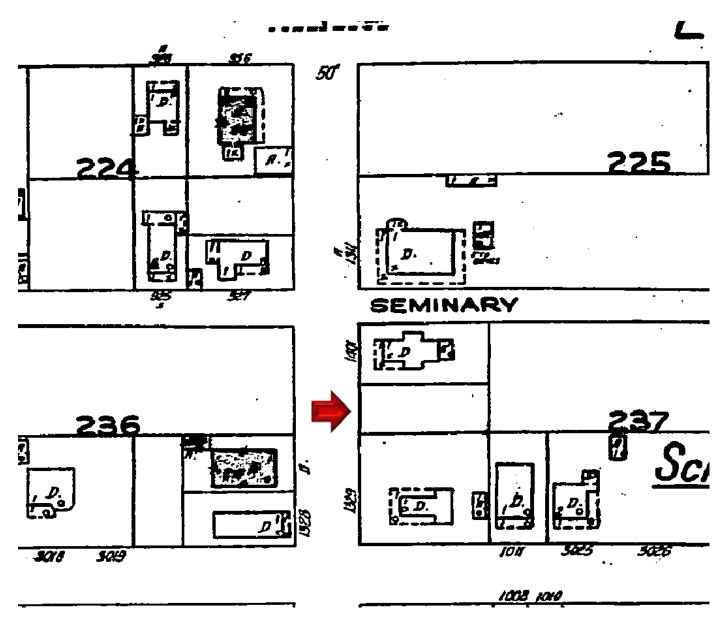

1926 Sanborn Map

# PROJECT PHOTOS

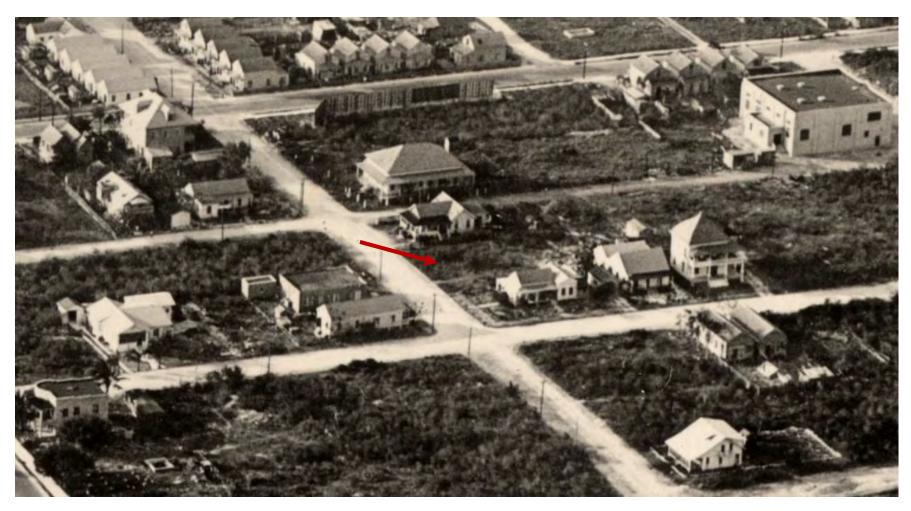

Aerial photograph circa 1930.













# PROPOSED DESIGN

## LEOHR LESLIE S R 2002 TRUST

## 1317 GRINNELL ST

KEY WEST, FLORIDA

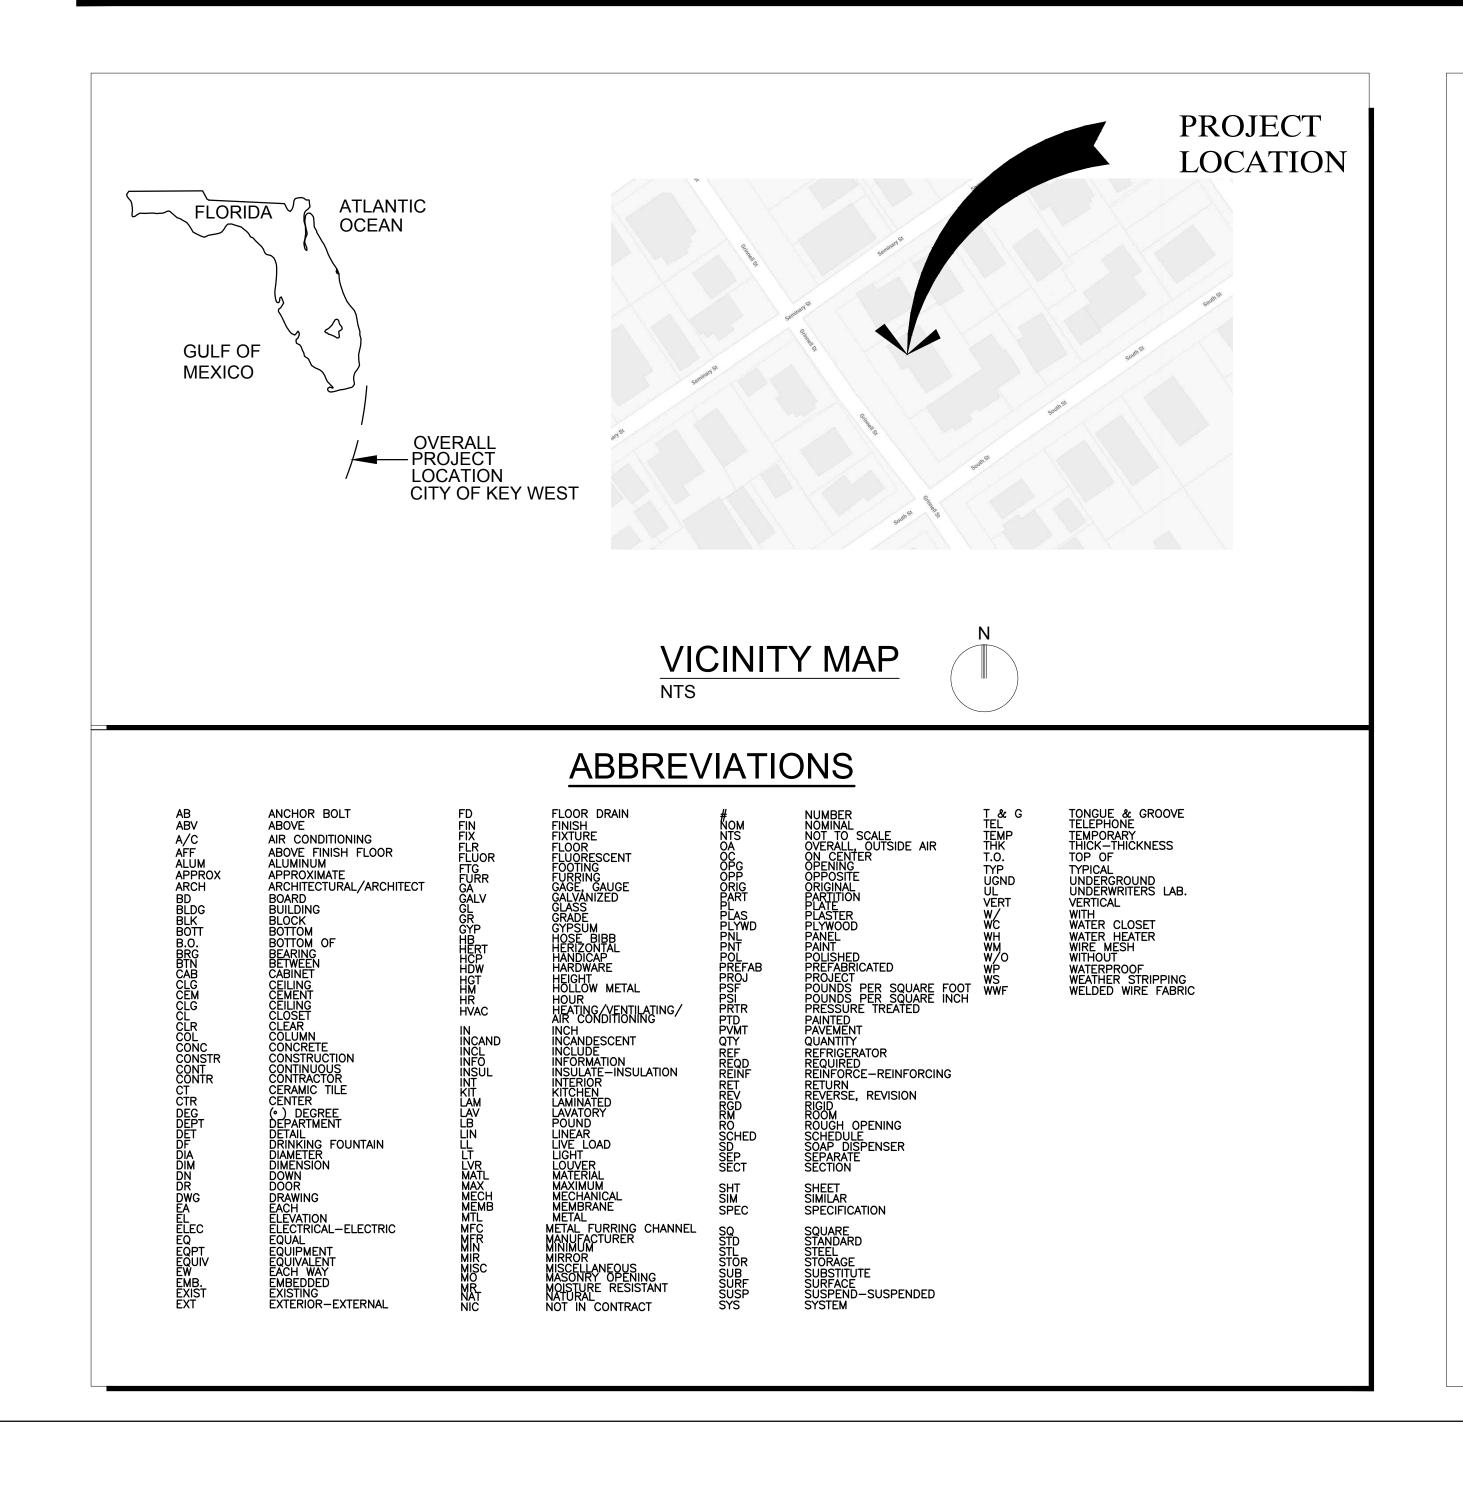

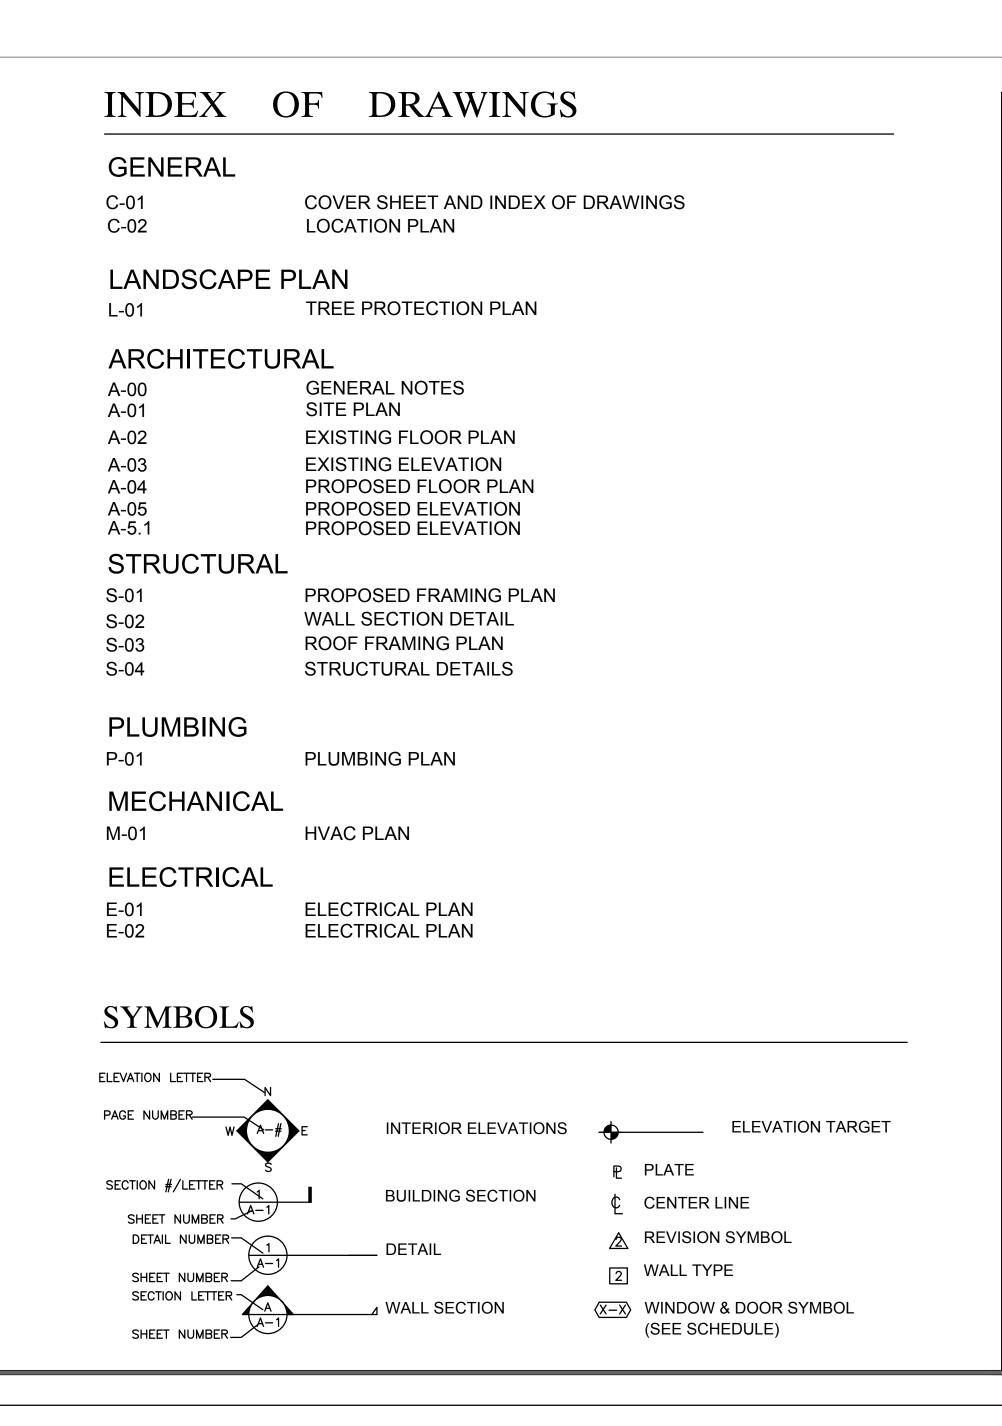

#### SCOPE OF WORK

A. DEMOLITION OF THE EXISTING CABANA AS SHOWN IN PLAN AND REPLACE WITH NEW CABANA.

B. CREATE A COVERED PORCH ON MAIN HOUSE BY UTILIZING PORTION OF THE EXISTING LIVING ROOM AS SHOWN IN

2. ALL WORK SHALL BE IN STRICT ACCORDANCE WITH ALL APPLICABLE CODES HAVING JURISDICTION. INCLUDING BUT NOT LIMITED TO:

•STANDARD BUILDING CODE, 2017 EDITION
•STANDARD MECHANICAL CODE, 2017 EDITION
•STANDARD PLUMBING CODE, 2017 EDITION
•NATIONAL ELECTRICAL CODE, 2017 EDITION
•MONROE COUNTY 2017

THE CONTRACT DOCUMENTS INCLUDE ARCHITECTURAL, STRUCTURAL, PLUMBING, MECHANICAL, AND ELECTRICAL DRAWINGS. NO PORTION BY ITSELF PROVIDES ALL THE INFORMATION REQUIRED TO PROPERLY COMPLETE THE PROJECT. THEREFORE IT IS THE RESPONSIBILITY OF THE GENERAL CONTRACTOR AND ALL OF HIS SUBCONTRACTORS TO THOROUGHLY FAMILIARIZE THEMSELVES WITH THESE DRAWINGS AND TO COORDINATE THE INFORMATION CONTAINED THEREIN TO PROPERLY AND SUCCESSFULLY CONSTRUCT THE PROJECT.

#### **REGISTERED ARCHITECT**

JUAN CRISTOBAL CONTIN

FL LICENSE # AR94935

826 SOUTH FEDERAL HIGHWAY SUITE #4 LAKE WORTH, FL 33460

#### MECHANICAL CONSULTANT

KAREN W. OLIVER

K.O. ENERGY DESIGN, LLC 561-327-7272 OFFICE 561-333-0775 FAX

EMAIL:KAREN@KOENERGYDESIGN.COM

#### **ELECTRICAL**

JUAN CRISTOBAL CONTIN

FL LICENSE # AR94935

826 SOUTH FEDERAL HIGHWAY SUITE #4 LAKE WORTH, FL 33460

#### **PLUMBING**

JUAN CRISTOBAL CONTIN

FL LICENSE # AR94935

826 SOUTH FEDERAL HIGHWAY SUITE #4 LAKE WORTH, FL 33460

#### **GENERAL NOTES:**

These drawings have a local state and federal copyright Juan Contin, Architect. and are property of the They are not to be used on other projects or extension of this project except by written agreements with Juan Contin, Architect. No design changes which alter the intent of the drawings or specifications are to be made without obtaining written permission from Juan Contin, Architect.



REGISTERED ARCHITECT:

JUAN CRISTOBAL CONTIN

FL LICENSE # AR94935

LAKE WORTH, FL 33460

826 S. FEDERAL HIGHWAY



IFNT:

LEOHR LESLIE S R 2002 TRUST

PROJECT TITLE:

1317 GRINNELL STREET

PROJECT ADDRESS:

1317 GRINNELL STREET KEY WEST, FLORIDA

DATE:	16 JULY, 2018
ISSUED:	
DRAWN BY:	JC

REVISIONS:

CHECKED BY:

9-7-2018

SCALE/NORTH POINT:

AS SHOWN

DRAWING TITLE

COVER SHEET


DRAWING STATUS:

DRAWING NUMBER:

C-01



REAR ELEVATION OF MAIN HOUSE

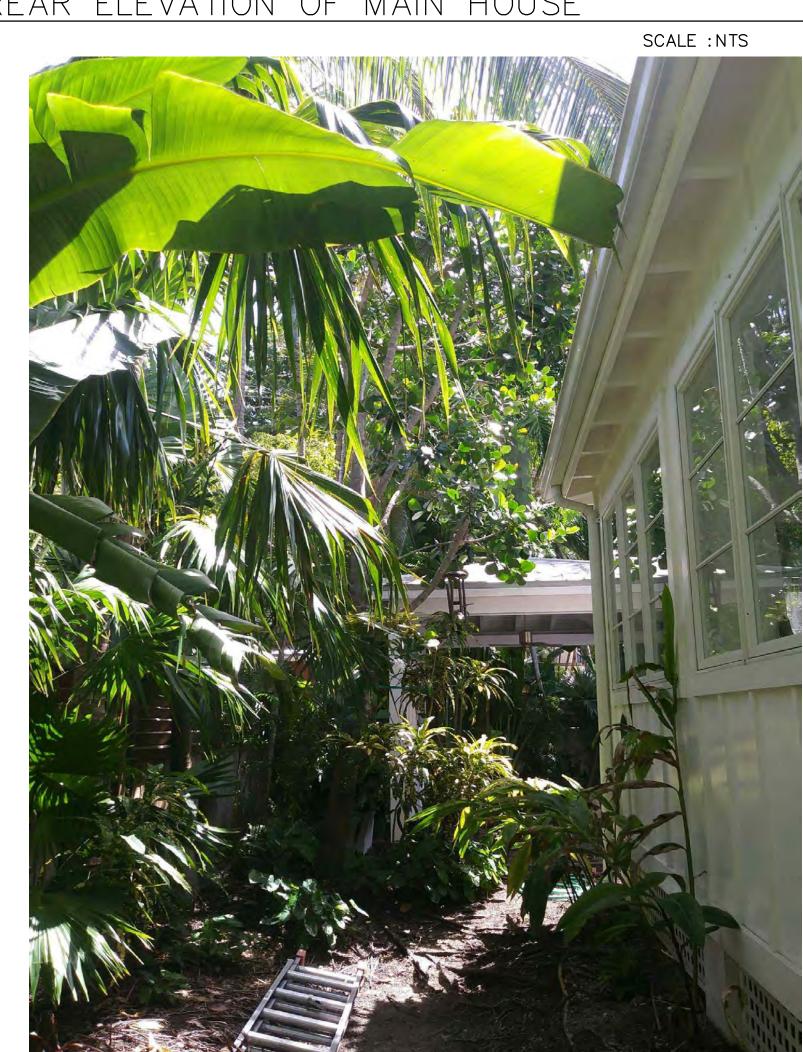

SOUTH ELEVATION OF EXISTING GAZEBO

SCALE :NTS




REAR ELEVATION OF MAIN HOUSE




WEST ELEVATION OF EXISTING GAZEBO

SCALE : NTS

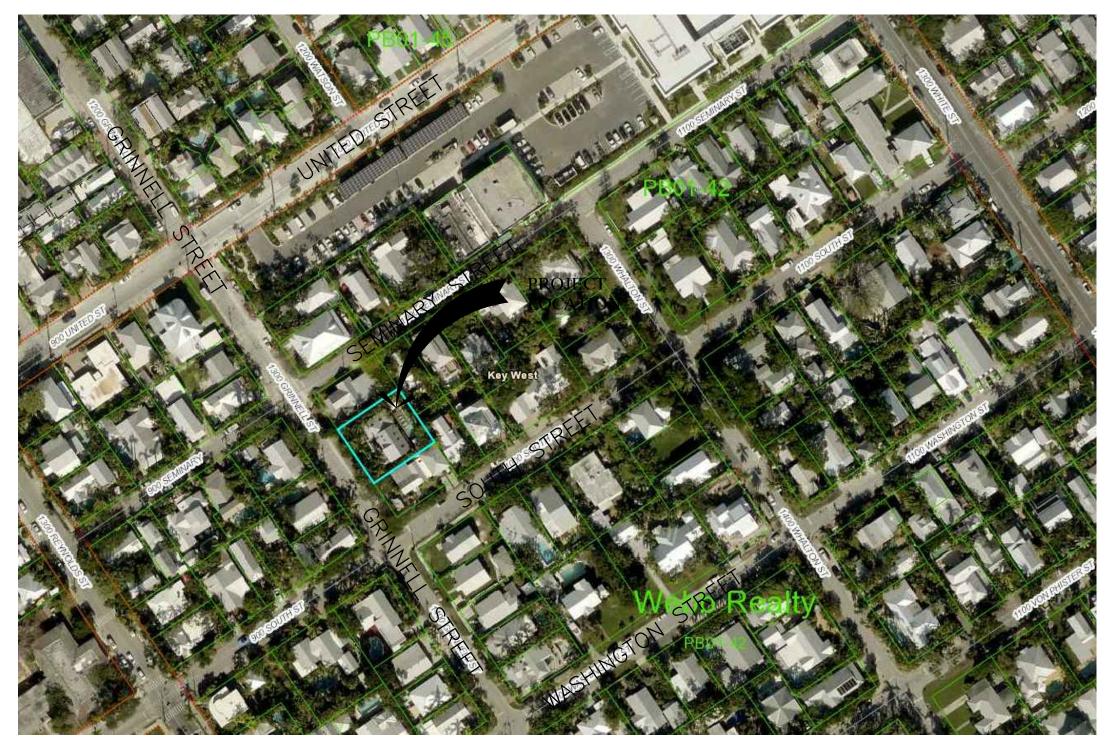

BUILDING LOCATION MAP

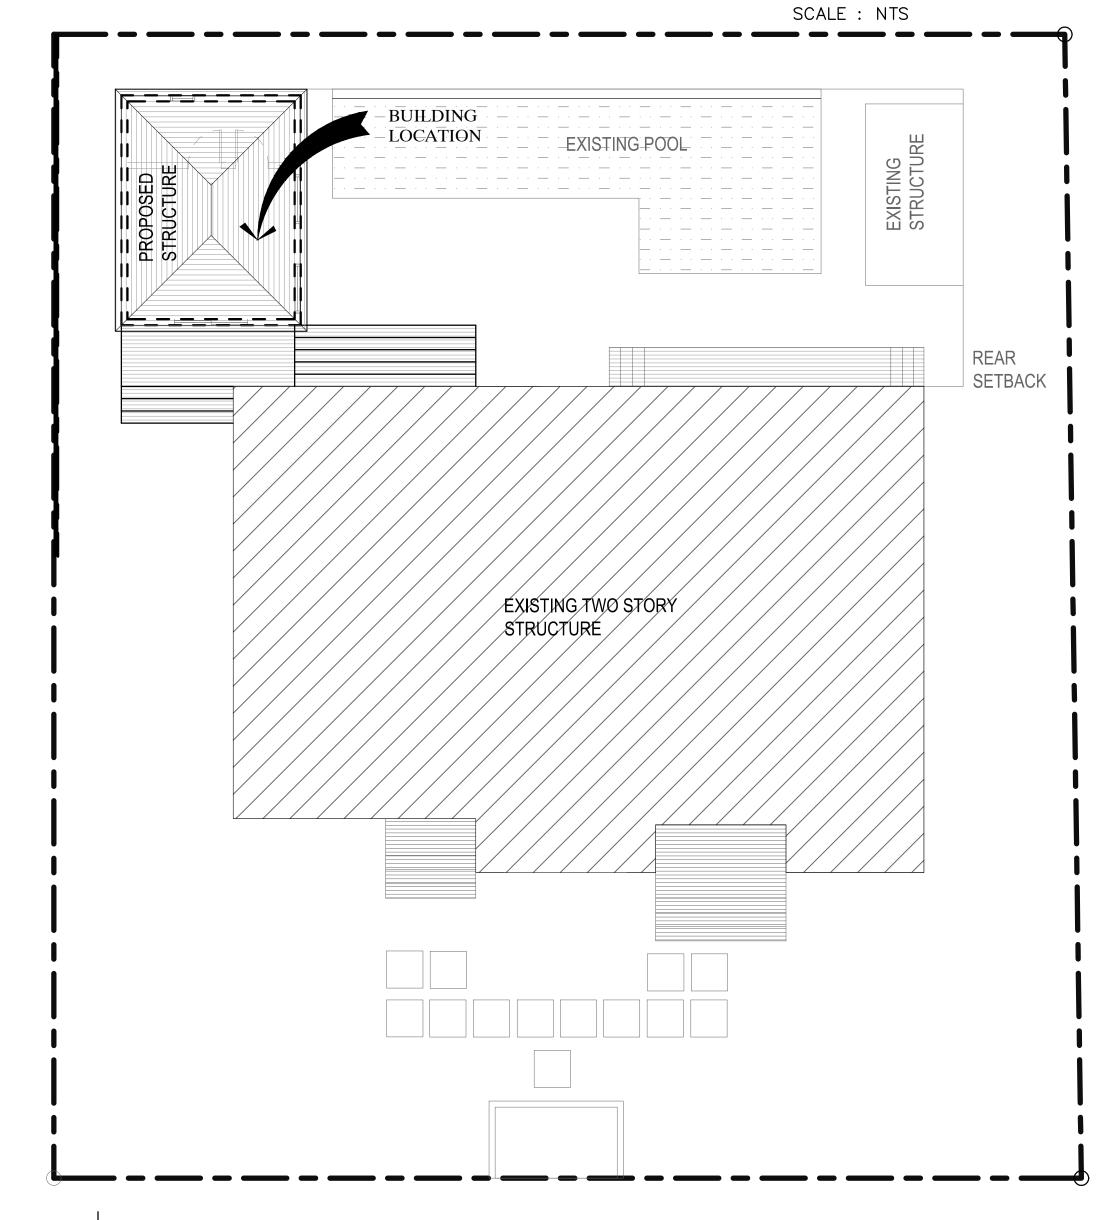

BUILDING LOCATION

SCALE : 1/4" = 1'-0"

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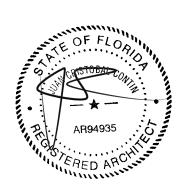
#### REGISTERED ARCHITECT:

JUAN CRISTOBAL CONTIN

FL LICENSE # AR94935

826 S. FEDERAL HIGHWAY

LAKE WORTH, FL 33460



#### CLIENT:

LEOHR LESLIE S R 2002 TRUST

#### PROJECT TITLE:

1317 GRINNELL STREET

#### PROJECT ADDRESS:

1317 GRINNELL STREET KEY WEST, FLORIDA

DATE:	16 JULY, 201
ISSUED:	

#### REVISIONS:

#### SCALE/NORTH POINT:

DRAWING TITLE

LOCATION PLAN

AS SHOWN

DRAWING STATUS:

DRAWING NUMBER:



#### NOTES


THIS PLANTING PLAN REFLECTS THE EXISTING PLANTS THAT ARE WITHIN CLOSE PROXIMITY OF THE BUILDING FOOT PRINT.PLEASE BE AWARE THAT ALL PLANS WILL REMAIN AND PROTECTED FROM BECOMING DAMAGED.

#### **Plant List**

KEY	ОТÝ. (////	BOTANICAL NAME	COMMON NAME	REMARKS
TP	2	Ravenella madagascariensis	Travellers Palm	10-12' o.a./ full,dense crown/ single head (no suckers)
АМ	3	Adonidia merillii	Christmas Palm	10'-12' o.a./ full, dense heads/ SINGLE trunk
FP	2	-	-	EXISTING FLOWER POT
EX	1	-	-	EXISTING UNKNOWN TREE TO REMAIN

#### GENERAL NOTES


- Contractor shall field verify all site conditions prior to initiating planting installation. All existing planting shall remain intact and undisturbed unless otherwise noted on the plans.
- 2. Contractor shall familiarize himself/herself with existing site conditions prior to initiating planting. All existing site furnishings, paving, landscape and other elements to remain shall be protected from any damage unless otherwise noted.
- 3. Report any discrepancies between the construction drawings and field conditions to the owner / architect, Inc. immediately.

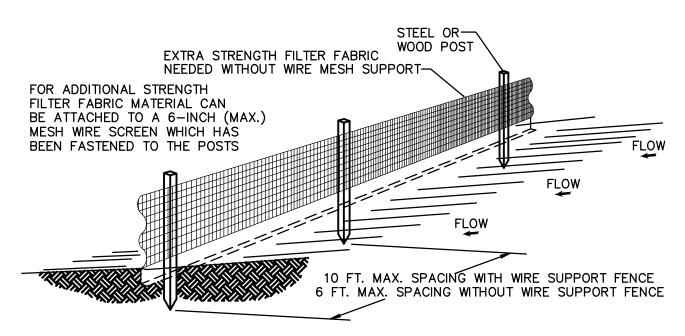

#### NOTES

- 1. THE HEIGHT OF THE GREEN FENCE FABRIC SHALL BE MINIMUM 6 FEET.
- 2. THE FILTER FABRIC SHALL BE PURCHASED IN A CONTINUOUS ROLL CUT TO THE LENGTH OF THE BARRIER TO AVOID THE USE OF JOINTS.
- 3. POSTS SHALL BE SPACED A MAXIMUM OF 8 FEET APART AT THE BARRIER LOCATION AND DRIVEN SECURELY INTO THE GROUND A MINIMUM OF 24 INCHES WHEN EXTRA STRENGTH FABRIC IS USED WITHOUT THE WIRE SUPPORT FENCE, POST SPACING SHALL NOT EXCEED 6 FEET (1.8 M).
- 4. A TRENCH SHALL BE EXCAVATED APPROXIMATELY 4 INCHES (10 CM) WIDE AND 4 INCHES (10 CM) DEEP ALONG THE LINE OF POSTS AND UPSLOPE FROM THE BARRIER.
- 5. WHEN STANDARD STRENGTH FILTER FABRIC IS USED, A WIRE MESH SUPPORT FENCE SHALL BE FASTENED SECURELY TO THE UPSLOPE SIDE OF THE POSTS USING HEAVY DUTY WIRE STAPLES AT LEAST 1 INCH (25 MM) LONG, TIE WIRES, OR HOG RINGS. THE WIRE SHALL EXTEND INTO THE TRENCH A MINIMUM OF 2 INCHES (5 CM) AND SHALL NOT EXTEND MORE THAN 36 INCHES (90 CM) ABOVE THE ORIGINAL GROUND SURFACE.
- 6. THE STANDARD STRENGTH FILTER FABRIC SHALL BE STAPLED OR WIRED TO THE FENCE, AND 8 INCHES (20 CM) OF THE FABRIC SHALL BE EXTENDED INTO THE TRENCH. THE FABRIC SHALL NOT EXTEND MORE THAN 36 INCHES (90 CM) ABOVE THE ORIGIONAL GROUND SURFACE.
- 7. THE TRENCH SHALL BE BACKFILLED AND THE SOIL COMPACTED OVER THE FILTER FABRIC.
- 8. ALL PROJECTS REQUIRE SUBMITTAL OF POLLUTION PREVENTION PLAN (PPP).
- 9. ALL PROJECTS 1 AC. OR MORE MUST SUBMIT NOTICE OF INTENT (NOI) TO FDEP.

GREEN FENCE INSTALLATION DETAIL
Sheet 1 of 2

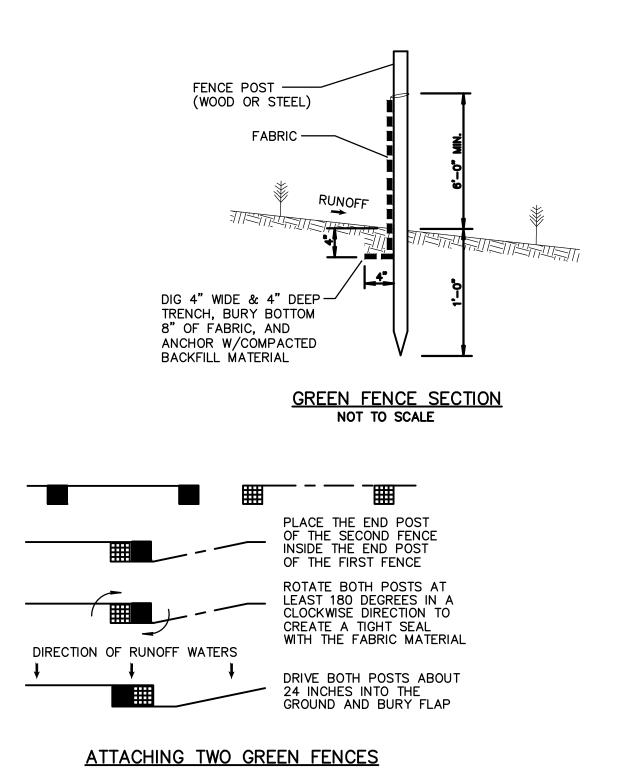


GREEN FENCE INSTALLATION DETAIL

Sheet 2 of 2

PROPERTY FENCE

PROTECTION FENCE

LOCATION OF-

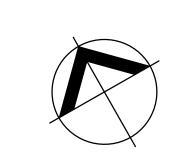

N TREE PROTECTION PLAN

-LOCATION OF

PROTECTION FENCE

SCALE : 1/8" = 1'-0"

GENERAL NOTES:

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REGISTERED ARCHITECT:

EXISTING STRUCTURE

**REAR** 

SETBACK

JUAN CRISTOBAL CONTIN

FL LICENSE # AR94935

| | 826 S. FEDERAL HIGHWAY

LAKE WORTH, FL 33460



CLIENT:

LEOHR LESLIE S R 2002 TRUST

**PROJECT TITLE**: 1317 GRINNELL STREET

PROJECT ADDRESS:

1317 GRINNELL STREET KEY WEST, FLORIDA

ATE: \_\_\_\_\_\_16 JULY, 2018

| ISSUED: \_\_\_\_\_

DRAWN BY: \_\_\_\_

CHECKED BY:

REVISIONS:

SCALE/NORTH POINT:

DRAWING TITLE

AS SHOWN

TREE PROTECTION PLAN

DRAWING STATUS:

DRAWING NUMBER



#### **GENERAL NOTES -FBC 2017**

- THE CONTRACTOR IS RESPONSIBLE FOR CONTACTING ANY GOVERNMENTAL AGENCIES NECESSARY IN ORDER TO ESTABLISH ANY UTILITY EASEMENTS OR LINES PRESENT WITHIN THE PROPERTY PRIOR TO PERFORMING ANY WORK.
- 2. CONCRETE SHALL HAVE 3,000 PSI COMPRESSIVE STRENGTH AT 28 DAYS, UNLESS OTHERWISE NOTED (U.O.N.)
- 3. ALL REINFORCING STEEL SHALL BE DEFORMED BARS, AND SHALL HAVE A MINIMUM YIELD STRENGTH OF 60,000 PSI GRADE 60, AND MEET ASTM A-36 SPECS. (OR IF OTHERWISE
- 4. ALL STRUCTURAL STEEL SHALL HAVE A MINIMUM YIELD STRENGTH OF 36.000 PSI, AND MEET ASTM A-36 SPECS.
- 5. ALL DETAILING, FABRICATION AND PLACING OF REINFORCING BARS MUST FOLLOW THE ACI "MANUAL OF STANDARD PRACTICE FOR DETAILING REINFORCED CONCRETE STRUCTURES",
- 6. STRUCTURAL DRAWINGS SHALL BE WORKED TOGETHER WITH ARCHITECTURAL, A/C, ELECTRICAL AND MECHANICAL DWGS., TO LOCATE OPENINGS, DRAINS, SLEEVES, SLOPES, DEPRESSED SLABS, BOLTS, CURBS, ETC.
- 7. ALL CONCRETE WORK SHALL BE IN ACCORDANCE WITH ACI-301ETC. "SPECIFICATIONS FOR STRUCTURAL CONCRETE FOR BUILDINGS."
- 8. REMOVAL OF FORMWORK SHALL BE IN ACCORDANCE WITH ACI-347 RECOMMENDED PRACTICE FOR CONCRETE FORMWORK."
- 9. DO NOT SCALE DRAWINGS; DIMENSIONS GOVERN.
- 10. REBARS SHOWN ON SECTIONS ARE FOR PLACEMENT DETAIL ONLY, SIZE AND AMOUNT OF REBARS ARE AS PER SCHEDULES.
- 11. NO TIE BEAMS SHALL BE FORMED/ POURED PRIOR TO TRUSS SHOP DRAWINGS APPROVAL.
- 12. WINDOW MANUFACTURER TO VERIFY ALL WINDOW OPENINGS AT FIELD PRIOR TO WINDOW PLACEMENT.
- 13. ARCHITECT/INTERIOR DESIGN ENGINEER'S VISITS AT THE SITE DURING CONSTRUCTION SHALL BE SCHEDULED WITH CONTRACTOR BEFORE COMMENCING OF WORK AND DURING CONSTRUCTION SHALL BE COORDINATED WITHIN 48 HOURS IN ADVANCE PRIOR TO INSPECTION.
- 14. VERIFY ALL DIMENSIONS ON DRAWINGS AND CONDITIONS AT JOB SITE PRIOR TO COMMENCING WORK. NOTIFY ARCHITECT OR OWNER REPRESENTATIVE OF ANY DISCREPANCIES AND SECURE AN INTERPRETATION OR DECISION FROM THE ARCHITECT BEFORE PROCEEDING WITH THE WORK, DO NOT SCALE DRAWINGS, DIMENSIONS GOVERN.
- 15. OBTAIN THE LATEST SET OF DRAWINGS, INCLUDING ANY REVISIONS, BEFORE COMMENCING WORK, NO CHANGES OR SUBSTITUTIONS SHALL BE MADE WITHOUT THE WRITTEN PERMISSION OF THE OWNER/ARCHITECT/INTERIOR DESIGNER.
- 16. ALL CONSTRUCTION SHALL BE IN ACCORDANCE WITH APPLICABLE REQUIREMENTS OF THE "FLORIDA BUILDING CODE 2017", CURRENT EDITION. NOTE: ALL LOCAL CODES SHALL PREVAIL.
- 17. THE ARCHITECT DOES NOT ACCEPT RESPONSIBILITY FOR THE MISINTERPRETATION OF THESE PLANS BY OTHERS, THE REVIEW AND APPROVAL OF SHOP DRAWINGS PRODUCT CONTROL APPROVAL BY OTHERS.
- 18. THE CONTRACTOR IS FULLY RESPONSIBLE FOR ANY ITEMS PURCHASED BY THE OWNER AND GIVEN TO HIM FOR INSTALLATION.
- 19. THE CONTRACTOR SHALL NOT PROCEED WITH ANY ADDITIONAL SERVICES OR WORK WITHOUT PRIOR NOTIFICATION TO THE OWNER, FOLLOWED BY A CHANGE ORDER.
- 20. THE CONTRACTOR SHALL MAKE REQUIRED ARRANGEMENTS, SECURE AND PAY FOR ALL SANITARY FACILITIES, BARRICADES, ENCLOSURES, AND FENCING AS NEEDED FOR AND DURING THE PROGRESS OF CONSTRUCTION. CONTRACTOR SHALL PROTECT ADJACENT PROPERTIES.
- 21. DO NOT SUBSTITUTE MATERIALS, EQUIPMENTS OR METHODS OF CONSTRUCTION UNLESS SUCH SUBSTITUTIONS OR CHANGES HAVE BEEN APPROVED IN WRITING BY THE OWNER/ARCHITECT/ENGINEER.
- 22. THE ARCHITECT/INTERIOR DESIGNER/OWNER HAS THE RIGHT TO REFUSE ANY MATERIAL AND WORKMANSHIP THAT DOES NOT MEET HIGH QUALITY STANDARDS OF THE VARIOUS TRADES INVOLVED.
- 23. CONTRACTOR SHALL MAINTAIN AN ACCURATE RECORD OF CHANGE ORDERS AND VARIATIONS THROUGHOUT THE PROGRESS OF THE WORK. USE ONE SET OF DOCUMENTS
- EXCLUSIVELY FOR THIS JOB.
- 24. CONTRACTOR SHALL DELIVER THE ANNOTATED JOB RECORD SET TO THE OWNER UPON COMPLETION OF THE WORK, AS A CONDITION OF ACCEPTANCE.
- 25. CLEANING AND DEBRIS REMOVAL. THE OWNER SHALL RECEIVE THE PROPERTY FREE FROM DUST, ALL GLASS SURFACES SHALL BE CLEAN AND DEBRIS SHALL BE REMOVED FROM THE SITE. THE CONTRACTOR SHALL MAKE EFFORT TO MAINTAIN THE FLOOR CLEAN DURING CONSTRUCTION PROGRESS. LEFTOVERS FROM MEALS CONSUMED ON PREMISES SHALL BE DEPOSITED IN SEALED CONTAINERS.
- 26. THE CONTRACTOR IS SOLELY RESPONSIBLE FOR MEANS AND METHODS OF CONSTRUCTION, AND FOR THE SEQUENCES AND PROCEDURES TO BE USED.
- 27. THE ARCHITECTURAL AND STRUCTURAL DRAWINGS SHALL GOVERN THE LOCATIONS OF THE INSTALLATIONS OF THE MECHANICAL AND ELECTRICAL SYSTEM. CONTRACTOR MUST INFORM THE ARCHITECT BEFORE FORMING ANY CONCRETE BEAM IF INTERFERING WITH A/C DUCT OR PLUMBING FIXTURES EXACT LOCATION. ANY DEVIATION FROM THE MECHANICAL/ELECTRICAL PLANS TO ACCOMMODATE THE ABOVE CONDITIONS SHALL BE MADE WITHOUT ADDITIONAL COST TO THE OWNER.
- 28. THE CONTRACTOR SHALL PRODUCE, BY MEANS OF SHOP DRAWINGS, ALL ADDITIONAL DETAILS WHICH ARE INFERABLE FROM THESE PLANS AND WHICH ARE NECESSARY FOR THE EXECUTION AND COMPLETION OF THE CONSTRUCTION.
- 29. THE CONTRACTOR MUST FURNISH ALL LABOR, TOOLS, MATERIALS AND EQUIPMENT NECESSARY TO EXECUTE THE CONSTRUCTION OF THIS JOB.
- 30. UPON ACCEPTANCE AS SUBSTANTIALLY COMPLETE, THE ARCHITECT SHALL ISSUE THE CONTRACTOR A "PUNCHLIST", INDICATING THE OBSERVED DEFICIENCIES IN THE WORK. THE CONTRACTOR SHALL MAKE SUCH CORRECTIONS AND ACHIEVE FINAL COMPLETION WITHIN 14 CALENDAR WORKING DAYS.
- 31. ANY OMISSION OF EQUIPMENT INSTALLATIONS AND MATERIALS SHALL BE PROMPTLY RECTIFIED. BY CONTRACTOR UPON NOTIFICATION BY ARCHITECT/ENGINEER/OWNER.
- 32. ANY OTHER SERVICES NECESSARY FOR THE COMPLETION OF THIS JOB THAT MAY BE INVOLUNTARY UNDER THE JURISDICTION OF THE FLORIDA BUILDING CODE AND NOT SPECIFIED IN THE "GENERAL NOTES AND OR SPECIFICATIONS" ARE THE CONTRACTOR'S SOLE RESPONSIBILITY.
- 33. CONTRACTOR SHALL SUBMIT TO ARCHITECT/ENGINEER & BUILDING DEPARTMENT ALL REQUIRED SHOP DRAWINGS FOR REVIEW AND APPROVAL AS REQUIRED.
- 34. ALL GLASS SHOWER AND TUB ENCLOSURES SHALL RECEIVE CATEGORY II. SAFETY GLAZING.
- 35. ALL FIXED GLASS SHALL BE 1/4" THICK (U.O.N.)
- 36. ALL CEILINGS SHALL BE SEALED SO THAT AIR FLOW FROM SHAFTS, WALL CHASES, CAVITIES AND BETWEEN CONDITIONED AND UNCONDITIONED ATTIC SPACE IS STOPPED.
- 37. USE ONLY HIGH HAT LIGHTS WITH SEALED CANS OR SEAL THEM FROM THE ATTIC DRYWALL SO THAT COLD AIR DOES NOT GET INTO THE ATTIC.
- 38. ALL DIFFUSERS AND GRILLS SHALL HAVE GASKETTS AND THE FIBERGLASS BOOT CONNECTIONS SHALL BE TIGHT IN ORDER TO PREVENT COLD AIR TO LEAK OUT THROUGHT THE DRYWALL OPENINGS ALLOWING CONDENSATION TO FORM.
- 39. DRAFT STOPS SHALL BE SEALED AROUND PIPES AND CONDUITS AT THE TOPS OF ALL INTERIOR PARTITION WALLS SO THAT AIR CANNOT PENETRATE DOWN INTO THE WALLS.
- 40. SEAL ALL CEILING SPACES BETWEEN THE CONDITIONED FLOORS FROM OUTSIDE AIR.
- 41. PROVIDE THE ABSOLUTE MINIMUM ATTIC VENTILATION, LOCATE THE NECESSARY SOFFIT VENTS ON THE EXPOSURE AWAY FROM THE LOCAL PREVAILING BREEZE.
- 42. INSURE THAT ALL INSULATION IS PROPERLY DISTRIBUTED AND INSTALLED WITHOUT GAPS OR IN CONTACT WITH SURFACES THAT TRANSFER AIR.
- 43. DO NOT VENTILATE THE ATTIC BY FORCED VENTILATION.
- 44. ASSURE THAT ALL FIREPLACE DAMPERS ARE TIGHTLY CLOSED.
- 45. INSURE THAT THERE IS NO DUCT LEAKAGE.
- 46. KEEP ALL DUCTWORK SEPARATE FROM ALL OTHER DUCTWORK, ATTIC INSULATION, AND BUILDING CONSTRUCTION MATERIALS.
- 47. SLABS OVER CRAWLSPACES, UNCONDITIONED SPACES SHALL BE SEALED AND INSULATED UNDERNEATH.
- 48. MAINTAIN CONDITIONS IN ATTIC SUCH THAT THE DEW POINT OF THE ATTIC AIR IS HIGHER THAN THE SKIN TEMPERATURE OF THE DUCTWORK AT ALL TIMES.
- 49. EXTERIOR AND ADJACENT WALLS SHALL BE SEALED AT THE FOLLOWING LOCATIONS AS PER FLORIDA BUILDING CODE, LATEST EDITION.
- BETWEEN WINDOWS AND DOORS AND THEIR FRAMES, BETWEEN WINDOWS AND DOOR FRAMES AND THE SURROUNDING WALL, 1.1.b.
- BETWEEN THE FOUNDATION AND WALL ASSEMBLY SILL-PLATES,
- JOINTS BETWEEN EXTERIOR WALL PANELS AT CHANGES IN PLANE, SUCH AS WITH EXTERIOR SHEATHING AT CORNERS AND CHANGES IN ORIENTATION. OPENINGS AND CRACKS AROUND ALL PENETRATIONS THROUGH THE WALL ENVELOPE SUCH AS UTILITY SERVICES AND PLUMBING,
- BETWEEN THE WALL PANELS AND TOP AND BOTTOM PLATES IN EXTERIOR AND ADJACENT WALLS. IN FRAME CONSTRUCTION, THE CRACK BETWEEN EXTERIOR AND ADJACENT
- WALL BOTTOM PLATES AND FLOORS SHALL BE SEALED WITH CAULKING OR GASKET MATERIAL. GYPSUM BOARD OR OTHER WALL PANELING ON THE INTERIOR SURFACE OF XTERIOR AND ADJACENT WALL SHALL BE SEALED TO THE FLOOR, AND (WHEN APPLICABLE)
- BETWEEN WALLS AND FLOOR WHERE THE FLOOR PENETRATES THE WALL

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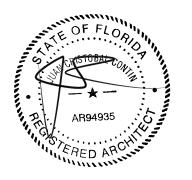
#### REGISTERED ARCHITECT:

JUAN CRISTOBAL CONTIN

FL LICENSE # AR94935

826 S. FEDERAL HIGHWAY

LAKE WORTH, FL 33460



LEOHR LESLIE S R 2002 TRUST

#### PROJECT TITLE:

1317 GRINNELL STREET

#### PROJECT ADDRESS:

1317 GRINNELL STREET KEY WEST, FLORIDA

DATE:	16 JULY, 2018
ISSUED:	
DRAWN BY:	JC

REVISIONS:

**CHECKED BY:** 

$\wedge$	

#### SCALE/NORTH POINT:

AS SHOWN


#### DRAWING TITLE

GENERAL NOTES


#### **DRAWING STATUS:**

#### **DRAWING NUMBER:**



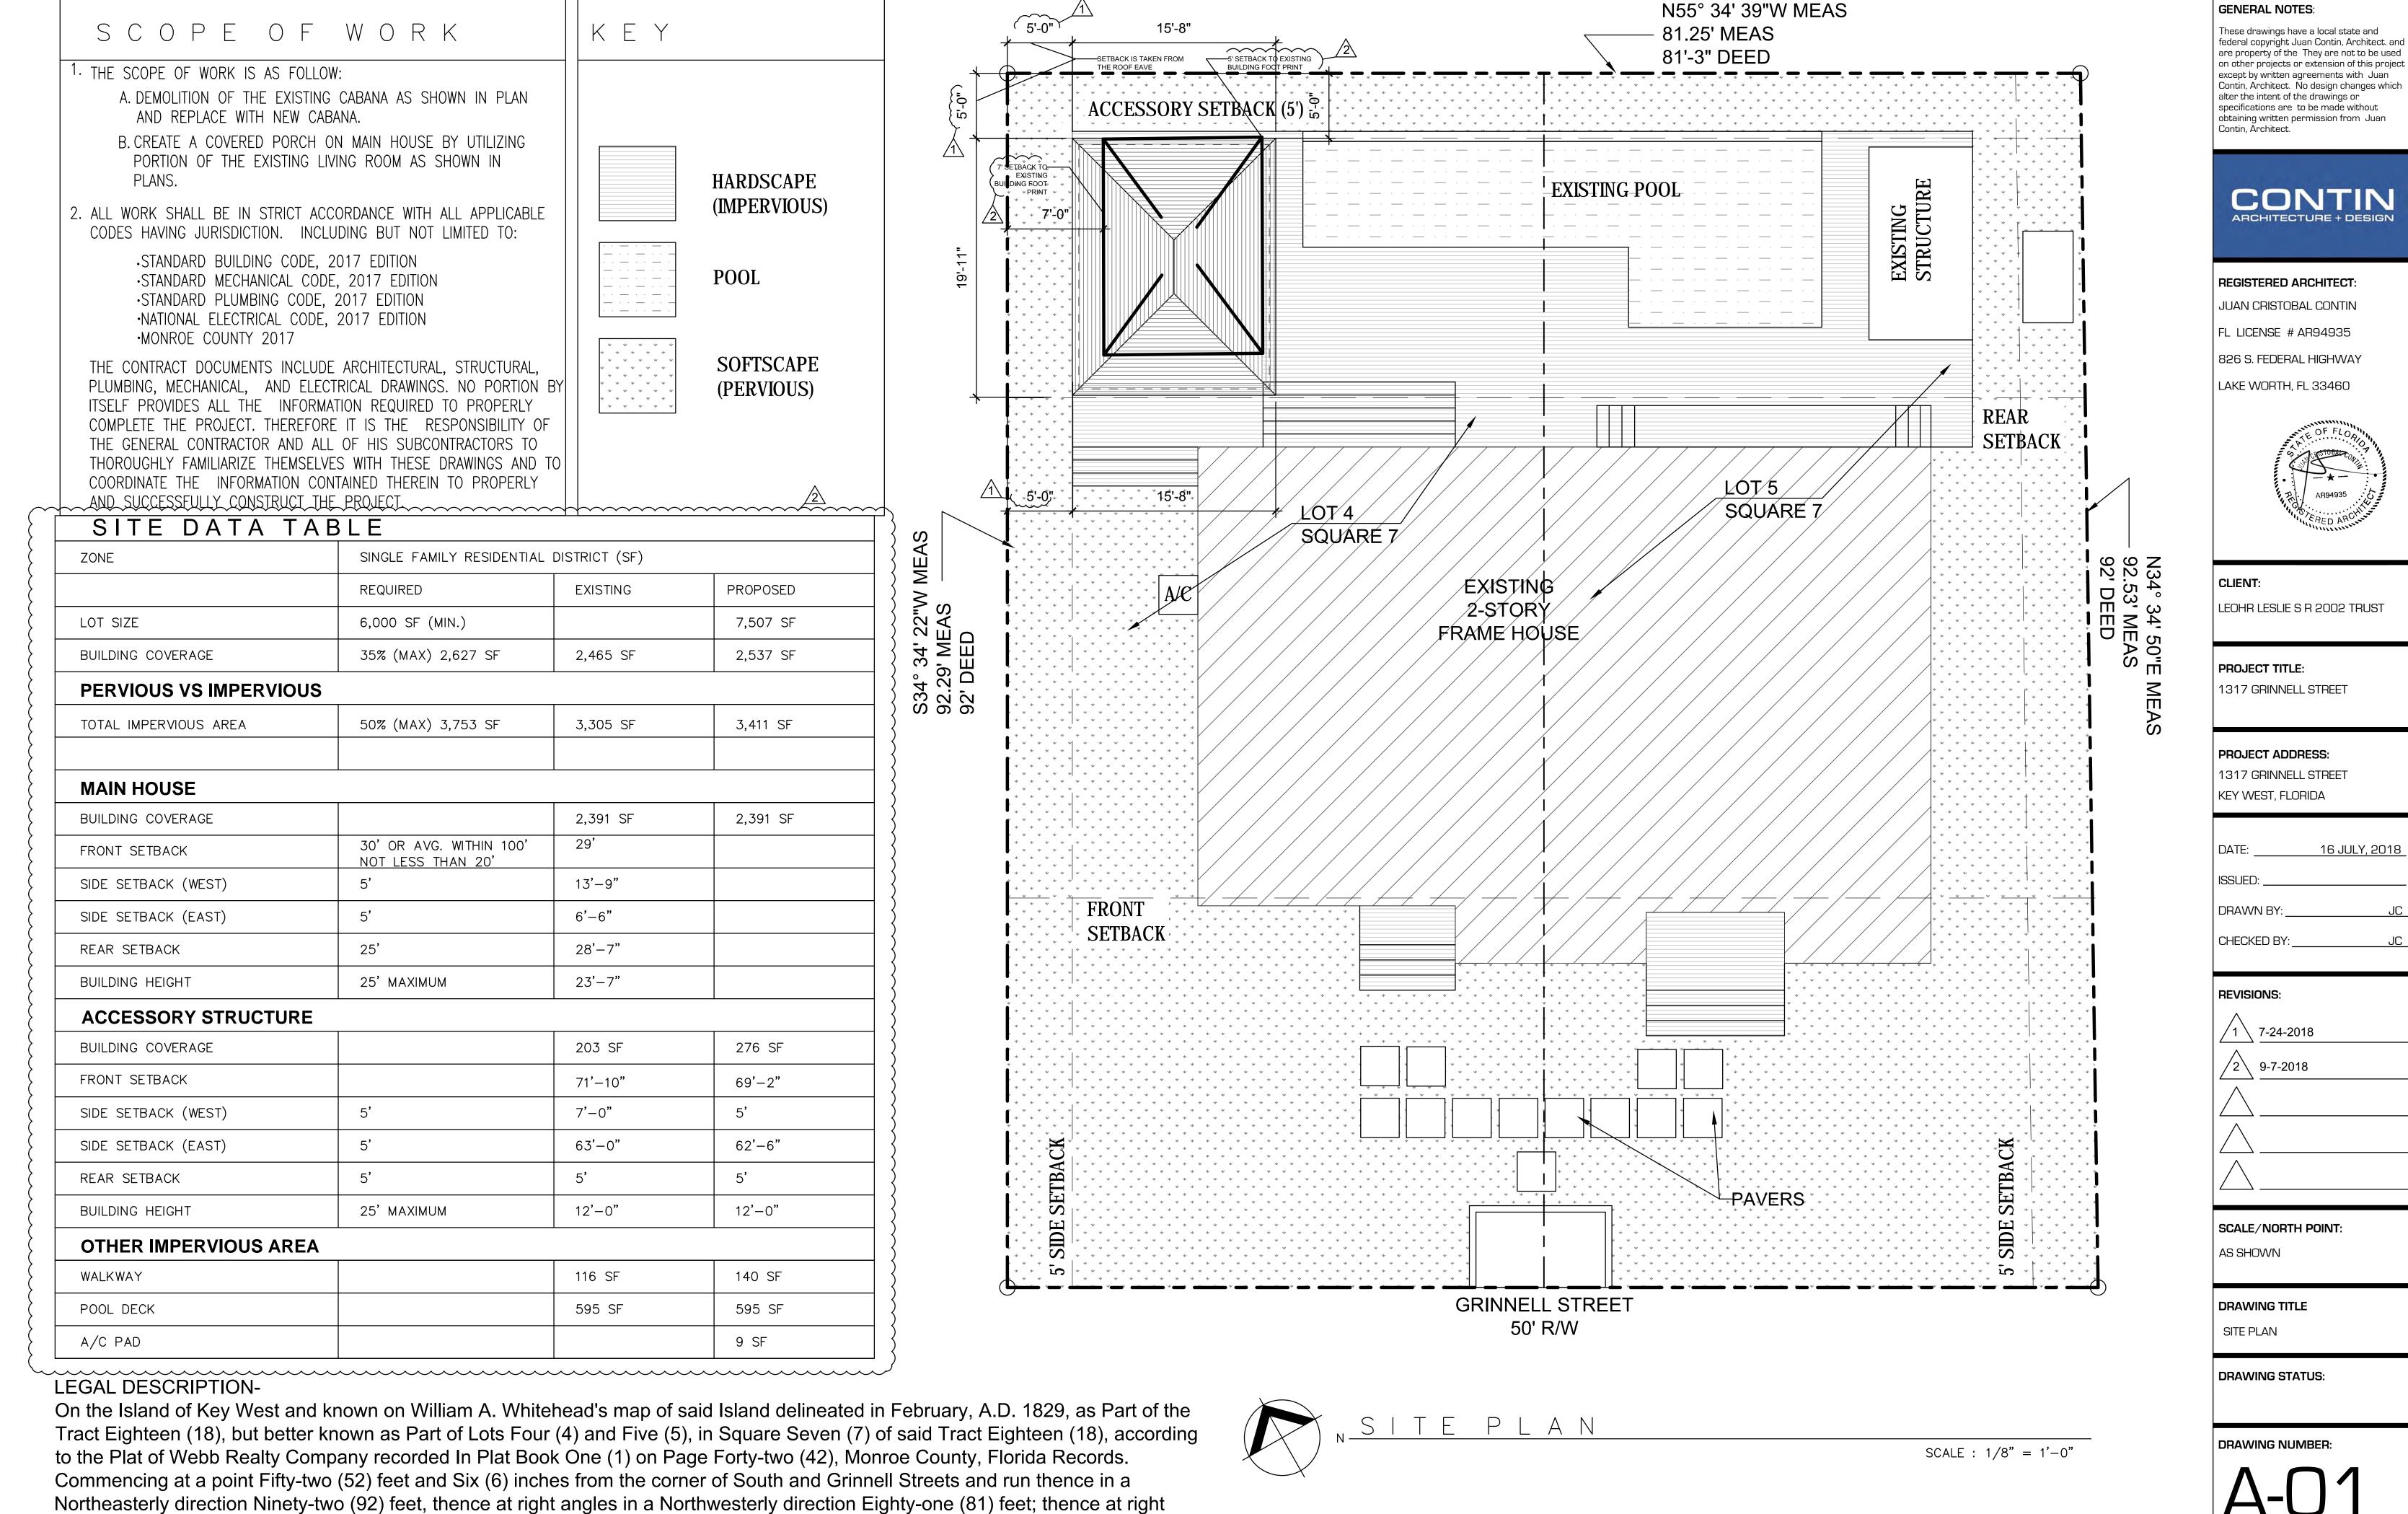

angles in a Southeasterly direction Eighty-one (81) feet and Tree (3) Inches to the Point of Beginning

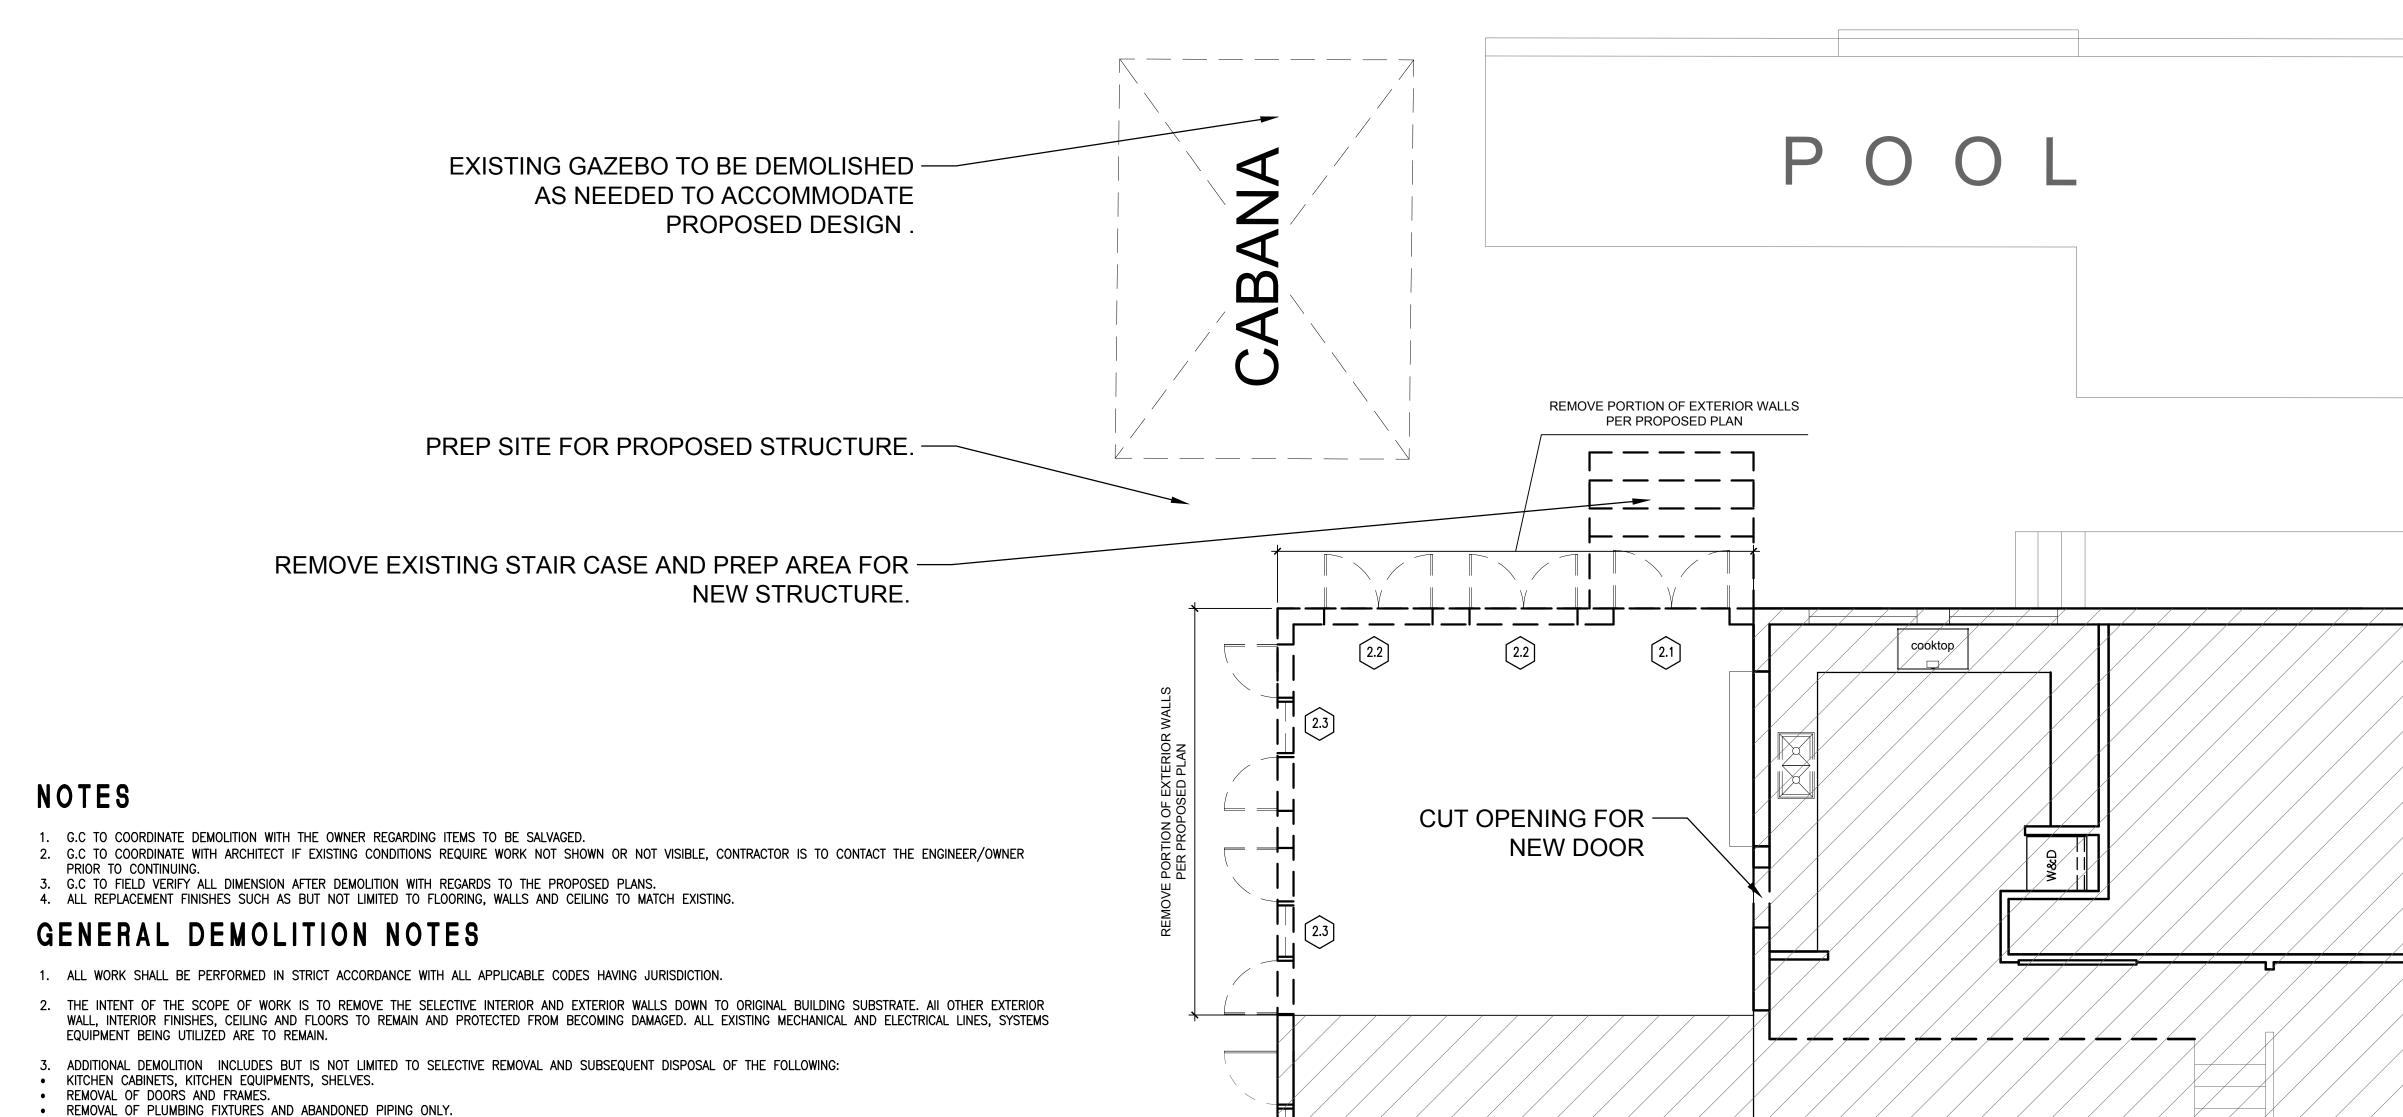

- CUT AND CAP ELECTRICAL AND MECHANICAL WIRES AND A.C. DEFUSE PER PROPOSED PLAN.
- COORDINATE DEMOLITION WITH ALL TRADES TO ASSURE COMPLETE REMOVAL OF ITEMS TO BE DEMOLISHED AND COMPLETE PROTECTION OF AREAS NOT IN DEMOLITION.
- G.C SHALL BE RESPONSIBLE TO PROVIDE TEMPORARY STRUCTURAL SUPPORT TO ROOF/FLOOR STRUCTURE DURING CONSTRUCTION.
- PROTECT FROM DAMAGE EXISTING WORK THAT IS TO REMAIN IN PLACE AND BECOMES EXPOSED DURING DEMOLITION OPERATIONS.
- FEDERAL AND STATE REGULATIONS STATE THAT ALL BUILDINGS SCHEDULED FOR DEMOLITION BE INSPECTED BY THE PALM BEACH COUNTY OFFICE OF ENVIRONMENTAL CONTROL FOR FRIABLE ASBESTOS. IN ADDITION TO THE REQUIRED INSPECTION, A WRITTEN NOTICE OF INTENT TO DEMOLISH MUST BE FILED WITH THE APPROPRIATE REGULATORY AGENCY. THIS NOTIFICATION IS REQUIRED EVEN IF THE BUILDING IS FREE OF ASBESTOS. NOTIFICATION AS OUTLINED BY THE NATIONAL EMISSION STANDARDS OF HAZARDOUS AIR POLLUTANTS, ASBESTOS NOTIFICATIONS REQUIREMENTS, BUILDING DEMOLITION/RENOVATION MUST BE COMPLETED BY THE CONTRACTOR.
- ALL ELECTRICAL AND MECHANICAL EQUIPMENT AND SYSTEMS SHALL BE OPERATED IN THE PRESENCE OF REPRESENTATIVES OF THE CONTRACTOR AND REPRESENTATIVES OF THE OWNER PRIOR TO ANY DEMOLITION, OR PRIOR TO DISCONNECTING ANY ELECTRICAL WIRING IN ORDER TO ESTABLISH THAT ALL SYSTEMS ARE IN PROPER WORKING ORDER AT THE START OF THE PROJECT. THIS WOULD ESTABLISH THE DEGREE OF RESPONSIBILITY THAT THE CONTRACTOR WILL HAVE WHEN HE IS REQUIRED TO PLACE THESE SYSTEMS BACK IN WORKING ORDER AT THE END OF THE PROJECT. IF UNANTICIPATED MECHANICAL, ELECTRICAL, OR STRUCTURAL ELEMENTS WHICH CONFLICT WITH THE INTENDED FUNCTION OR DESIGN ARE ENCOUNTERED, INVESTIGATE AND MEASURE BOTH NATURE AND EXTENT OF THE CONFLICT AND NOTIFY THE OWNER'S REPRESENTATIVE, ARCHITECT OR RESPECTIVE ENGINEER FOR DIRECTIVE. PROTECT ALL ACTIVE PLUMBING, ELECTRICAL, MECHANICAL LINES AND SYSTEMS TO REMAIN OPERATIVE AND EXPOSED INTO VIEW.
- REMOVE ALL ABANDONED PLUMBING, ELECTRICAL AND MECHANICAL LINES NOT IN USE. MAINTAIN EXISTING FIRE SEPARATION SEALANT AND CAULKING AT ALL FLOOR, CEILING AND WALL PENETRATIONS INTO ADJACENT OCCUPIED SPACES.


	DEMOLITION LEGEND								
	EXISTING FRAME WALLS TO REMAIN		EXISTING AREA TO BE PROTECTED FROM BECOMING DAMAGE						
====	EXISTING FRAME WALLS TO BE REMOVED								
	EXISTING DOORS TO BE REMOVED AND REUSED WHERE NOTED								
	EXISTING DOORS TO REMAIN								

#### 1 WOODS & PLASTIC

1.1 REMOVE WOOD SIDING AND STRUCTURE DOWN TO FLOORING.
G.C SHALL BE RESPONSIBLE TO TEMPORARY SUPPORT STRUCTURE DURING CONSTRUCTION.

#### 2 DOORS & WINDOWS

- 2.1 REMOVE AND RELOCATE DOOR AS PER PROPOSED PLAN
- 2.2 REMOVE AND RELOCATE WINDOW AS PER PROPOSED PLAN2.3 REMOVE AND PROPERLY STORE WINDOW FOR FUTURE USE

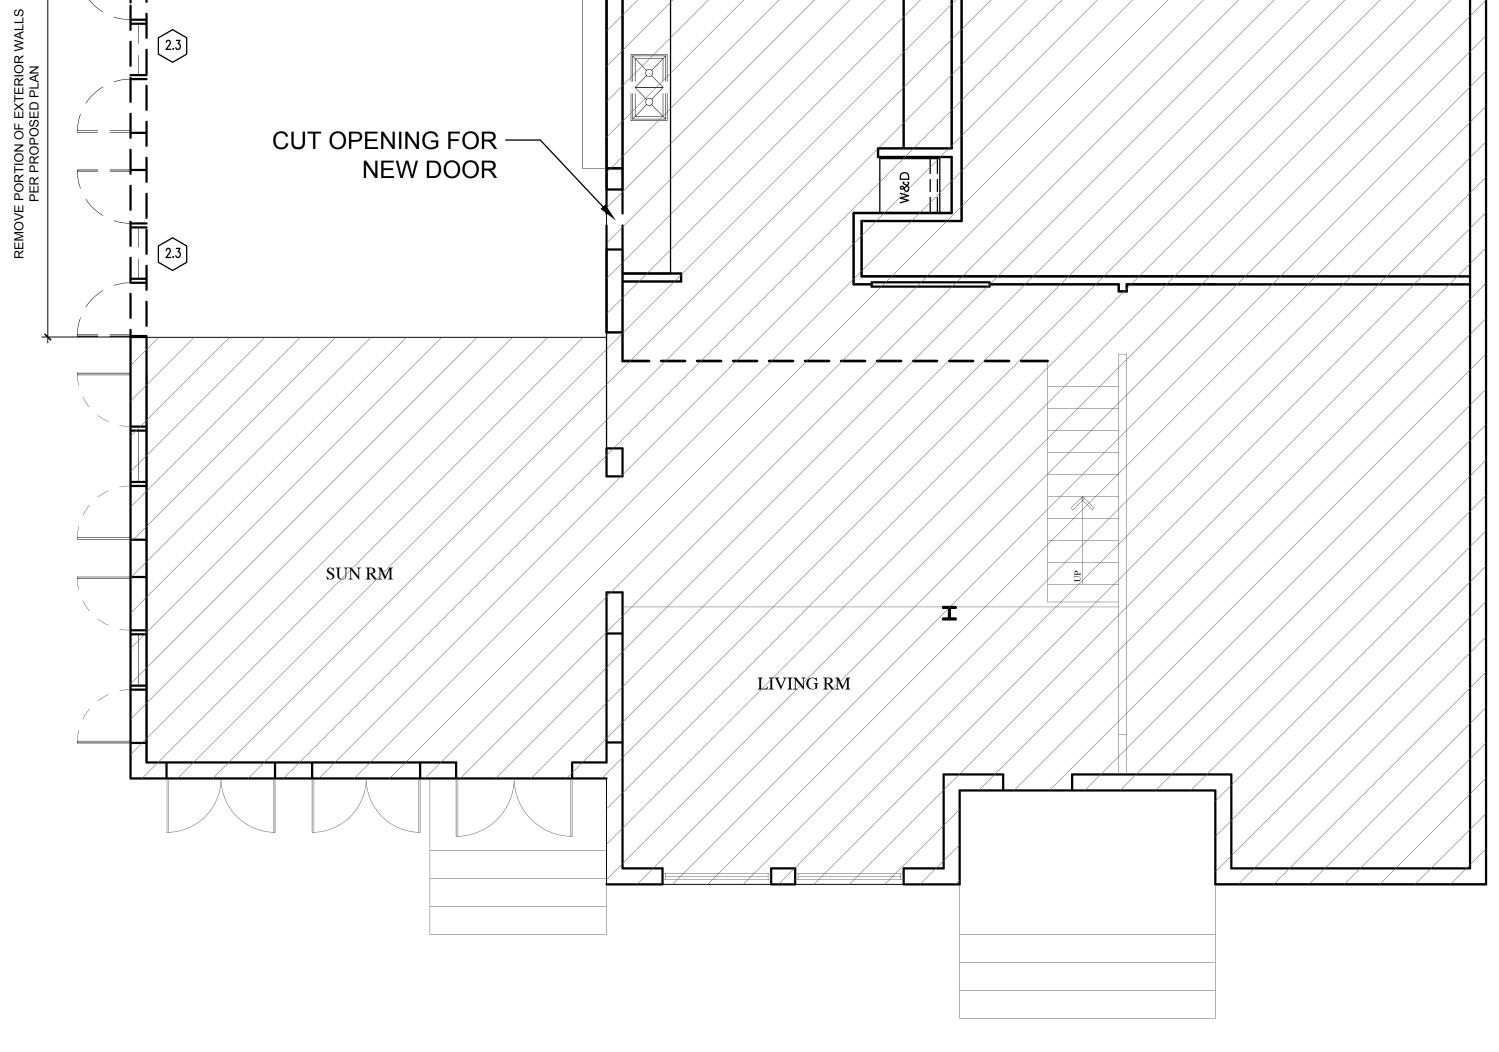

NEXISTING LEVEL 1 FLOOR PLAN

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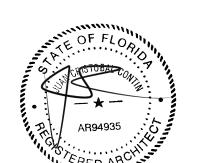
#### REGISTERED ARCHITECT:

JUAN CRISTOBAL CONTIN

FL LICENSE # AR94935

| | 826 S. FEDERAL HIGHWAY

LAKE WORTH, FL 33460



CLIENT:

LEOHR LESLIE S R 2002 TRUST

PROJECT TITLE:

1317 GRINNELL STREET

**PROJECT ADDRESS:** 

1317 GRINNELL STREET KEY WEST, FLORIDA

DATE: 16 JULY, 2018

DRAWN BY:

CHECKED BY:

REVISIONS:

SCALE/NORTH POINT:

AS SHOWN

DRAWING TITLE


EXISTING FLOOR PLAN

DRAWING STATUS:

DRAWING NUMBER:

SCALE : 1/4" = 1'-0"



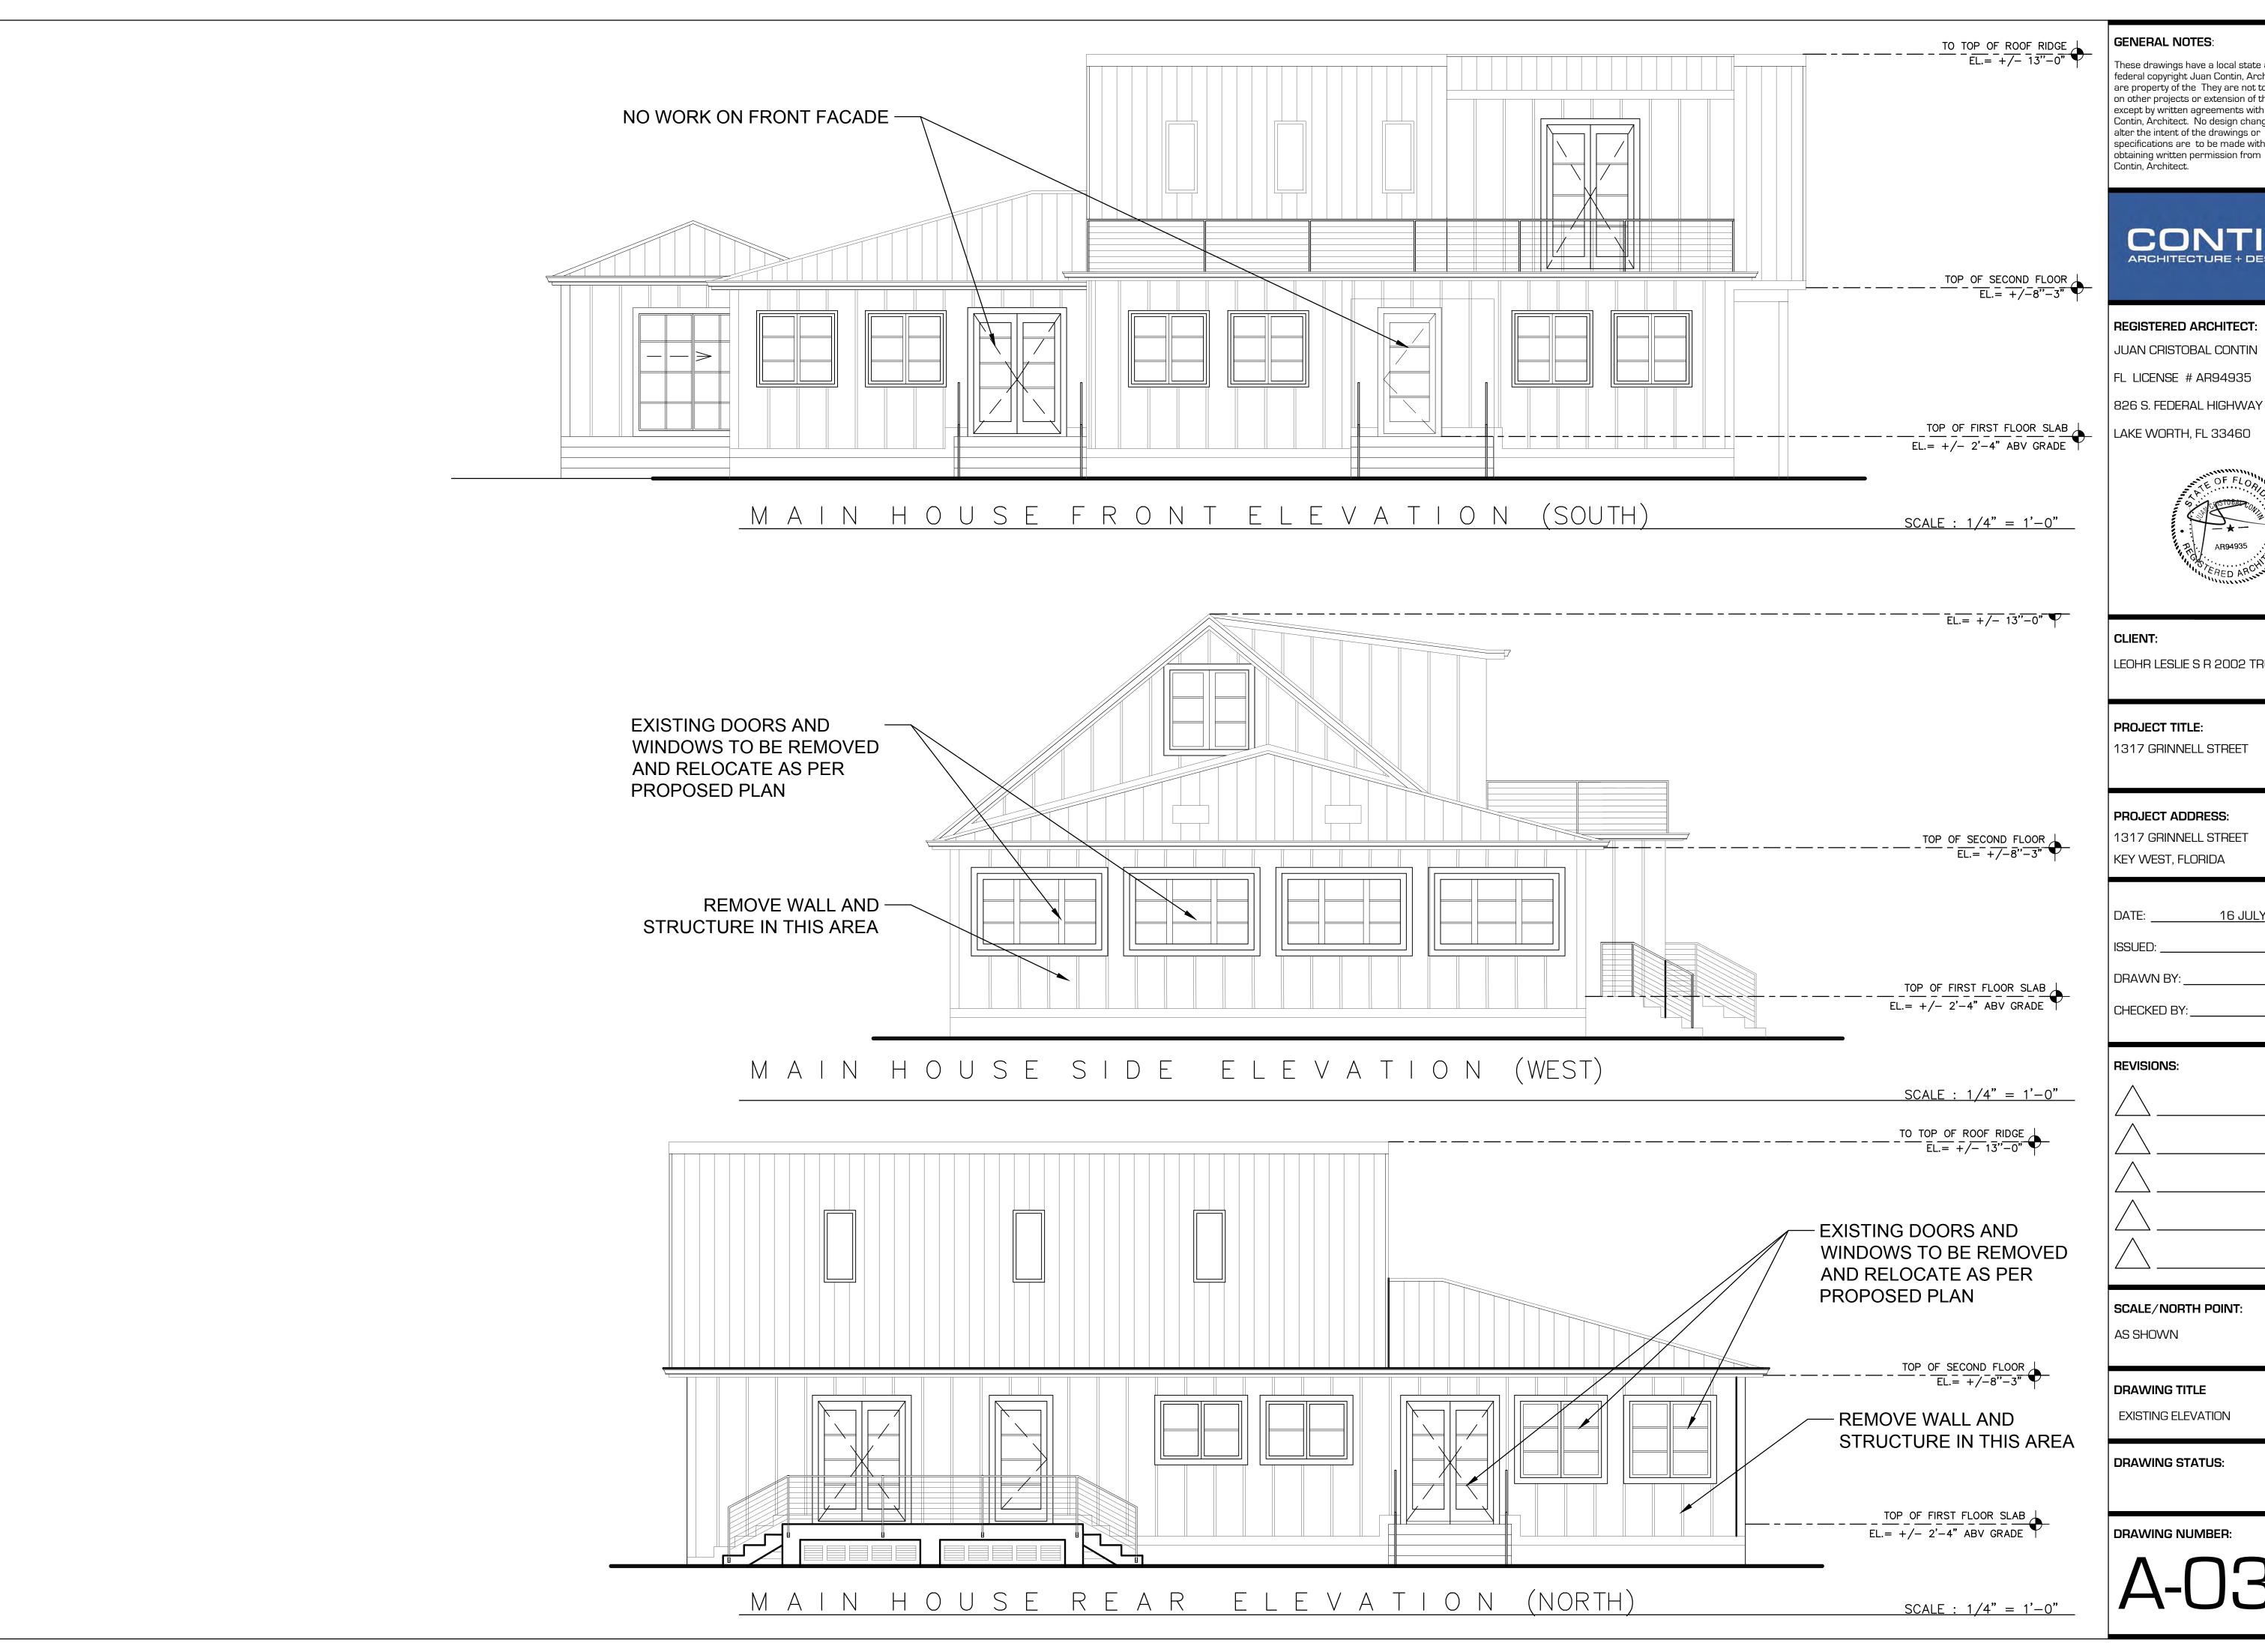


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### CONTIN ARCHITECTURE + DESIGN




LEOHR LESLIE S R 2002 TRUST

16 JULY, 2018

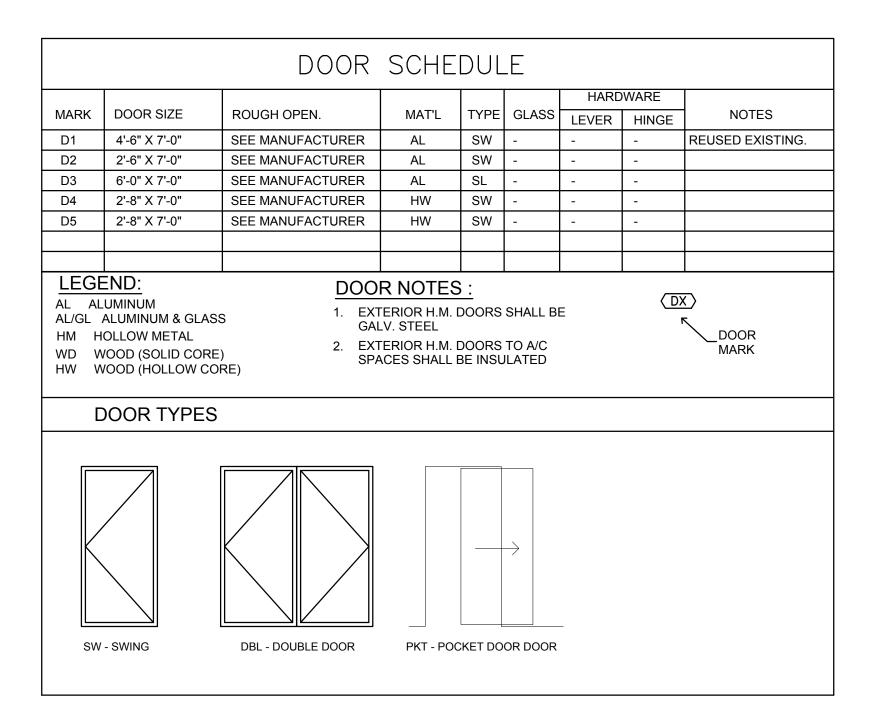

			WINDOW SCH	EDL	JLE	- -	(WX)	V W	/INDOW MARK
MARK	K QTY. WINDOW SIZE					DESCRIPTION  ELEV. MAT'L GLASS HEAD HT.			REMARKS
W-101	1	4'-0" X 4'-0"	SEE MANUFACTURER		AL		8'-0"	С	
V-102	1	3'-10" X 4'-0"	SEE MANUFACTURER		AL		8'-0"	С	
V-103	1	2'-0" X 2'-10"	SEE MANUFACTURER		AL		8'-0"	SH	
V-104	1	3'-4" X 2'-10"	SEE MANUFACTURER		AL		8'-0"	SH	
N-105								С	REUSED EXISTING.
V-106								С	REUSED EXISTING.
WINDOW TYPES									
SH	H - SINGLE I	HUNG F - FIXED	CA - CASEMENT		GL - G	LIDING			AW - AWNING

BUILDING SQUARE FOOTAGE									
MAIN HOUSE									
DESCRIPTION:	UNDER AIR	NOT UNDER AIR							
FIRST & SECOND FLOOR	2,205								
PORCH AND TERRACE		814 SQ. FT.							
TOTAL		3,019 SQ. FT.							
	CABANA								
DESCRIPTION:	UNDER AIR	NOT UNDER AIR							
CABANA	276 SQ. FT.								
PORCH		114 SQ. FT.							
TOTAL		390 SQ. FT.							

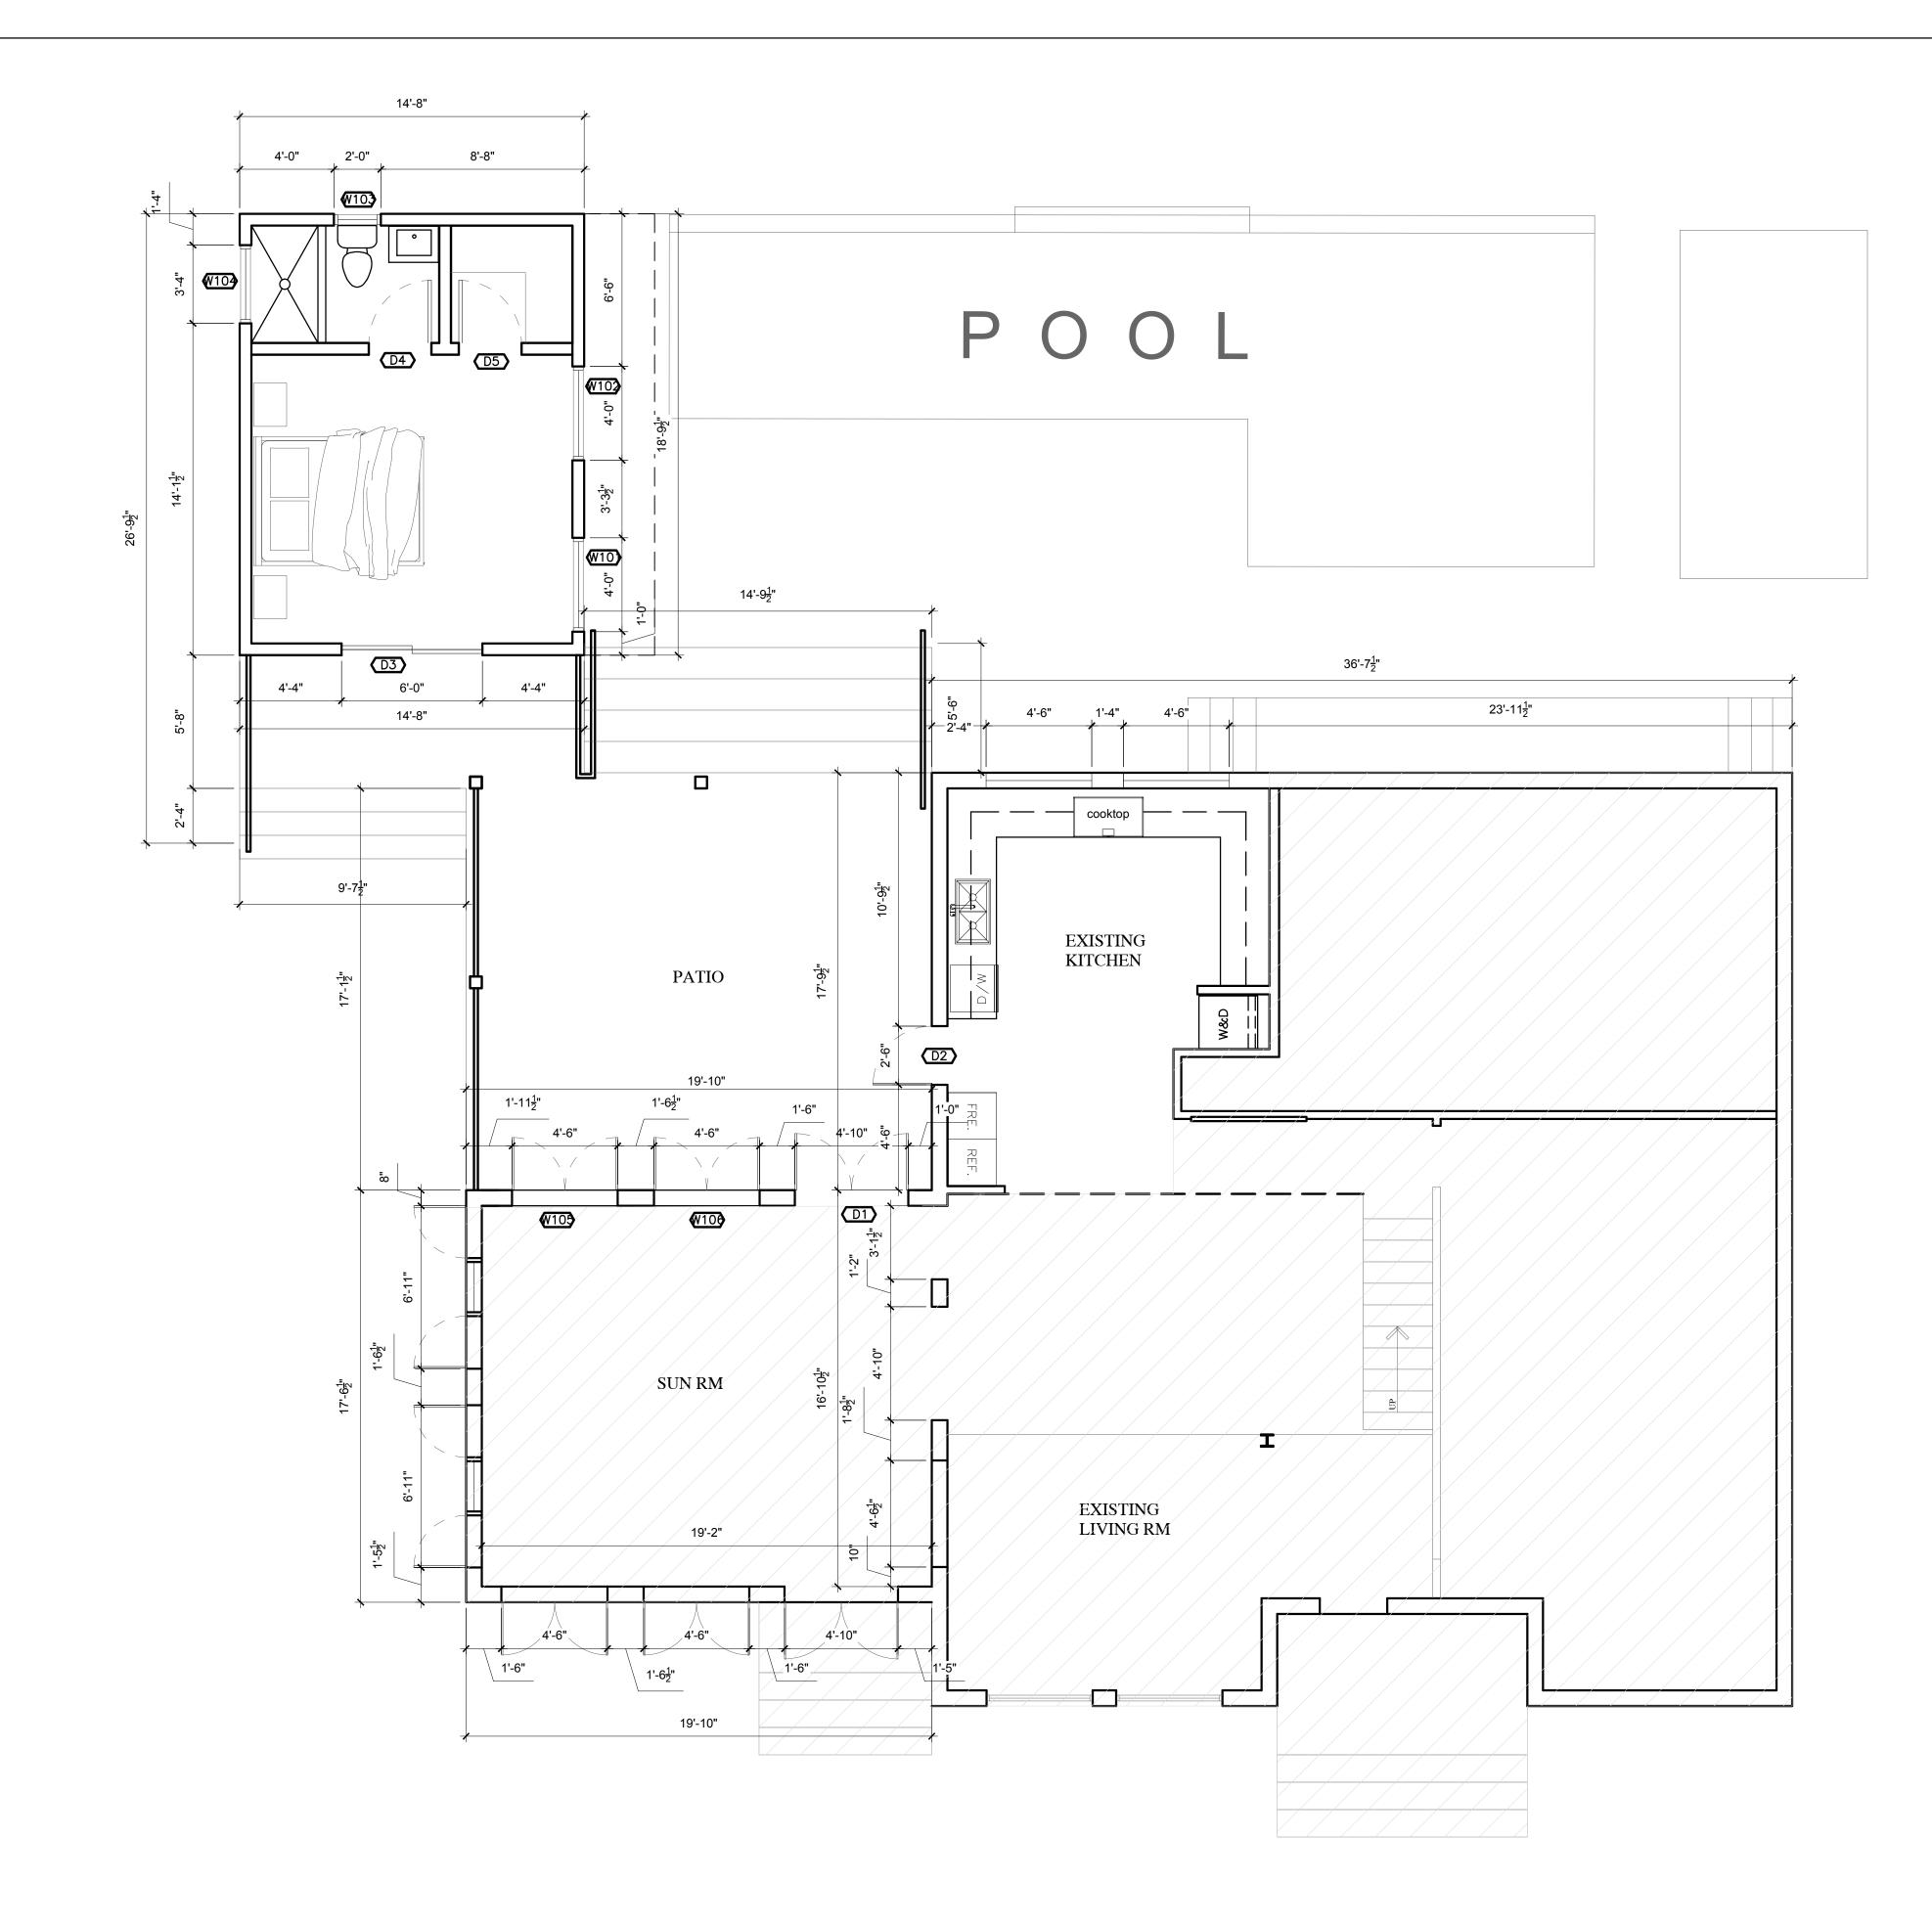

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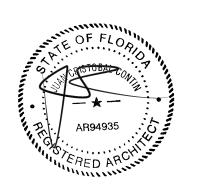
#### REGISTERED ARCHITECT:

JUAN CRISTOBAL CONTIN

FL LICENSE # AR94935

826 S. FEDERAL HIGHWAY

LAKE WORTH, FL 33460



#### CLIENT:

LEOHR LESLIE S R 2002 TRUST

#### PROJECT TITLE:

1317 GRINNELL STREET

#### PROJECT ADDRESS:

1317 GRINNELL STREET KEY WEST, FLORIDA

16 JULY, 2018 DRAWN BY:

REVISIONS:

CHECKED BY:

#### SCALE/NORTH POINT:

AS SHOWN

#### DRAWING TITLE

PROPOSED FLOOR PLAN

DRAWING STATUS:

#### DRAWING NUMBER:





NPROPOSED LEVEL 1 FLOOR PLAN SCALE : 1/4" = 1'-0"





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DATE: \_\_\_\_\_\_\_16 JULY, 2018
ISSUED: \_\_\_\_\_

REVISIONS:

DRAWN BY:

SCALE/NORTH POINT:

AS SHOWN


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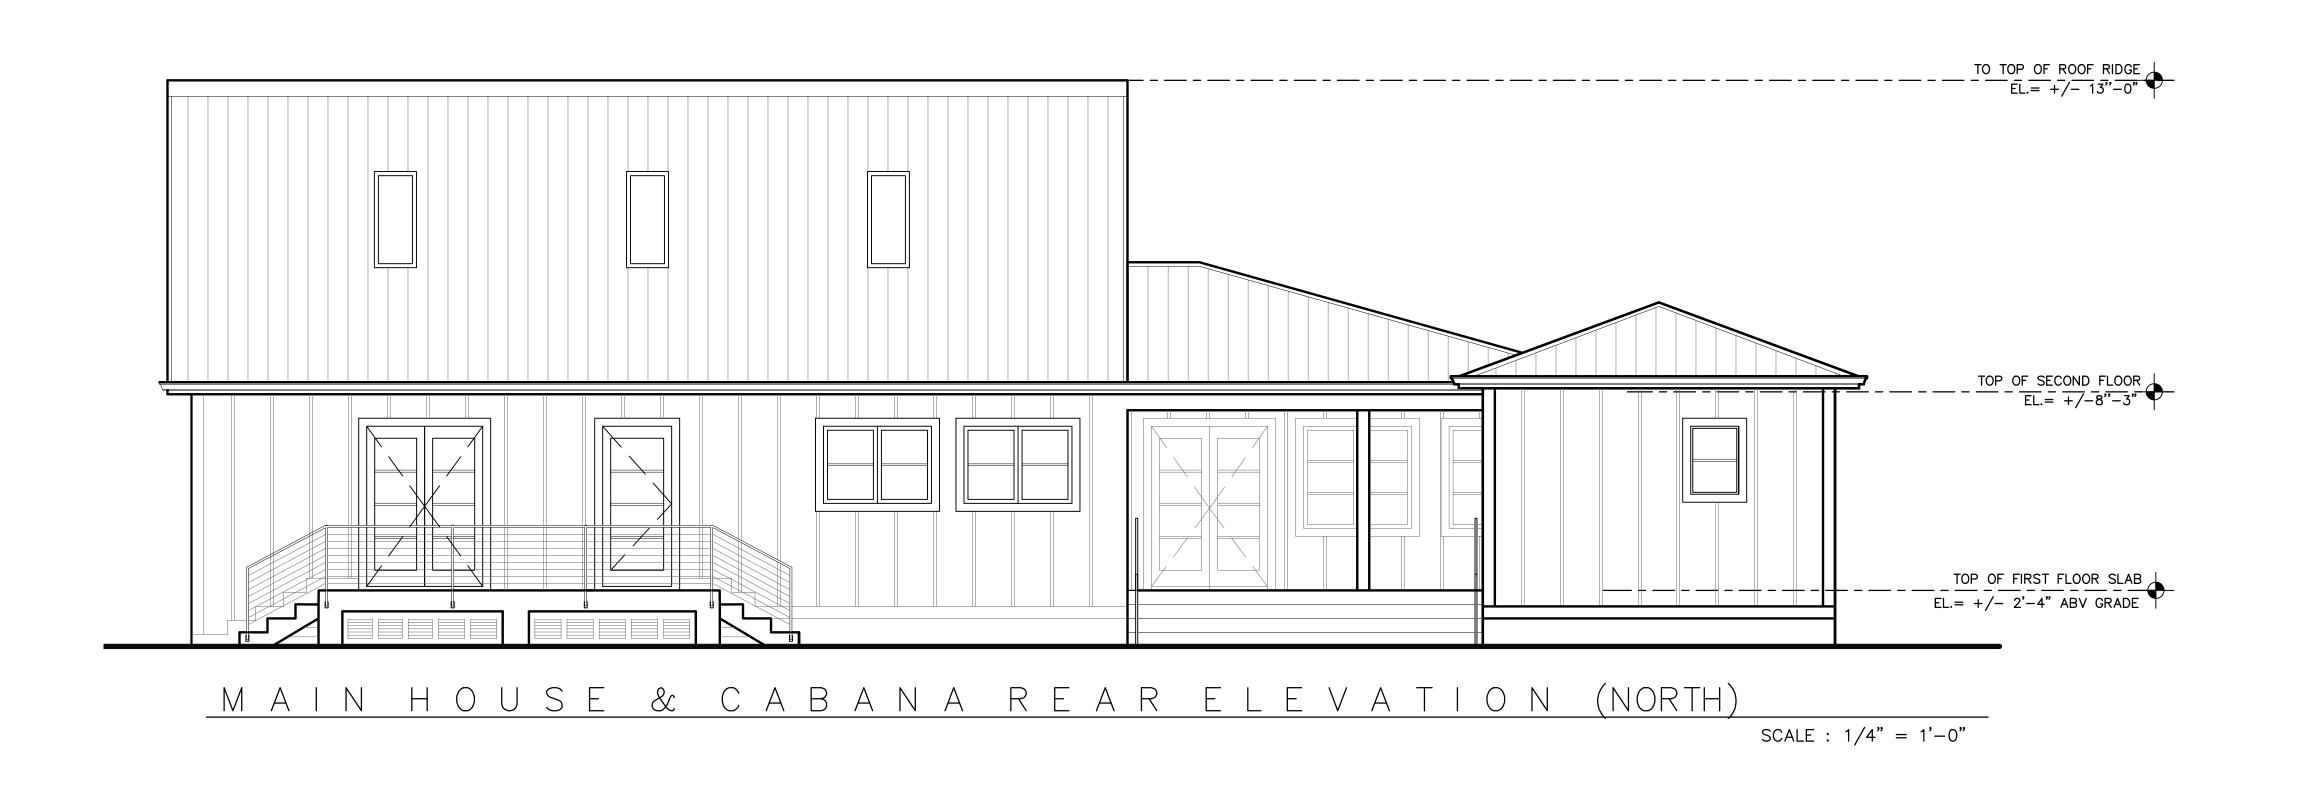
PROPOSED ELEVATION

DRAWING STATUS:

DRAWING NUMBER:

A-05



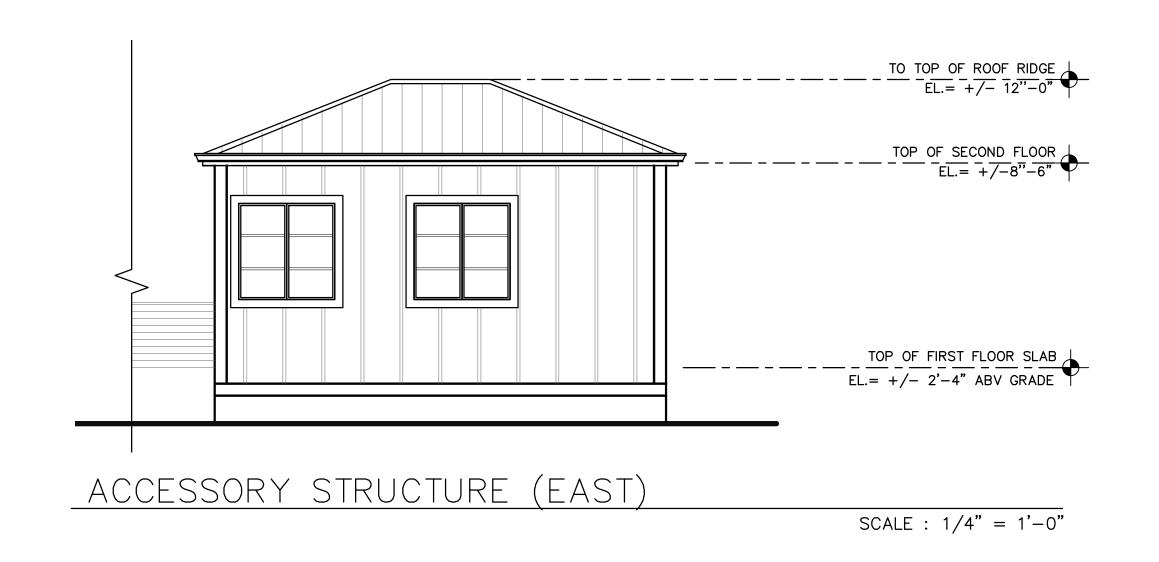

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REGISTERED ARCHITECT:

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FL LICENSE # AR94935

826 S. FEDERAL HIGHWAY

LAKE WORTH, FL 33460



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1317 GRINNELL STREET

PROJECT ADDRESS:

1317 GRINNELL STREET KEY WEST, FLORIDA

DATE: \_\_\_\_\_\_\_16 JULY, 2018 | ISSUED: \_\_\_\_\_

REVISIONS:

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SCALE/NORTH POINT:

AS SHOWN


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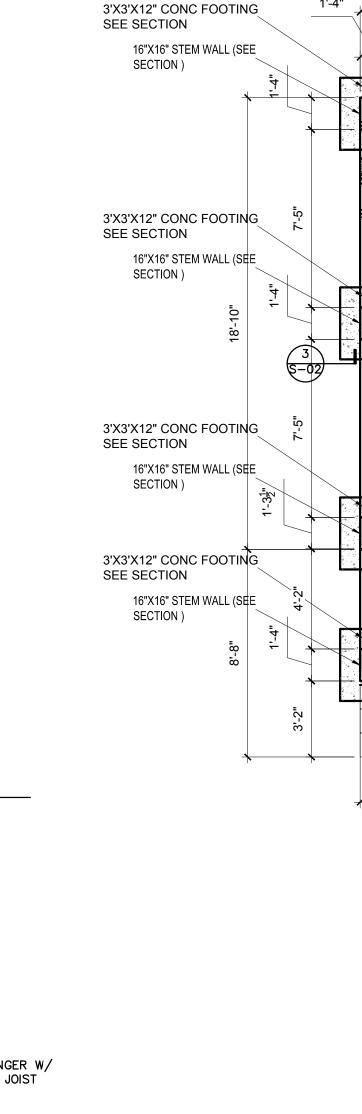
PROPOSED ELEVATION

DRAWING STATUS:

DRAWING NUMBER:

A-5.1



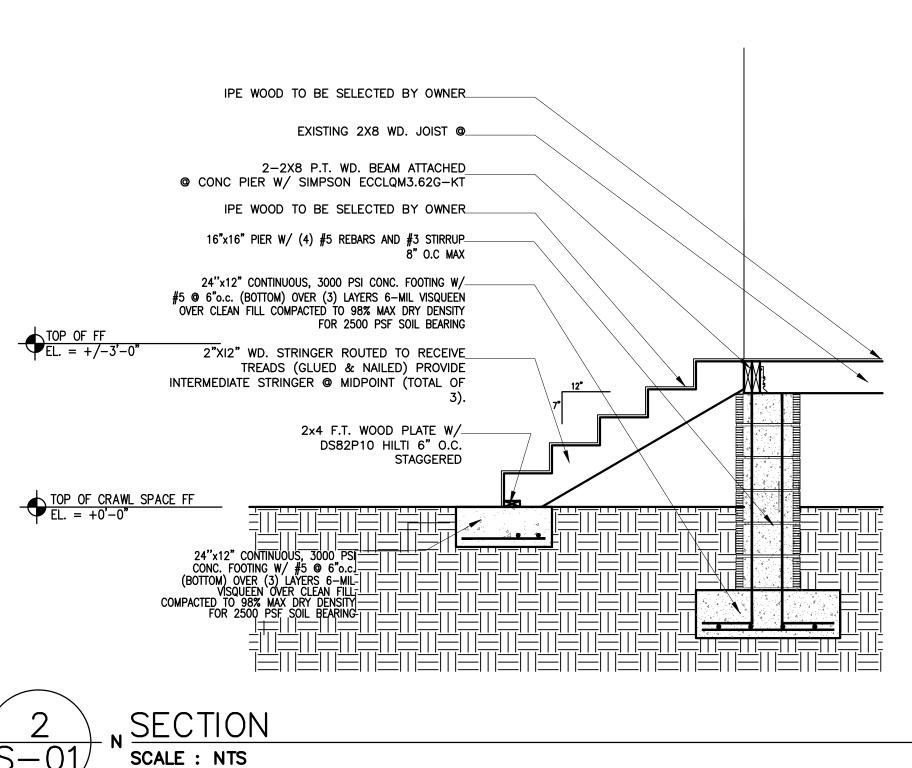

14'-8"

12'-0"

9'-7½" (1 N

3'X3'X12" CONC FOOTING

3'X3'X12" CONC FOOTING

3'X3'X12" CONC FOOTING

\$EE SECTION

SECTION)

EXISTING WOOD BEAMS

16"X16" STEM WALL (SEE

\$EE SECTION

-16"X16" STEM WALL (SEE

SEE SECTION

SECTION)

\_16"X16" STEM WALL (SEE

#### **GENERAL NOTE:**

DENOTES EXISTING STRUCTURE

DENOTES EXIST. NONE LOADBEARING WALL

ALL WORK SHALL BE DONE IN ACCORDANCE WITH LOCAL BUILDING CODES AND AS SHOWN ON THE DRAWINGS TO THE APPROVAL OF THE ENGINEER

AND OWNER.


ÆXISTING AREA (NO WORK TO BE)


/ PERFORMED INSIDE THIS AREA)

CONTRACTOR TO VERIFY ALL CONDITIONS AND MEASUREMENTS AT SITE AS COMPARED TO THE PLANS PRIOR TO PERFORMING WORK.

IF EXISTING CONDITIONS REQUIRE WORK NOT SHOWN OR NOT VISIBLE, CONTRACTOR IS TO CONTACT THE ARCHITECT/OWNER PRIOR TO CONTINUING.

THE CONTRACTOR AND ALL SUB—CONTRACTORS SHALL BE PERMITTED TO VISIT THE SITE PRIOR TO BIDDING TO DETERMINE EXISTING CONDITIONS AND THE EXTENT OF DEMOLITION, REMOVAL, ETC. REQUIRED.

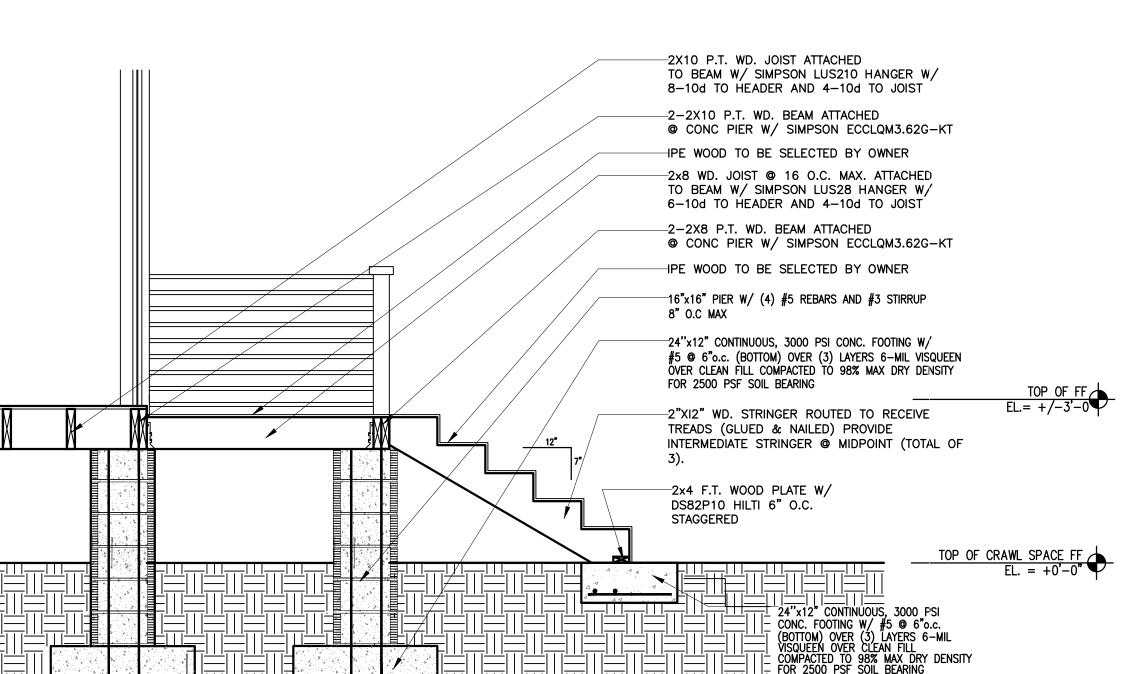

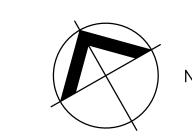

STRUCTURAL PLAN

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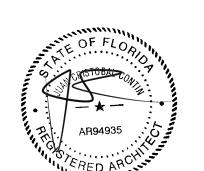
REGISTERED ARCHITECT:

JUAN CRISTOBAL CONTIN

FL LICENSE # AR94935

826 S. FEDERAL HIGHWAY

LAKE WORTH, FL 33460



CLIENT:

LEOHR LESLIE S R 2002 TRUST

PROJECT TITLE:

1317 GRINNELL STREET

PROJECT ADDRESS:

1317 GRINNELL STREET

KEY WEST, FLORIDA

16 JULY, 2018

\_\_\_\_\_

DRAWN BY: \_\_\_\_

CHECKED BY:

REVISIONS:

<u>\_\_\_\_\_</u>

\_\_\_\_\_

SCALE/NORTH POINT:

AS SHOWN

DRAWING TITLE

PROPOSED FRAMING PLAN


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DRAWING NUMBER:


SCALE : 1/4" = 1'-0"

S-01

 $\frac{3}{S-O1}$  N SECTION SCALE : NT



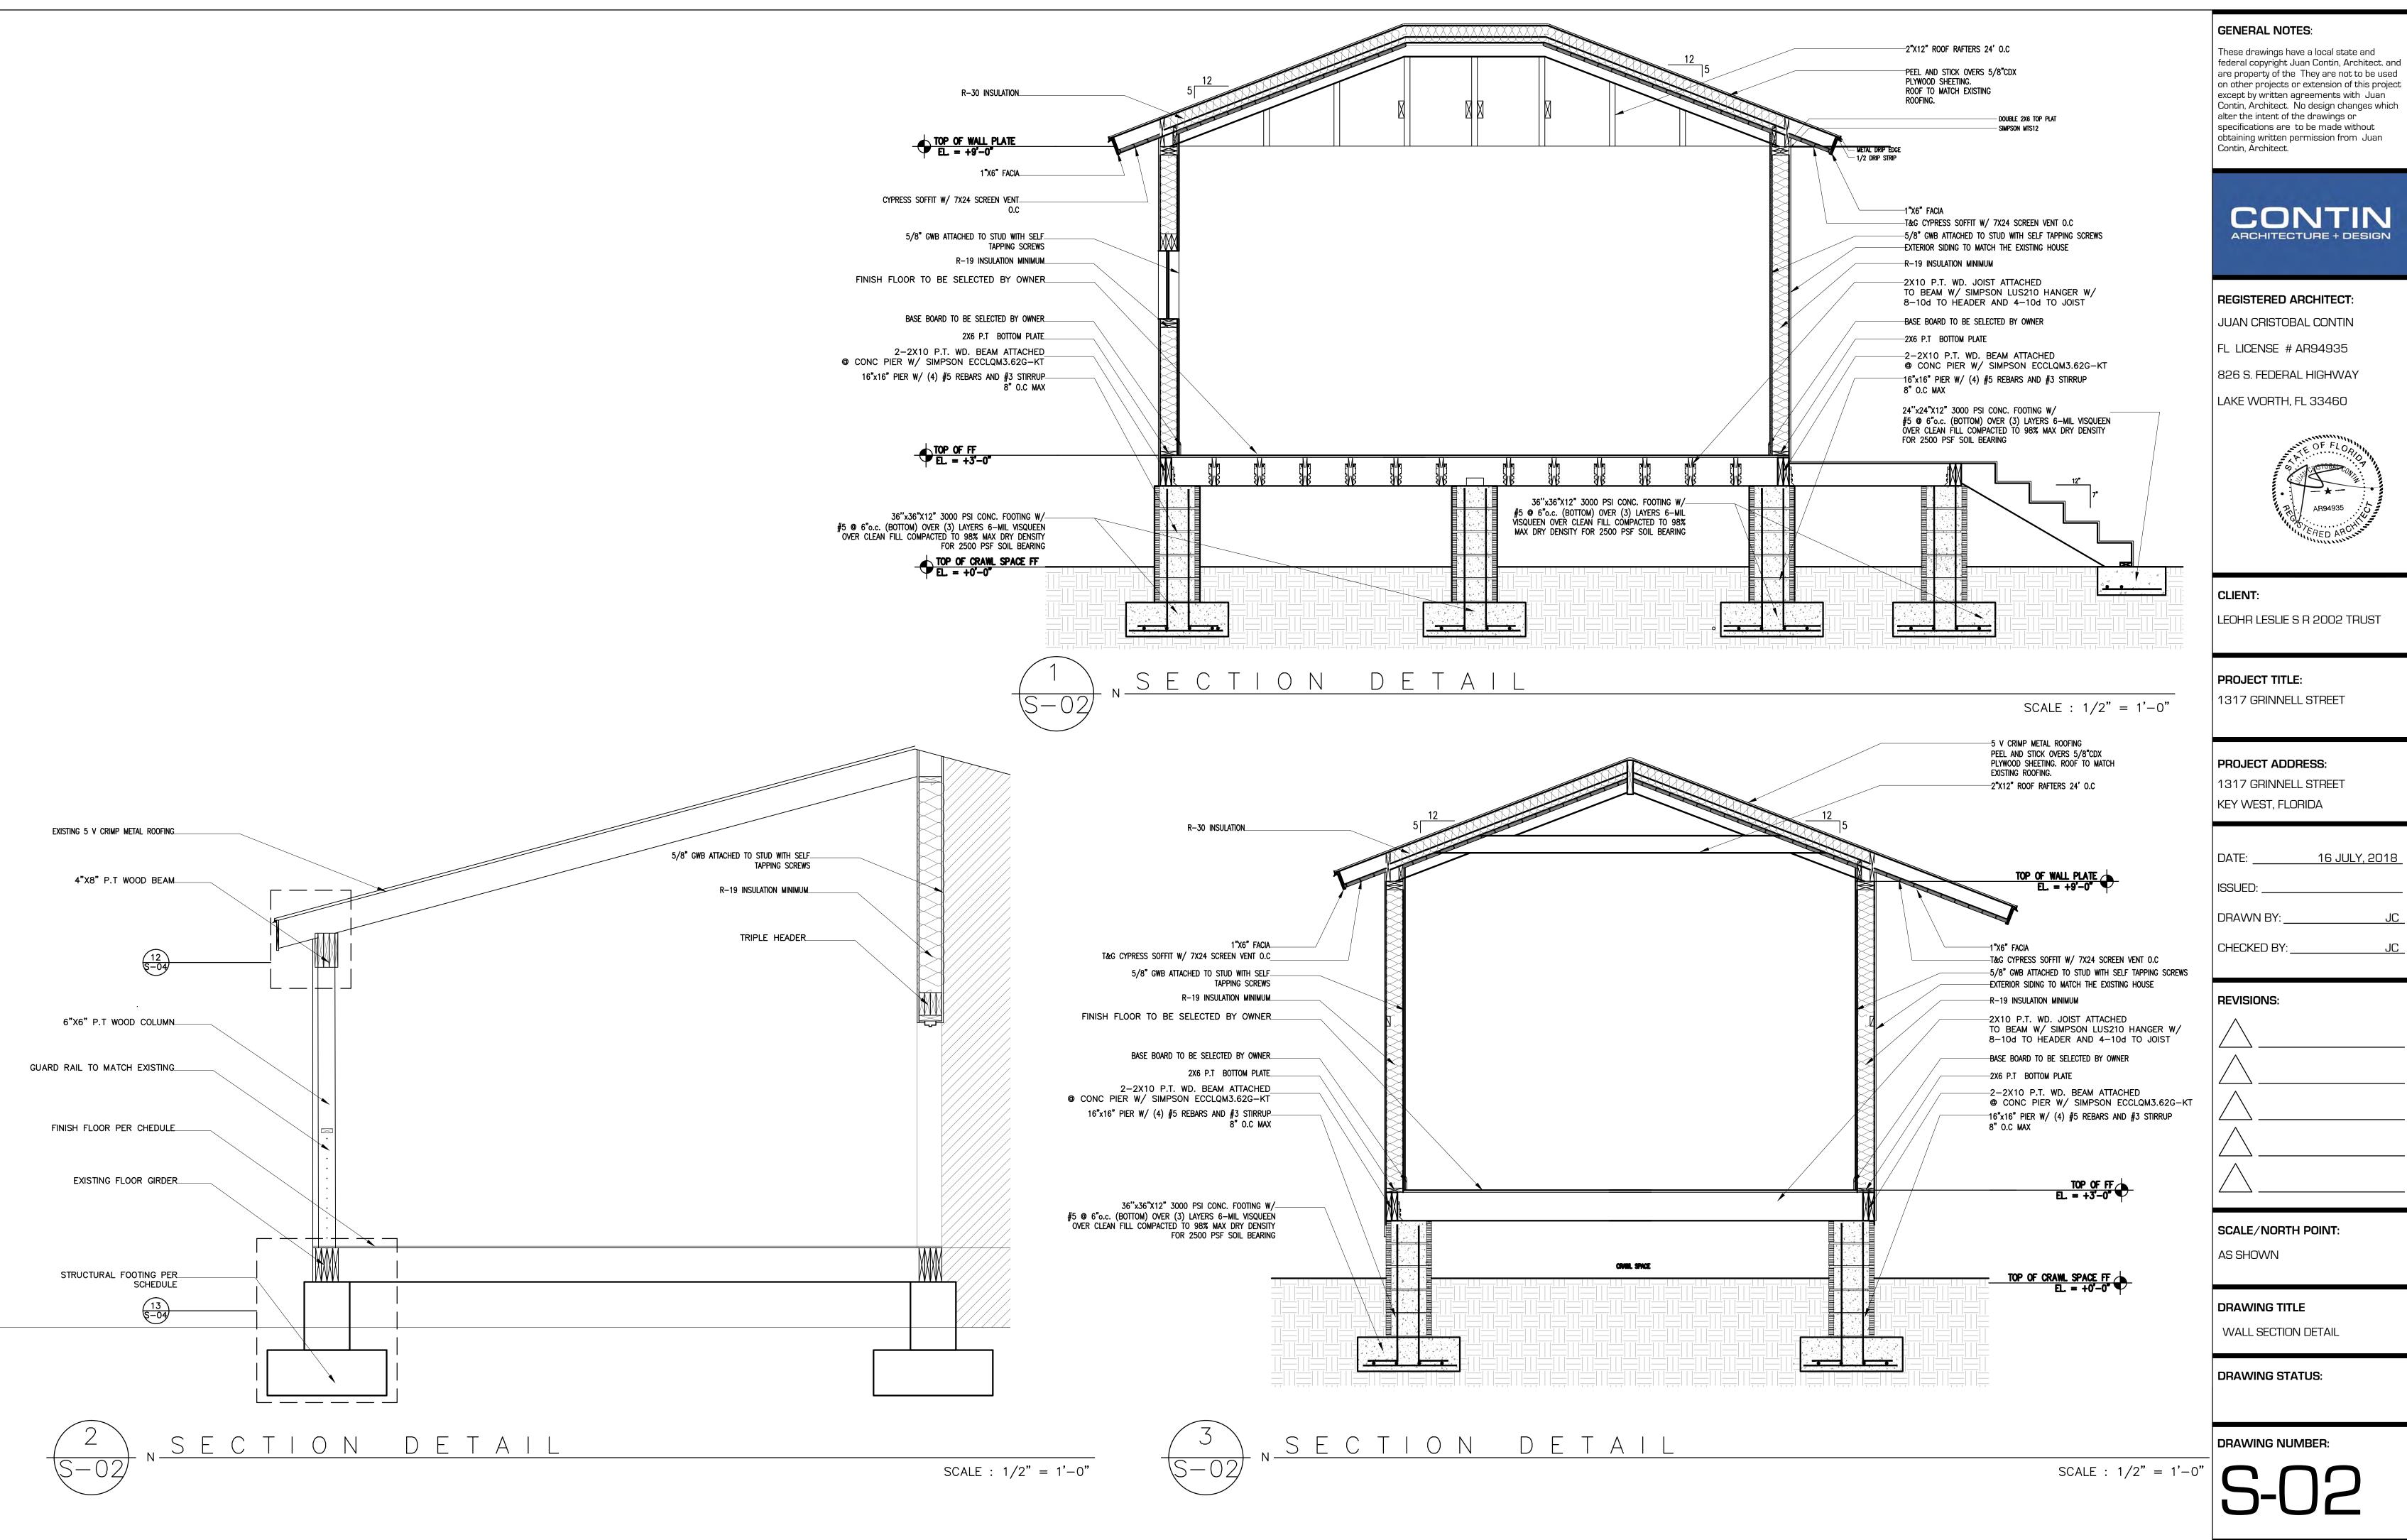

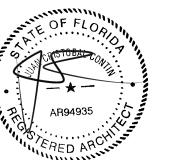

#### STRUCTURAL DESIGN CRITERIA & CODES

THIS STRUCTURE HAS BEEN DESIGNED IN ACCORDANCE WITH THE FLORIDA BUILDING CODE FBC 2017.

WIND LOADS ARE BASED ON THE ANSI/ASCE 7-10 MINIMUM DESIGN LOADS FOR BUILDINGS AND OTHER STRUCTURES. ALL PRIMARY FRAMING AND EXTERIOR ENVELOPE COMPONENTS AND CLADDING SHALL BE DESIGNED AND CONSTRUCTED TO RESIST THE LOADS AND FORCES DERIVED FROM THIS STANDARD.

GRAVITY DESIGN LOADINGS FOR THIS PROJECT ARE AS FOLLOWS:

STAIR DEAD LOAD, 100 PSF FLOOR DEAD LOAD: 20PSF STAIR LIVE LOAD, 100 PSF FLOOR LIVE LOAD: 50PSF

TERRACE DEAD LOAD, 20 PSF ROOF DEAD LOAD: 20PSF TERRACE LIVE LOAD, 50 PSF ROOF LIVE LOAD: 30PSF

WIND DESIGN CRITERIA

ULTIMATE DESIGN WIND SPEED, Vult: 170MPH (3-SECD GUST)
NOMINAL DESIGN WIND SPEED, Vest: 132MPH (3-SECD GUST)
RISK CATEGORY: II


EXPOSURE: C
IMPORTANCE FACTOR: 1=1.0
EDGE ZONE DIMENSION: A=4'


ACTUAL PRESSURES FOR SPECIFIC COMPONENTS AND CLADDING MATERIALS SHALL BE CALCULATED BASED ON THE SPECIFIC TRIBUTARY AREA (IN SQ. FT.) CONSIDERED.


MAIN BUILDING

BASIC VELOCITY PRESSURE: 32.03 PSF INT. PRESSURE COEFFICIENT: +0.18 "a" DIMENSION: 4.0'

COMPONENTS AND CLADDING											
ZONE					1	l	T				
	1 S.F.	2-10	11-20	21-30	31-40	41-50	51-50	>100			
ROOF 1	+21.78 -34.59										
ROOF 2/2 O.H	+21.78 -70.78										
ROOF 3/3 O.H	+21.78 -118.51										
WALLS 4	+34.84 -38.04	+34.84 -38.04	+34.84 -38.04	+34.84 -38.04	+34.39 -37.59	+33.84 -37.04	+32.14 -35.34	+32.14 -35.34			
WALLS 5	+34.84 -44.69	+34.84 -44.69	+34.84 -44.69	+34.84 -44.69	+34.84 -43.80	+34.39	+33.84	+32.14			

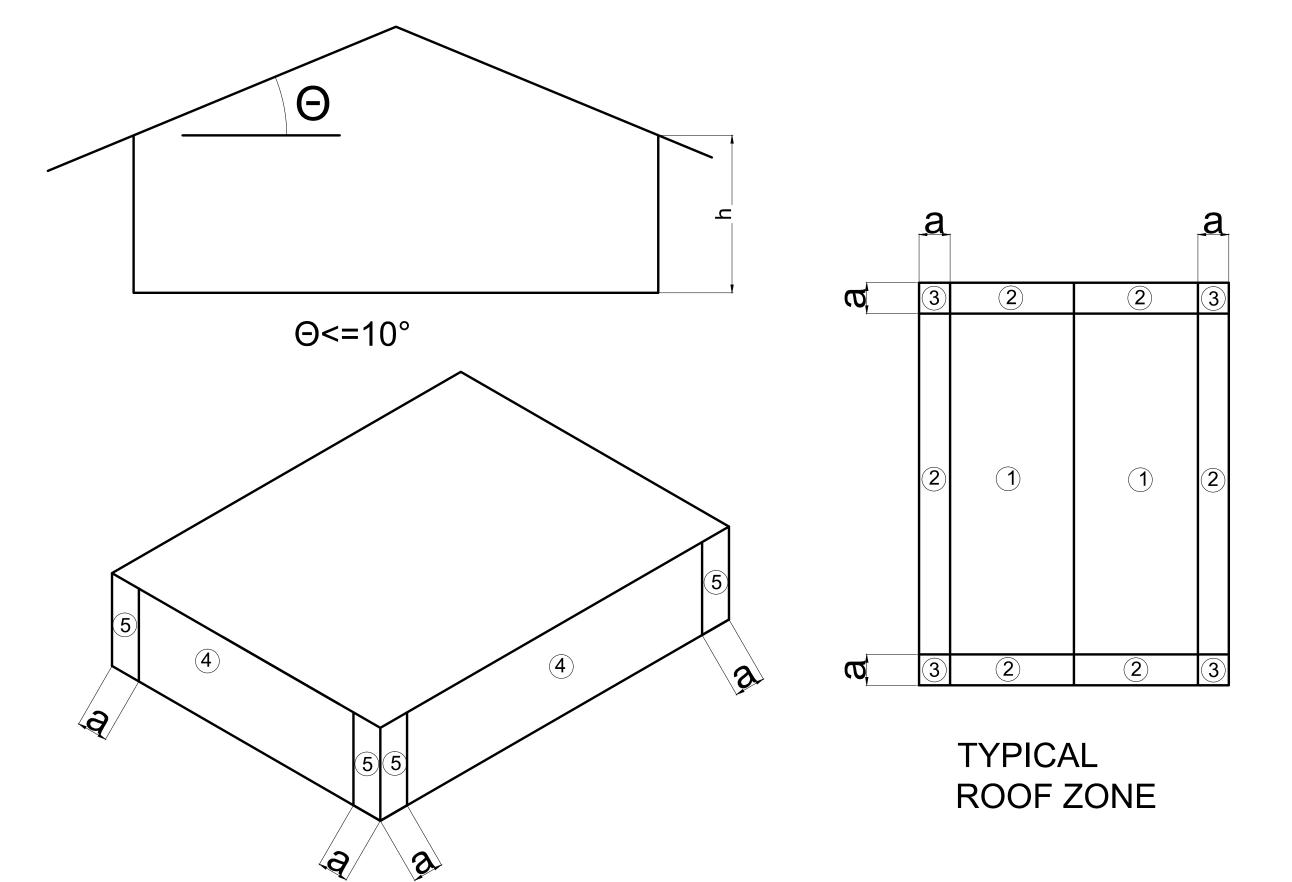

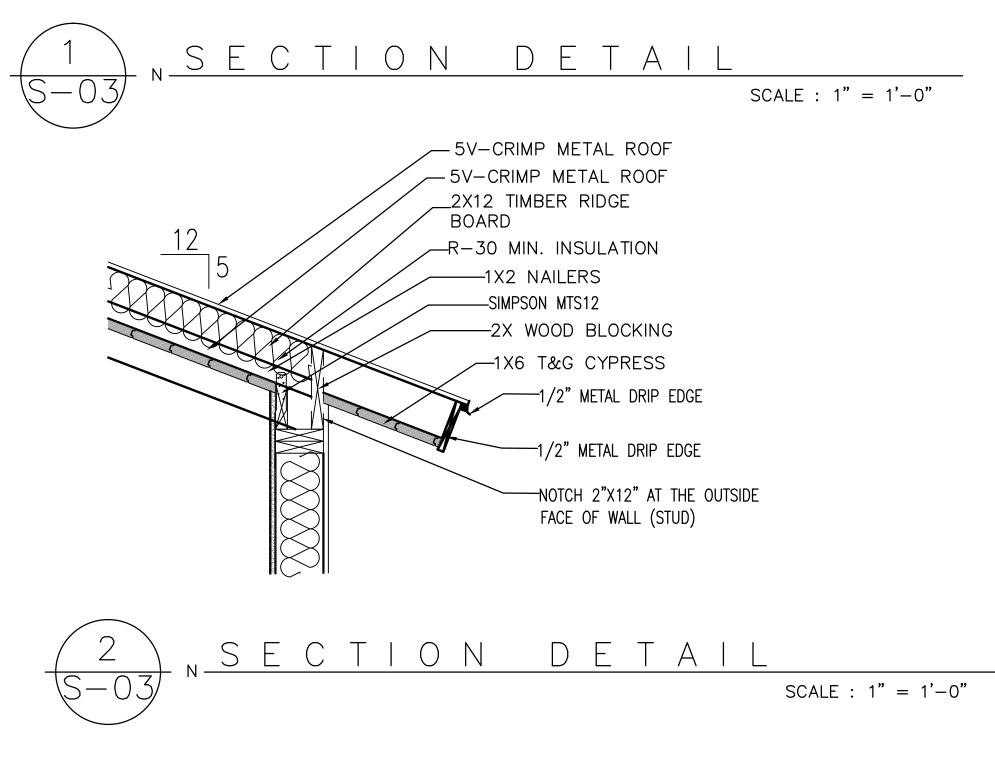

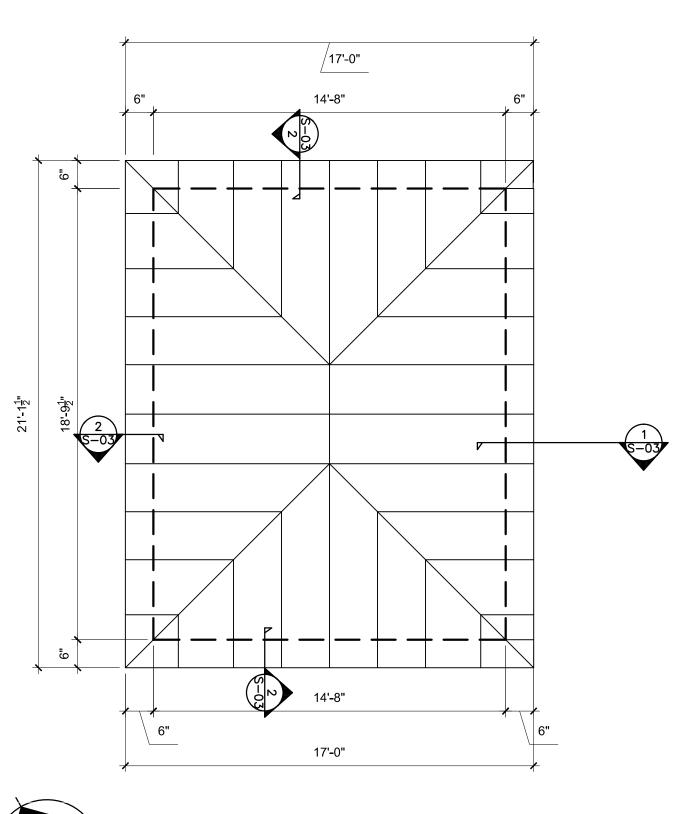



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REGISTERED ARCHITECT:

JUAN CRISTOBAL CONTIN

FL LICENSE # AR94935

| | 826 S. FEDERAL HIGHWAY

LAKE WORTH, FL 33460



CLIENT:

LEOHR LESLIE S R 2002 TRUST

PROJECT TITLE:

1317 GRINNELL STREET

PROJECT ADDRESS:

1317 GRINNELL STREET KEY WEST, FLORIDA

DATE: 16 JULY, 2018

DRAWN BY:

REVISIONS:

CHECKED BY:

SCALE/NORTH POINT:

DRAWING TITLE

ROOF FRAMING PLAN


AS SHOWN

DRAWING STATUS:

DRAWING NUMBER:


SCALE : 1/4" = 1'-0"


S-03

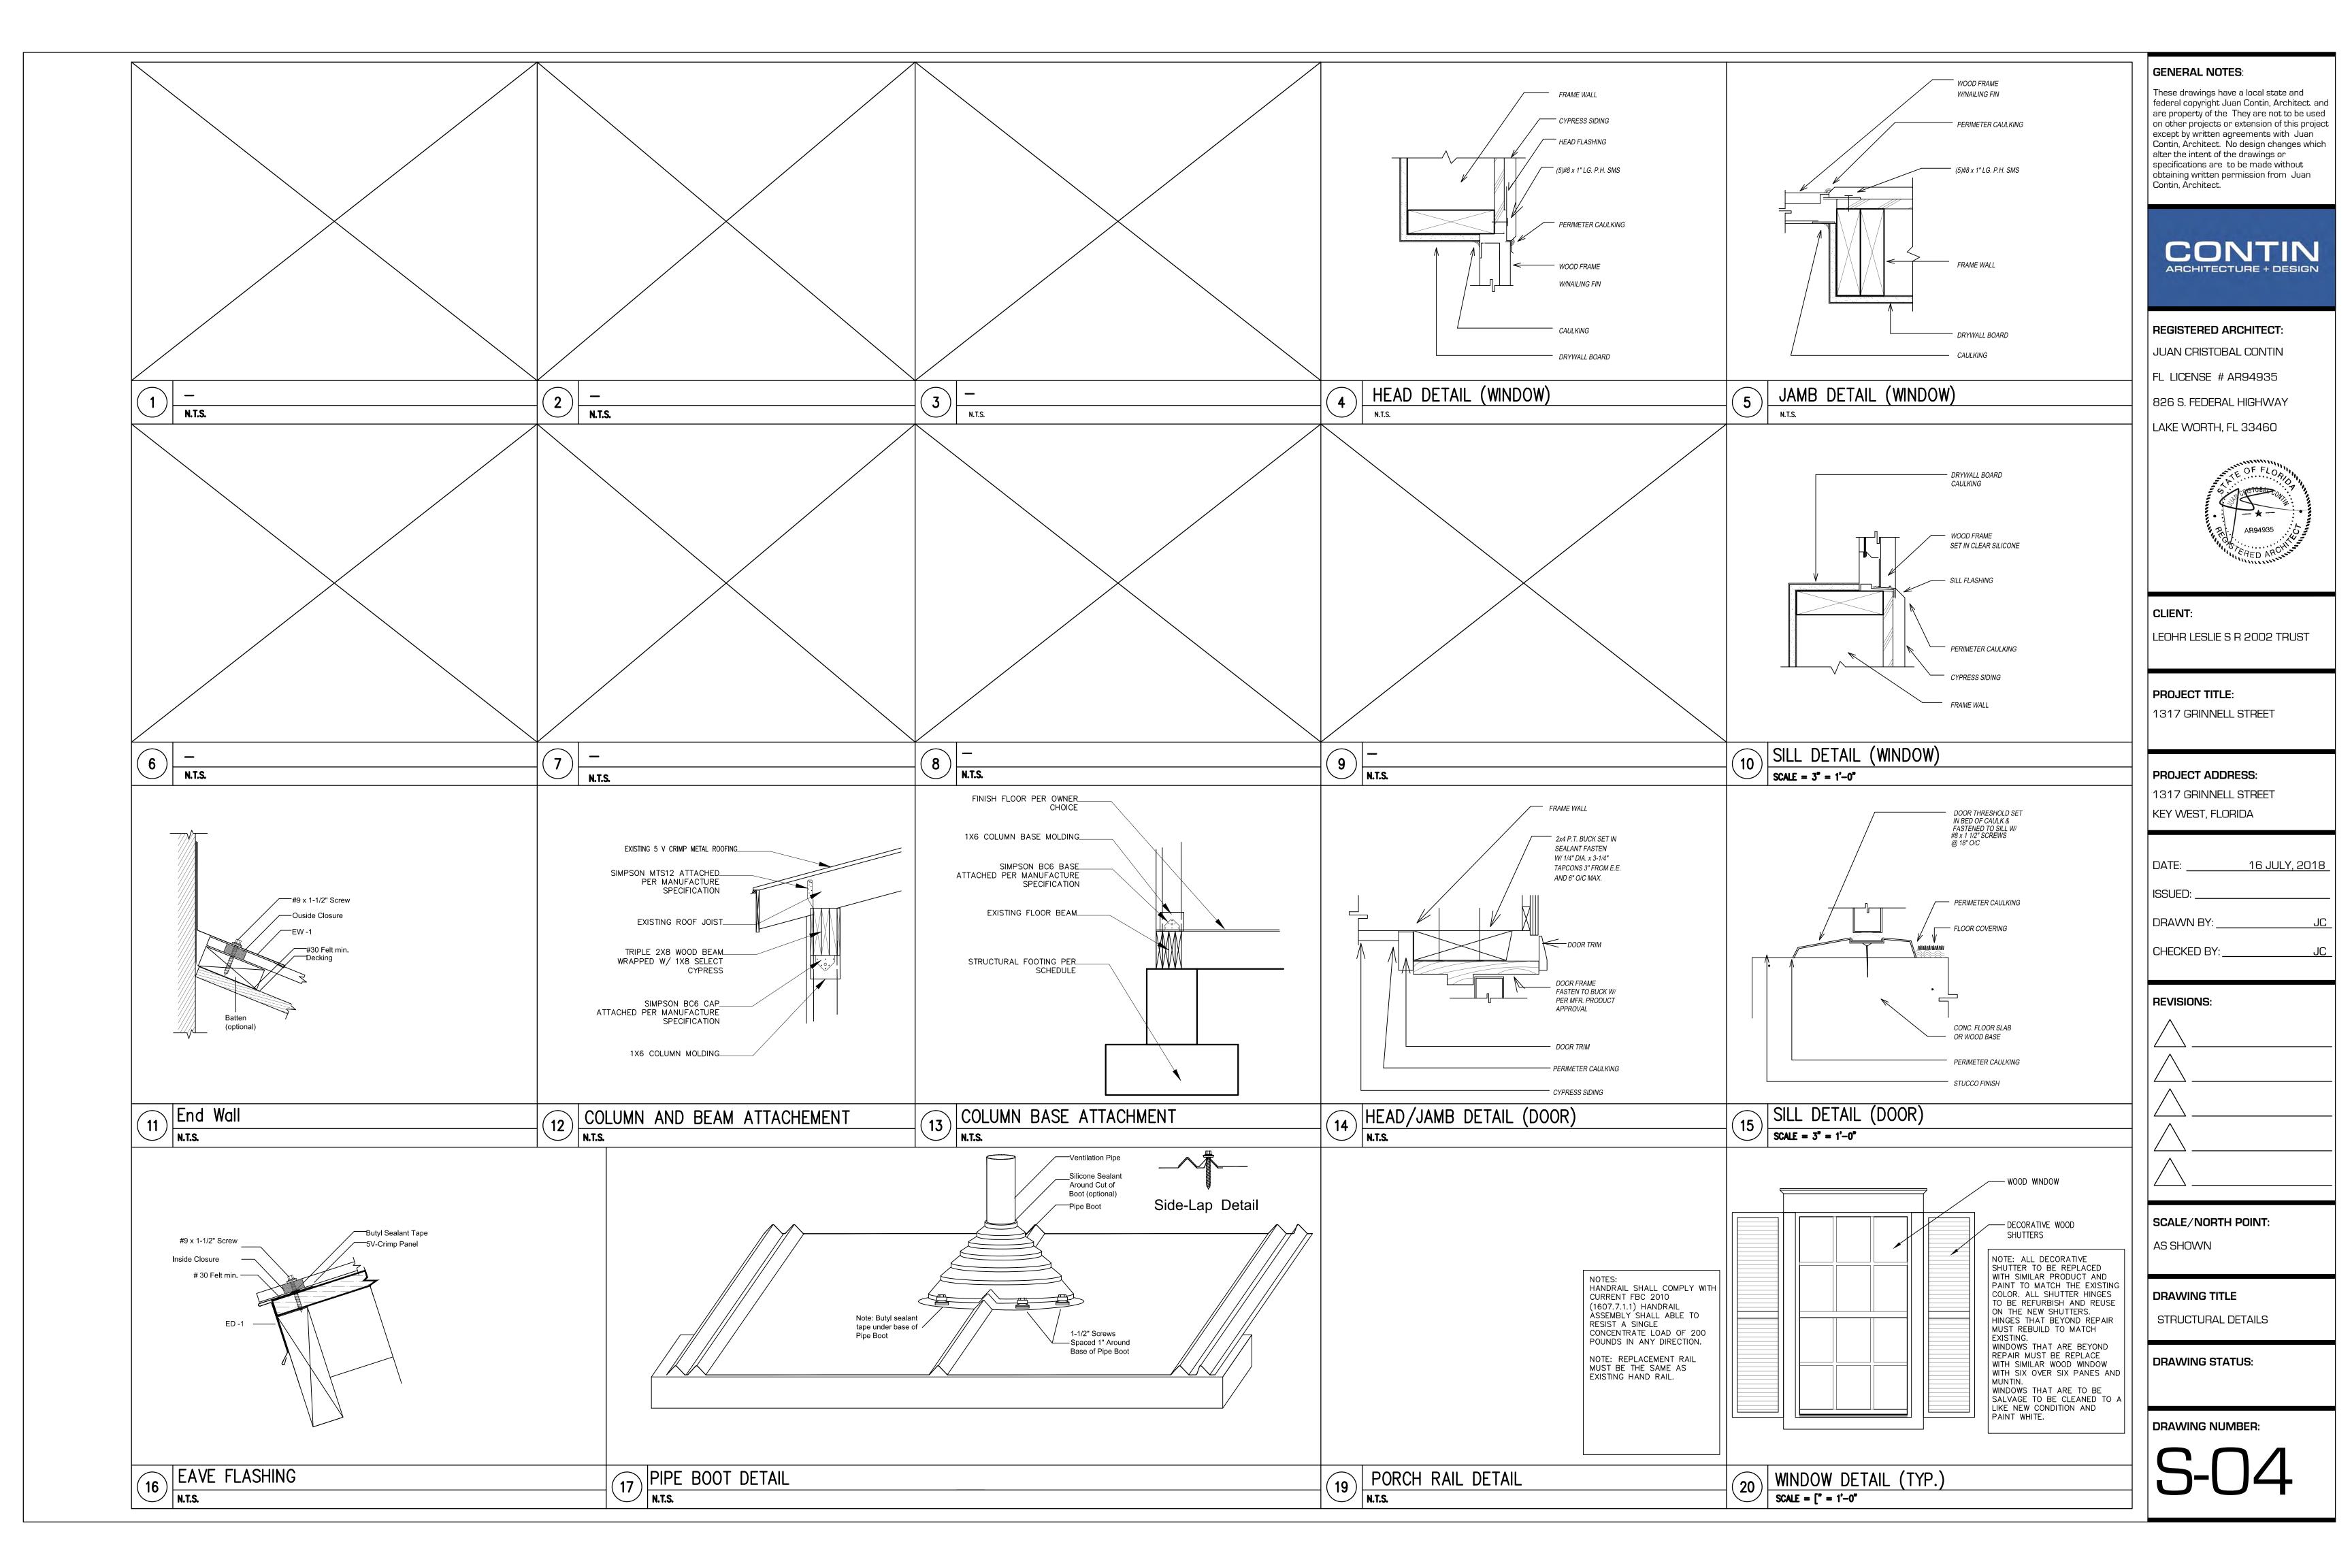

#### PLUMBING NOTES

- 1. INSTALLATION SHALL BE IN ACCORDANCE WITH THE FLORIDA BUILDING CODE 2017,
- AND ALL LOCAL CODES.
- 2. ALL MATERIALS SHALL BE NEW AND CODE APPROVED.
- 3. VERIFY ALL EXISTING SANITARY AND WATER CONDITIONS IN THE BUILDING. ALL NEW DOMESTIC WATER PIPING SHALL BE COPPER. ALL NEW SANITARY PIPING SHALL HUBLESS C.I. OR PVC. AS REQUIRED TO INTEGRATE WITH EXISTING PIPING
- 4. THE PLUMBING SUB-CONTRACTOR SHALL FURNISH A WRITTEN GUARANTEE THAT PLUMBING WORK IS FREE FROM DEFECTS IN MATERIALS AND WORKMANSHIP FOR A PERIOD OF ONE YEAR FROM THE DATE OF ACCEPTANCE BY OWNER. REPAIR OR REPLACE ALL WORK WHICH BECOMES DEFECTIVE AT NO COST TO OWNER.
- 5. PLUMBING SUB—CONTRACTOR SHALL PROVIDE REQUIRED PERMITS.6. INSTALL PLUMBING FIXTURES AS INDICATED ON THESE PLANS. COMPLETE SYSTEM, FIXTURES AND DEVICES SHALL
- BE GIVEN AN IN—SERVICE TEST AFTER COMPLETION OF INSTALLATION.
- 7. ALL EXCAVATION AND BACKFILL AS REQUIRED FOR THIS PHASE OF CONSTRUCTION, SHALL BE PART OF THIS CONTRACT.
- 8. BUILDING DRAINAGE SYSTEM IS BASED ON 1/8"/ FT. MIN. FALL. ALL DEVIATIONS SHALL BE APPROVED BY THE ARCHITECT / ENGINEER. 2 1/2" AND SMALLER PIPE SHALL PITCH AT 1/4" PER FOOT.
- 9. DO NOT SCALE FOR THE EXACT FIXTURES, PIPING, EQUIPMENT ETC.
- 10. ALL WORK SHALL BE COORDINATED WITH OTHER TRADES TO AVOID INTERFERENCE WITH PROGRESS OF
- 11. WATER PIPING SHALL BE TYPE "L" COPPER WITH WROUGHT SOLDER FITTINGS. UNDERGROUND PIPING MAY BE TYPE "M" WITH PROPER SLEEVING AND NO JOINTS BELOW SLAB.
- 12. FURNISH AND INSTALL APPROVED SHOCK ABSORBERS AND SHUTOFF VALVES WITH ACCESS PANELS AT EACH
- 13. PLUMBING SUB-CONTRACTOR SHALL PROVIDE ACCURATE RED-LINE (OR BETTER) AS-BUILT DRAWINGS TO ARCHITECT / OWNER PRIOR TO FINAL SIGNING-OFF OF PROJECT.
- 14. THESE PLANS ARE BASED ON AVAILABLE INFORMATION. VERIFY EXACT LOCATION OF EXISTING WATER AND SEWER
- 15. COORDINATE TIE-IN OF GAS PIPING WITH GAS SUPPLIER.

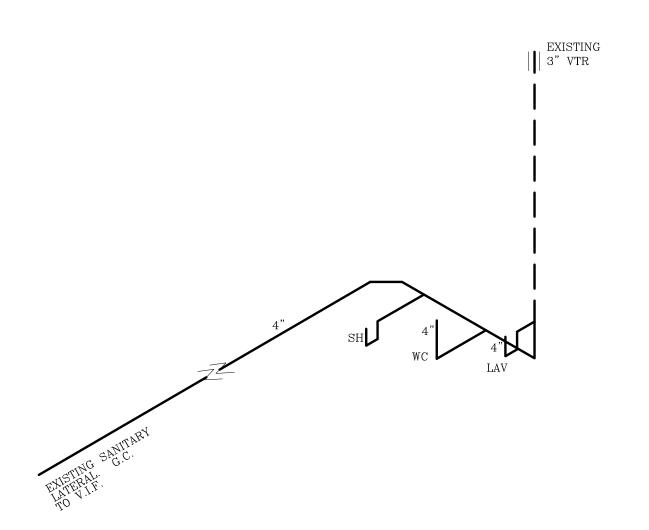

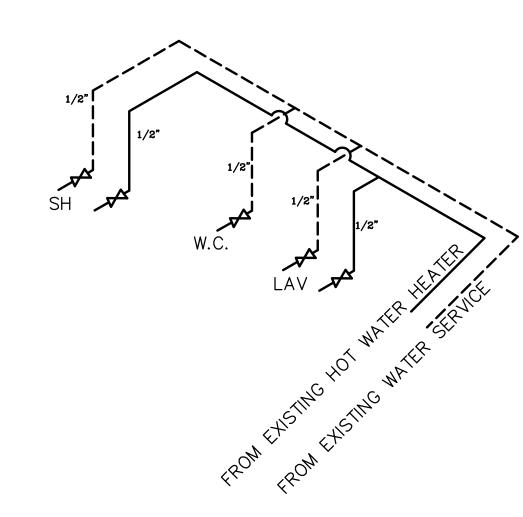

SANITARY RISER DIAGRAM

SCALE : NTS

#### POTABLE WATER RISER

PLUMBING NOTE: WATER HAMMER ARRESTORS
ARE TO BE INSTALLED
ACCORDING TO MANUF.
INSTRUCTIONS AND WH-PAI-201

LEGEND:

 $\otimes$ 

SANITARY LINE

PLUMBING FIXTURE

COLD WATER LINE

HOT WATER LINE

GAS HOT WATER HEATER

HOSE BIBB

CLEAN OUT

PLUMBING PLAN

SCALE : 1/4" = 1'-0"

DRAIN

**VENT** 

COLD WATER

HOT WATER

NOTE: PROVIDE APPROPRIATELY SIZED SHUT-OFF
VALVES AT ALL FIXTURES AND EQUIPMENT

MARK	DESCRIPTION	MANUFACTURER	MODEL #	DESCRIPTION
P1	LAVATORY	-	-	FINAL SELECTION BY OWNER
P2	TOILET	-	-	FINAL SELECTION BY OWNER
P3	BUILT IN SHOWER	-	-	FINAL SELECTION BY OWNER
P4	KITCHEN SINK	-	-	PLEASE NOTE THAT BOTH SANITARY AND POTABLE WATER LINE EXISTING FINAL SELECTION OF BY OWNER

★ BASIS OF DESIGN — COORDINATE ALL FINAL SELECTIONS W/ OWNER & G.C.

		cooktop		
EXISTING SANITARY LATERAL. G.C. TO V.I.F.	PATIO	EXISTING KITCHEN	Q8M	
		FRE. REF.		
	SUN RM			
		EXISTING LIVING RN	M	

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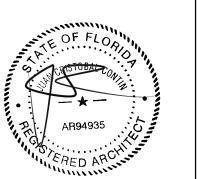
REGISTERED ARCHITECT:

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826 S. FEDERAL HIGHWAY

LAKE WORTH, FL 33460



CLIENT:

LEOHR LESLIE S R 2002 TRUST

PROJECT TITLE:

1317 GRINNELL STREET

PROJECT ADDRESS:

1317 GRINNELL STREET KEY WEST, FLORIDA

OATE: \_\_\_\_\_\_16 JULY, 2018

ISSUED: \_\_\_

DRAWN BY:

CHECKED BY:

REVISIONS:

SCALE/NORTH POINT:

AS SHOWN


DRAWING TITLE

PLUMBING PLAN

DRAWING STATUS:

DRAWING NUMBER:

P-01

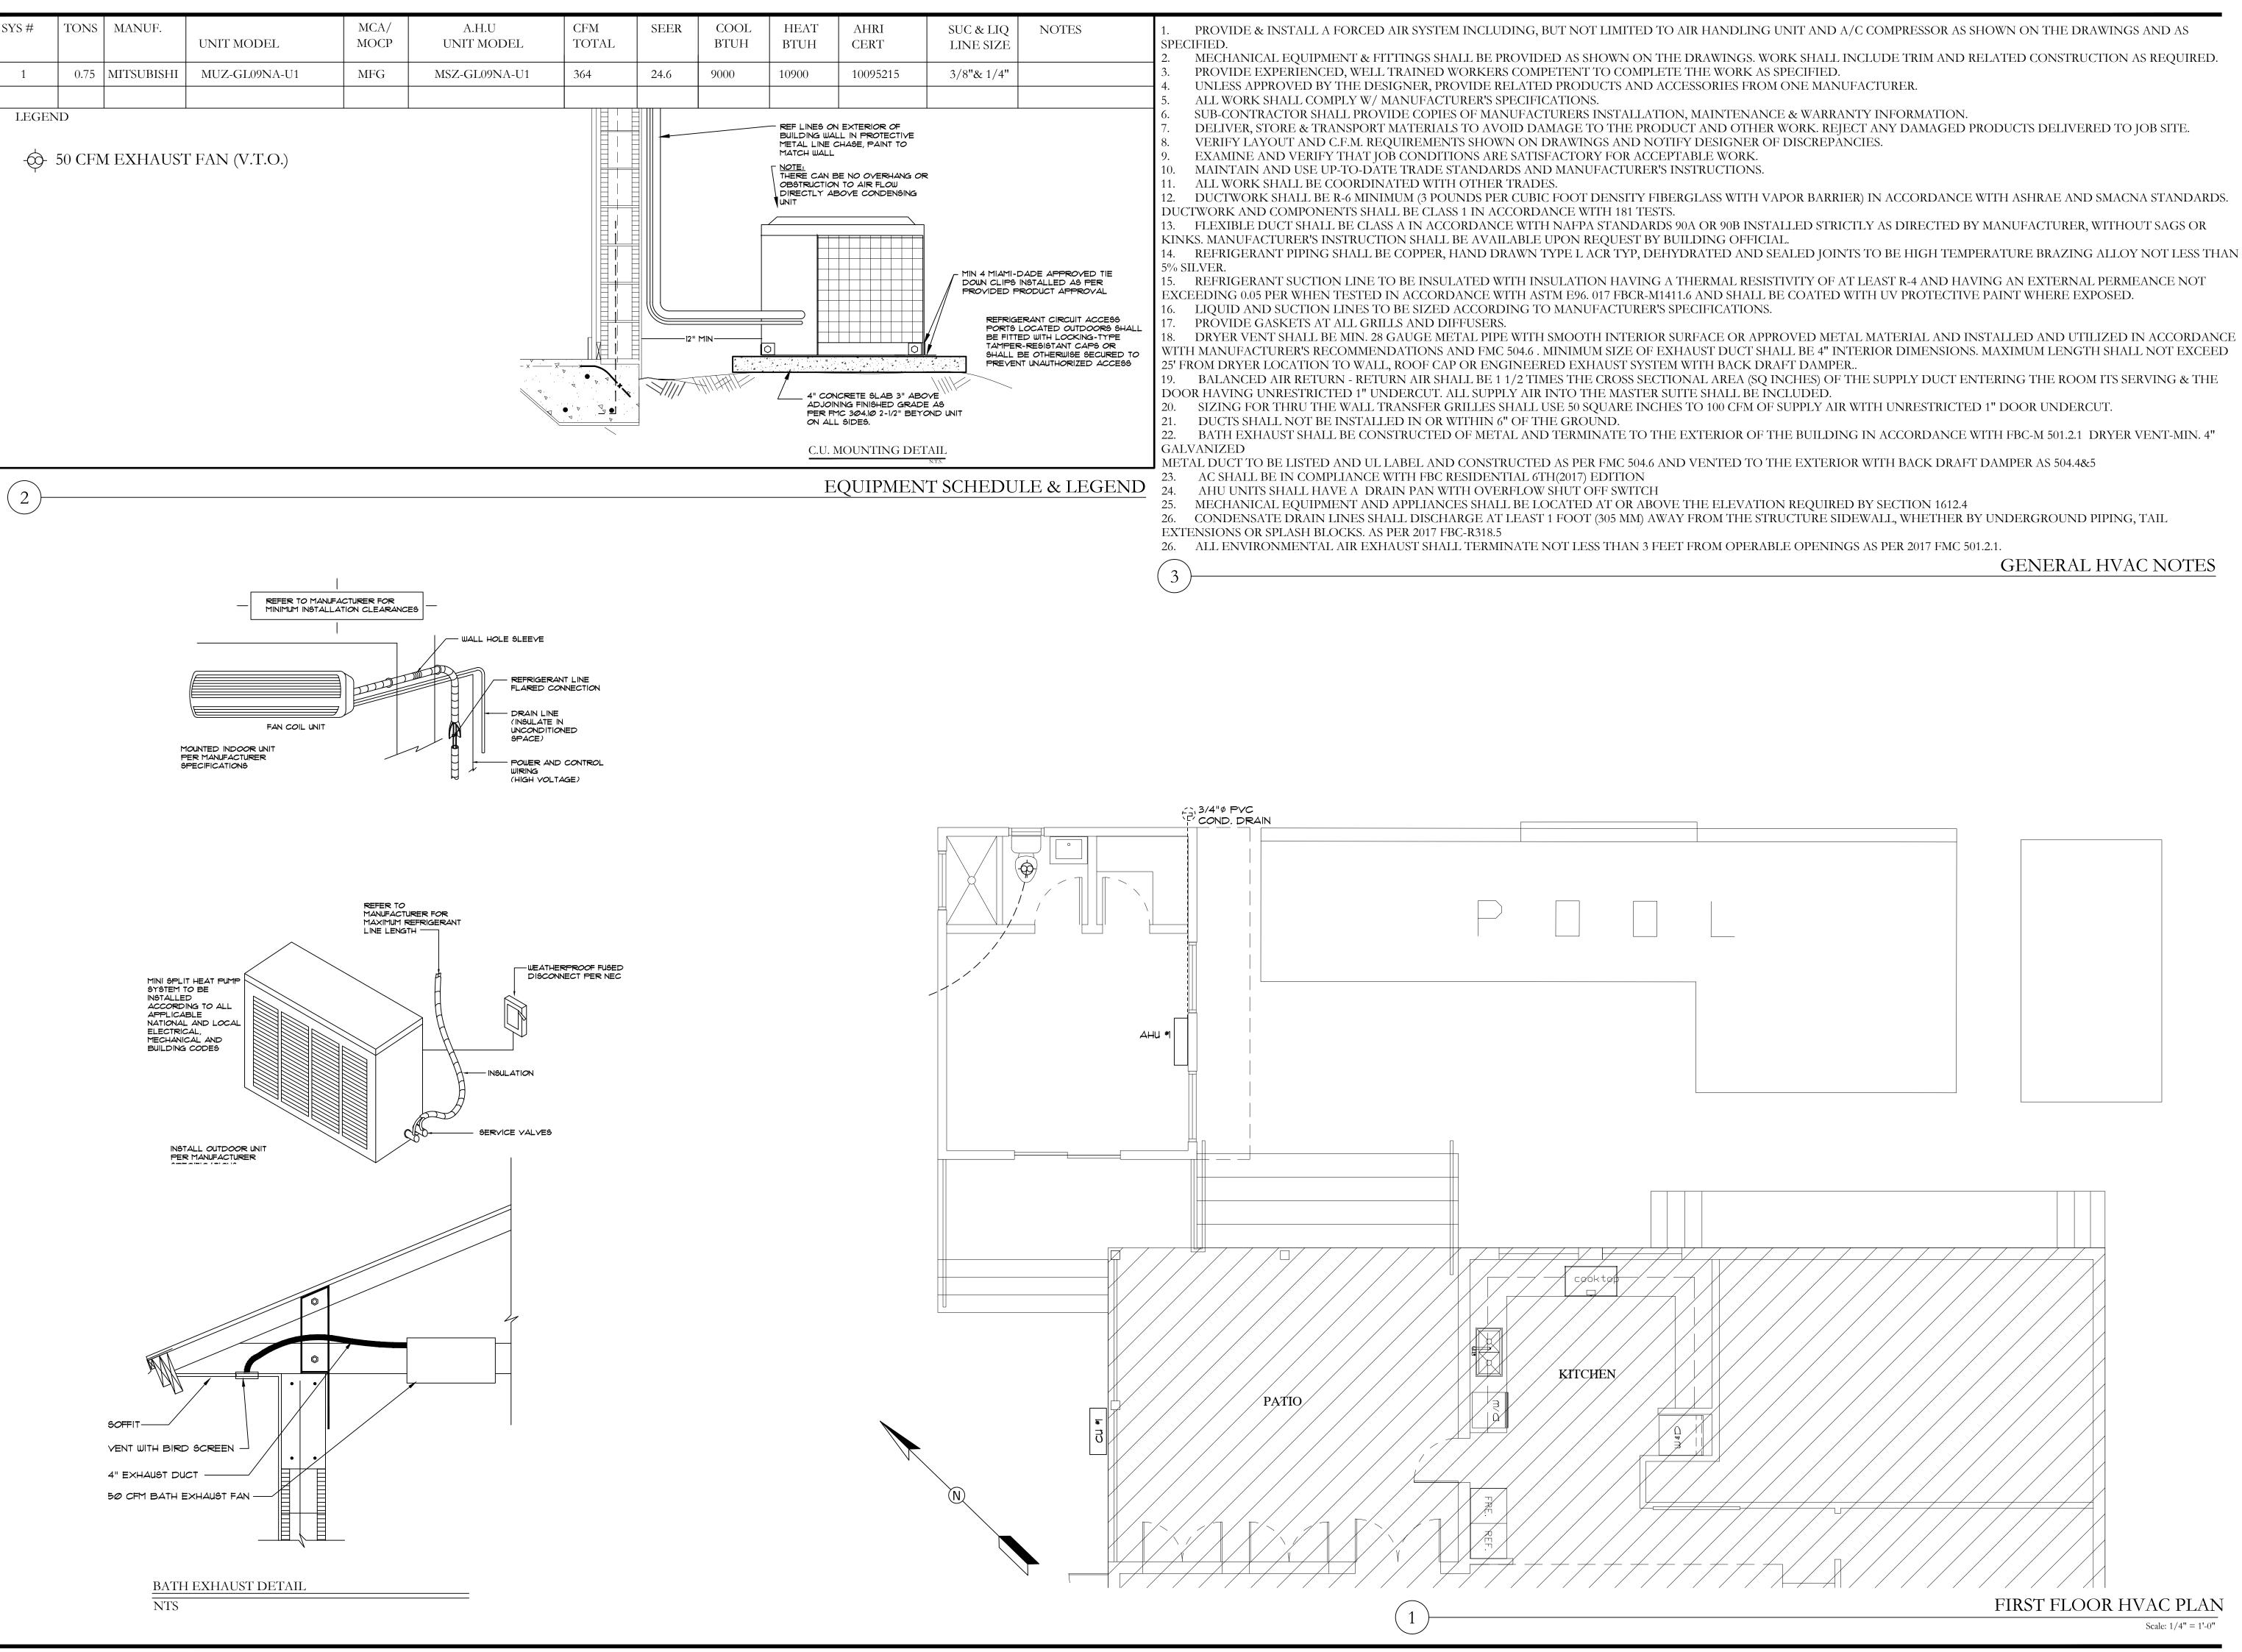

K.O. ENERGY DESIGN, LLC

'efficiency by design'
KAREN OLIVER
1470 NORTH CONGRESS AVE

WEST PALM BEACH, FL, 33409

561.327.7272 FAX 561.333.0775 FLORIDA STATE LICENSE #CACA15692

www.KoEnergyDesign.com

DRAWINGS FOR:

THE 1375 GRINNELL RESIDENCE

1375 GRINNELL STREET KEY WEST, FLORIDA

#### DRAWING INFO

DATE	6/25/2018
SCALE	VARIES
JOB#	XXXX
DRAWN BY	D. MOYER

#### REVISIONS

OWNERSHIP AND USE OF THESE DOCUMENTS & SPECIFICATIONS AS INSTRUMENTS OF SERVICE ARE AND SHALL REMAIN THE PROPERTY OF THE K.O. ENERGY DESIGN, LLC WHETHER THE PROJECT THEY ARE MADE FOR IS EXECUTED OR NOT. THEY SHALL NOT BE USED BY THE OWNER OR OTHERS ON OTHER PROJECTS OR FOR ADDITIONS TO THIS PROJECT BY OTHERS, EXCEPT BY AGREEMENT IN WRITING FROM K.O. ENERGY DESIGN,

NOTE:
THE HEAT LOAD CALCULATIONS
FOR THIS PROJECT WERE
CALCULATED
USING THE FOLLOWING GLAZING

LLC.

FENESTRATION DATA: U:1.01 SHGC:0.48




KAREN ÖLÍVER FLORIDA STATE LICENSE #CACA15692

SHEET

M.1

	ELECTRIC SYMBO	DL LEGEND	
SYMBOL	DESCRIPTION	SYMBOL	DESCRIPTION
	FLUORESCENT LIGHT FIXTURE	•	EXHAUST FAN (DUCTED) WITH LIGHT
	SWITCHED WALL OUTLET		SURFACE MOUNTED LIGHT FIXTURE w/ VAPOR BARRIER
$\bigoplus_{GFI}$	GROUND FAULT INTERRUPTER WALL OUTLET	<del>()</del>	EYEBALL
₩P GFI	WATER PROOF WALL OUTLET	Ò	RECESSED LIGHT FIXTURE (HI HAT)
$\Rightarrow$	WALL OUTLET		SURFACE MOUNTED INCANDESCENT FIXTURE
$\rightarrow$	20A, 120V SINGLE RECEPTACLE GROUNDING TYPE U.O.N. MOUNTED 18" AFF	•	LED TASK LIGHT
	220 WALL OUTLET	<b>\$</b>	SURFACE MOUNTED INCANDESCENT FIXTURE
	240 WALL OUTLET & SPECIAL PURPOSE RECEPT	l -Q-1	WALL MOUNTED INCANDESCENT FIXTURE
<del></del>	WALL OUTLET BOX & SINGLE POLE SWITCH - 20 WALL OUTLET BOX & 3-WAY SWITCH - 20 AMP		EXTERIOR LED UP LIGHTS
<del>^</del> <del>}</del> <del>\</del>	WALL OUTLET BOX & 4-WAY SWITCH - 20 AMP	8	SMOKE DETECTOR
Ž	CEILING MOUNTED PREWIRED GARAGE DOOR OUT	LET < PH	TELEPHONE JACK
1/10	SWITCH WITH CONVENIENCE OUTLET		WALL HUNG TELEPHONE JACK
<del>\\</del> \_	REOSTAT (DIMMER SWITCH)	7	T.V. OUTLET - COORDINATE W/ LOCAL CABI
	DISCONNECT	—□ TV	COMPANY
	ELECTRIC METER	-0	PUSH BUTTON
	ELECTRIC PANEL	0000	CHIMES
	CEILING FAN JUNCTION BOX		GARAGE DOOR OPENER

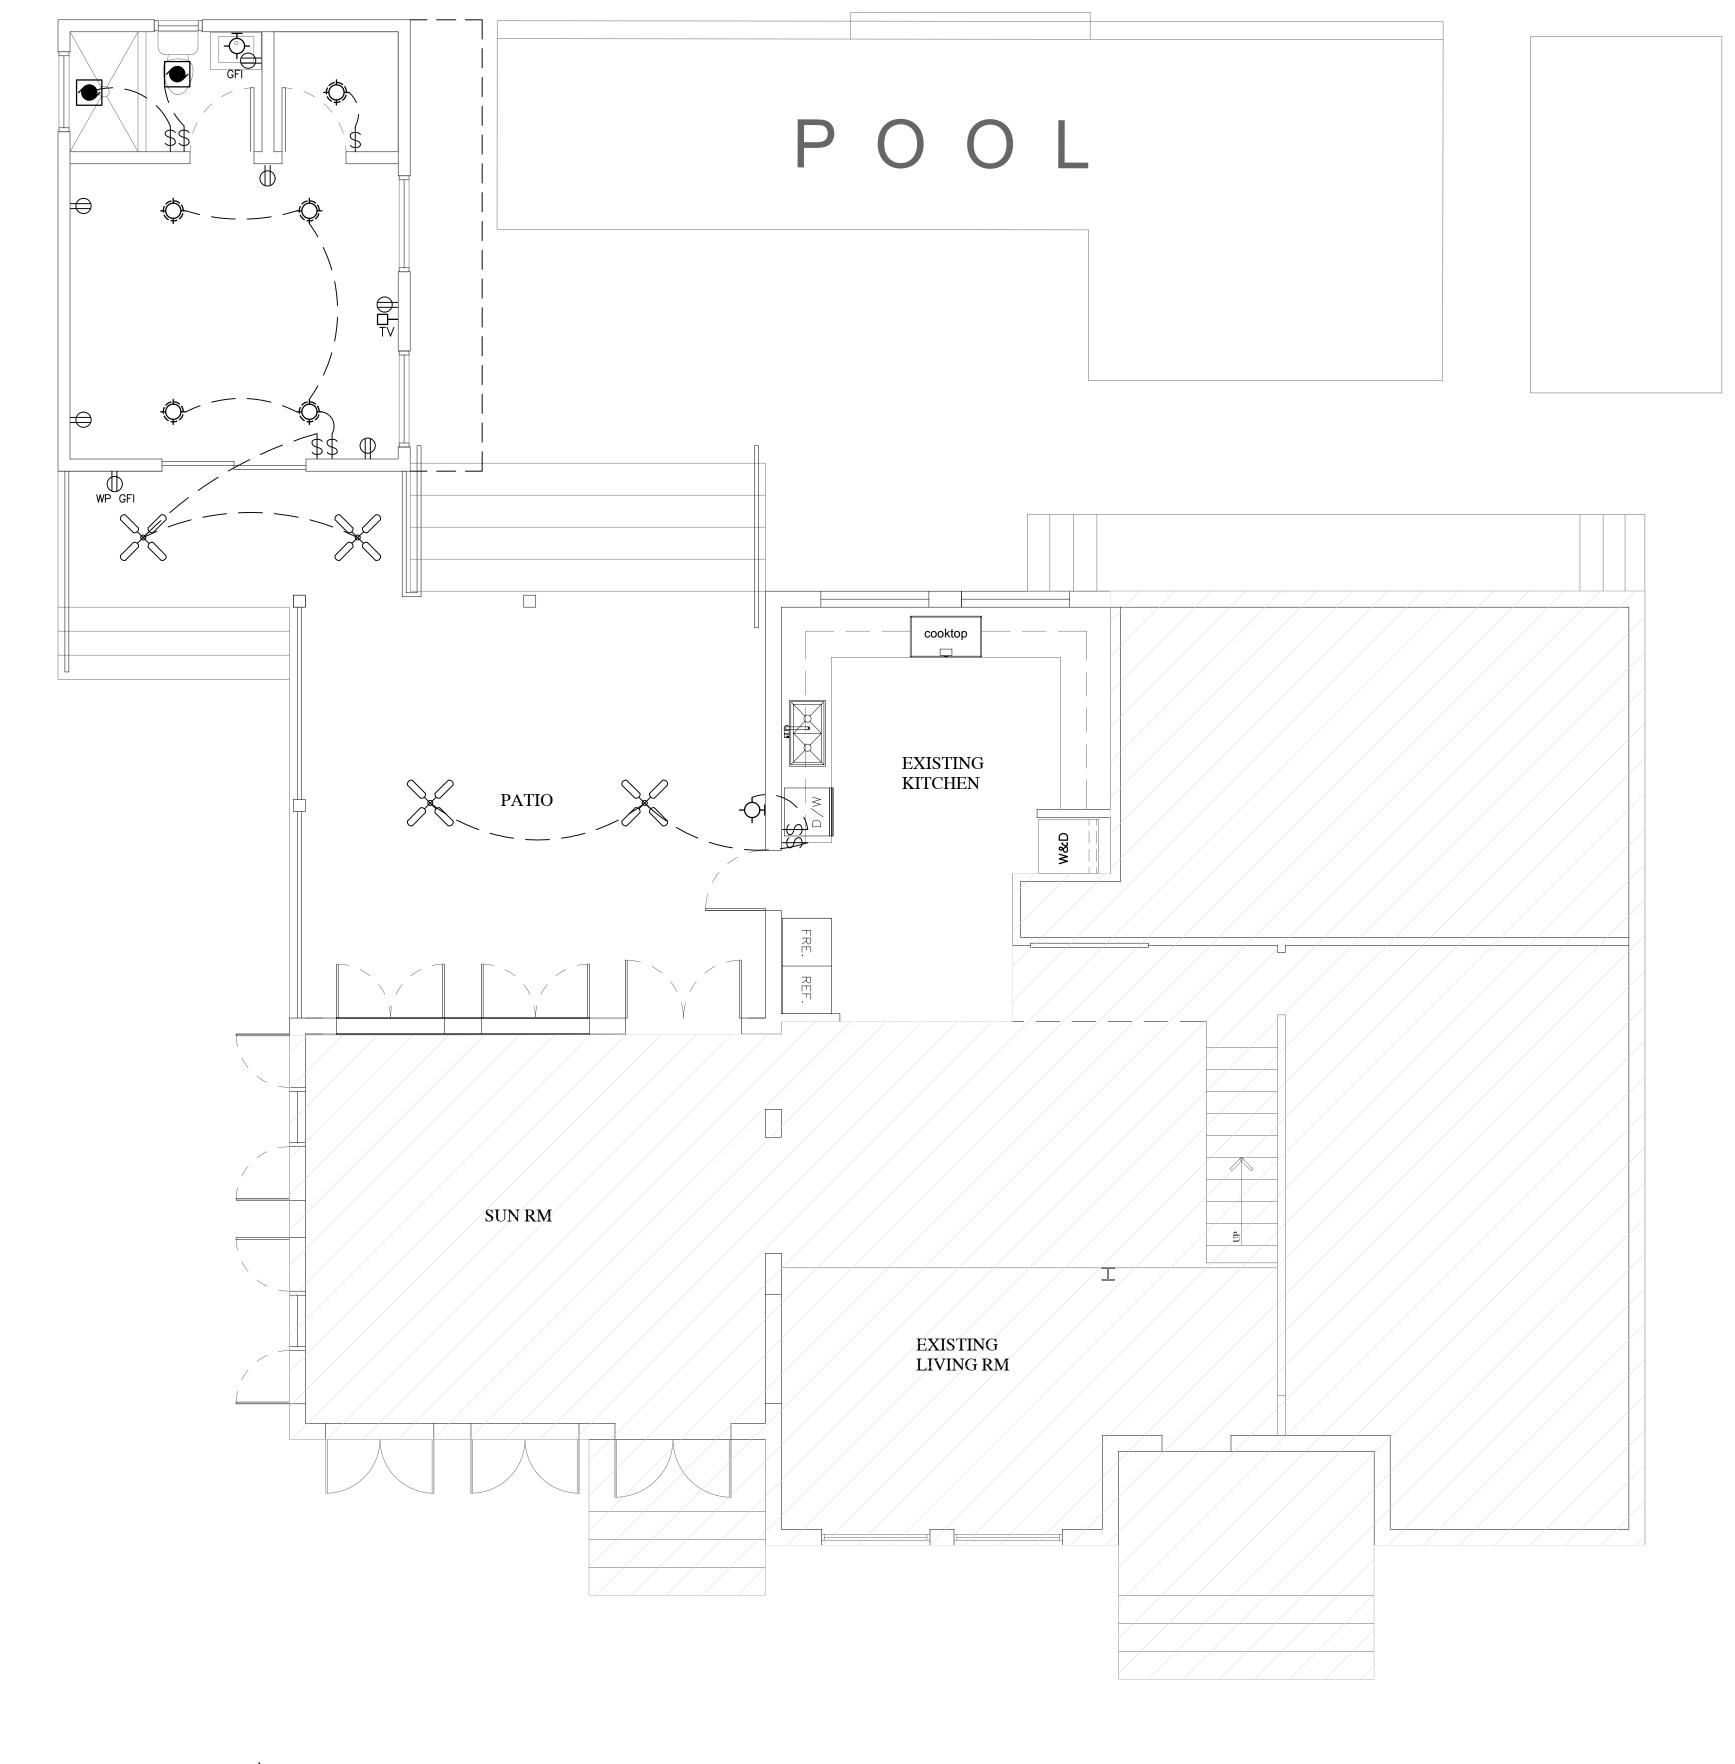

N ELECTRICAL PLAN

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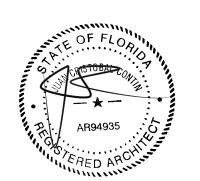


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LAKE WORTH, FL 33460



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DATE: <u>16 JULY, 2018</u>

DRAWN BY:

REVISIONS:

SCALE/NORTH POINT:

AS SHOWN

DRAWING TITLE

ELECTRICAL PLAN

DRAWING STATUS:

DRAWING NUMBER:

SCALE : 1/4" = 1'-0"

E-01

#### **GENERAL RESIDENTIAL ELECTRICAL NOTES:**

- COOLING AND HEATING LOADS ARE NOT CONCURRENT.
- 2. PROVIDE ALL FINAL CONNECTIONS TO ALL EQUIPMENT AND APPLIANCES.
- 3. PROVIDE ALL A/C CONTROL IN SEPARATE 1/2"C AS REQUIRED BY A/C
- DRAWINGS OR MANUFACTURER DIAGRAMS. 4. ALL LAVATORIES AND KITCHEN RECEPTACLES TO BE GFI TYPE.
- 5. TERRACE RECEPTACLES TO BE GFI TYPE.
- 6. COORDINATE LOCATION OF ALL DISCONNECT SWITCHES WITH OTHER TRADES TO ALLOW N.E.C. REQUIREMENTS CLEARANCES.
- 7. CIRCUIT WIRING REQUIRED TO BE AS FOLLOWS:120V-2 WIRE (L-N); 120/240V - 3 WIRE (LL-N); 240V - 2 WIRE (L-L) WHEN EQUIPMENT GROUND IS REQUIRED INCREASE CIRCUIT SIZE AS REQUIRED.
- 8. ALL WIRING TO BE COPPER. THHN/THWN TYPE RUN IN METALLIC CONDUIT OR ROMEX CABLE IF AHJ APPROVED.
- 9. ALL COUNTER RECEPTACLES AND SWITCHES TO BE MOUNTED +6" ABOVE COUNTER ( TO BOTTOM OF PLATE). UNLESS OTHERWISE NOTED DIFFERENT ON PLANS.
- 10. REFRIGERATOR RECEPTACLE TO BE MOUNTED +60"
- 11. ALL LAVATORY RECEPTACLES TO BE MOUNTED +42" A.F.F. UNLESS OTHERWISE NOTED DIFFERENT ON PLANS.
- 12. COORDINATE LOCATION OF AIR CONDITIONER (INDOOR UNIT) DISCONNECT SWITCH WITH A/C CONTRACTOR TO KEEP N.E.C. REQUIRED CLEARANCE.
- 13. KITCHEN TELEPHONE OUTLET TO BE MOUNTED +60" A.F.F.
- 14. ALL DUPLEX RECEPTACLES IN EXTERIOR AREAS TO BE OF WP, GFI TYPE.
- 15. PROVIDE EMPTY CONDUITS AS REQUIRED FOR TELEPHONE AND TV. SYSTEMS.
- 16. OUTDOOR UNDERGROUND CONDUITS SHALL BE SCHEDULE 40 PVC UNDER PAVED AREAS IT SHALL BE ENCASED IN CONCRETE. MINIMUM COVER SHALL BE 24 INCHES. A GROUNDING CONDUCTOR PROPERLY SIZED MUST BE INSTALLED AS PER N.E.C. 250 IF PVC IS USED.
- 17. OUTLET BOXES SHALL BE PRESSED STEEL IN DRY LOCATIONS CAST ALLOY W/THREADED HUBS IN WET OR DAMP LOCATIONS AND SPECIAL ENCLOSURES FOR OTHER CLASSIFIED AREAS.
- 18. MOTOR STARTERS SHALL BE MANUAL OR MAGNETIC, WITH OVERLOAD RELAYS IN EACH HOT LEG.
- 19. ELECTRICAL SYSTEM SHALL BE COMPLETELY & EFFECTIVELY GROUNDED AS REQUIRED BY THE LATEST EDITION OF THE N.E.C. PROVIDE PROPER SIZE AND TYPE OF PROTECTION DEVICES TO MATCH EQUIPMENT SERVED.
- 20. MINIMUM WIRE SIZE SHALL BE #12 THHN/THWN.
- 21. ALL CONDUCTORS SHALL BE COPPER.
- 22. CONDUIT IN FINISHED AREAS SHALL BE CONCEALED.
- 23. CONDUIT IN UNFINISHED AREAS SHALL BE EXPOSED.
- 24. FUSES SHALL BE DUAL ELEMENT, TIME DELAY TYPE.
- 25. INSTALL NYLON PULL STRINGS IN ALL EMPTY CONDUITS FOR FUTURE USE.
- 26. ALL MATERIALS SHALL BE U.L. APPROVED.

**EXTERIOR WALL** 

 $\Box$ 

METER-MAIN COMBINATION SERVICE RATED DEVICE

VERIFY LOCATION IN FIELD

22000 A/C MINIMUM

200A MAIN 240/120 V,1PH,3W

- 27. WORKMANSHIP SHALL BE TO BEST RESIDENTIAL PRACTICE.
- 28. ALL LIGHT FIXTURES TO BE SELECTED BY OWNER/ARCHITECT AND INSTALLED BY CONTRACTOR
- 29. RECESSED LIGHT FIXTURES OVER BATHTUB OR SHOWER SHALL BE COMPLETELY ENCLOSED AND VAPOR PROOF SUITABLE FOR WET LOCATIONS.
- 30. ALL LUMINARIES SHALL BE PROPERLY SUPPORTED IN ACCORDANCE WITH THE CEILING SYSTEM MANUFACTURER RECOMMENDATIONS AND LOCAL CODES AND REQUIREMENTS.

- 31. RISER ARE DIAGRAMMATIC ONLY. THEY DO NOT SHOW EVERY BEND, REQUIRED FOR THE INSTALLATION.
- 32. THIS DRAWING IS A GUIDE FOR THE INSTALLATION OF ELECTRICAL SERVICE. THE ELECTRICAL CONTRACTOR IS RESPONSIBLE TO PROVIDE A FUNCTIONING SYSTEM.
- 33. A/C EQUIPMENT WIRING, BREAKER AND FUSE SIZES ARE BASED ON A/C EQUIPMENT SPECIFIED ON CONTRACT DRAWINGS. CONTRACTOR IS RESPONSIBLE FOR PROVIDING ALL WIRING, BREAKER AND FUSE SIZES IN ACCORDANCE WITH A/C EQUIPMENT NAMEPLATE REQUIREMENTS IF DIFFERENT FROM THAT SPECIFIED ON DRAWING, AS WELL AS ANY FEEDER CHANGES BEING AFFECTED BY THIS CHANGE. CONTRACTOR SHALL MAKE ABOVE MENTIONED CHANGES AT NO EXTRA COST.
- CONTRACTOR SHALL COORDINATE ALL HIS WORK WITH OTHER TRADES IN ORDER TO FURNISH AND INSTALL ALL CONTROL WIRING AND RACEWAY, ALL POWER CONTROL CIRCUIT WIRING AND RACEWAYS AS SHOWN ON THE AIR CONDITIONING DRAWINGS OR SPECIFICATIONS. IF AIR CONDITIONING DRAWINGS REFER TO MANUFACTURER'S WIRING DIAGRAMS, THE CONTRACTOR SHALL VERIFY WITH SAID MANUFACTURER ALL REQUIREMENTS AND INCLUDE ALL RELATED WORK IN HIS CONTRACT.
- 35. THE E.C. IS TO ARRANGE FOR TELEPHONE SERVICE AND TELEPHONE WIRING COORDINATE WITH TELEPHONE COMPANY. UNLESS OTHERWISE SPECIFIED
- SMOKE ALARM SHALL BE DIRECTED WIRED 120V. UL APPROVED WITH SUITABLE ALARM INSTALLED IN ACCORDANCE WITH MANUFACTURER RECOMMENDATIONS AND LISTING.ALL SMOKE ALARMS HARDWIRED WITH BATTERY BACKUP WITHIN RESIDENCE TO MEET NFPA 72 CODE REQUIREMENTS, ALARMS IN THE DWELLING.
- 37. E.C. TO COORDINATE TO MAKE CERTAIN ALL A.C. POWER. CONTROL WIRING AND CONDUITS ARE IN THE BID.
- 38. E.C. TO COORDINATE ALL SERVICE REQUIREMENTS WITH THE POWER COMPANY BIDDING TO BE CERTAIN THAT ALL WORK NECESSARY TO MEET POWER COMPANY SPECIFICATIONS IS IN BID, SAME WITH TELEPHONE AND CABLE TV COMPANIES.
- 39. E.C. SHALL BE RESPONSIBLE FOR ALL APPLICABLE FEES, TAXES AND PERMITS AS REQUIRED TO COMPLETE THE JOB.
- 40. THE E.C. SHALL PROVIDE TYPE WRITTEN PANEL DIRECTORY INDICATING PANEL CIRCUITS
- 41. MAXIMUM NUMBER OF CONDUCTORS IN A BOX SHALL BE AS PER N.E.C., art. 370.16
- 42. BALANCE ALL LOADS AT THE END OF PROJECT.
- 43. E.C. SHALL DEMONSTRATE TO THE OWNER THE SATISFACTORY OPERATIONS OF THE SYSTEM WITH A TEST COMPLETION.
- 44. PROVIDE ONE-YEAR FULL GUARANTEE AGAINST DEFECTIVE WORKMANSHIP, MATERIAL AND EQUIPMENT FROM DATE OF FINAL ACCEPTANCE BY OWNER.
- 45. ALL PANEL BOARDS SHALL HAVE AIC RATING TO WITHSTAND THE FAULT CURRENT SUPPLIED TO THE RESIDENCE, COMPLY WITH N.E.C. art. 110.9 & 110.10.
- 46. ALL PANEL BOARDS SHALL HAVE AIC RATED TO WITHSTAND THE FAULT CURRENT SUPPLIED
- TO THE RESIDENCE COMPLY WITH N.E.C ART 110-9 &110-10, 47. ALL EXTERIOR RECEPTACLES TO BE GFI AND TO HAVE WP "IN USE "

#### RESIDENTIAL ELECTRICAL CODE NOTES:

- 1. LIGHTING FIXTURES AND COLORS AS SELECTED BY ARCHITECT/ OWNER 2. E.C. TO PROVIDE COUNTER SPACE RECEPTACLES GFI AS PER 210.52C.1 @ 48" O.C (TYP).
- 3. ALL APPLIANCES DISCONNECTS TO BE ACCESSIBLE AS PER NEC 422 (TYP) COORDINATE WITH OTHER TRADES TO PROVIDE CLEARANCES AS REQUIRED.
- 4. VERIFY ALL ELECTRICAL OUTLETS, PHONE AND T.V OUTLETS LOCATION W/ ARCHITECT PRIOR INSULATION. 5. LIGHTING FIXTURES IN CLOSETS TO COMPLY W/ NEC 410.8 (TYP). 6. E.C. TO PROVIDE ALL RECEPTACLE SPACING AS PER NEC 210.52 (TYP).
- 7. PROVIDE AFCI BREAKERS FOR BEDROOMS AS REQUIRED BY NEC 210.12 (TYP). 8. BRACE J. BOX FOR CEILING FAN NEC 422. 18 (TYP) 9. COORDINATE LOCATION OF AHU DISCONNECT SWITCH WITH A/C CONTRACTOR TO KEEP
- NEC REQUIRED CLEARANCE, PROVIDE ALL A/C CONTROLS IN SEPARATE CONDUITS AS REQUIRED. 10. COORDINATE EXACT LOCATION IN FIELD AND WITH MECHANICAL DRAWINGS.

SEE A/C SCHEDULE FOR ELECTRICAL INFORMATION. 11. ALL EXTERIOR OUTLETS TO HAVE WP "IN USE" COVERS

FINISHED FLOOR

**EXISTING** 

PN L

ITEM SQ. FT GENERAL LIGHTING (3W/S.F.) SMALL APPLIANCES RANGE REFRIGERATOR 1 GARAGE DOOR WASHER NEW LIGHTING CIRCUITS HOT WATER GARAGE OUTLES HYDROMASSAGE BATHROOM OUTLETS DISPOSAL DISHWASHER DRYER	WATTS 3,019 9,057 1,500 5,000 1,000 1,500 1,500	0 1,500	WATTS 390 1,170 800
GENERAL LIGHTING (3W/S.F.)  SMALL APPLIANCES  RANGE  REFRIGERATOR 1  GARAGE DOOR  WASHER  NEW LIGHTING CIRCUITS  HOT WATER  GARAGE OUTLES  HYDROMASSAGE  BATHROOM OUTLETS  DISPOSAL  DISHWASHER	9,057 1,500 5,000 1,000 1,500	_	1,170
SMALL APPLIANCES RANGE REFRIGERATOR 1 GARAGE DOOR WASHER NEW LIGHTING CIRCUITS HOT WATER GARAGE OUTLES HYDROMASSAGE BATHROOM OUTLETS DISPOSAL DISHWASHER	1,500 5,000 1,000 1,500	_	-
RANGE REFRIGERATOR 1 GARAGE DOOR WASHER NEW LIGHTING CIRCUITS HOT WATER GARAGE OUTLES HYDROMASSAGE BATHROOM OUTLETS DISPOSAL DISHWASHER	5,000 1,000 1,500 1,500		
REFRIGERATOR 1 GARAGE DOOR WASHER NEW LIGHTING CIRCUITS HOT WATER GARAGE OUTLES HYDROMASSAGE BATHROOM OUTLETS DISPOSAL DISHWASHER	1,000		
GARAGE DOOR WASHER NEW LIGHTING CIRCUITS HOT WATER GARAGE OUTLES HYDROMASSAGE BATHROOM OUTLETS DISPOSAL DISHWASHER	1,500		
WASHER NEW LIGHTING CIRCUITS HOT WATER GARAGE OUTLES HYDROMASSAGE BATHROOM OUTLETS DISPOSAL DISHWASHER	1,500		
NEW LIGHTING CIRCUITS HOT WATER GARAGE OUTLES HYDROMASSAGE BATHROOM OUTLETS DISPOSAL DISHWASHER	1,500		
HOT WATER GARAGE OUTLES HYDROMASSAGE BATHROOM OUTLETS DISPOSAL DISHWASHER			
GARAGE OUTLES HYDROMASSAGE BATHROOM OUTLETS DISPOSAL DISHWASHER			
HYDROMASSAGE BATHROOM OUTLETS DISPOSAL DISHWASHER			
BATHROOM OUTLETS DISPOSAL DISHWASHER	1,500		
DISPOSAL DISHWASHER	1,500		000
DISHWASHER			800
	750		
UKYEK	1,200		
	5,000		
KITCHEN OUTLETS	3,000		
HOOD	800		
SMOKE DETECTOR	1,000		
BEDROOM OUTLETS			
COFFEE MAKER			
WINE COOLER			
MICROWAVE	1,000		
OVEN	6,000		
POOL PUMP		3,000	
POOL LTS		800	
PANEL C	2,770		
LTS. AND RECEPTS.		960	
CONNECTED LOAD: (LESS A/C)	42,577	6,260	2,770
FIRST 10KW @ 100%	10,000	10,000	10,000
BAL. @40%	13,031	-1,496	-2,892
A/C OR HTG. @ 100%	10,000	0	5,000
DEMAND LOAD:	33,031	8,504	12,108
AMPS @ 240/120V. 1PH	138	35	50
BREAKER SIZE	200	100	50
NEUTRAL LOAD	PANEL A WATTS	PANEL B WATTS	PANEL C WATTS
LIGHTING, WASHER, SMALL	16.5==		1.6-5
APPLIANCES	12,057	1,500	1,970
3KW @ 100%	3,000	3,000	3,000
BALANCE @ 35%	3,170	-525	-361
RANGE @ 70%	3,500	0	0
DRYER @ 70%	3,500	0	0
EXTERIOR LIGHTING & RECEPTACLES	0	0	0
GATE	0	0	0
BATHROOM (GFI)	1,500	0	800
DISPOSAL	750	0	0
	1,200	0	0
DISHWASHER		1	1 <del>-</del>

1,600

18,220

1,600

4,075

17

1,600

5,040

										1	20V. A	PPLIAN	NCES
										Т	OTAL	NEUTF	RAL W.:
										N	EUTR	AL AM	PS (N.W
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				<b>A</b>	Т	3	4	AIR HAND	DLER 1	60	6	3/4	10000
800	1/2	12	20	SMALL APP	PLIANCES G.F.I	5	6	Т	<b>A</b>	Т			
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<u>ELECTRICAL</u> RISER

TO CONCRETE, ENCASED ELECTRODE

TO COLD WATER PIPE

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**EXISTING** 

PN L

SCALE : 1/4" = 1'-0"

#### **GENERAL NOTES:**

These drawings have a local state and federal copyright Juan Contin, Architect. and are property of the They are not to be used on other projects or extension of this project except by written agreements with Juan Contin, Architect. No design changes which alter the intent of the drawings or specifications are to be made without obtaining written permission from Juan Contin, Architect.




| REGISTERED ARCHITECT:

JUAN CRISTOBAL CONTIN

FL LICENSE # AR94935

826 S. FEDERAL HIGHWAY

LAKE WORTH, FL 33460

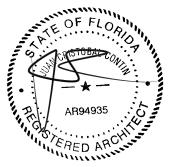

CLIENT:

LEOHR LESLIE S R 2002 TRUST

PROJECT TITLE:

1317 GRINNELL STREET

PROJECT ADDRESS:

1317 GRINNELL STREET KEY WEST, FLORIDA

16 JULY, 2018

ISSUED: DRAWN BY:

CHECKED BY:

REVISIONS:

SCALE/NORTH POINT:

AS SHOWN

DRAWING TITLE

ELECTRICAL PLAN

DRAWING STATUS:

DRAWING NUMBER:



The Historic Architectural Review Commission will hold a public meeting at <a href="Si:30 p.m."><u>Si:30 p.m.</u></a>, <a href="October 23, 2018 at City Hall. 1300 White Street"><u>Street</u></a>, Key West, Florida. The purpose of the hearing will be to consider a request for:

NEW ONE-STORY ACCESSORY STRUCTURE AND CONVERSATION OF REAR PORTION OF HOUSE INTO A COVERED PATIO. DEMOLITION OF NON-HISTORIC ACCESSORY STRUCTURE AND PARTIAL DEMOLITION OF EAST AND NORTH EXTERIOR WALLS OF MAIN HOUSE.

#### **#1317 GRINNELL STREET**

Applicant – Juan Contin, Architects Application #H17-03-0058

If you wish to see the application or have any questions, you may visit the Planning Department during regular office hours at 1300 White Street, call 305-809-3973 or visit our website at <a href="https://www.citvofkevwest-fl.gov">www.citvofkevwest-fl.gov</a>.

#### THIS NOTICE CAN NOT BE REMOVED FROM THE SITE UNTIL HARC FINAL DETERMINATION

ADA ASSISTANCE: It is the policy of the City of Key West to comply with all requirements of the Americans with Disabilities Act (ADA). Please call the TTY number at 800-955-8771 or 800-955-8770 (Voice) or the ADA Coordinator at 305-809-3811 at least five business days in advance for sign language interpreters, assistive listening devices, or materials in accessible format.

# PROPERTY APPRAISER INFORMATION



#### Disclaimer

The Monroe County Property Appraiser's office maintains data on property within the County solely for the purpose of fulfilling its responsibility to secure a just valuation for ad valorem tax purposes of all property within the County. The Monroe County Property Appraiser's office cannot guarantee its accuracy for any other purpose. Likewise, data provided regarding one tax year may not be applicable in prior or subsequent years. By requesting such data, you hereby understand and agree that the data is intended for ad valorem tax purposes only and should not be relied on for any other purpose.

By continuing into this site you assert that you have read and agree to the above statement.

#### Summary

Parcel ID 00039320-000000 Account # 1040061 Property ID 1040061

Millage Group 10KW Location 1317 GRINNELL ST, KEY WEST

Address 1317 GRINNELL ST, KEY WE

 Legal
 KW WEBB REALTY CO SUB PB1-42 PT LOTS 4-5 SQR 7 TR 18 OR302 

 Description
 59/60 OR466-19/20 OR477-263 OR821-335 OR877-1595 OR896-981

OR1143-1831/32R/S OR2284-961/62 OR2327-955/56 OR2373-777

OR2799-2367/68

(Note: Not to be used on legal documents)

Neighborhood 6131

Property Class SINGLE FAMILY RESID (0100)

Subdivision The Webb Realty Co Sec/Twp/Rng 05/68/25

Sec/Twp/Rng 05/68/25 Affordable No

Housing



#### Owner

LEOHR LESLIE S R 2002 TRUST C/O LEOHR DOUGLAS C TRUSTEE 2247 ROLLINGWOOD DR MEDINA OH 44256

#### Valuation

	2017	2016	2015	2014
+ Market Improvement Value	\$1,002,076	\$307,233	\$305,383	\$290,501
+ Market Misc Value	\$57,898	\$61,690	\$54,056	\$50,552
+ Market Land Value	\$620,612	\$1,088,035	\$962,556	\$818,299
= Just Market Value	\$1,680,586	\$1,456,958	\$1,321,995	\$1,159,352
= Total Assessed Value	\$1,680,586	\$720,205	\$715,199	\$709,523
- School Exempt Value	\$O	(\$25,000)	(\$25,000)	(\$25,000)
= School Taxable Value	\$1.680,586	\$695,205	\$690,199	\$684.523

#### Land

Land Use	Number of Units	Unit Type	Frontage	Depth
RES SUPERIOR DRY (01SD)	7.475.00	Square Foot	81.25	92

#### **Buildings**

**Building ID Exterior Walls CUSTOM** 2 STORY ELEV FOUNDATION Year Built 1963 Style **Building Type** S.F.R. - R1/R1 EffectiveYearBuilt 2008 WD CONC PADS Gross Sa Ft Foundation 3121 GABLE/HIP Finished Sq Ft 2017 Roof Type Stories 2 Floor Roof Coverage **METAL** Condition GOOD Flooring Type CONC S/B GRND Heating Type FCD/AIR DUCTED with 0% NONE Perimeter 316 **Functional Obs** 0 Bedrooms

| Section | Sect

 Code
 Description
 Sketch Area
 Finished Area
 Perimeter

 OPX
 EXC OPEN PORCH
 678
 0
 0

Code	Description	Sketch Area	Finished Area	Perimeter
FLA	FLOOR LIV AREA	2,017	2,017	0
OPU	OP PR UNFIN LL	76	0	0
OUU	OP PR UNFIN UL	350	0	0
TOTAL	<del></del>	3,121	2,017	0

#### Yard Items

Description	Year Built	Roll Year	Quantity	Units	Grade
FENCES	2008	2009	1	2088 SF	5
WOOD DECK	2008	2009	1	295 SF	4
RES POOL	2008	2009	1	456 SF	2
DET CABANA	2008	2009	1	150 SF	4


#### Sales

Sale Date	Sale Price	Instrument	Instrument Number	Deed Book	Deed Page	Sale Qualification	Vacant or Improved
6/2/2016	\$1,985,000	Warranty Deed		2799	2367	01 - Qualified	Improved
3/29/2007	\$950,000	Warranty Deed		2284	961	Q - Qualified	Improved
9/1/1990	\$256,000	Warranty Deed		1143	1831	Q - Qualified	Improved
10/1/1983	\$50,000	Warranty Deed		896	981	Q - Qualified	Vacant
11/1/1980	\$32,500	Warranty Deed		821	335	Q - Qualified	Vacant
2/1/1970	\$4,210	Conversion Code		477	263	Q - Qualified	Vacant

#### **Permits**

		Date			
Number <b>♦</b>	Date Issued	Completed	Amount	Permit Type <b>≑</b>	Notes <b>≑</b>
13-0958	3/13/2013		\$4,500	Residential	INSTALL 1 18,000 BTU MITSUBISHI MINI-SPLIT UNIT NO OUTSIDE LINES, CONDENSER UNIT ON SLAB. 10' FROM PROPERTY LINE. UNIT WILL BE OVER CONCRETE SLAB & MUST BE AT LEAST 5' SETBACK FROM PROPERTY LINES. NO EXTERIOR LINES.
13-0691	2/27/2013		\$40,000	Residential	INFILL EXISITNG ROOFED PORCH ADD WINDOW
13-0692	2/27/2013		\$1,000	Residential	ADD SEVEN (7) RECEPTACLES & ONE LIGHT, ONE (1) SWITCH.
8-865	3/27/2008	12/31/2008	\$1,000		SET 120 DFAL TANK ON PAD
08-0225	1/30/2008	12/31/2008	\$2,400	Residential	REPLACE A-FRAME ROOF WITH SHED ROOF
8-225	1/30/2008	12/31/2008	\$2,400		REPLACE A FRAME ROOF WITH SHED ROOF
07-4620	12/10/2007	12/31/2008	\$6,300	Residential	WIRE & HOOKUP THE POOL EQUIPMENT, ONE POOL LIGHT, TWO MOTORS, AND 1 HEATER, INSTALL 100 AMP SUB-PANEL FOR POOL EQUIPMENT
07-5290	12/10/2007	12/31/2008	\$258,000	Residential	REMOVE EXISTING V-CRIMP AND REPLACE WITH SAME 1800 SF, ELECTRICAL INTERIOR RENOVATION, INSTALL TV AND PHONE CABLE, PLUMBING ROUGH & SET PLUMBING FIXTURES & APPLIANCES, INSTALL 2-3 TON CENTRAL AIR 13 OUTLETS, 300 SF ADD TO COVER DECK, ADD ENCLOSED SPACE 70SF, CERMIC TILE 300SF, REPLACE WINDOWS, DOORS, KITCHEN CABINETS, ADD 3 6X6 POSTS ON SOUTH ELEVATION.
07-5112	11/27/2007	12/31/2008	\$4,500	Residential	CONSTRUCT TWO PERGOLAS ONE 168 SF AND ONE 126 SF
07-4884	11/6/2007	11/15/2007	\$1,800	Residential	REPLACE ALL PERIMETER PLUMBING DUE TO BREAKAGE BY LANDSCAPER
7-4800	10/22/2007	12/31/2008	\$10,000		CONSTRUCT POOL DECK ON GRADE
7-4425	9/21/2007	12/31/2008	\$3,800		UPGRADE SVC FROM 150 TO 200 AMP HOOK UP AC UNIT RELO W/D R/R OUTLETS,RECEPTACLES,SWITCHES, TV JACKS
7-4324	9/19/2007	12/31/2008	\$20,000		CONSTRUCT WOOD PRIVACY FENCE-TOTAL OF 348LF 4'H WITH 2'H LOUVRE
7-3315	7/5/2007	10/1/2007	\$200		CAP EXISTING SEWER & WATER TO ALLOW HOME TO BE DEMO'D
01-4071	1/3/2002	9/5/2002	\$1	Residential	ROOFING


#### Sketches (click to enlarge)

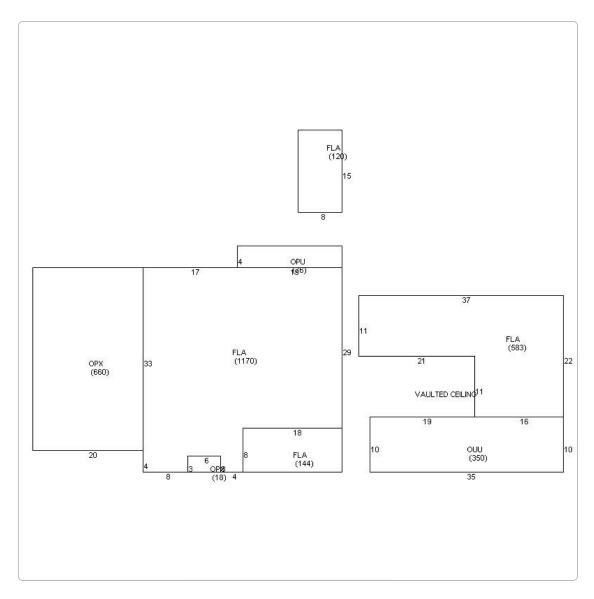

#### **Photos**



#### Мар

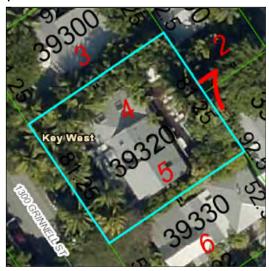

No data available for the following modules: Commercial Buildings, Mobile Home Buildings, Exemptions.

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