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## Historic Architectural Review Commission Staff Report for Item 14

To: Chairman Haven Burkee and Historic Architectural Review  
Commission Members

From: Daniela Salume, MFA  
Historic Architectural Preservationist

Meeting Date: July 22, 2025

Applicant: Peter Janker

Application Number: C2025-0061

Address: 1301 Whitehead Street

### **Description of Work:**

Second Reading - After the fact – Partial demolition of rear section of first floor and second story covered porch.

### **Site Facts:**

The site under review is located on the corner of Whitehead and United Streets. The site consists of a principal historic frame vernacular house built circa 1912 and a historic carport (seen on 1968 aerial photo) that faces United Street. The historic house is a contributing resource to the historic district. The two-story frame structure has a one-story front porch that wraps towards United Street, accentuating its corner setting. The house has dense vegetation, particularly towards Whitehead Street. The Sanborn maps from 1926, 1948 and 1962 all depict the historic existing carport that faces United Street, dedicated to one car.

Currently the house sits on piers and it is on an AE-8 flood zone.



*Photo of property circa 1956. Monroe Country Library.*



*Aerial photo of property in 1941.*



*Aerial photo of property circa 1950.*



*Aerial photo from 1968.*



*Photo of property under review before lifting of home circa 2022.*



*Photo of property under review before lifting of home circa 2022.*



*Photo of property under review before lifting of home circa 2024.*



*Photo of property under review after lifting of home circa 2024.*



*Photo of property under review after lifting of home circa 2024.*



*Photo of property under review showing unpermitted work on the rear of the property circa 2024.*



*Photo of property under review showing unpermitted railings circa 2024.*



*Photo of property under review showing unpermitted work in rear circa 2024.*




*Photo of property under review. Code case from Jan 23, 2025.*



*Photo of property under review. Code case from Jan 23, 2025.*



*Photo of property under review showing existing carport from United Street June 2025.*

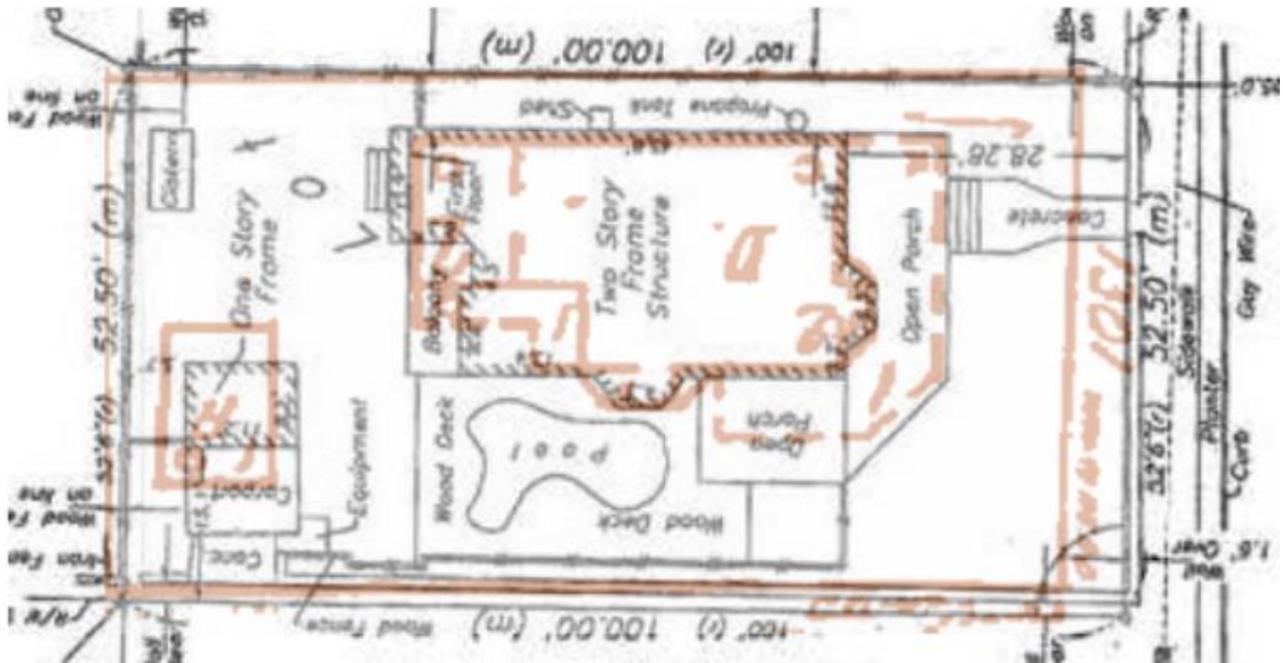


*Current survey and 1962 Sanborn Map.*

### **Ordinance Cited on Review:**


- Section 102-217 (4), demolition for contributing and historic structures of the Land Development Regulations.
- Section 102-218 - Criteria for Demolition of the Land Development Regulations.

### **Staff Analysis:**


The proposed work includes a partial demolition of the rear portion of the first floor and the existing second-story covered porch. This demolition will remove certain altered elements at the rear of the structure in order to accommodate a reconfiguration of both floors and the construction of a new two-story rear porch.

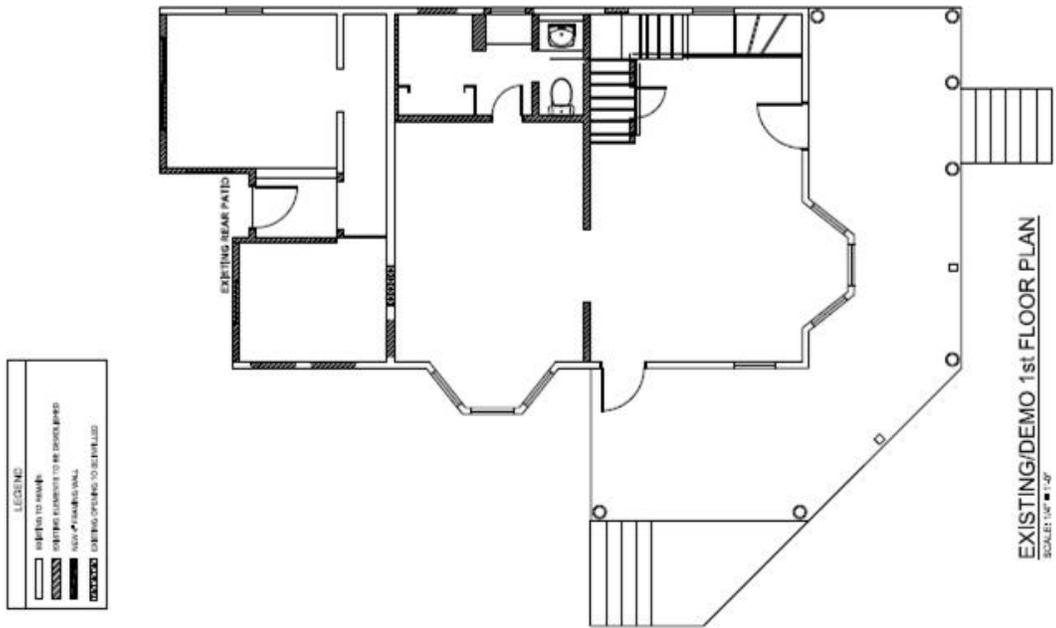


*Existing First Floor Plan of principal structure.*

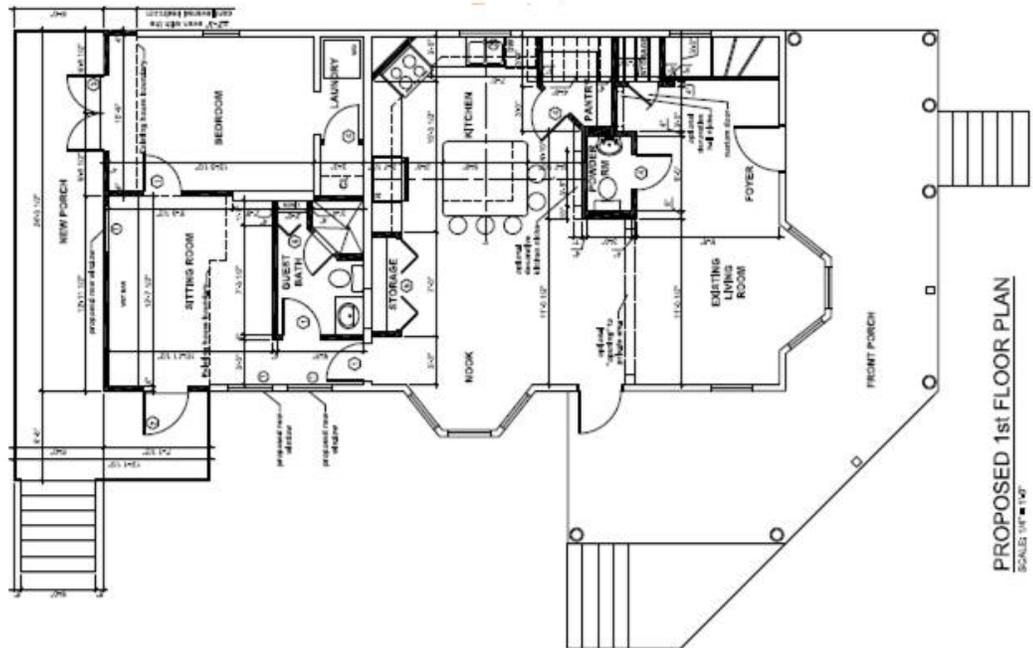

*Proposed First Floor Plan for principal structure.*

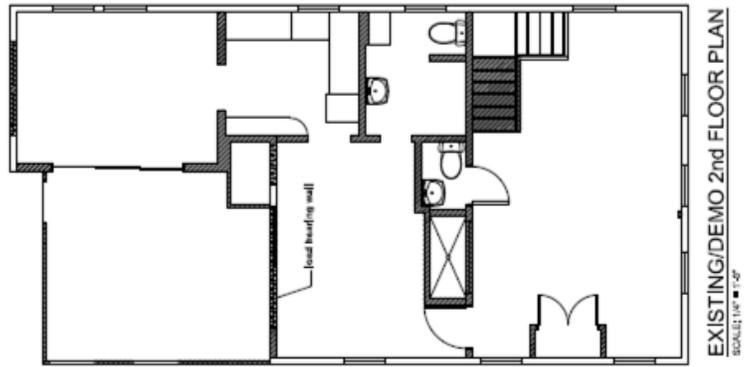

*Existing Second Floor Plan of principal structure.*

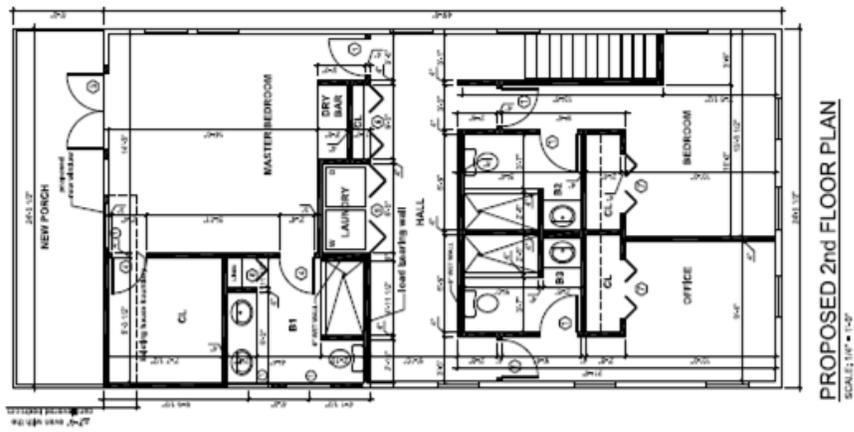

*Proposed Second Floor Plan for principal structure.*

LEGEND	
	EXISTING TO REMAIN
	EXISTING ELEMENTS TO BE DEMOLISHED
	NEW 4" FRAMING WALL
	EXISTING OPENING TO BE INFILLED

*Legend for floor plans, outlining demolition components.*

It is staff's opinion that the request for this demolition shall be based on the demolition criteria of Chapter 102 Section 218 (a) of the LDR's. The criteria for demolition of historic structures state the following:

*(a) The historic architectural review commission shall issue a certificate of appropriateness for an application for demolition:*

- (1) If the subject of the application is a contributing or historic building or structure, then it should not be demolished unless its condition is irrevocably compromised by extreme deterioration, or it does not meet any of the criteria of section 102-125(1) through (9).*

The elements under review are contributing and historic but do exhibit extreme deterioration.

The following is the criteria of section 102-125:

- 1 Embodies no distinctive characteristics of a type, period, or method of construction of aesthetic or historic significance in the city and is not a significant and distinguishable building entity whose components may lack individual distinction.*

Staff opines that elements proposed for demolition do not display distinctive characteristics of a type, period or method of construction.

- 2 Is not specifically associated with events that have made a significant contribution to local, state, or national history.*

It is staff understanding that no significant events have ever happened on the site relevant to local, state, or national history.

- 3 Has no significant character, interest, or value as part of the development, heritage, or cultural characteristics of the city, state, or*

*nation, and is not associated with the life of a person significant in the past.*

It is staff's understanding that the elements under review have no significant character and are not associated with the life of a significant person in the past.

- 4 *Is not the site of a historic event with a significant effect upon society.*

It is staff's understanding that the site is not associated with any significant event.

- 5 *Does not exemplify the cultural, political, economic, social, or historic heritage of the city.*

It is staff's understanding that the elements under review do not exemplify the cultural, political, economic, social or historic heritage of the city.

- 6 *Does not portray the environment in an era of history characterized by a distinctive architectural style.*

Staff believes that elements proposed for demolition do not portray an era of history characterized by a distinctive architectural style.

- 7 *If a part of or related to a square, park, or other distinctive area, nevertheless should not be developed, or preserved according to a plan based on the area's historic, cultural, natural, or architectural motif.*

This is not the case.

- 8 *Does not have a unique location or singular physical characteristic which represents an established and familiar visual feature of its neighborhood or of the city, and does not exemplify the best remaining architectural type in a neighborhood; and*

The elements under review do not have a unique location or physical characteristics which represent an established and familiar visual feature of its neighborhood or of the city.

- 9 *Has not yielded, and is not likely to yield, information important in history.*

Staff believes that the elements under review do not yield important information in history.

It is staff opinion that the request for demolition can be considered as it meets the criteria for demolition and the proposed elements for demolition do not portray any significant architectural elements. If approved, this will require two readings for demolition as the building is contributing to the historic district. Staff will review submitted construction plans for demolition and design to assure consistency with submitted drawings.

# APPLICATION

# HARC MAJOR PROJECTS CERTIFICATE OF APPROPRIATENESS



**City of Key West**

1300 White Street  
Key West, Florida 33040

HARC COA # <i>COAC 2025-0061</i>	REVISION #	INITIAL & DATE
FLOOD ZONE	ZONING DISTRICT	BLDG PERMIT #

**A PRE-APPLICATION MEETING WITH HARC STAFF IS REQUIRED PRIOR TO SUBMITTAL**

ADDRESS OF PROPOSED PROJECT:

<i>1301 Whitehead Street</i>	
NAME ON DEED: <i>Peter &amp; Dixie Janker</i>	PHONE NUMBER <i>703 850 0986</i>
OWNER'S MAILING ADDRESS: <i>1301 Whitehead Street</i>	EMAIL <i>psjanker@yahoo.com</i>
APPLICANT NAME: <i>Peter Janker</i>	PHONE NUMBER <i>703 850 0986</i>
APPLICANT'S ADDRESS: <i>1301 Whitehead St.</i>	EMAIL <i>psjanker@yahoo.com</i>
APPLICANT'S SIGNATURE: <i>[Signature]</i>	DATE

**ANY PERSON THAT MAKES CHANGES TO AN APPROVED CERTIFICATE OF APPROPRIATENESS MUST SUBMIT A NEW APPLICATION.**

FLORIDA STATUTE 837.06: WHOEVER KNOWINGLY MAKES A FALSE STATEMENT IN WRITING AND WITH THE INTENT TO MISLEAD A PUBLIC SERVANT IN THE PERFORMANCE OF HIS OR HER OFFICIAL DUTY SHALL BE GUILTY OF A MISDEMEANOR OF THE SECOND-DEGREE PUNISHABLE PER SECTION 775.082 OR 775.083. THE APPLICANT FURTHER HEREBY ACKNOWLEDGES THAT THE SCOPE OF WORK AS DESCRIBED IN THE APPLICATION SHALL BE THE SCOPE OF WORK THAT IS CONTEMPLATED BY THE APPLICANT AND THE CITY. THE APPLICANT FURTHER STIPULATES THAT SHOULD FURTHER ACTION BE TAKEN BY THE CITY FOR EXCEEDING THE SCOPE OF THE DESCRIPTION OF WORK, AS DESCRIBED HEREIN, AND IF THERE IS CONFLICTING INFORMATION BETWEEN THE DESCRIPTION OF WORK AND THE SUBMITTED PLANS, THE AFOREMENTIONED DESCRIPTION OF WORK SHALL BE CONTROLLING.

PROJECT INCLUDES: REPLACEMENT OF WINDOWS  RELOCATION OF A STRUCTURE  ELEVATION OF A STRUCTURE   
 PROJECT INVOLVES A CONTRIBUTING STRUCTURE: YES  NO  INVOLVES A HISTORIC STRUCTURE: YES  NO   
 PROJECT INVOLVES A STRUCTURE THAT IS INDIVIDUALLY LISTED ON THE NATIONAL REGISTER: YES  NO

<b>DETAILED PROJECT DESCRIPTION INCLUDING MATERIALS, HEIGHT, DIMENSIONS, SQUARE FOOTAGE, LOCATION, ETC.</b>
GENERAL: <i>Follow on HARC review to bonds held 2015, 2016, 2017, 2022, 2024. Complete renovation of home to include: squaring off back of home; new window &amp; door (sliders); redesigned roofline; mument; redesign of accessory bld / garage.</i>
MAIN BUILDING: <i>Windows, door (north), sliders, roof redesign of flat feature.</i>
<b>DEMOLITION (PLEASE FILL OUT AND ATTACH DEMOLITION APPENDIX):</b>
<i>Mument of accessory building with partial demo of structure for enlargement to single stall garage with a second story storage area.</i>

APPLICATIONS MUST BE SUBMITTED IN PERSON WITH HARD COPIES BY 3PM ON THE SCHEDULED DEADLINE  
 PLEASE SEND AN ELECTRONIC COPY OF ALL DOCUMENTS CITY\_HARC@CITYOFKEYWEST-FL.GOV

<b>ACCESSORY STRUCTURE(S):</b> <i>max per 2017 HARC board approval, enlarge to full one car garage with 2nd floor storage area</i>	
<b>PAVERS:</b>	<b>FENCES:</b> <i>repair and paint</i>
<b>DECKS:</b> <i>repair &amp; paint.</i>	<b>PAINTING:</b> <i>same color as rest of house &amp; trim.</i>
<b>SITE (INCLUDING GRADING, FILL, TREES, ETC):</b> <i>Per 2022 HARC board</i>	<b>POOLS (INCLUDING EQUIPMENT):</b>
<b>ACCESSORY EQUIPMENT (GAS, A/C, VENTS, ETC):</b> <i>install central a/c, gas for kitchen, vents as appropriate.</i>	<b>OTHER:</b> <i>new elec system &amp; plumbing system to include drip sprayer system</i>

OFFICIAL USE ONLY:	HARC COMMISSION REVIEW	EXPIRES ON:
MEETING DATE:	<input type="checkbox"/> APPROVED <input type="checkbox"/> NOT APPROVED <input type="checkbox"/> DEFERRED FOR FUTURE CONSIDERATION	INITIAL:
MEETING DATE:	<input type="checkbox"/> APPROVED <input type="checkbox"/> NOT APPROVED <input type="checkbox"/> DEFERRED FOR FUTURE CONSIDERATION	INITIAL:
MEETING DATE:	<input type="checkbox"/> APPROVED <input type="checkbox"/> NOT APPROVED <input type="checkbox"/> DEFERRED FOR FUTURE CONSIDERATION	INITIAL:
REASONS OR CONDITIONS:		
STAFF REVIEW COMMENTS:		
FIRST READING FOR DEMO:	SECOND READING FOR DEMO:	
HARC STAFF SIGNATURE AND DATE:	HARC CHAIRPERSON SIGNATURE AND DATE:	

THIS APPLICATION MAY BE REVIEWED BY PLANNING DEPARTMENT STAFF.

# HARC CERTIFICATE OF APPROPRIATENESS: DEMOLITION APPENDIX



**City of Key West**

1300 White Street  
Key West, Florida 33040

HARC COA # <b>Coas 2025-1570</b>	INITIAL & DATE <b>PDM 6/30/2025</b>
ZONING DISTRICT	BLDG PERMIT # <b>BLD2025-1177</b>

<b>ADDRESS OF PROPOSED PROJECT:</b>	1301 Whitehead Street
<b>PROPERTY OWNER'S NAME:</b>	Peter & Dixie Janker
<b>APPLICANT NAME:</b>	Peter Janker

*I hereby certify I am the owner of record and that the work shall conform to all applicable laws of this jurisdiction. By receiving a Certificate of Appropriateness, I realize that this project will require a Building Permit approval **PRIOR to proceeding with the work outlined above** and that a final inspection is required under this application. I also understand that **any changes to an approved Certificate of Appropriateness must be submitted for review.***

<p style="border: 1px solid black; padding: 5px;">PROPERTY OWNER'S SIGNATURE  105 June 2025</p>	<p style="font-size: 1.2em; font-weight: bold;">Peter Janker</p> <p style="font-size: 0.8em;">DATE AND PRINT NAME</p>
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DETAILED PROJECT DESCRIPTION OF DEMOLITION
Removal and replacement of northeast wall side wall, removal and replacement of rear east wall so as to enclose what is now a screened 2nd floor porch. Remove rear wall and replace so as to square off of the rear of the building.

CRITERIA FOR DEMOLITION OF CONTRIBUTING OR HISTORIC STRUCTURES:
<b>Before any Certificate of Appropriateness may be issued for a demolition request, the Historic Architectural Review Commission must find that the following requirements are met (please review and comment on each criterion that applies):</b>
(1) If the subject of the application is a contributing or historic building or structure, then it should not be demolished unless its condition is irrevocably compromised by extreme deterioration or it does not meet any of the following criteria:
(a) The existing condition of the building or structure is irrevocably compromised by extreme deterioration.
The lifting of the building identified issues with support structure and stability reflected in the northeast side wall detaching. The lift was completed by bypassing the the rear structure for the lift and use of extra cribbing.
(2) Or explain how the building or structure meets the criteria below:
(a) Embodies no distinctive characteristics of a type, period, or method of construction of aesthetic or historic significance in the city and is not a significant and distinguishable building entity whose components may lack individual distinction.
The northeast rear of the building, both floors, has been previouisly reviewed by the committee and no distinctive characteristics were identifed of historical significance. No issues were identified with squaring off the rear of the building.

Nothing in this application is intended to alter the authority of the Building Official to condemn for demolition dangerous buildings, as provided in Section 102-218 of the Land Development Regulations and Chapter 14 of the Code of Ordinances.

(b) Is not specifically associated with events that have made a significant contribution to local, state, or national history.

N/A

(c) Has no significant character, interest, or value as part of the development, heritage, or cultural characteristics of the city, state or nation, and is not associated with the life of a person significant in the past.

N/A

(d) Is not the site of a historic event with significant effect upon society.

N/A

(e) Does not exemplify the cultural, political, economic, social, or historic heritage of the city.

N/A

(f) Does not portray the environment in an era of history characterized by a distinctive architectural style.

N/A

(g) If a part of or related to a square, park, or other distinctive area, nevertheless should not be developed or preserved according to a plan based on the area's historic, cultural, natural, or architectural motif.

N/A

(h) Does not have a unique location or singular physical characteristic which represents an established and familiar visual feature of its neighborhood or of the city, and does not exemplify the best remaining architectural type in a neighborhood.

N/A

Nothing in this application is intended to alter the authority of the Building Official to condemn for demolition dangerous buildings, as provided in Section 102-218 of the Land Development Regulations and Chapter 14 of the Code of Ordinances.

(i) Has not yielded, and is not likely to yield, information important in history,

N/A

**CRITERIA FOR DEMOLITION OF NON-CONTRIBUTING OR NON-HISTORIC STRUCTURES:**

The following criteria will also be reviewed by the Historic Architectural Review Commission for proposed demolitions. The Commission shall not issue a Certificate of Appropriateness that would result in the following conditions (please review and comment on each criterion that applies):

(1) Removing buildings or structure that are important in defining the overall historic character of a district or neighborhood so that the character is diminished.

Structures being removed currently detract from the historical character of the home & neighborhood. Changes are anticipated to enhance the character of the home, neighborhood and district.

(2) Removing historic buildings or structures and thus destroying the historic relationship between buildings or structures and open space.

No impact

(3) Removing an historic building or structure in a complex; or removing a building façade; or removing a significant later addition that is important in defining the historic character of a site or the surrounding district or neighborhood.

The additions are not being removed. Walls are being brought up to code and safety standards and for three sections of the rear wall are being moved approximaely 18 inches to align with the 2nd story southeast wall.

(4) Removing buildings or structures that would otherwise qualify as contributing.


City has articulated that the northeast 1st and 2nd floor structures to be noncontributing, specifically the former 1st floor porch (subsquently enclosed) and the 2nd floor screen porch.

# SANBORN MAPS






75  
UNITED

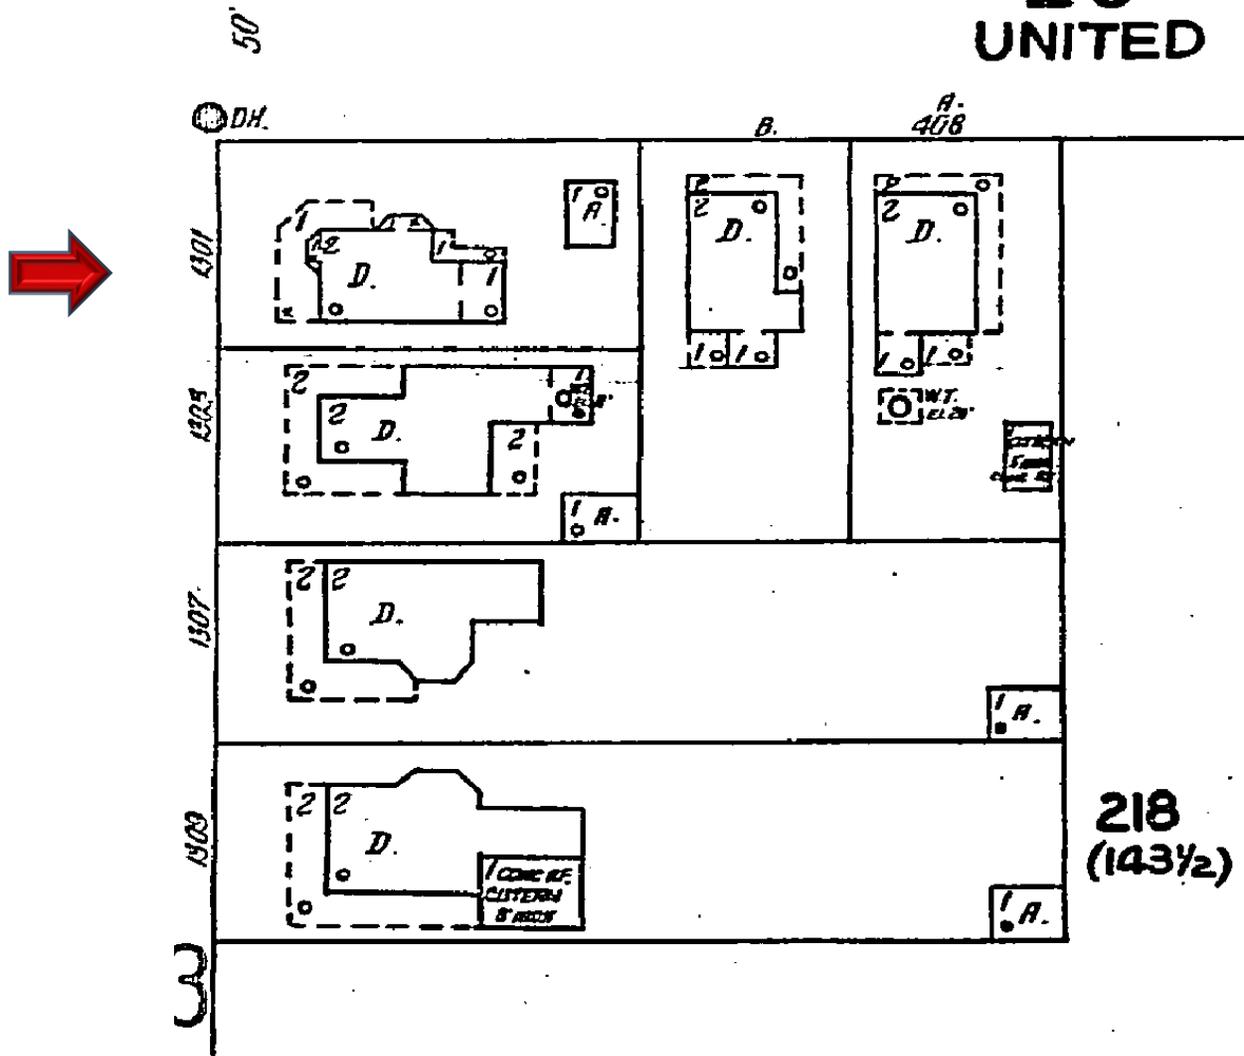

#1301 Whitehead Street 1926 Sanborn Map

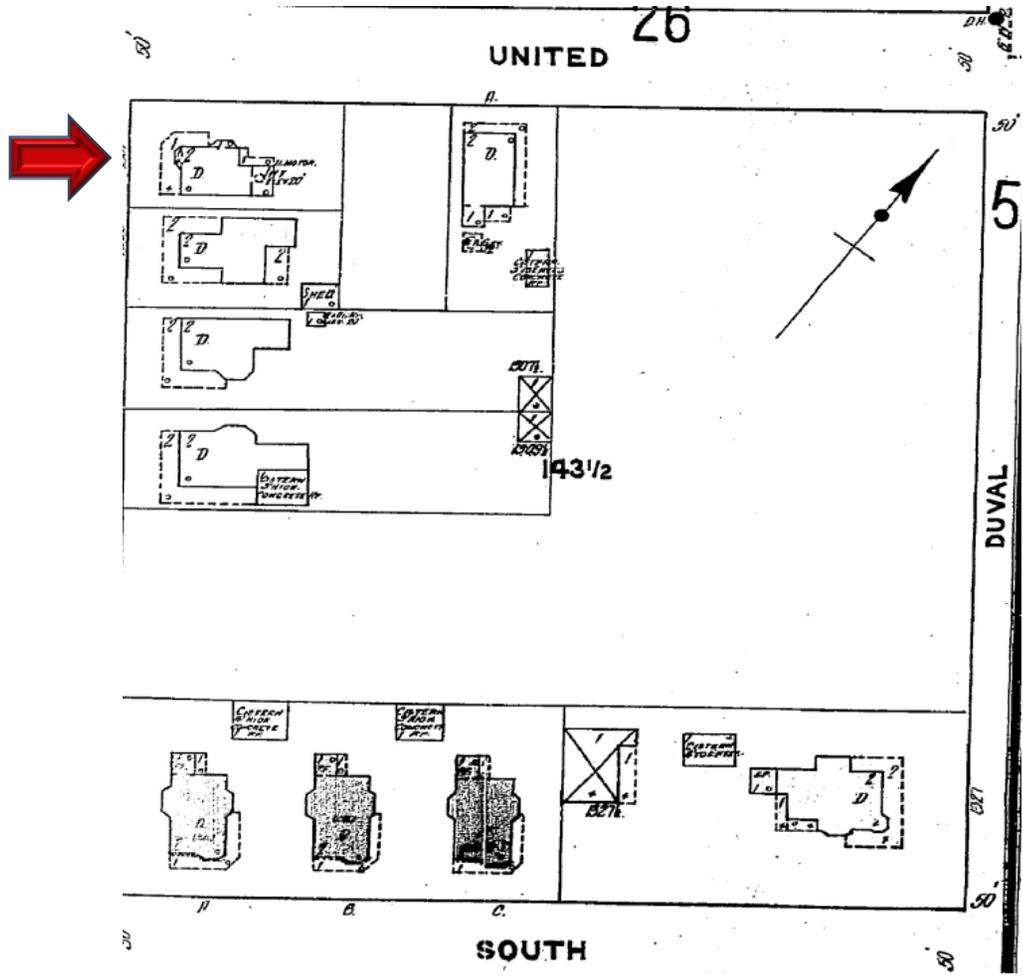

1912 Sanborn Map

# PROJECT PHOTOS

## Scope of Unpermitted Work Performed at 1301 Whitehead Street, an historic 2 story Conch House

- (1) Front Porch Railings: Installation of one section of front porch railings per plans submitted by Samantha Jones INC (see enclosure for engineering details). Railings consist of 2x6 pressure treated lumber with tapered 15% top for sheading water. Balusters are 2x2 pressure treated lumber. Posts are of 6x6 pressure treated lumber fastened to the porch with  $\frac{3}{4}$ " stainless steel threaded rod. All wood attachments were via 3" Deckmate 316 stainless-steel screws, Balusters are fastened with Deckmate 316 stainless steel 3" trim screws. All wood was primed with Kiltz white primer and finished with high gloss white exterior Behr enamel.
- (2) North Wall: Replacement of damaged north wall with 2x4 pressure treated lumber, two window openings were rough framed can be patched & enclosed (same size openings as historic windows of home) and one door rough framed but will be patched & enclosed (36x86) opening conforming with elevations provided by One Call Construction during its 2016 HARC review. Framing construction performed iaw code standards on pressure treated 2x4 16-inch centered studs and appropriate fasteners.
- (3) Beams: There are a total of 6 beams, on the ceiling of the first floor, each of which consists of 3 pressure treated 2x12s of lumber fasten together with Liquid Nails and 5' Ledger Loc fasteners. The two on the exterior walls, running west to east, act as sills with the one on the south being 20' 4" and the one to the north 18'. Two interior beams each of which consists of extending the length of the rear addition are 20' 4' and 18' respectfully west to east. Two beams run south to north and comprises the home's lintel/roof beam to support the roof, the other comprises the interior load bearing wall for what was the home's roof beam for the original rear of the home built in 1911, both are 23' 2" in length.  
2<sup>nd</sup> Floor Joists: Work consisted of pressure treated 2x10 joists running perpendicular to length of the home between the four beams noted in para 3. They are attached to the beams with Simpson Strong Tie hangers of stainless steel, LUS210SS and fastened with stainless steel nails (SCRN Ring Shank Connector nails Type 361). See engineering diagram
- (4) Posts: Three existing 6x6 pressure treated posts were replaced with three new posts, since old posts were damaged, weather worn and too short once home was raised. An additional three 6x6 posts were added to provide additional support to the roof beam & square off the back elevation of the home. It also brought construction standards up to meet or exceed code requirements. Posts were secured with fabricated stainless steel & powder coated 6x6 brackets, manufactured with 201 stainless steel base plate

.2" thick and reinforced with 12" vertical plates which are .16" thick, and fasten with ½" stainless steel lag screws.

- (5) Support Structure 2<sup>nd</sup> Floor Porch Floor: primary 2x4 framing (see photo below) removed. Stop work occurred before work could be completed in regard to replacement of support structure & half walls.
- (6) Rear Wall 1<sup>st</sup> floor removed not yet replaced, 2<sup>nd</sup> floor porch ½ wall and top screen removed and not yet replaced. Walls currently supported with jack stands and bottle jacks.

#### Photo Library:

- (1) Front Porch Railings:

Known HARC issues: HARC would like to see 6x6 posts removed and replaced with bottom rail wooden bridges, issue is one of building codes compliance, HARC initially objected to the distracting look of having 6x6 posts every 6 feet per code; HARC felt that if the posts remained then the posts should go thru top railing and have a cap, Owners have concerns and would rather the posts stay below the top railing to not have the posts stand out which is a common look especially for the Curry homes and homes with expansive porches; gap between lower rail and porch surface, code specifies 2 inches, HARC would like it more but an obvious limit would be 3 ½, which is the same as the balusters; spacing between balusters vicinity the porch columns, HARC would like them with uniformed gaps; post on top of stairs looks long since stairs are free standing. For steps, HARC would like to see upper post moved to porch or removed and porch columns use for anchor support.



Railing Elevations presented during 2016 One Call Construction HARC Board Presentation:  
Railing over Posts, no objections noted.



HARC Recommended Railings: Lower railing blocks, based upon inquiry from owners, HARC noted that color must be white and not trim and home color as shown.





**Examples of 2x6 sloped railings over posts in the immediate area of old town and relevant to the railing design of 1301 Whitehead:**

Railings over posts, one of the three sisters on South Street, on same block as 1301 Whitehead



Railings over porch corner of United and Duval, one block from 1301 Whitehead



Railings over posts, 2 blocks north on Whitehead Street.





Casa Marina Railings over posts, vicinity of recreational area



(2) North Rear Wall:

Before Demo and Replacement



After Lift before North Wall demo



After Demo and Framing



2016 HARC reviewed plans, no objections to squaring off back of home or enclosing rear 2<sup>nd</sup> story porch



2025 Current Plans for future HARC review



North Wall Interior, replaced wall that fell off during lifting of home, joists and sill replaced 2x4 joists and 2x6 sills. (see next photo)



(3) Beams and 2<sup>nd</sup> Floor Joists:

Old North 2<sup>nd</sup> floor joists removed, not spacing and use of 2x4 lumber...not to code



Old 2<sup>nd</sup> floor, shimmed 24 inch on center joists on south side of rear that were removed, note cantilevered on far wall that is insufficient



South Sill and two interior beams 2 each beams consisting of 3 each 2x12 sills and 3 each 3 2x12 interior beams. Note 16 inch on center Joists on both north and south sections of the rear of the house



(4) Three 6x6 posts (left section of photo) emplaced to provide extra support to roof beam thus eliminating the 2 foot, 2<sup>nd</sup> floor cantilever across the rear of the home. No rear addition and both floors remain under the exiting roofline.



(5) Porch knee wall and screen removed along with interior plywood sheathing use to keep weather out.

Knee Wall with exposed 2x4s and screening on upper half...upper half, interior ½ plywood (installed for weather/ hurricane protection) already removed



Rear of home with knee wall removed, looking east, support structure removed, not yet replaced.



Rear of 1301 Whitehead before lifting and prior to renovation




Rear of 1301 Whitehead after lifting and prior to renovation of first floor




Rear of home view with upper porch demo completed with no replacement structure for 1<sup>st</sup> floor rear wall or 2<sup>nd</sup> floor porch ½ wall or screen



Rear of Home...current plans

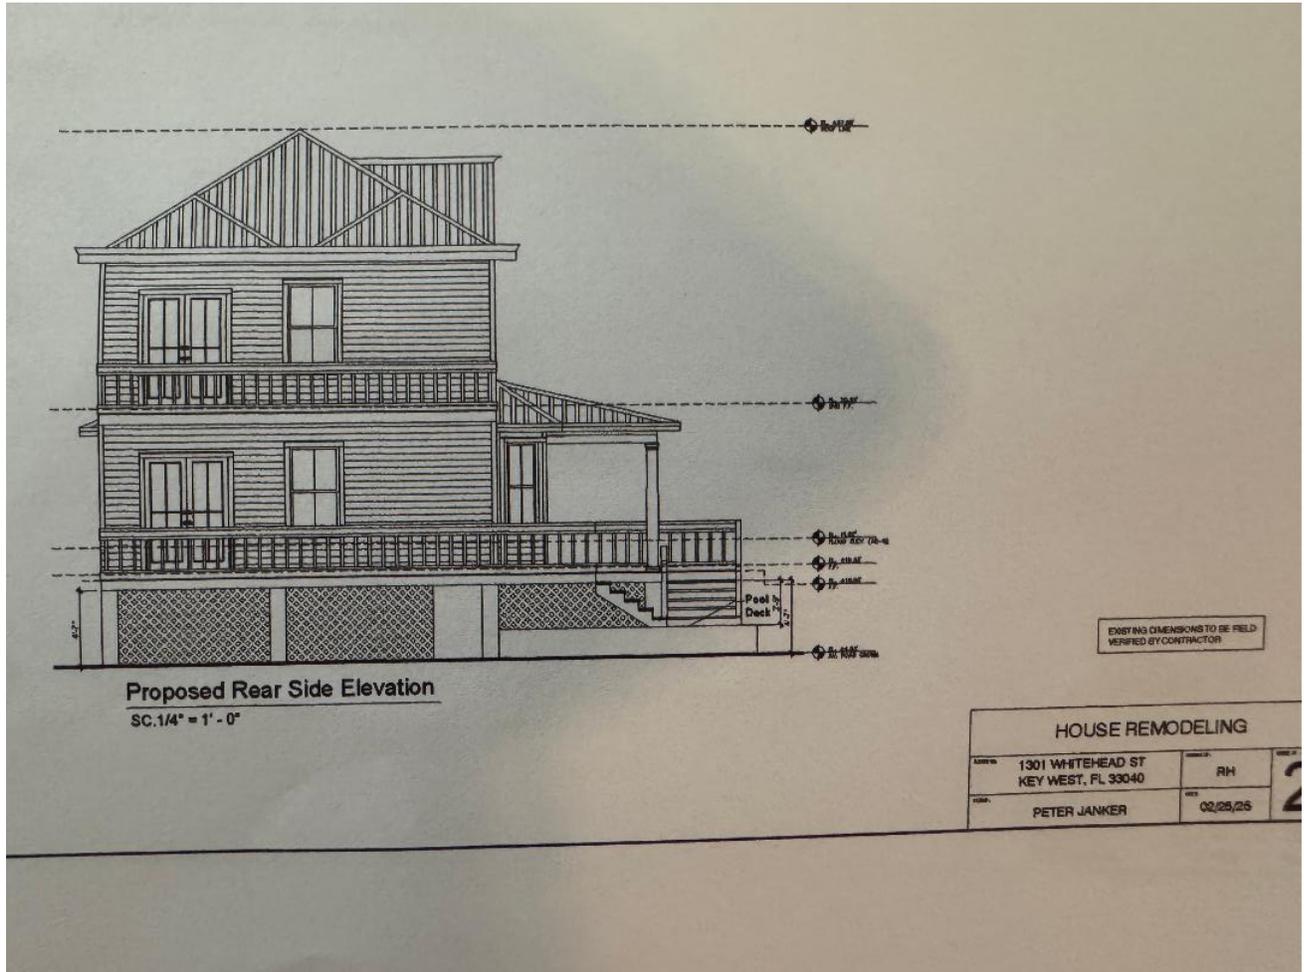

Scope of Unpermitted work on site plan

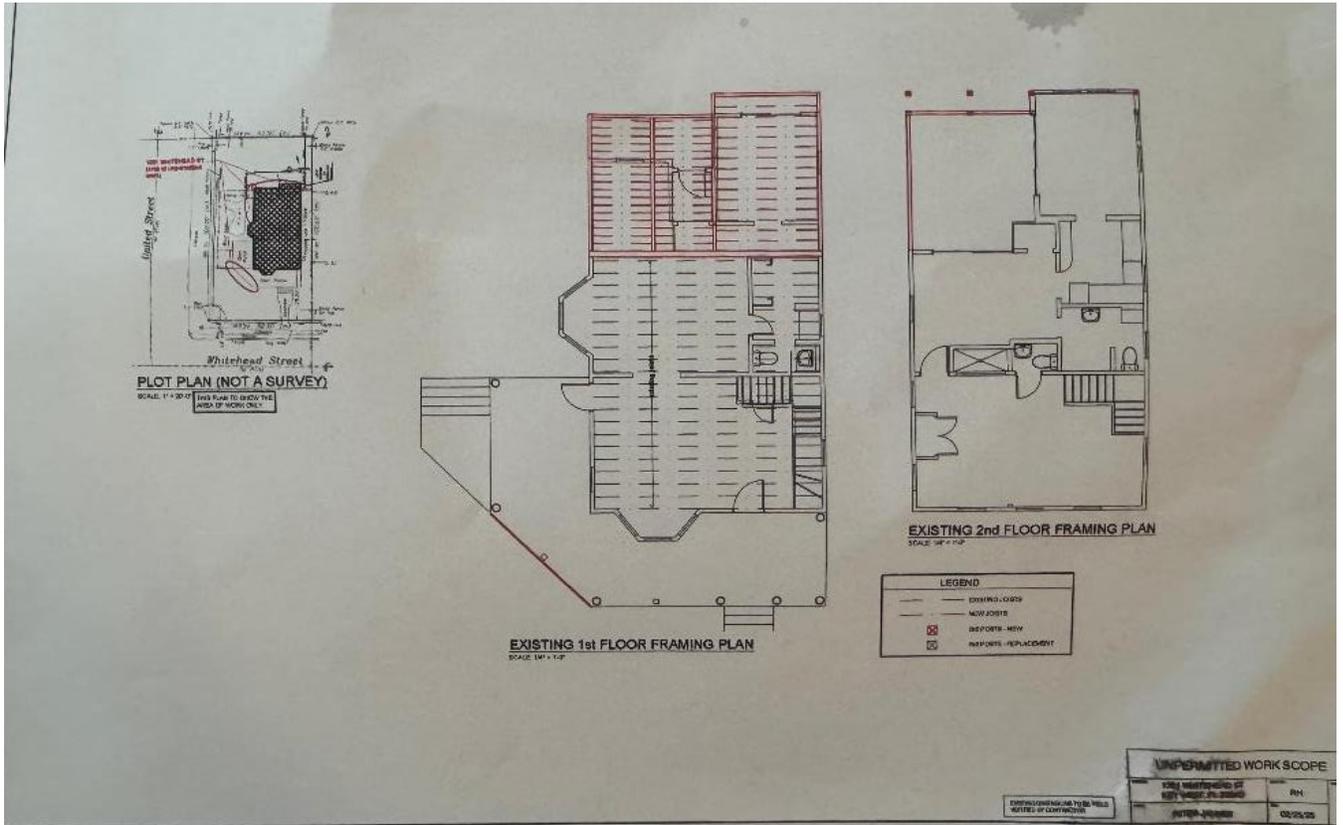

# Demolition Appendix 1301 Whitehead, Key West, FL

- **Demolition Plans:**

- Existing Conditions:**

- The property under review contains a historic two-story frame “large Conch house” [1] structure, which is listed as contributing, with a year built circa 1911. The southeast 1<sup>st</sup> story addition (summer kitchen) was built approximately 1912 and was originally attached to the home. Sometime after 1912 a living space was added above the summer kitchen and the structures were attached to the main house via the addition of a hallway on the first floor. A porch was built on the northeast side of the building and over the years was enclosed & an open porch constructed upon its roof sometime between 1960 and 1965.

- In May 2024, 1301 Whitehead was raised three feet, 6 inches above its previous elevation of 6.5 feet bringing the total elevation of the home to 10 feet. Hardscaping has taken place in both front, side and rear yards via use of fill dirt to successfully reduce the visual impact of the elevating of the home. Hardscaping has been completed in the front yard and mitigation of the visual impact of the raising of the home appears to have been achieved. (see Photo “Front Elevation”) The lifting of the home is intended to protect this contributing structure and was in accordance with those plans briefed and approved by the HARC committee in 2017. (see “Conception” rendering)

- What needed to be removed/moved:**

- Demolition of the rear north wall of the old porch. Rational: North wall section detached while the home was being raised. During the lift, it was chained to the second-floor sill and ledger lock screwed into the northeast framing of the original home. Replacement was necessary since its supporting structure had failed which created a safety issue. This had been recognized by the lifting company that was forced to not use the wall structure for lifting and secured said wall with a chain. The lift was conducted thru a temporary beam put in place to the respective rear & interior load bearing walls. (see “after lift” photo 4x6 post and beam)

- Demolition of the rear north wall of the old porch. Rational: North wall section detached while the home was being raised. During the lift, it was chained to the second-floor sill and ledger lock screwed into the northeast framing of the original home. Replacement was necessary since its supporting structure had failed which created a safety issue. This had been recognized by the lifting company that was forced to not use the wall structure for lifting and secured said wall with a chain. The lift was conducted thru a temporary beam put in place to the respective rear & interior load bearing walls. (see “after lift” photo 4x6 post and beam)

Demolition of rear northeast porch (5x5 square feet), consisting of novelty siding on its north side and cedar shingles in shake style on its west side. Neither was appropriate for the home which has clapboard style wood siding on its major exterior features.

The porch supporting structure had also failed resulting in the porch railings sloping 20% to the north. (see photo "Rear Slant") Additionally, the porch header had failed due to the upper porch deck being constructed of substandard 2x4 joists. The upper porch features date from the 1960-1965 era when the doorway from the historical southeast summer kitchen was changed over to a window and the exit door was moved to what had been an historical ground level porch on the northeast corner of the home. Overall, the porch had detached from foundation and had no supporting structure prior to the lift, materials used not suited to the home and the lumber had deteriorated to a point that it created a safety issue.

Demolition of rear southeast, 1<sup>st</sup> floor slider and wall segment, total area 10x9. Cantilevered second floor wall was not to code in regards to recess beams lack of setback. Termite damage to framing and inadequate load transfer framing (inadequate header for slider) also resulted in slider malfunctions/sticking due to perceived inadequate structural support.

The east facing door that was historically part of the north east 2<sup>nd</sup> story porch was removed as well as the screening for the second story screen porch, with the intention of enclosing the formally screen porch with lap siding and windows according to submitted plans. The stairs and staircase platforms that supported said door had been removed prior to current ownership. (see Photo "Rear Slant")

While the two under house 30K gallon cisterns are being restored & saved the small 4x10 foot cistern at the southeast corner of the lot had previously been decommissioned, likely in coordination of the reported windmill which no longer exists.

The southeast 2<sup>nd</sup> floor summer kitchen addition is proposed to lose its two windows (see "after lift" photo above) which will be replaced by French doors, as well as on the 1<sup>st</sup> floor where a slider will be replaced with French door matching and in line with that of the second floor.

The door that replaced the door on the north side of the summer kitchen (had been changed into a window in the rear slant photo) and exited to the east from the enclosed first floor porch on the north east side of the home will be removed and replaced with a door exiting to the north which will be aligned with the historical exit from the rear of the home. (see "after demo and rebuild" photo above).

The accessory building, which was approved for raising and moving in 2017, has not yet been moved but is anticipated to be moved, and reconstructed so as to comply all setback requirements.

The homeowner is proposing removing the current northeast addition flat roof and replacing it with a similar roofline as the southeast addition (roofet). Intent is that the structure would continue the same water catchment gutters as does the rest of the home. Homeowner is seeking a compromise with the city HARC manager as to being able to retain some element of an elevated flat structure in consideration of removing what can be viewed as an eyesore. Failing this, the homeowner is willing to modify the northeast roofline to match the rest of the home, implement the water catchment feature on this element thus improving the aesthetics while retaining the features of a flat roof. An alternative is to return to the same basic gable roof that existed prior to 1960, to the entire rear home post 1911 additions.

- **Demolition Scope:**

The only significant demolition anticipated is to the rear 1/3 of the home in regards to the rear walls and north wall of the home which has already occurred and was performed as part of the 1<sup>st</sup> story framing and house lift. It is planned to remove all exterior wall mounted sewer, power, AC unit, and water lines that currently are mounted and place them within the existing wall structure or underground. (see photos “South wall”) The pool will remain in its current location but it is likely that its walls will need to be replastered and that the supporting deck will need to have up to ½ of its decking removed, support structure brought up to code and reinstalled. Once the accessory building is moved, its new foundation will have to be built. All demolition will leverage industry standard safety measures for both occupants and construction personnel. Three windows are anticipated to be demo’ed on the south side of the home. One is an aluminum jalousie window and one has a Plexiglas instead of glass, and one is a fixed pane of patterned glass. none are historic to the home. (see South wall photos) Two windows will be removed on the east rear 2<sup>nd</sup> story of the building to make room for a set of French doors however consideration is being given to move the door to the northeast of the rear to what is now part of the screen porch, this would save the two original windows.

- **Historic/Cultural Item Identification:**

The current homeowners are highly motivated to preserve the historical elements of the home and have already identified key features that led to the conclusion that the 1912 summer kitchen was a separate structure when build. As a result, the homeowners intend on retaining interior siding (had been covered with drywall) within the house to preserve the home’s history. Homeowners have also salvaged 75% of the Dade pine flooring and walls within the home and will process said lumber for reuse within the home. 100% of the front porch framing was saved and 20% of the first-floor framing beams were saved, at significant cost, by sistering 2x12 pressure treated lumber to permit joist attachment. Damaged joists will be reused within the house as stair threads

or for other infrastructure purposes. Homeowners will remain on site during construction and will communicate to their architect any discovery of historical elements or features, which the homeowners are motivated to preserve. The 1911 builders of the home used mild steel brackets, some of which show evidence of on-site heating and customization. In concert with best engineering and architectural practices these items will be removed, inspected, and where possible refurbished & reused as designed in appropriate locations and in accordance with building codes. (see Photo “Bracket Reuse”) In some cases, the reuse will be augmented with alternate elements such as in the reused brackets where the 2 ½ inch squared headed lag screws have been replaced with 3 ½ inch stainless steel lag bolts with stainless steel washers. This process has been used in the bay windows on the west and north elevations where 32-inch treaded ¾ inch steel rods have been replaced with 32-inch ¾ inch stainless steel treaded rods for lateral compression of the 8x8 beams.

The homeowner proposes that portions of the rear 1/3 of the home consisting of the additions done after 1912, to include both 1<sup>st</sup> and 2<sup>nd</sup> stories be sided with a concrete based lap siding (Hardy board) to clearly identify those structures as non-historic to the original home if acceptable by HARC.

- **Site Information:**

Planning for this renovation stipulates homeowner’s specific guidance to protect the current look and feel of the property to include preserving its dense foliage and vegetation. It is not currently anticipated that any protected trees or foliage will be impacted. Should a protected tree be affected the Key West Forester will be contacted for guidance and direction. Utilities considerations are as follows: There is an anticipated need for an additional hook up of sewer for the second unit, there are already two street sewer mains in place, one on United Street (currently capped) and one on Whitehead Street (which is currently hooked up); electrical is planned to be placed underground from the United Street side of the property where it currently serviced. At this time two 200-amp services are anticipated (two meters currently installed 150-amps each with one overhead service line); water is anticipated to require two additional services, one for the second residential unit (consideration is being given to have this second service to support site irrigation and pool service and to service both units with one water service meter) and one for an anticipated fire sprinkler system (Key Aqueduct flow test has already been conducted and resulted are attached) . Gas cylinder has currently been removed from the premises, but is anticipated to be reestablished with a smaller cylinder to reduce its space needs as well as visual aesthetics. It remains to be determined if the gas cylinder will be underground or above ground since the gas company has policies which impact this decision. The homeowner’s preference is to place the gas service underground.

### **Utility Infrastructure:**


Electrical and sewer utilities will provide services from the same public connection points that currently support the property. The additional water and sewer services are anticipated to be from the location on the United Street side of the property. Other than projected backflow preventor, it is not anticipated that any sewer or water utilities infrastructure will be visible from outside or inside the property. Stormwater will be routed to support the current in place foliage and once cisterns are recommissioned stormwater will be routed for underground storage and landscaping/firefighting use.

- **Accessibility, Circulation, & Parking:**

Homeowner had previously coordinated with the city for placement of bike racks immediately adjacent to his property and two additional bike posts within the block area. Current plans support retrofitting of accessibility features for both the front and rear of the home, should that become necessary. Construction and renovation are not anticipated to have any adverse impact on current parking in the area either residential or general public. Movement of the accessory building (garage) is anticipated to provide two additional off street-parking spaces which will improve the parking situation in the Southernmost Point area. The current off-street parking area is inadequate to support anything but a golf cart or sub-compact vehicle, with difficulty.

- **Supporting Photographs:**

Scope of Work Elevation – Presented at 2017 HARC Committee Review with Acceptance, updated July 2024 Review

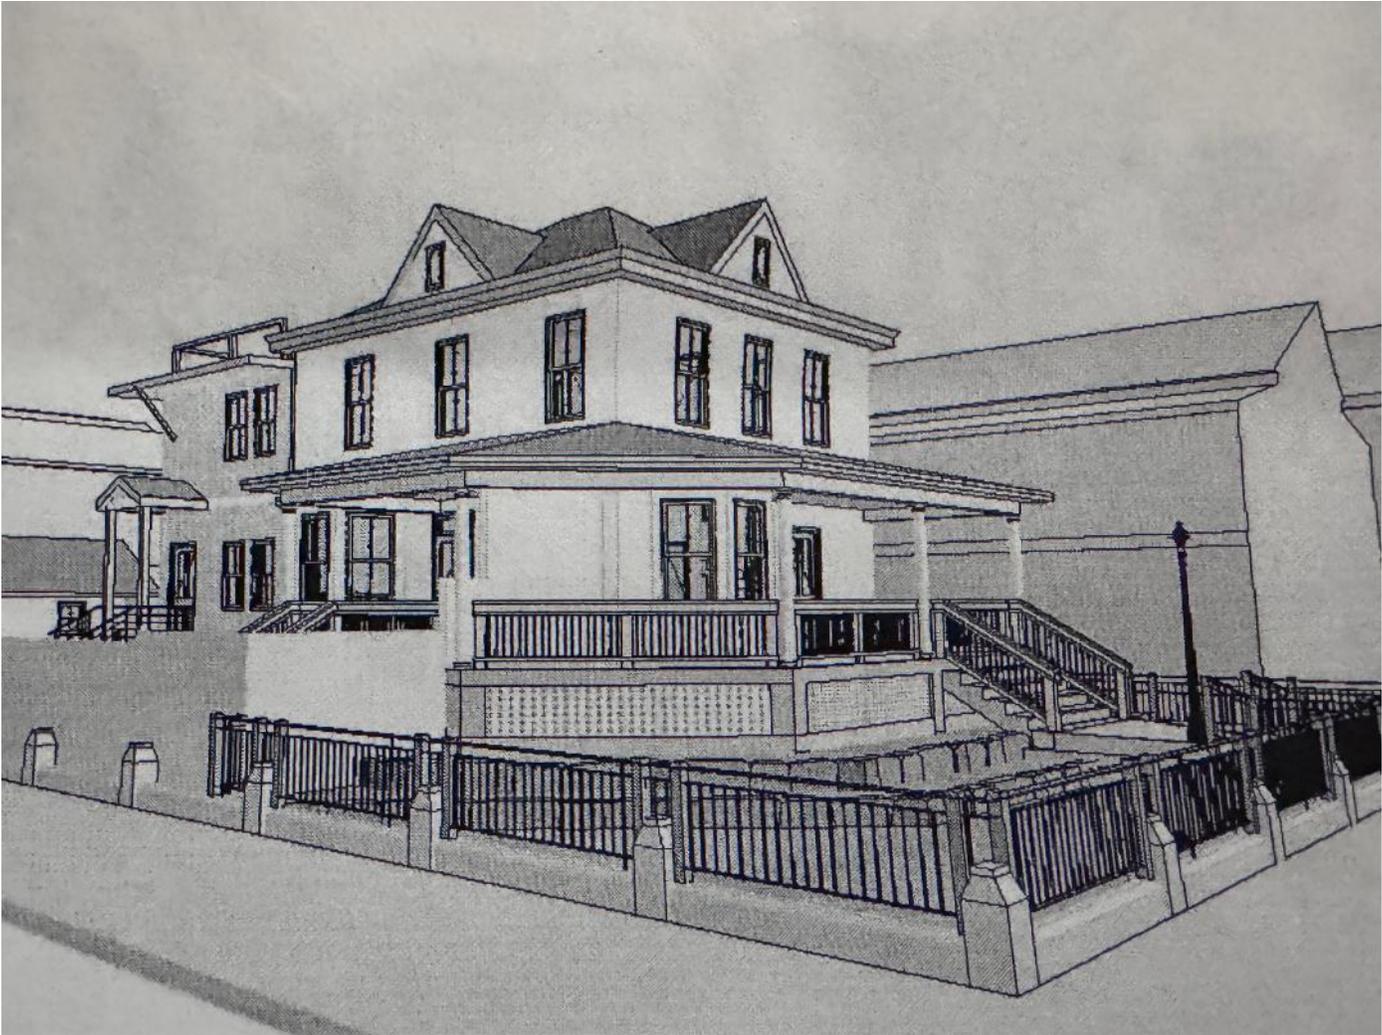

**1301 Whitehead Prior to lifting home, prior to 15 May 2024**



**Current Front Entry of Home after lifting 3' 6"**



**North front of home and front porch prior to railings**



**Proposed design with top railings over posts per concept plans...intent is to not make railings stand out and to use historical Curry design in Southernmost Point area**



**Rear Northeast Wall and screen porch:**

**Before lifting of home**



Northeast wall after lifting, wall has detached from home (chained to home) and lift is conducted omitting wall and using aux beams (note PT 4x6 and 6x6)



Northeast wall reframed with door and windows per plans



Rear of home. Three different types of siding: clapboard; dutch lap and Shingle,  
Rear porch slanted down 20% based on support failure, usable  
Top porch door, flat roof with no dutch gutters (like remainder of house), 2x4 for  
screen porch joists, improper cantilevered second floor,  
Over all effect is that the back of the home is an eyesore.



South wall with exposed utilities such as cable, gas lines, water lines, and sewer lines. Intent is to remove them from the exterior and place them inside the walls



**Windows to be replace on south wall**

**Aluminum jalousie window in old bathroom which will become the new kitchen**




**Southeast bedroom window, top is plexiglass**



**Southwest window single pane patterned glass, non-historic for home**

## Historic/Cultural Item Identification

Reuse historical brackets after refurbishment, augment old square screws with stainless steel

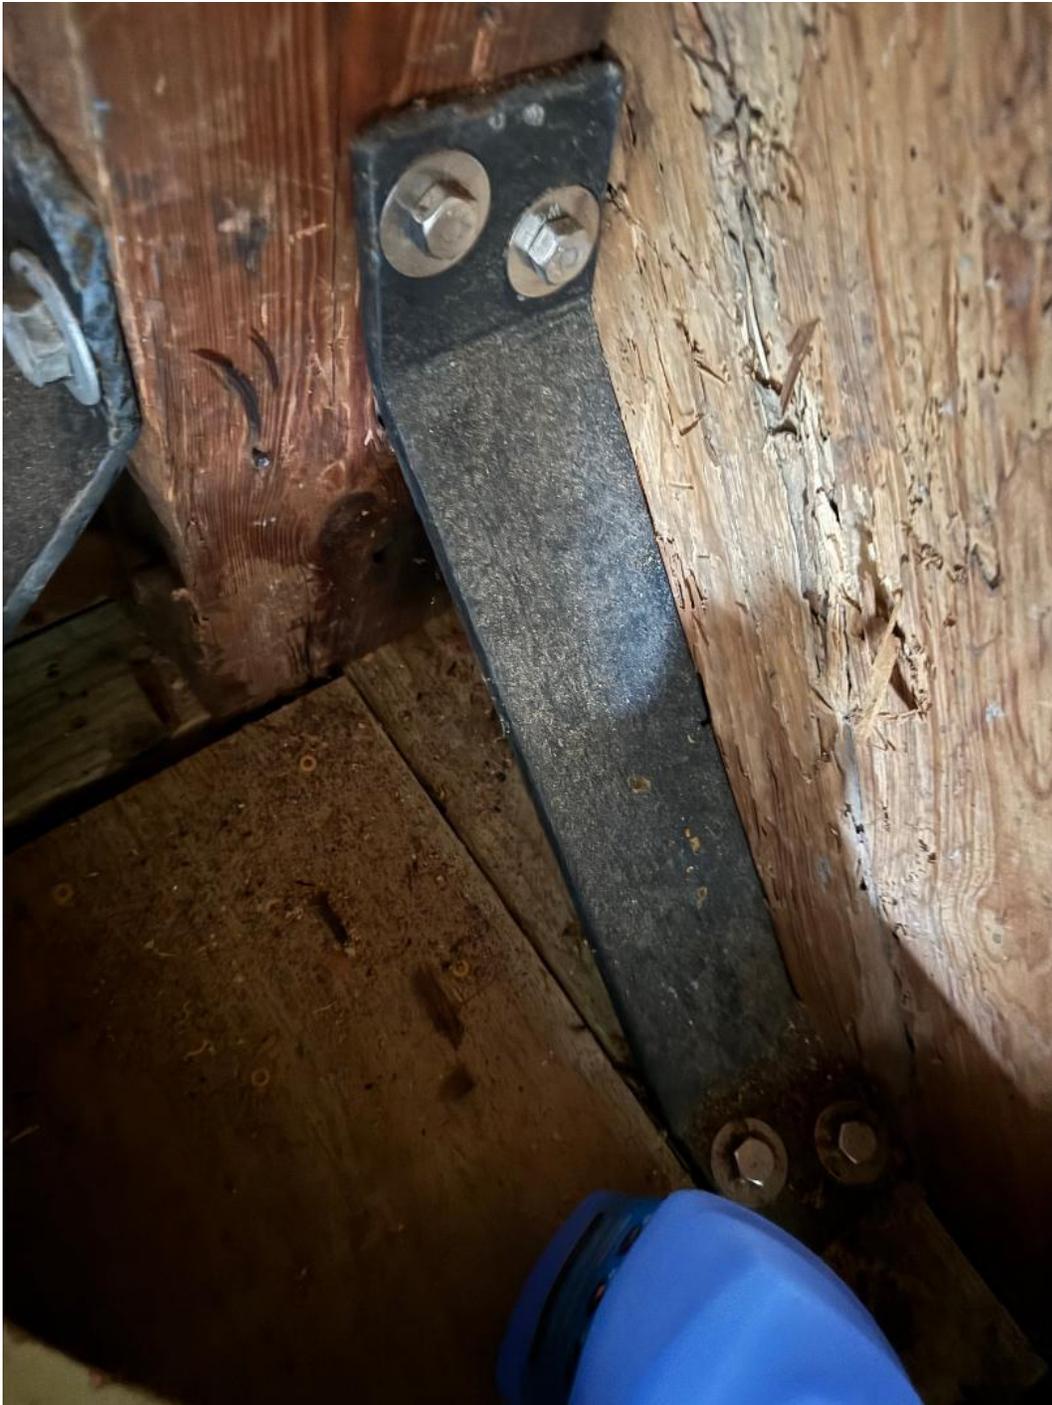

70+ percent of dad pine saved for refurbishment and reuse in interior



Clapboard siding in interior hallway from attachment of summer kitchen to main house post 1912...retain to capture home history



## Accessibility, Circulation, & Parking




### **Attachments:**

**Bike Rack, corner of United and Whitehead**



**Keys Aqueduct Authority Fire Sprinkler Pressure Test 16 May 2025**


**Water Flow  
Test Summary Sheet**

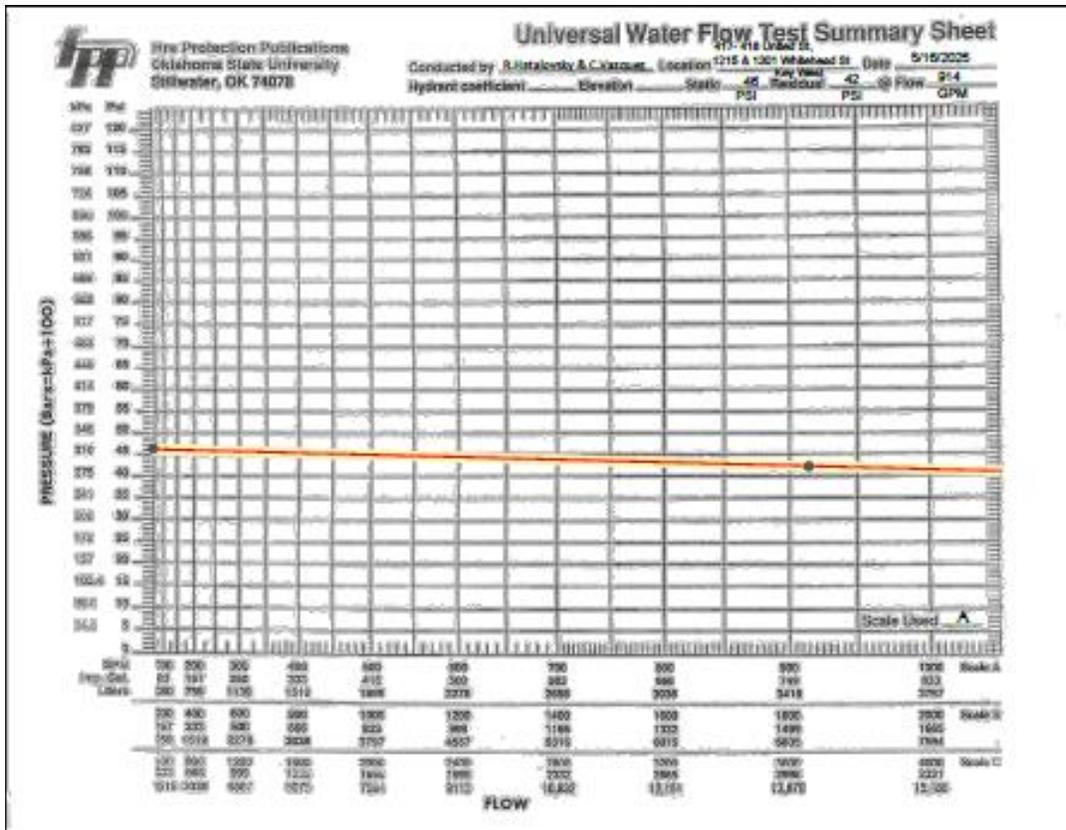

1: "Papa: Hemingway In Key West, James Mc Lendon, Publisher E.A. Seeman Publishing, 1972  
First Edition, 1990 edition Langley Press. Pp57, 130


# SURVEY

# Boundary Survey Map of Part of Lot 2, Square 3, Tract 16 Island of Key West, Florida

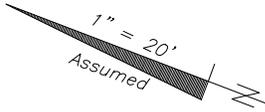

**LEGEND**

●	Found 1/2" Iron Pipe
○	Set 3/4" Iron Pipe w/cap (6298)
●	Found 1/2" Iron Rod (2863)
▲	Found Nail & Disc (5234)
△	Set Nail & Disc (6298)
(M)	Measured
(R)	Record
(M/R)	Measured & Record
C.B.S.	Concrete Block Structure
R\W	Right of Way
CLF	Chain Link Fence
⊕	Centerline
⊗	Wood Utility Pole
⊠	Concrete Utility Pole
-P-	Overhead Utility Lines
(3.5)	Spot Elevation (Typical)

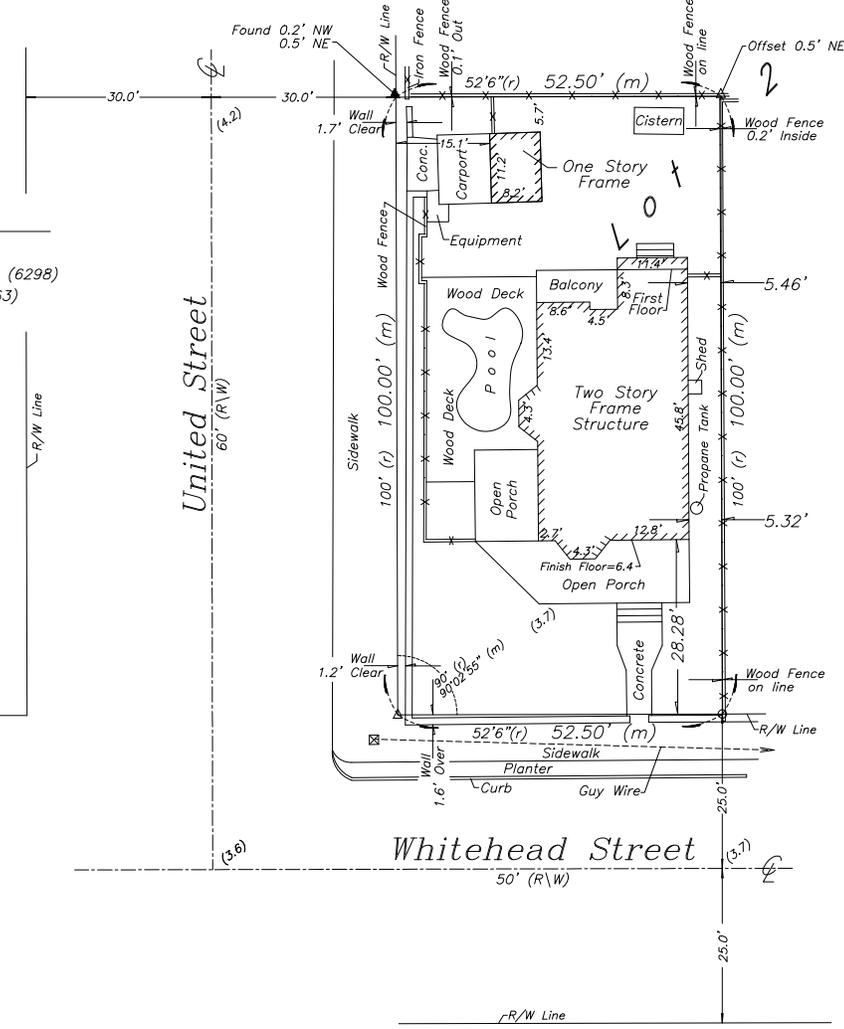

- NOTES:**
- The legal description shown hereon was furnished by the client or their agent.
  - Underground foundations and utilities were not located.
  - All angles are 90° (Measured & Record) unless otherwise noted.
  - Street address: 1301 Whitehead Street, Key West, FL.
  - This survey is not valid without the signature and the original raised seal of a Florida licensed surveyor and mapper.
  - Lands shown hereon were not abstracted for rights-of-way, easements, ownership, or other instruments of record.
  - North Arrow is assumed and based on the legal description.
  - Date of field work: October 11, 2011 and September 16, 2015.
  - Ownership of fences is undeterminable, unless otherwise noted.
  - Adjoiners are not furnished.
  - Elevations are shown in parenthesis and refer to Mean Sea Level, N.G.V.D. 1929 Datum.
  - Benchmark utilized: BASIC
  - Flood Insurance Rate Map Zone: AE (EL 8); Community Panel #120168; 1516 K, dated 2-18-05.

**BOUNDARY SURVEY OF:** On the Island of Key West and known as Part of Lot 2, Square 3, Tract 16 of the Northwesternly one-half of Lot 2, better described by metes and bounds as follows: COMMENCING at the intersection of the of United Street and the Northeastly right of way line of Whitehead Street, said point of intersection to be the Point of Beginning of the parcel of land hereinafter described; thence run in a Southeastly direction along the Northeastly right of way of Whitehead Street 52 feet 6 inches to a point; thence run at a right angle in a Northeastly direction 100 feet to a point; thence run at a right angle in a Northwestly direction 52 feet 6 inches out to United Street; thence run at a right angle in a Southwestly direction along the Southeastly right of way of United Street 100 feet back to the Point of Beginning of the parcel of land herein described.

**BOUNDARY SURVEY FOR:** Peter S. Janker & Dixie L. Janker;

I HEREBY CERTIFY that this survey was made under my responsible charge and meets the Standard of Practice as set forth by the Florida Board of Professional Surveyors & Mappers in Chapter 5J-17, Florida Administrative Code, pursuant to Section 472.027, Florida Statutes.

J. LYNN O'FLYNN, INC.

J. Lynn O'Flynn, PSM  
Florida Reg. #6298

October 17, 2011  
Revised 9/17/15 to add Flood Zone information and Elevations


THIS SURVEY  
IS NOT  
ASSIGNABLE

**J. LYNN O'FLYNN, Inc.**

Professional Surveyor & Mapper  
PSM #6298


3430 Duck Ave., Key West, FL 33040  
(305) 296-7422 FAX (305) 296-2244

# PROPOSED DESIGN

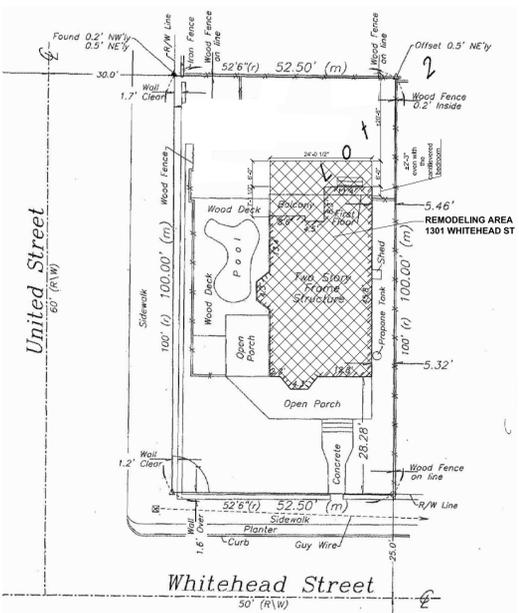


**PLOT PLAN (NOT A SURVEY)**

SCALE: 1" = 20'-0"  
 THIS PLAN TO SHOW THE AREA OF WORK ONLY

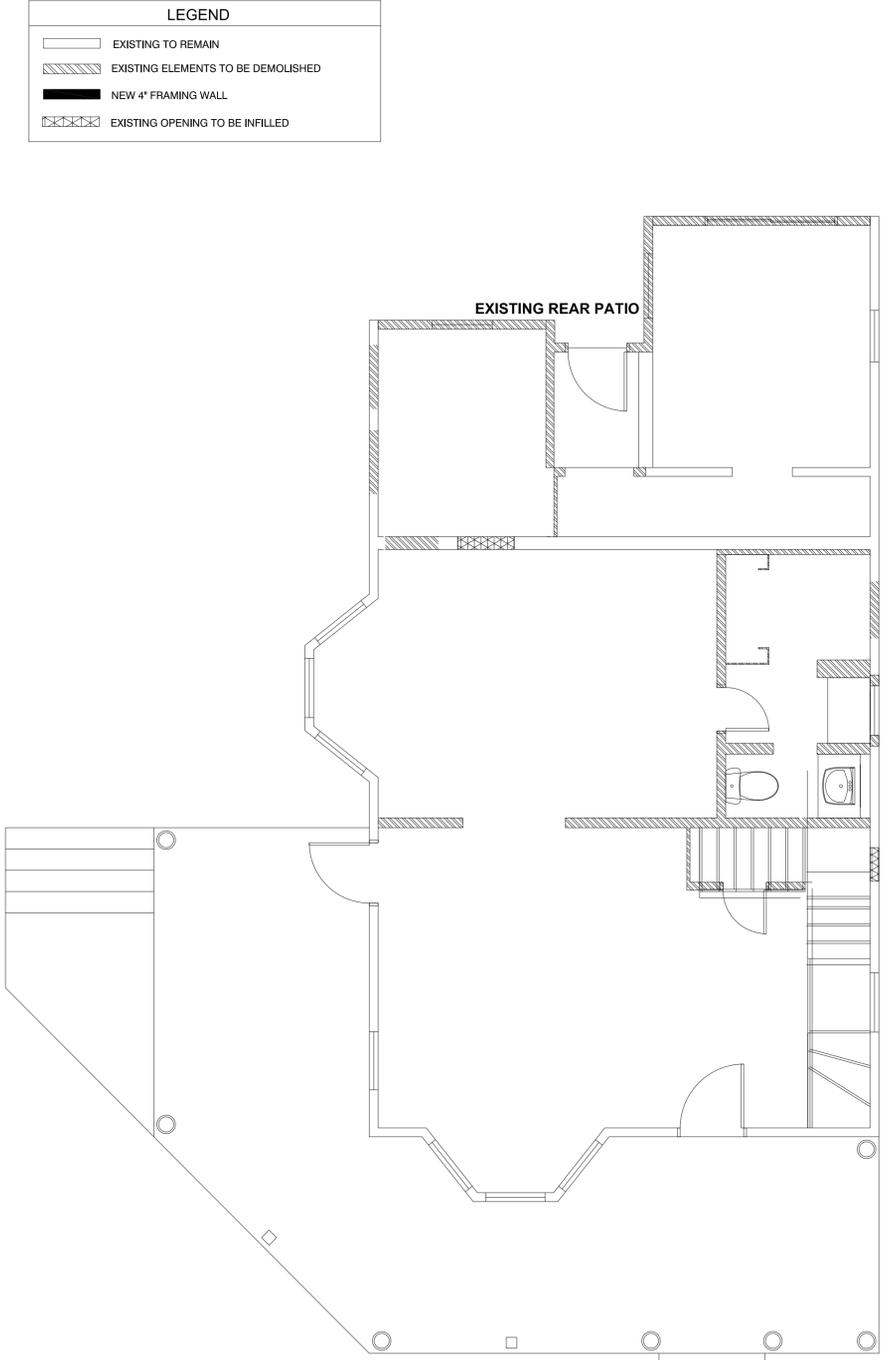

**EXISTING/DEMO 1st FLOOR PLAN**

SCALE: 1/4" = 1'-0"

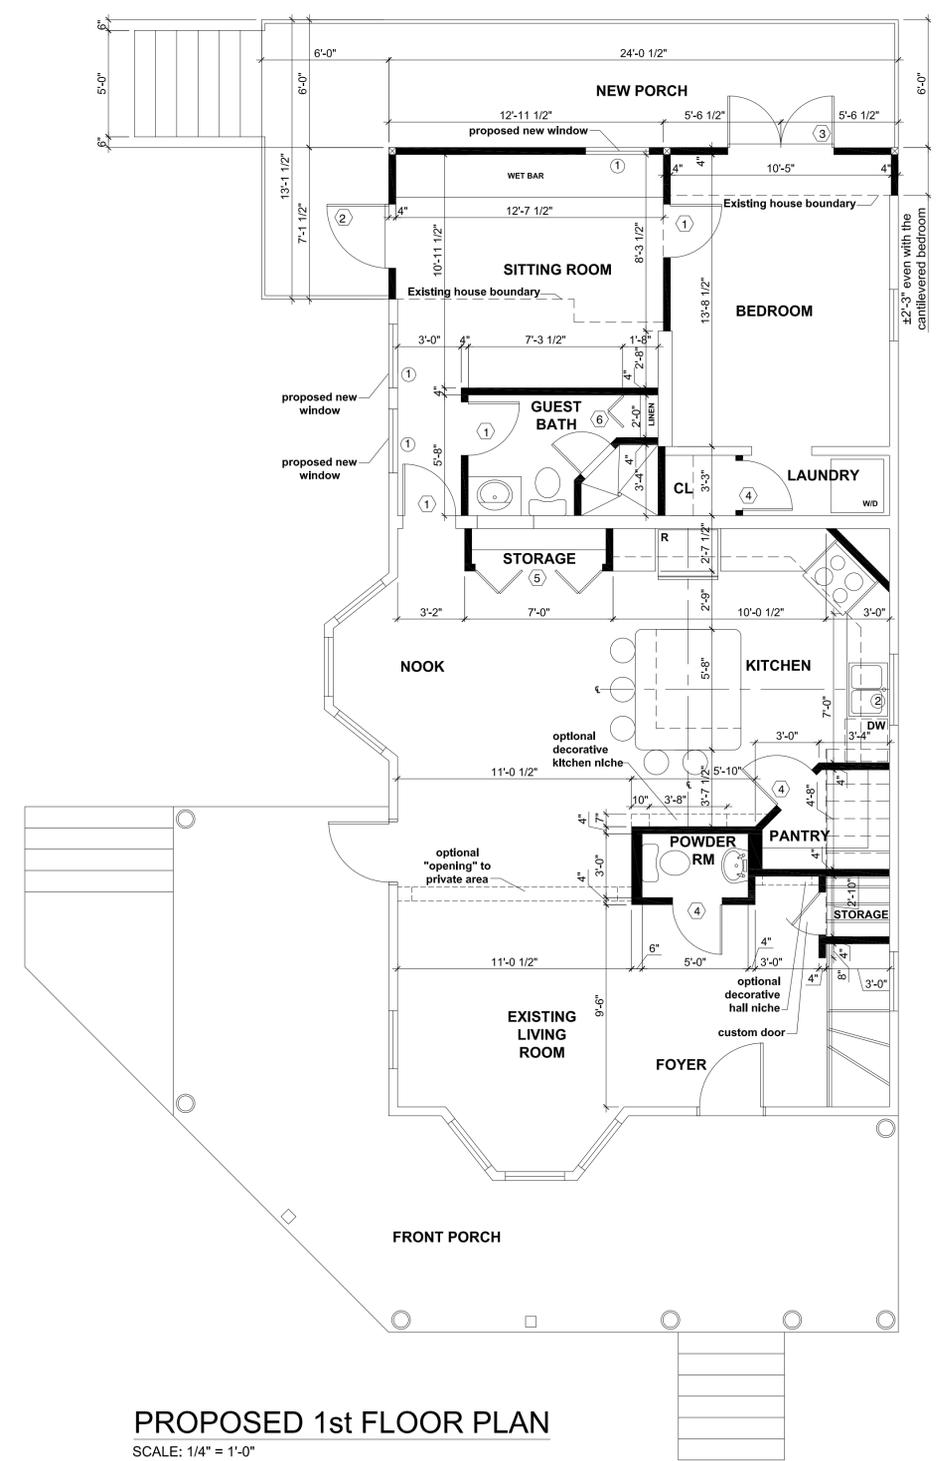

**PROPOSED 1st FLOOR PLAN**


SCALE: 1/4" = 1'-0"

REVISIONS	MARK	DESCRIPTION	DATE

**PROJECT OWNER**  
 1301 WHITEHEAD STREET  
**COMPLIANCE**  
 1301 WHITEHEAD STREET, KEY WEST, FL 33040  
 PETER JANKER EMAIL: PSJANKER@YAHOO.COM

**ARCHITECT**  
 JOHN ROBERT BARNES, RA, NCARB  
 REGISTERED ARCHITECT  
 AR-010526

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EXISTING AND PROPOSED FIRST FLOOR PLANS	
DATE PREPARED: MAY 2025	PROJECT NUMBER: JRB
DRAWN BY: JOHN ROBERT BARNES	SCALE SHOWN: AS SHOWN
CHECKED BY: JRB	LAST REVISED BY: JRB
PROJECT LOCATION: 1301 WHITEHEAD STREET, KEY WEST, FL 33040	DATE OF ISSUE: 5/23/25 (4:58PM)
DATE OF REVISION: 5/23/25 (4:58PM)	PROJECT NUMBER: JRB
PROJECT NUMBER: JRB	PROJECT NAME: 1301 WHITEHEAD STREET COMPLIANCE
PROJECT DATE: MAY 23, 2025	PROJECT TIME: 5:03 PM

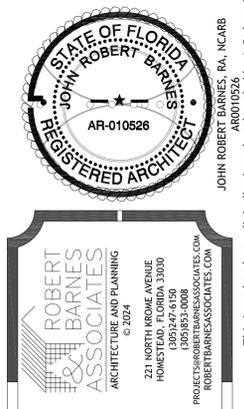**A1.0**


This item has been digitally signed and sealed by J. Robert Barnes RA on the date adjacent to the seal. Printed copies of this document are not considered valid.

WINDOW SCHEDULE			
MARK	SIZE	TYPE	PRODUCT APPROVAL
①	2'6" x 5'3"	SINGLE HUNG	SERIES SH7700A ALUMINUM SINGLE HUNG WINDOWS LMI BY PGT NOA 23-0707.10 EXP = 08-23-28 DESIGN PRESSURES +65 PSF and -80 PSF
②	3'0" x 3'4"	SINGLE HUNG	


DOOR SCHEDULE			
MARK	SIZE	TYPE	PRODUCT APPROVAL
①	2'6" x 6'8"	WOOD SWING DOOR	SERIES EWD OUTSWING OPAQUE WOOD DOOR- L.M. LARGE AND SMALL MISSILE IMPACT BY EXCLUSIVE WOOD DOORS INC. NOA 23-1024.04 EXP = 08-11-26 DESIGN PRESSURES +70 PSF and -70 PSF
②	3'0" x 6'8"	WOOD PANEL DOOR	
③	5'0" x 6'8"	DOUBLE FRENCH DOOR	SERIES FD5555 OUTSWING PVC FRENCH DOORS W/WO SIDE LITES & TRANSOM LMI BY PGT NOA 23-0717.01 EXP = 01-23-29 DESIGN PRESSURES +70 PSF and -70 PSF
④	2'4" x 6'8"	WOOD SWING DOOR	
⑤	2-3'0" x 6'8"	BI-FOLD DOOR	
⑥	2'0" x 6'8"	BI-FOLD DOOR	
⑦	2-2'0" x 6'8"	BI-FOLD DOOR	
⑧	2-2'6" x 6'8"	BI-FOLD DOOR	

LEGEND	
	EXISTING TO REMAIN
	EXISTING ELEMENTS TO BE DEMOLISHED
	NEW 4" FRAMING WALL
	EXISTING OPENING TO BE INFILLED

EXISTING DIMENSIONS TO BE FIELD VERIFIED BY CONTRACTOR

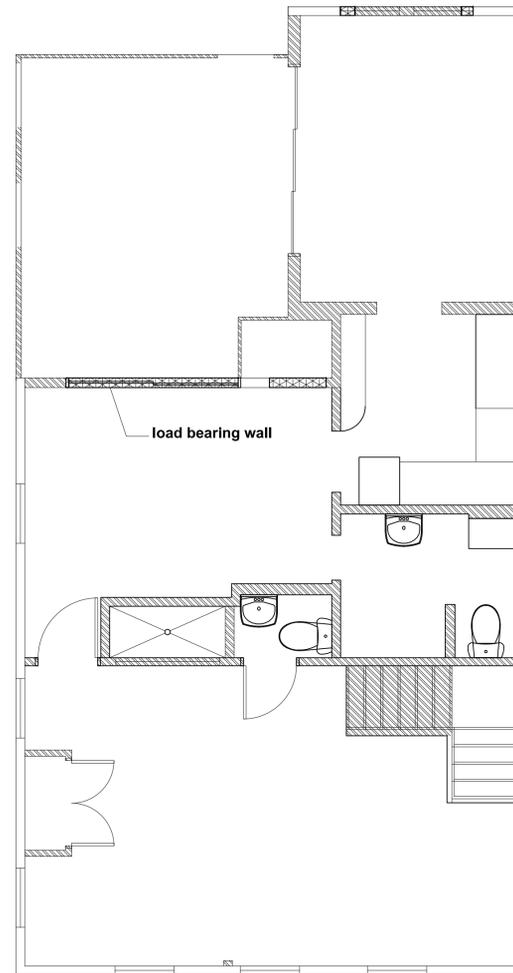


**EXISTING/DEMO 2nd FLOOR PLAN**  
SCALE: 1/4" = 1'-0"

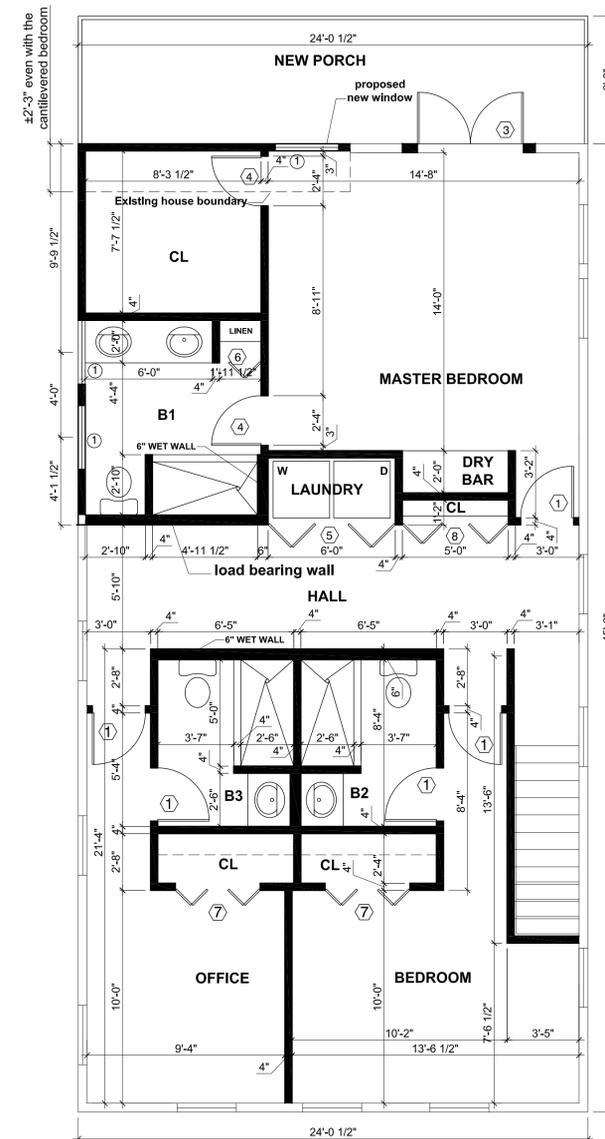

**PROPOSED 2nd FLOOR PLAN**  
SCALE: 1/4" = 1'-0"

REVISIONS	MARK	DESCRIPTION	DATE

**1301 WHITEHEAD STREET COMPLIANCE**  
PROJECT OWNER  
FOR RECORD  
1301 WHITEHEAD STREET, KEY WEST, FL 33040  
PROJECT NO.  
PETER JANKER EMAIL: PSJANKER@YAHOO.COM  
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FORT LAUDERDALE, FL 33304  
(305) 983-0008  
ROBERTBARNESASSOCIATES.COM

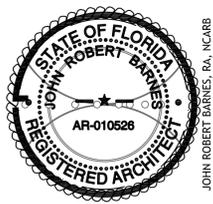EXISTING AND PROPOSED SECOND FLOOR PLANS	
DATE: 05/23/2025	SCALE: AS SHOWN
DRAWN BY: JRB	CHECKED BY: JRB
PROJECT NUMBER: 1301WHITEHEAD-018-PLANS-FEB2025-FORRECORD.DWG	DATE PLOTTED: 5/23/25 (5:28PM)
PROJECT LOCATION: 1301 WHITEHEAD STREET, KEY WEST, FL 33040	PROJECT NO: 2025
DATE PLOTTED: May 23, 2025	TIME PLOTTED: 5:32 PM

**A2.0**

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Existing Front Elevation




Proposed Front Elevation

EXISTING DIMENSIONS TO BE FIELD VERIFIED BY CONTRACTOR



Existing Rear Elevation

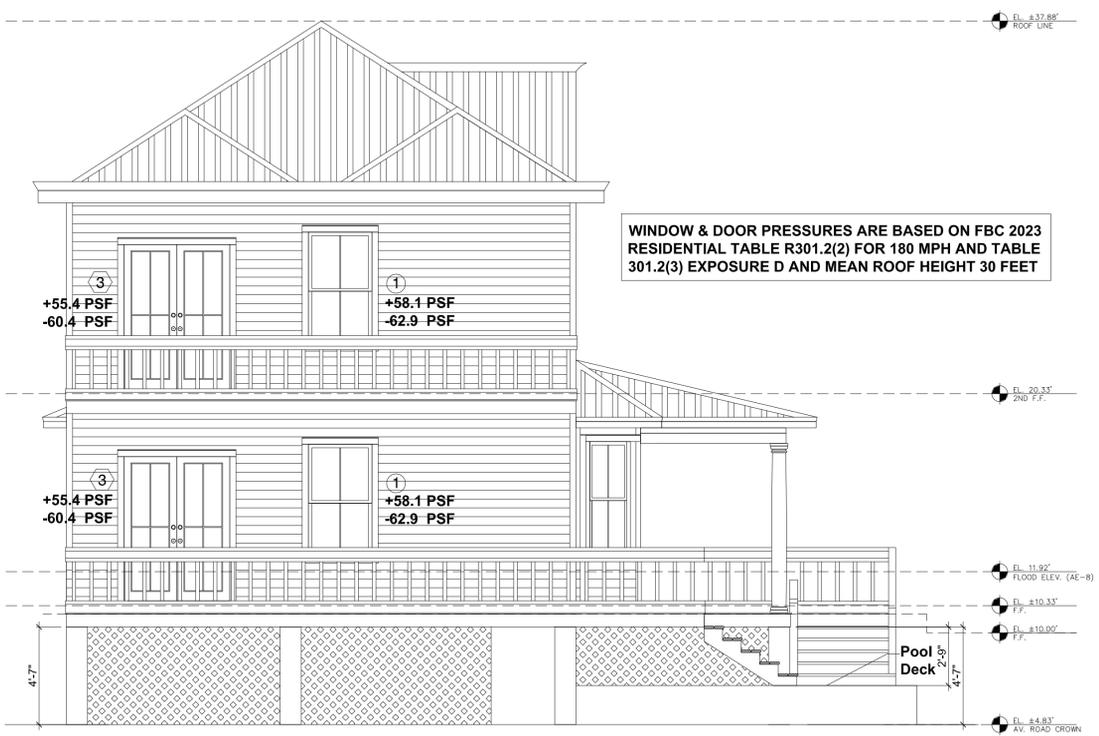

Proposed Rear Elevation

WINDOW & DOOR PRESSURES ARE BASED ON FBC 2023 RESIDENTIAL TABLE R301.2(2) FOR 180 MPH AND TABLE 301.2(3) EXPOSURE D AND MEAN ROOF HEIGHT 30 FEET

REVISIONS	MARK	DESCRIPTION	DATE


**1301 WHITEHEAD STREET COMPLIANCE**

PROJECT OWNER  
1301 WHITEHEAD STREET, KEY WEST, FL 33040

ARCHITECT  
JOHN ROBERT BARNES, RA, NCARB  
REGISTERED ARCHITECT  
AR-010526

PROJECT EMAIL: PSJANKER@YAHOO.COM

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KEY WEST, FL 33040  
PHONE: (305) 247-4150  
FAX: (305) 247-4150  
PROJECT: 1301 WHITEHEAD STREET COMPLIANCE  
ROBERTBARNESASSOCIATES.COM

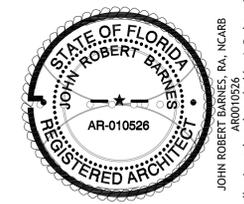EXISTING AND PROPOSED FRONT & REAR ELEVATIONS		DATE	SCALE	PROJECT NUMBER	PROJECT NAME	DATE	SCALE	PROJECT NUMBER	PROJECT NAME
DATE CHANGED	SCALE SHOWN	DATE	SCALE	PROJECT NUMBER	PROJECT NAME	DATE	SCALE	PROJECT NUMBER	PROJECT NAME
05/23/2025	JRB	05/23/2025	JRB	1301 WHITEHEAD-018-PLANS-FEB2025-FOR-ENG.DWG	1301 WHITEHEAD STREET COMPLIANCE	05/23/2025	JRB	1301 WHITEHEAD-018-PLANS-FEB2025-FOR-ENG.DWG	1301 WHITEHEAD STREET COMPLIANCE
DESIGNED BY	DRAWN BY	CHECKED BY	DATE	SCALE	PROJECT NUMBER	PROJECT NAME	DATE	SCALE	PROJECT NUMBER
JOHN ROBERT BARNES	JRB	JRB	05/23/2025	JRB	1301 WHITEHEAD-018-PLANS-FEB2025-FOR-ENG.DWG	1301 WHITEHEAD STREET COMPLIANCE	05/23/2025	JRB	1301 WHITEHEAD-018-PLANS-FEB2025-FOR-ENG.DWG
DATE	SCALE	PROJECT NUMBER	PROJECT NAME	DATE	SCALE	PROJECT NUMBER	PROJECT NAME	DATE	SCALE
05/23/2025	JRB	05/23/2025	JRB	1301 WHITEHEAD-018-PLANS-FEB2025-FOR-ENG.DWG	1301 WHITEHEAD STREET COMPLIANCE	05/23/2025	JRB	1301 WHITEHEAD-018-PLANS-FEB2025-FOR-ENG.DWG	1301 WHITEHEAD STREET COMPLIANCE

**A3.0**

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Existing Right Side Elevation



Proposed Right Side Elevation

EXISTING DIMENSIONS TO BE FIELD VERIFIED BY CONTRACTOR


REVISIONS	MARK	DESCRIPTION	DATE

PROJECT / OWNER  
**1301 WHITEHEAD STREET COMPLIANCE**

JOB ADDRESS  
**1301 WHITEHEAD STREET, KEY WEST, FL 33040**

CONTACT / ARCHITECT  
**PETER JANKER EMAIL: PSJANKER@YAHOO.COM**

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EXISTING AND PROPOSED RIGHT SIDE ELEVATION		PROJECT / OWNER	
DATE CHANGED	SCALE SHOWN	DRAWN BY	LAST VALID BY
May 23, 2025	JRB	JRB	JRB
PROJECT NUMBER	PROJECT NAME	DATE SUBMITTED	POST TIME
1301WHITEHEAD-018-PLANS-FEB2025-FORRENG.DWG	1301 WHITEHEAD-018-PLANS-FEB2025-FORRENG.DWG	5/23/25 4:58PM	5:05 PM
DATE SUBMITTED	PROJECT NAME	DATE CHANGED	POST TIME
May 23, 2025	1301 WHITEHEAD-018-PLANS-FEB2025-FORRENG.DWG	5/23/25 4:58PM	5:05 PM

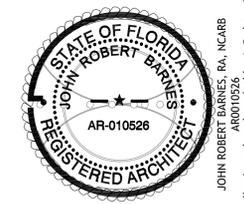DRAWING NUMBER  
**A4.0**

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Existing Left Side (United St.) Elevation



Proposed Left Side (United St.) Elevation


REVISIONS	MARK	DESCRIPTION	DATE

**PROJECT OWNER**  
**1301 WHITEHEAD STREET COMPLIANCE**

**JOB ADDRESS**  
**1301 WHITEHEAD STREET, KEY WEST, FL 33040**

**CONTACT INFO**  
**PETER JANKER EMAIL: PSJANKER@YAHOO.COM**

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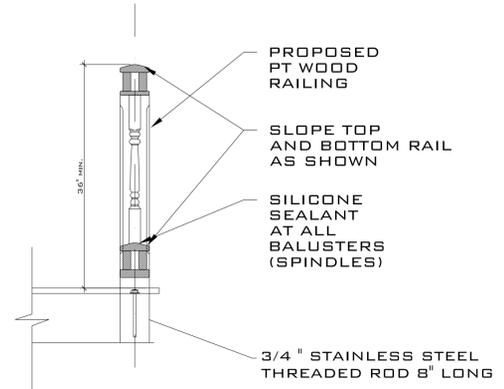
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 FORT MONROE, FLORIDA 33050  
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 (305) 983-0008  
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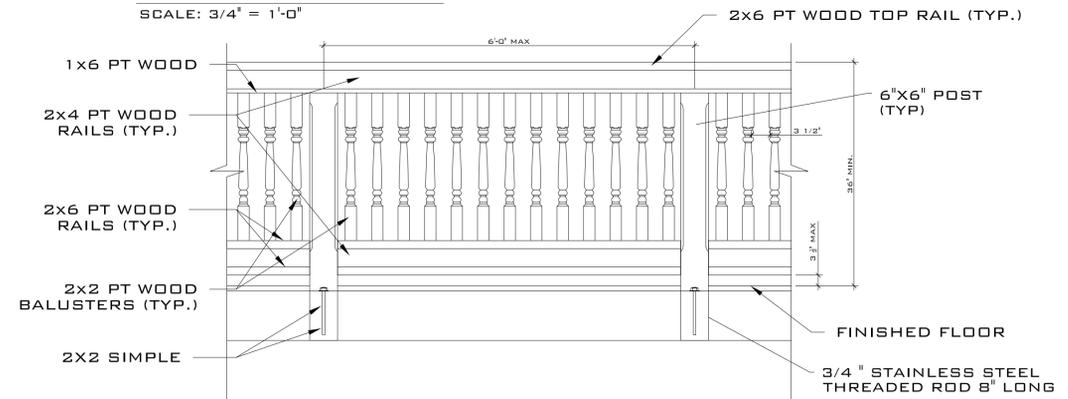
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DATE CHANGED	PROJECT NUMBER	SCALE	DATE SHOWN	DATE	PROJECT NAME
05/23/2025	1301 WHITEHEAD-018-PLANS-FEB2025-FOREING.DWG	AS SHOWN	JRB	5/23/25 (4:58PM)	1301 WHITEHEAD-018-PLANS-FEB2025-FOREING.DWG
DRAWN BY	CHECKED BY	DATE	DATE	DATE	DATE
JOHN ROBERT BARNES	JRB	5/23/25	5/23/25	5/23/25	5/23/25
DATE	DATE	DATE	DATE	DATE	DATE
05/23/25	05/23/25	05/23/25	05/23/25	05/23/25	05/23/25

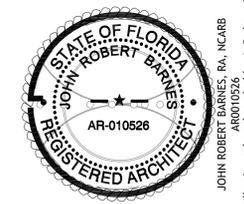**A5.0**

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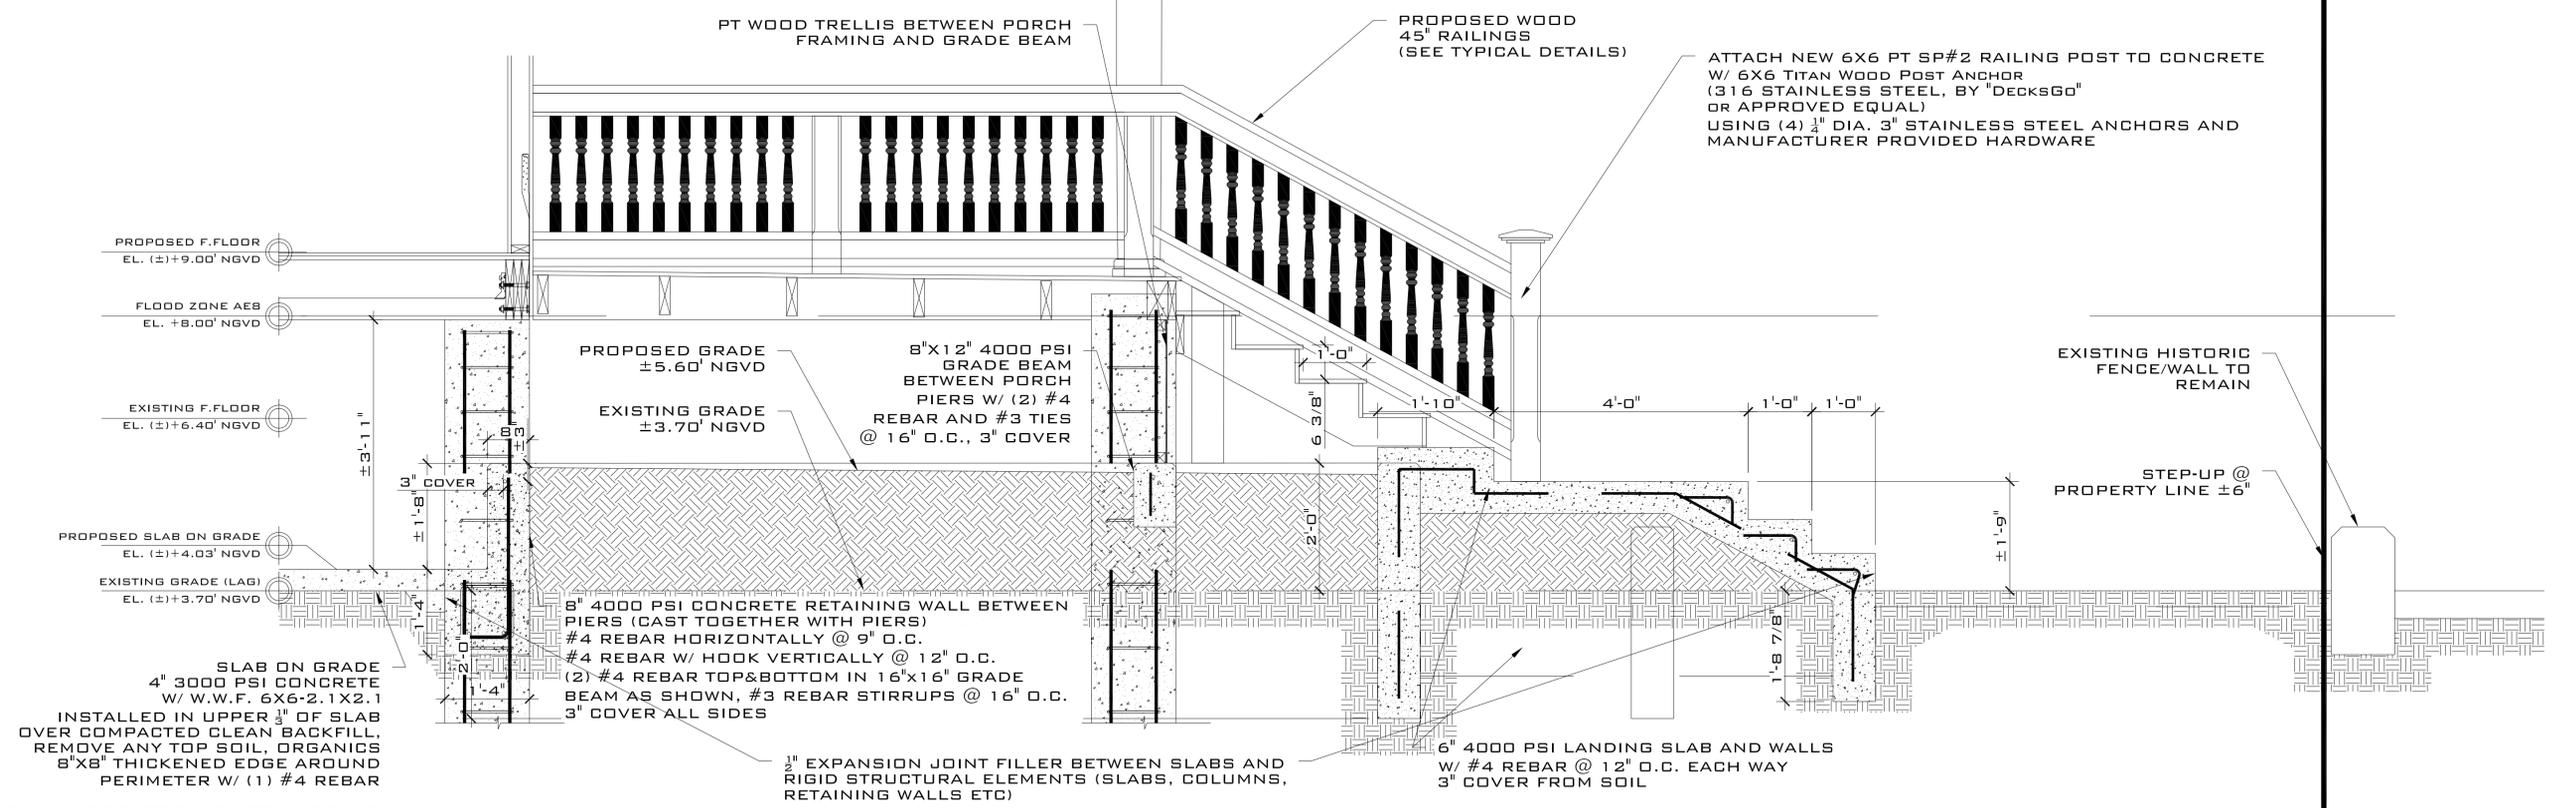
**TYPICAL WOOD RAILING SECTION**  
SCALE: 3/4" = 1'-0"



**TYPICAL WOOD RAILING**  
SCALE: 3/4" = 1'-0"




**DETAIL - RAILING ATTACHED TO COLUMNS**  
N.T.S.



**SECTION 1-1**  
SCALE: 3/4" = 1'-0"

REVISIONS	MARK	DESCRIPTION	DATE

**1301 WHITEHEAD STREET COMPLIANCE**  
PROJECT NUMBER  
JOB ADDRESS  
**1301 WHITEHEAD STREET, KEY WEST, FL 33040**  
JOB NUMBER  
**PETER JANKER EMAIL: PSJANKER@YAHOO.COM**  
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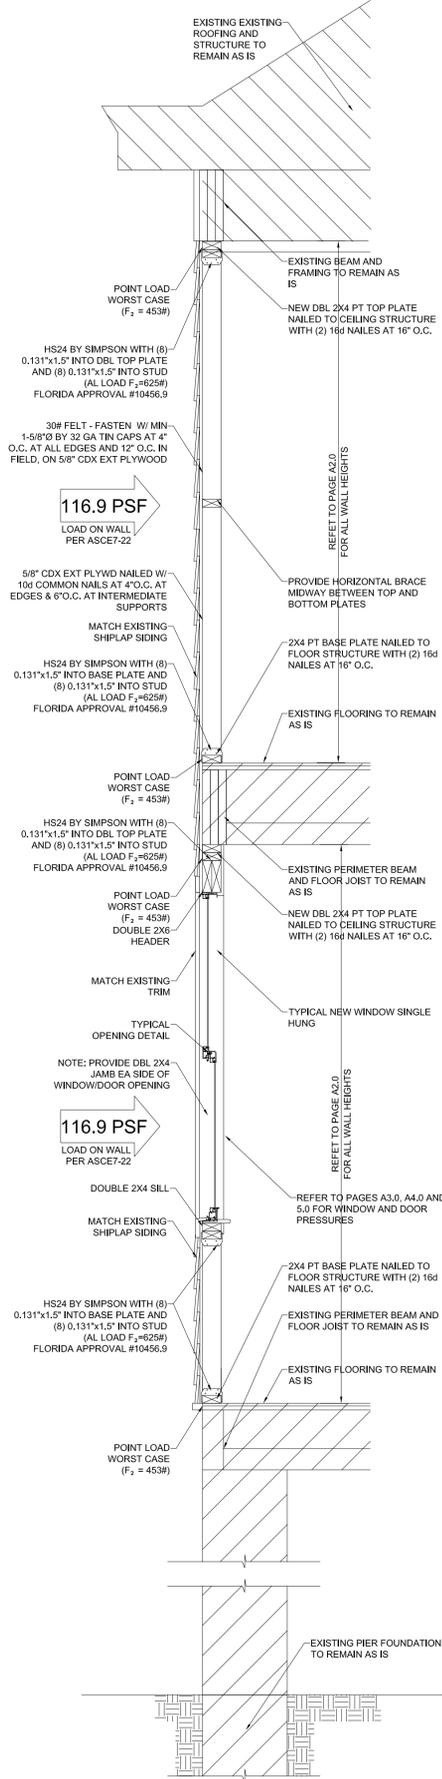
**ROBERT BARNES ASSOCIATES**  
ARCHITECTURE AND PLANNING  
221 NORTH BREVARD AVENUE  
FORT LAUDERDALE, FL 33304  
(305) 983-0088  
PROJECT NUMBER: 1301 WHITEHEAD STREET COMPLIANCE  
ROBERTBARNESASSOCIATES.COM

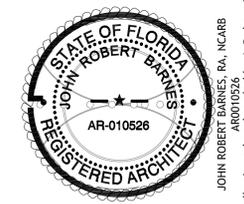DRAWING TITLE		PROJECT NUMBER		JOB NUMBER		JOB DATE	
<b>RAILING DETAILS</b>		1301 WHITEHEAD STREET COMPLIANCE		1301 WHITEHEAD STREET COMPLIANCE		MAY 23, 2025	
DATE ISSUED	SCALE	DRAWN BY	CHECKED BY	DATE PLOTTED	SCALE	DATE PLOTTED	SCALE
MAY 23, 2025	AS SHOWN	JRB	JRB	5/23/25 (4:58PM)	AS SHOWN	5/23/25 (4:58PM)	AS SHOWN
DRAWING NUMBER		PROJECT NUMBER		JOB NUMBER		JOB DATE	
<b>A6.0</b>		1301 WHITEHEAD STREET COMPLIANCE		1301 WHITEHEAD STREET COMPLIANCE		MAY 23, 2025	

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Typical Wall Section  
SC. 3/4" = 1' - 0"

Wind Loads - Components & Cladding : h ≤ 60'

Roof		GCP +/- GCP				Surface Pressure (psf)				User input	
Area	10 sf	50 sf	100 sf	500 sf	10 sf	50 sf	100 sf	500 sf	Design	80 sf	200 sf
Negative Zone 1	-1.60	-1.15	-0.95	-0.85	-128.3	-92.8	-77.2	-77.2	-87.2	-82.2	-77.2
Negative Zone 2	-2.14	-1.44	-1.14	-1.14	-172.1	-116.9	-91.8	-91.8	-101.9	-96.8	-91.8
Negative Zone 3	-2.25	-1.50	-1.18	-1.18	-180.9	-120.7	-94.8	-94.8	-103.1	-98.0	-93.0
Positive All Zones	0.88	0.60	0.48	0.48	70.7	48.2	38.5	38.5	41.7	38.5	38.5
Overhang Zone 3 @zone 4	-3.17	-2.30	-1.92	-1.80	-254.7	-169.9	-144.4	-144.4	-164.2	-159.2	-154.2
Overhang Zone 3 @zone 5	-3.47	-2.48	-2.05	-1.80	-278.8	-188.8	-164.4	-164.4	-175.4	-170.4	-165.4

Wind Loads - Components & Cladding : h ≤ 60'

Walls		GCP +/- GCP				Surface Pressure at h				User input	
Area	10 sf	50 sf	100 sf	500 sf	10 sf	50 sf	100 sf	500 sf	Design	80 sf	200 sf
Negative Zone 4	-1.28	-1.10	-1.05	-0.98	-102.8	-88.9	-84.3	-78.7	-92.5	-86.6	-84.3
Negative Zone 5	-1.58	-1.23	-1.12	-0.98	-128.9	-98.5	-90.0	-78.7	-115.9	-98.5	-90.0
Positive Zone 4 & 5	1.18	1.00	0.95	0.88	94.8	80.8	75.3	70.7	84.8	80.8	75.3

**LUMBER AND FRAMING**  
FRAMING LUMBER SHALL CONFORM WITH THE PROVISIONS OF THE AMERICAN SOFTWOOD LUMBER STANDARD PS-20 (LATEST EDITION) AND EACH PIECE SHALL BEAR THE GRADE STAMP OF AN APPROVED GRADING AGENCY

FRAMING LUMBER GRADES: THE FOLLOWING GRADES SHALL BE THE MINIMUM ACCEPTABLE GRADES, UNLESS OTHERWISE NOTED ON THE DRAWINGS.

ITEM	MIN GRADE
STUD ONLY: 2" TO 4" THICK; 2" TO 4" WIDE ...	NO. 2 SOUTHERN PINE
STRUCTURAL LIGHT FRAMING: 2" TO 4" THICK; 2" TO 4" WIDE ...	NO. 2 SOUTHERN PINE
STRUCTURAL JOISTS & HEADERS: 2" TO 4" THICK; 6" AND WIDER ...	NO. 2 SOUTHERN PINE
POSTS: 4"x4" AND LARGER ...	NO. 2 SOUTHERN PINE OR NO. 2 DOUGLAS FIR

BOLT HOLES SHALL BE 1/16" LARGER THAN THE BOLT SIZE. RE-TIGHTEN ALL NUTS PRIOR TO CLOSING IN. STANDARD CUT WASHERS SHALL BE USED UNDER BOLT HEADS AND NUTS AGAINST WOOD.

ALL LUMBER IN CONTACT WITH MASONRY OR CONCRETE SHALL BE PRESSURE TREATED OR OTHERWISE BE PROTECTED BY AN APPROVED SEPARATING MATERIAL. BOLTS SHALL BE PLACED 9" FROM ANY NOTCH GREATER THAN 1/2 THE WIDTH OF A MEMBER.


DO NOT NOTCH JOISTS, RAFTERS OR BEAMS. OBTAIN ENGINEER'S OR ARCHITECT'S APPROVAL FOR ANY HOLES OR NOTCHES NOT DETAILED. HOLES THROUGH SILLS, PLATES, STUDS AND DOUBLE PLATED IN INTERIOR BEARING AND SHEAR WALLS SHALL NOT EXCEED 1/3 THE PLATE WIDTH. USE BORED HOLES LOCATED IN THE CENTER OF THE STUD OR PLATE.

2" SOLID BLOCKING SHALL BE PLACED BETWEEN JOISTS OR RAFTERS AT ALL SUPPORTS.

ALL NAILING SHALL CONFORM TO THE MINIMUM STANDARDS OF THE INTERNATIONAL BUILDING CODE OR THE 2023 FLORIDA BUILDING CODE.

ALL NAILS AND SCREWS SHALL BE STAINLESS STEEL OR GALVANIZED PER FEMA BULLETIN 2-08 REQUIREMENTS.

ALL LUMBER AND FRAMING WORK AT BELOW FLOOD ELEVATIONS SHALL BE IN ACCORDANCE WITH FEMA 2-08 AND NFIP AND ASCE 24 AND IRC. MINIMUM FRAMING LUMBER SHALL BE CLASS V PRESERVATIVE-TREATED BORATE AND ALL PLYWOOD USED SHALL BE MARINE GRADE.

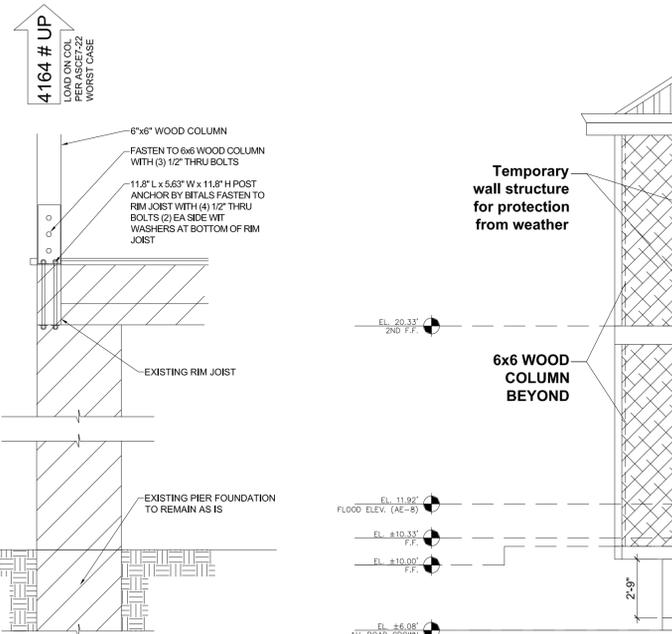

Typ Column Connection  
SC. 3/4" = 1' - 0"



Weather Enclosure - Front Side Elevation (Remains the same)  
SC. 1/4" = 1' - 0"

THIS PAGE FOR WEATHER PROOFING WALLS ONLY. SEE SHEETS A3.0, A4.0 AND A5.0 FOR PROPOSED AND EXISTING ELEVATIONS



Weather Enclosure - Left Side Elevation  
SC. 1/4" = 1' - 0"

REVISIONS

DATE	DESCRIPTION

1301 WHITEHEAD STREET  
COMPLIANCE

1301 WHITEHEAD STREET, KEY WEST, FL 33040  
CONTACT: PSJANKER@YAHOO.COM


STATE OF FLORIDA  
JOHN ROBERT BARNES  
REGISTERED ARCHITECT  
AR-010526

ROBERT BARNES & ASSOCIATES  
ARCHITECTURE AND PLANNING  
721 NORTH ROOME AVENUE  
HOMESTEAD, FLORIDA 33009  
(305) 947-4150  
PROJECT: 1301 WHITEHEAD STREET COMPLIANCE  
DATE: MAY 27, 2025

WEATHER ENCLOSURE  
ELEVATIONS & SECTION

A8.0

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**Weather Enclosure - Rear Side Elevation**  
 SC. 1/4" = 1' - 0"

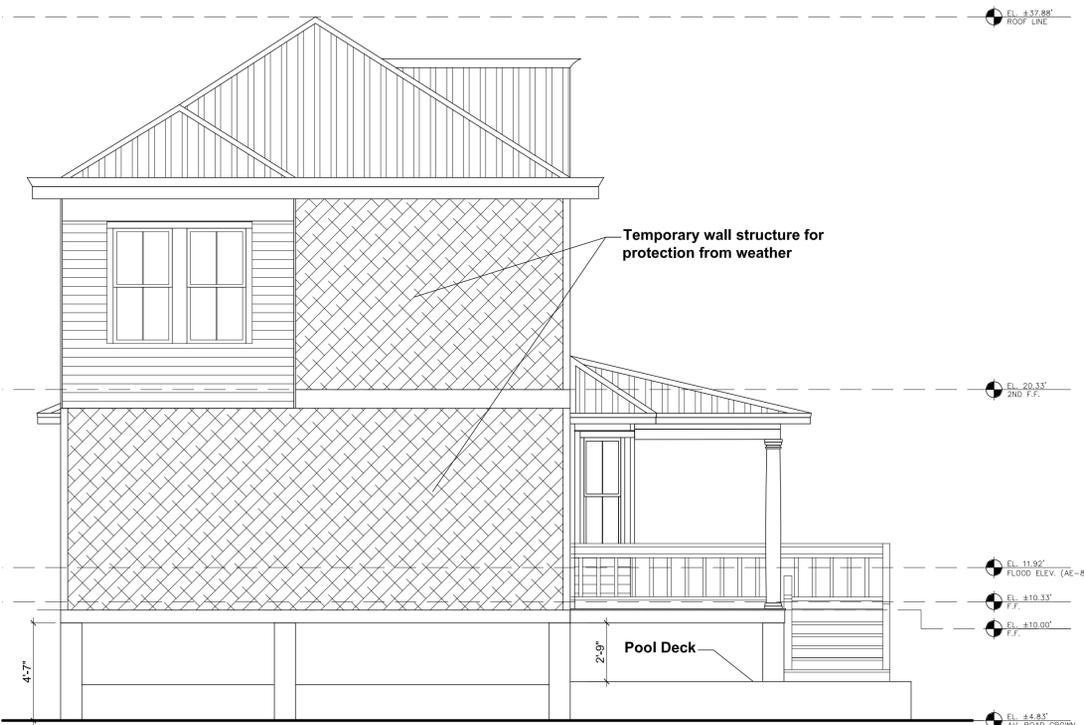THIS PAGE FOR WEATHER PROOFING WALLS ONLY.  
 SEE SHEETS A3.0, A4.0 AND A5.0 FOR PROPOSED  
 AND EXISTING ELEVATIONS



**Weather Enclosure - Right Side Elevation**  
 SC. 1/4" = 1' - 0"

EXISTING DIMENSIONS TO BE FIELD  
 VERIFIED BY CONTRACTOR


REVISIONS	MARK	DESCRIPTION	DATE

**1301 WHITEHEAD STREET COMPLIANCE**

PROJECT OWNER: 1301 WHITEHEAD STREET, KEY WEST, FL 33040

ARCHITECT: PETER JANKER EMAIL: PSJANKER@YAHOO.COM

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 HOMESTEAD, FLORIDA 33090  
 (305) 947-6150  
 PROJECTS@ROBERTBARNESASSOCIATES.COM  
 ROBERTBARNESASSOCIATES.COM

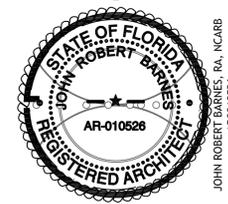
<b>WEATHER ENCLOSURE ELEVATIONS CONTINUED</b>		PROJECT NUMBER: JRB	DATE: MAY 23, 2025
DATE: APRIL 2025	PROJECT NAME: ROBERT BARNES	DESIGNED BY: AS SHOWN	LAST REVISED BY: JRB
REVISION: RB0404202501	PROJECT: 1301 WHITEHEAD STREET COMPLIANCE	CREATED: JRB	DATE: MAY 23, 2025
REVISION: CUISERS@DANADESKTOP1301	PROJECT: 1301 WHITEHEAD STREET COMPLIANCE	CREATED: JRB	DATE: MAY 23, 2025
REVISION: JRB	PROJECT: 1301 WHITEHEAD STREET COMPLIANCE	CREATED: JRB	DATE: MAY 23, 2025

DRAWING NUMBER: **A9.0**

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PLANS SUBMITTED ON JUNE 12, 2024


<b>SITE DATA:</b>	
TOTAL SITE AREA:	5,250.00 SQ FT
LAND USE:	HD09
FLOOD ZONE:	AEB
<b>MAXIMUM IMPERVIOUS SURFACE E RATIO:</b>	
REQUIRED	60% (3,150.00 SQ FT)
EXISTING	47.80% (±2,509.4 SQ FT)
PROPOSED	48.66% (±2,554.4 SQ FT)
<b>MAXIMUM BUILDING COVERAGE:</b>	
REQUIRED	50% (2,625.00 SQ FT)
EXISTING	39.45% (±2,071.2 SQ FT)
PROPOSED	40.30% (±2,116.2 SQ FT)
<b>OPEN SPACE MINIMUM:</b>	
REQUIRED	35% (1,837.50 SQ FT)
EXISTING	48.31% (±2,431.5 SQ FT)
PROPOSED	45.45% (±2,386.5 SQ FT)
<b>SETBACKS:</b>	
<b>FRONT:</b>	
REQUIRED	10'-0"
EXISTING	±16.4'
<b>STREET SIDE:</b>	
REQUIRED	5'-0"
EXISTING	±11'-0"
<b>SIDE:</b>	
REQUIRED	5'-0"
EXISTING	3'-0" TO 5'-0"
<b>REAR:</b>	
REQUIRED	20'-0"
EXISTING	24'-6"
PROPOSED	20'-2"
<b>MAXIMUM HEIGHT:</b>	
EXISTING	30 FT
	±33'-0" (TO CROWN OF ROAD)

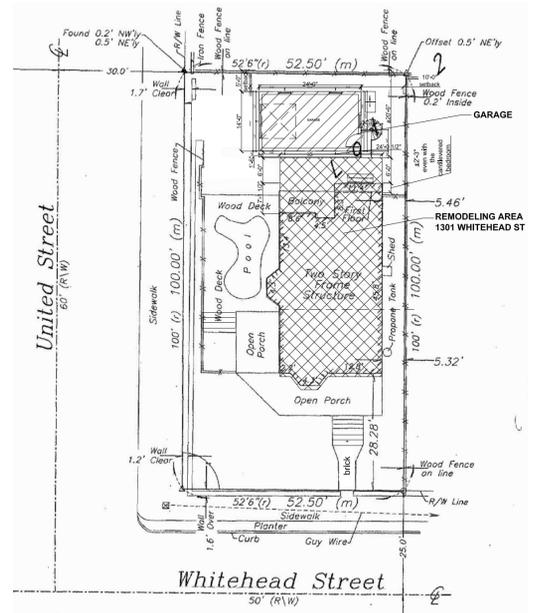


**PLOT PLAN (NOT A SURVEY)**  
SCALE: 1" = 20'-0"

THIS PLAN TO SHOW THE AREA OF WORK ONLY

LEGEND	
	EXISTING TO REMAIN
	EXISTING ELEMENTS TO BE DEMOLISHED
	NEW 4' FRAMING WALL
	EXISTING OPENING TO BE INFILLED

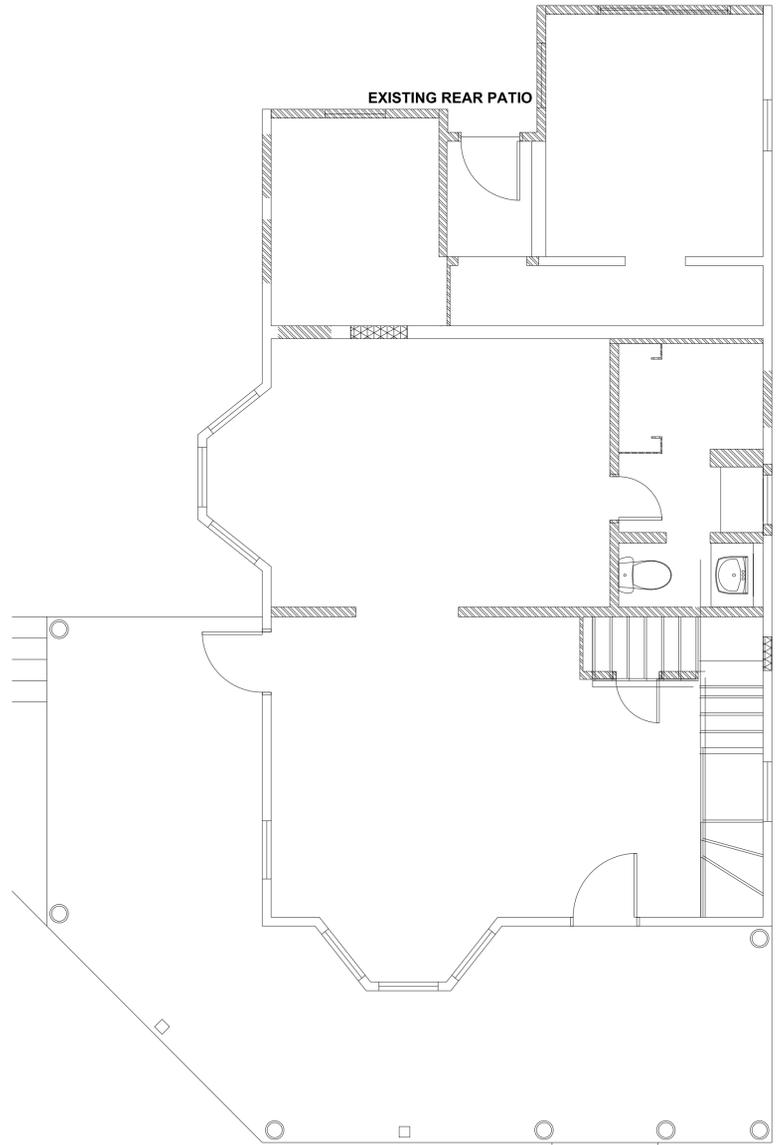


**EXISTING/DEMO 1st FLOOR PLAN**  
SCALE: 1/4" = 1'-0"

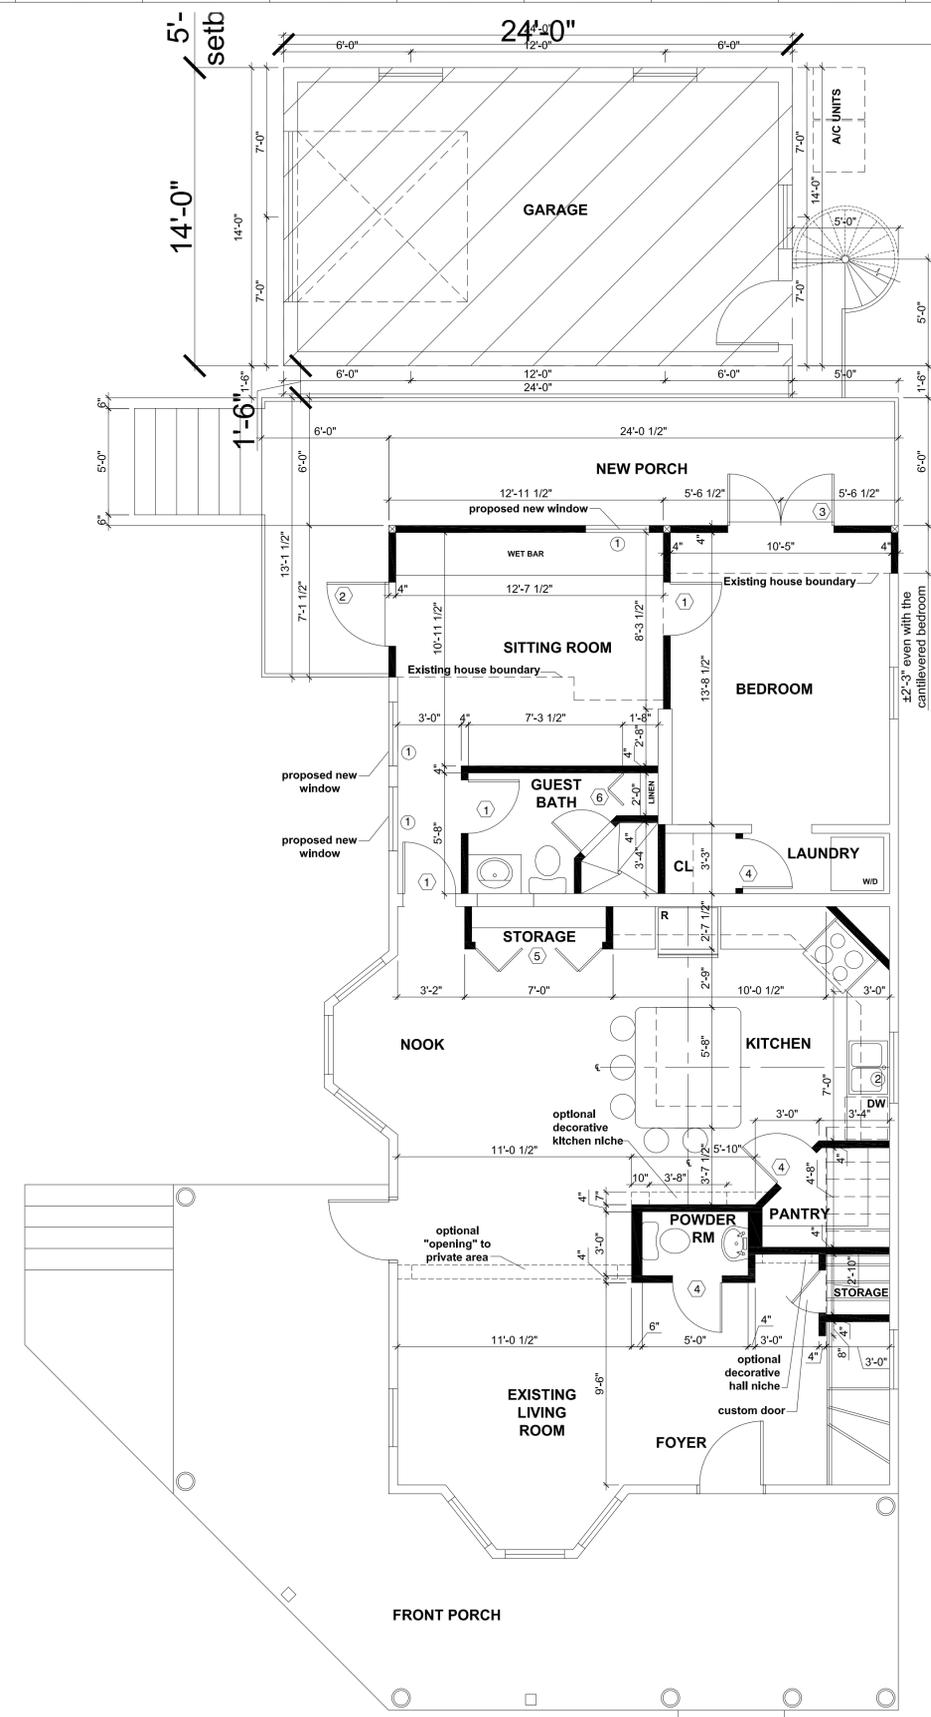

**PROPOSED 1st FLOOR PLAN**  
SCALE: 1/4" = 1'-0"

REVISIONS	MARK	DESCRIPTION	DATE

**1301 WHITEHEAD STREET COMPLIANCE**  
PROJECT NUMBER: 1301 WHITEHEAD STREET, KEY WEST, FL 33040  
FOR ADDRESS: 1301 WHITEHEAD STREET, KEY WEST, FL 33040  
PROJECT OWNER: PETER JANKER EMAIL: PSJANKER@YAHOO.COM  
ARCHITECT: JOHN ROBERT BARNES, REGISTERED ARCHITECT, AR-010526  
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ARCHITECTURE AND PLANNING  
221 NORTH REDON AVENUE  
FORT MYERS, FL 33901  
(305) 883-0088  
ROBERTBARNESASSOCIATES.COM
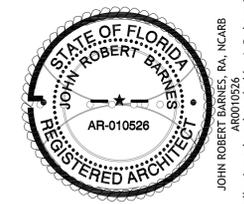
<b>EXISTING AND PROPOSED FIRST FLOOR PLANS</b>	
DATE: 06/12/2025	SCALE: AS SHOWN
DRAWN BY: JRB	LAST REVISED BY: JRB
CHECKED BY: JRB	DATE: 06/12/2025
PROJECT NUMBER: 1301 WHITEHEAD-018-PLANS-FE2025-FOR-ENG.DWG	DATE: 06/12/2025
PROJECT NAME: 1301 WHITEHEAD-018-PLANS-FE2025-FOR-ENG.DWG	DATE: 06/12/2025
PROJECT LOCATION: 1301 WHITEHEAD STREET, KEY WEST, FL 33040	DATE: 06/12/2025
PROJECT OWNER: PETER JANKER	DATE: 06/12/2025
PROJECT NUMBER: 1301 WHITEHEAD-018-PLANS-FE2025-FOR-ENG.DWG	DATE: 06/12/2025
PROJECT NAME: 1301 WHITEHEAD-018-PLANS-FE2025-FOR-ENG.DWG	DATE: 06/12/2025
PROJECT LOCATION: 1301 WHITEHEAD STREET, KEY WEST, FL 33040	DATE: 06/12/2025
PROJECT OWNER: PETER JANKER	DATE: 06/12/2025
PROJECT NUMBER: 1301 WHITEHEAD-018-PLANS-FE2025-FOR-ENG.DWG	DATE: 06/12/2025
PROJECT NAME: 1301 WHITEHEAD-018-PLANS-FE2025-FOR-ENG.DWG	DATE: 06/12/2025
PROJECT LOCATION: 1301 WHITEHEAD STREET, KEY WEST, FL 33040	DATE: 06/12/2025
PROJECT OWNER: PETER JANKER	DATE: 06/12/2025

**A1.0**


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WINDOW SCHEDULE			
MARK	SIZE	TYPE	PRODUCT APPROVAL
①	2'6" x 5'3"	SINGLE HUNG	SERIES SH7700A ALUMINUM SINGLE HUNG WINDOWS LMI BY PGT NOA 23-0707.10 EXP = 08-23-28 DESIGN PRESSURES +65 PSF and -80 PSF
②	3'0" x 3'4"	SINGLE HUNG	


DOOR SCHEDULE			
MARK	SIZE	TYPE	PRODUCT APPROVAL
①	2'6" x 6'8"	WOOD SWING DOOR	SERIES EWD OUTSWING OPAQUE WOOD DOOR- L.M. LARGE AND SMALL MISSILE IMPACT BY EXCLUSIVE WOOD DOORS INC. NOA 23-1024.04 EXP = 08-11-26 DESIGN PRESSURES +70 PSF and -70 PSF
②	3'0" x 6'8"	WOOD PANEL DOOR	
③	5'0" x 6'8"	DOUBLE FRENCH DOOR	SERIES FD5555 OUTSWING PVC FRENCH DOORS W/WO SIDE LITES & TRANSOM LMI BY PGT NOA 23-0717.01 EXP = 01-23-29 DESIGN PRESSURES +70 PSF and -70 PSF
④	2'4" x 6'8"	WOOD SWING DOOR	
⑤	2'3'0" x 6'8"	BI-FOLD DOOR	
⑥	2'0" x 6'8"	BI-FOLD DOOR	
⑦	2'2'0" x 6'8"	BI-FOLD DOOR	
⑧	2'2'6" x 6'8"	BI-FOLD DOOR	

LEGEND	
	EXISTING TO REMAIN
	EXISTING ELEMENTS TO BE DEMOLISHED
	NEW 4" FRAMING WALL
	EXISTING OPENING TO BE INFILLED

EXISTING DIMENSIONS TO BE FIELD VERIFIED BY CONTRACTOR

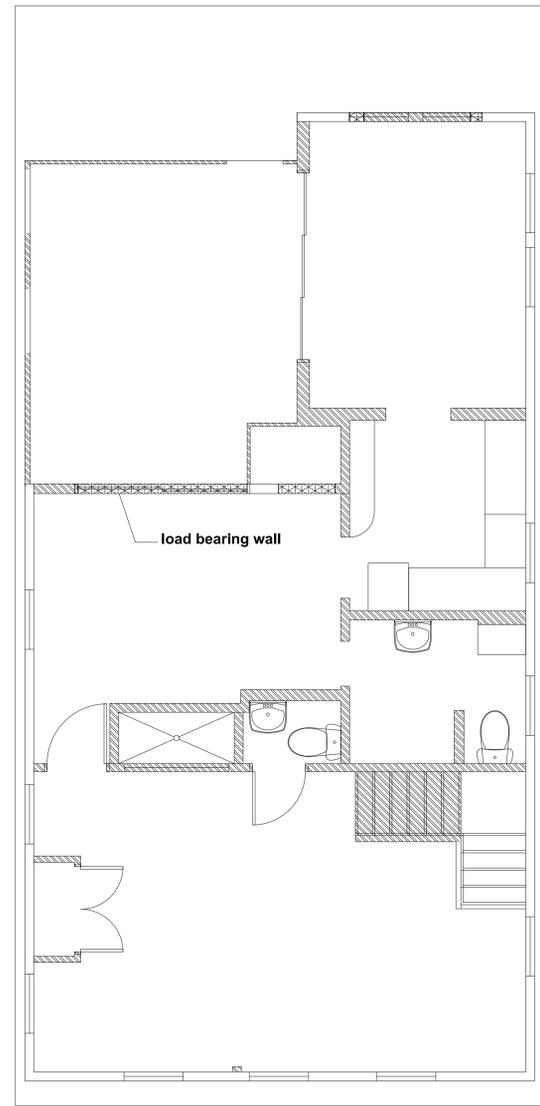


**EXISTING/DEMO 2nd FLOOR PLAN**  
SCALE: 1/4" = 1'-0"

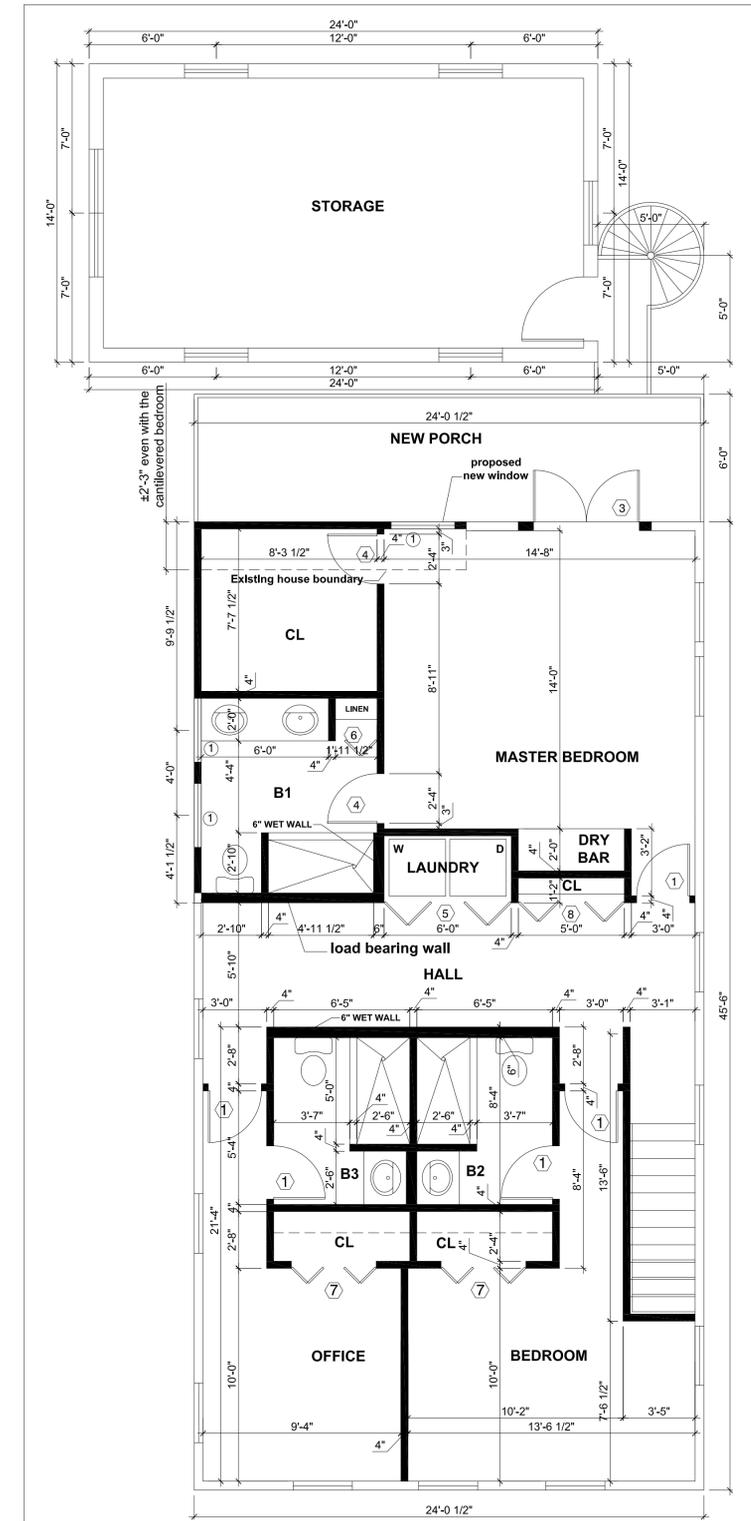

**PROPOSED 2nd FLOOR PLAN**  
SCALE: 1/4" = 1'-0"

REVISIONS	MARK	DESCRIPTION	DATE

**1301 WHITEHEAD STREET COMPLIANCE**  
PROJECT OWNER  
1301 WHITEHEAD STREET, KEY WEST, FL 33040  
FOR RECORD  
PETER JANKER EMAIL: PSJANKER@YAHOO.COM  
REGISTERED ARCHITECT  
ROBERT BARNES & ASSOCIATES, P.A.  
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21 NORTH BORDOWEN AVENUE  
FORT MYERS, FLORIDA 33901  
PHONE: (888) 696-2330  
(335) 547-6150  
FAX: (335) 883-0088  
WWW.ROBERTBARNESASSOCIATES.COM

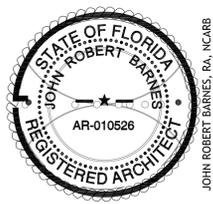EXISTING AND PROPOSED SECOND FLOOR PLANS	
DATE: 06/12/2025	PROJECT NUMBER: 1301 WHITEHEAD STREET COMPLIANCE
DRAWN BY: JRB	CHECKED BY: JRB
DATE: 06/12/2025	DATE: 06/12/2025
PROJECT: 1301 WHITEHEAD STREET COMPLIANCE	DATE: 06/12/2025 03:27PM
FILE: 1301 WHITEHEAD STREET COMPLIANCE - 2025-06-10 LATEST CAD WITH GARAGE	FILE: 1301 WHITEHEAD STREET COMPLIANCE - 2025-06-10 LATEST CAD WITH GARAGE
SCALE: 1/4" = 1'-0"	SCALE: 1/4" = 1'-0"
DATE: 06/12/2025	DATE: 06/12/2025
TIME: 3:28 PM	TIME: 3:28 PM

**A2.0**

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Existing Front Elevation




Proposed Front Elevation

EXISTING DIMENSIONS TO BE FIELD VERIFIED BY CONTRACTOR



Existing Rear Elevation

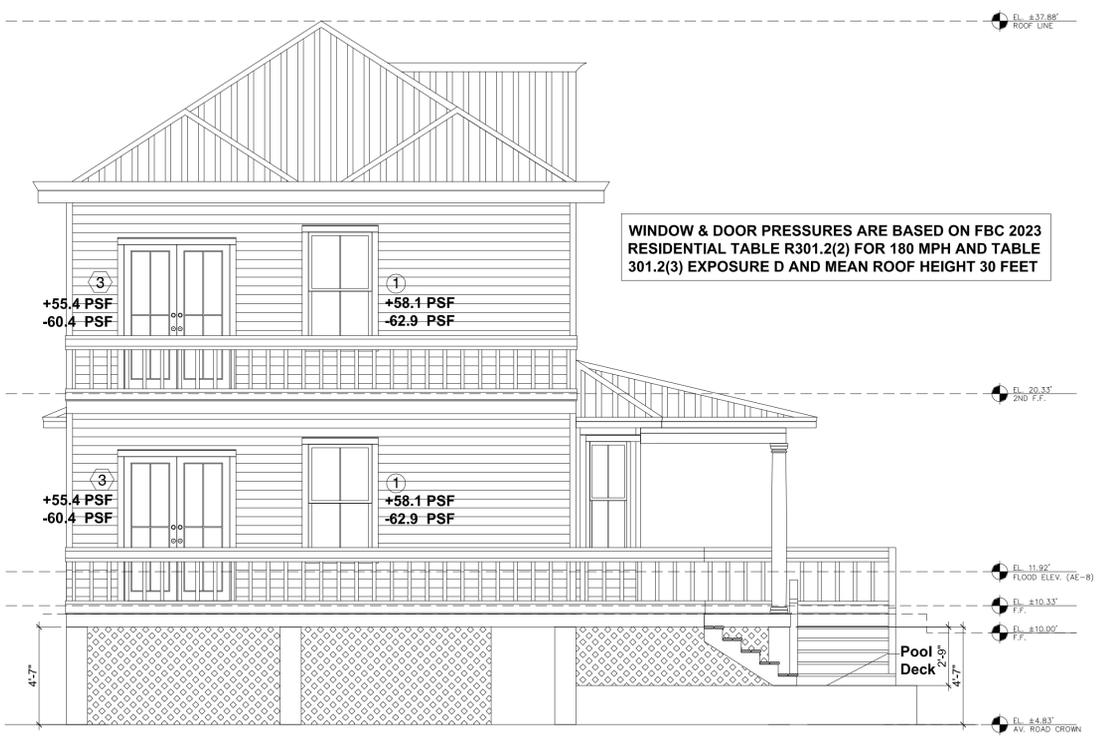

Proposed Rear Elevation

WINDOW & DOOR PRESSURES ARE BASED ON FBC 2023 RESIDENTIAL TABLE R301.2(2) FOR 180 MPH AND TABLE 301.2(3) EXPOSURE D AND MEAN ROOF HEIGHT 30 FEET

REVISIONS	MARK	DESCRIPTION	DATE

**1301 WHITEHEAD STREET COMPLIANCE**


PROJECT OWNER  
1301 WHITEHEAD STREET, KEY WEST, FL 33040

ARCHITECT  
JOHN ROBERT BARNES, RA, NCARB  
REGISTERED ARCHITECT  
AR-010526

ARCHITECTURE AND PLANNING ASSOCIATES  
21 NORTH REDON AVENUE  
FORT MYERS, FL 33901  
(335) 983-0008  
ROBERTBARNESASSOCIATES.COM

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FORT MYERS, FL 33901  
(335) 983-0008  
ROBERTBARNESASSOCIATES.COM

EXISTING AND PROPOSED FRONT & REAR ELEVATIONS		PROJECT NUMBER	DATE DRAWN	SCALE	DATE CHECKED	PROJECT DATE	PROJECT NAME	PROJECT LOCATION	PROJECT NUMBER	DATE CHECKED	PROJECT DATE	PROJECT NAME	PROJECT LOCATION

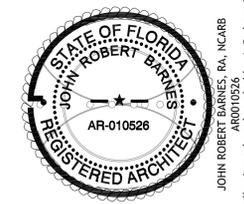**A3.0**

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Existing Right Side Elevation



Proposed Right Side Elevation

EXISTING DIMENSIONS TO BE FIELD VERIFIED BY CONTRACTOR


REVISIONS	MARK	DESCRIPTION	DATE

PROJECT / OWNER  
**1301 WHITEHEAD STREET COMPLIANCE**

JOB ADDRESS  
**1301 WHITEHEAD STREET, KEY WEST, FL 33040**

CONTACT / ARCHITECT  
**PETER JANKER EMAIL: PSJANKER@YAHOO.COM**

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 HOMERIDGE, FL 33030  
 (305) 883-0008  
 ROBERTBARNESASSOCIATES.COM

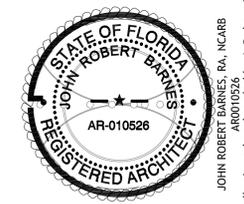EXISTING AND PROPOSED RIGHT SIDE ELEVATION		PROJECT / OWNER	
DATE CHANGED	SCALE SHOWN	DRAWN BY	LAST VALID BY
May 23, 2025	1/8" = 1'-0"	JRB	JRB
DESIGNED BY	PROJECT NUMBER	CHECKED BY	DATE SUBMITTED
JOHN ROBERT BARNES	1301 WHITEHEAD-018-PLANS-FEB2025-FORENG.DWG	JRB	5/23/25 (4:58PM)
DATE ISSUED	PROJECT / OWNER	PROJECT NUMBER	DATE SUBMITTED
May 23, 2025	1301 WHITEHEAD-018-PLANS-FEB2025-FORENG.DWG	1301 WHITEHEAD-018-PLANS-FEB2025-FORENG.DWG	5/23/25 (4:58PM)
SCALE	PROJECT / OWNER	DATE CHANGED	SCALE SHOWN
1/8" = 1'-0"	1301 WHITEHEAD-018-PLANS-FEB2025-FORENG.DWG	May 23, 2025	1/8" = 1'-0"

PROJECT / OWNER  
**1301 WHITEHEAD STREET COMPLIANCE**

JOB ADDRESS  
**1301 WHITEHEAD STREET, KEY WEST, FL 33040**

CONTACT / ARCHITECT  
**PETER JANKER EMAIL: PSJANKER@YAHOO.COM**

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EXISTING DIMENSIONS TO BE FIELD VERIFIED BY CONTRACTOR

**A4.0**

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Existing Left Side (United St.) Elevation



Proposed Left Side (United St.) Elevation


REVISIONS	MARK	DESCRIPTION	DATE

**PROJECT OWNER**  
**1301 WHITEHEAD STREET COMPLIANCE**

**JOB ADDRESS**  
**1301 WHITEHEAD STREET, KEY WEST, FL 33040**

**CONTACT INFO**  
**PETER JANKER EMAIL: P.JANKER@YAHOO.COM**

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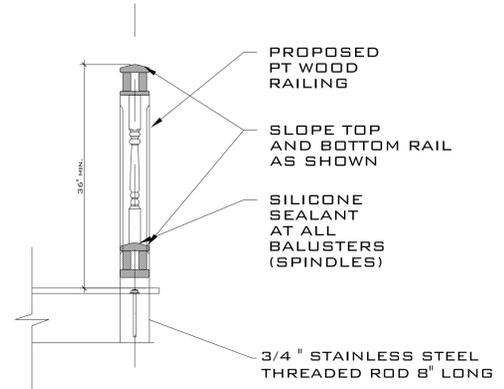
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 ARCHITECTURE AND PLANNING  
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 (305) 983-0008  
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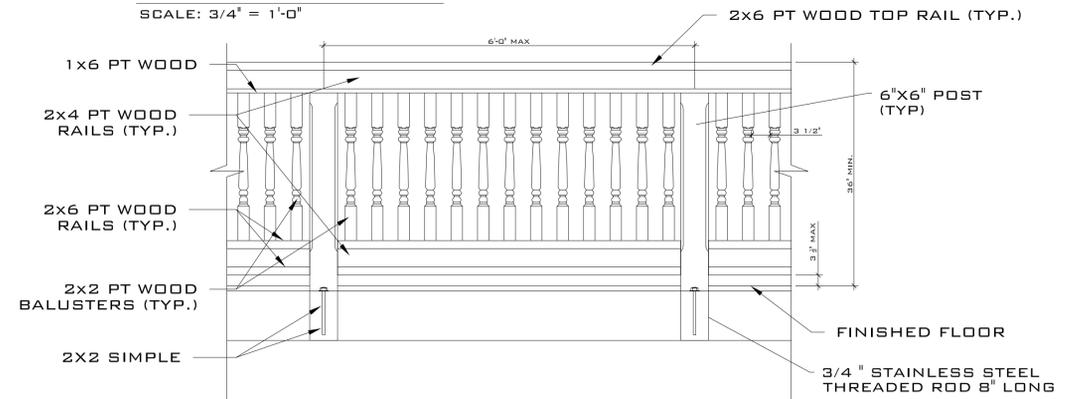
EXISTING AND PROPOSED LEFT SIDE ELEVATION		PROJECT INFORMATION		DATE	
DATE CHANGED	PROJECT NUMBER	SCALE	DATE SHOWN	DATE	PROJECT NAME
05/23/2025	1301 WHITEHEAD-018-PLANS-FEB2025-FOREING.DWG	AS SHOWN	JRB	5/23/25 (4:58PM)	1301 WHITEHEAD-018-PLANS-FEB2025-FOREING.DWG
DRAWN BY	CHECKED BY	DATE	DATE	DATE	DATE
JOHN ROBERT BARNES	JRB	5/23/25	5/23/25	5/23/25	5/23/25
DATE	DATE	DATE	DATE	DATE	DATE
05/23/25	05/23/25	05/23/25	05/23/25	05/23/25	05/23/25

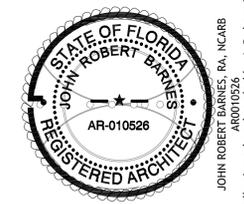**A5.0**

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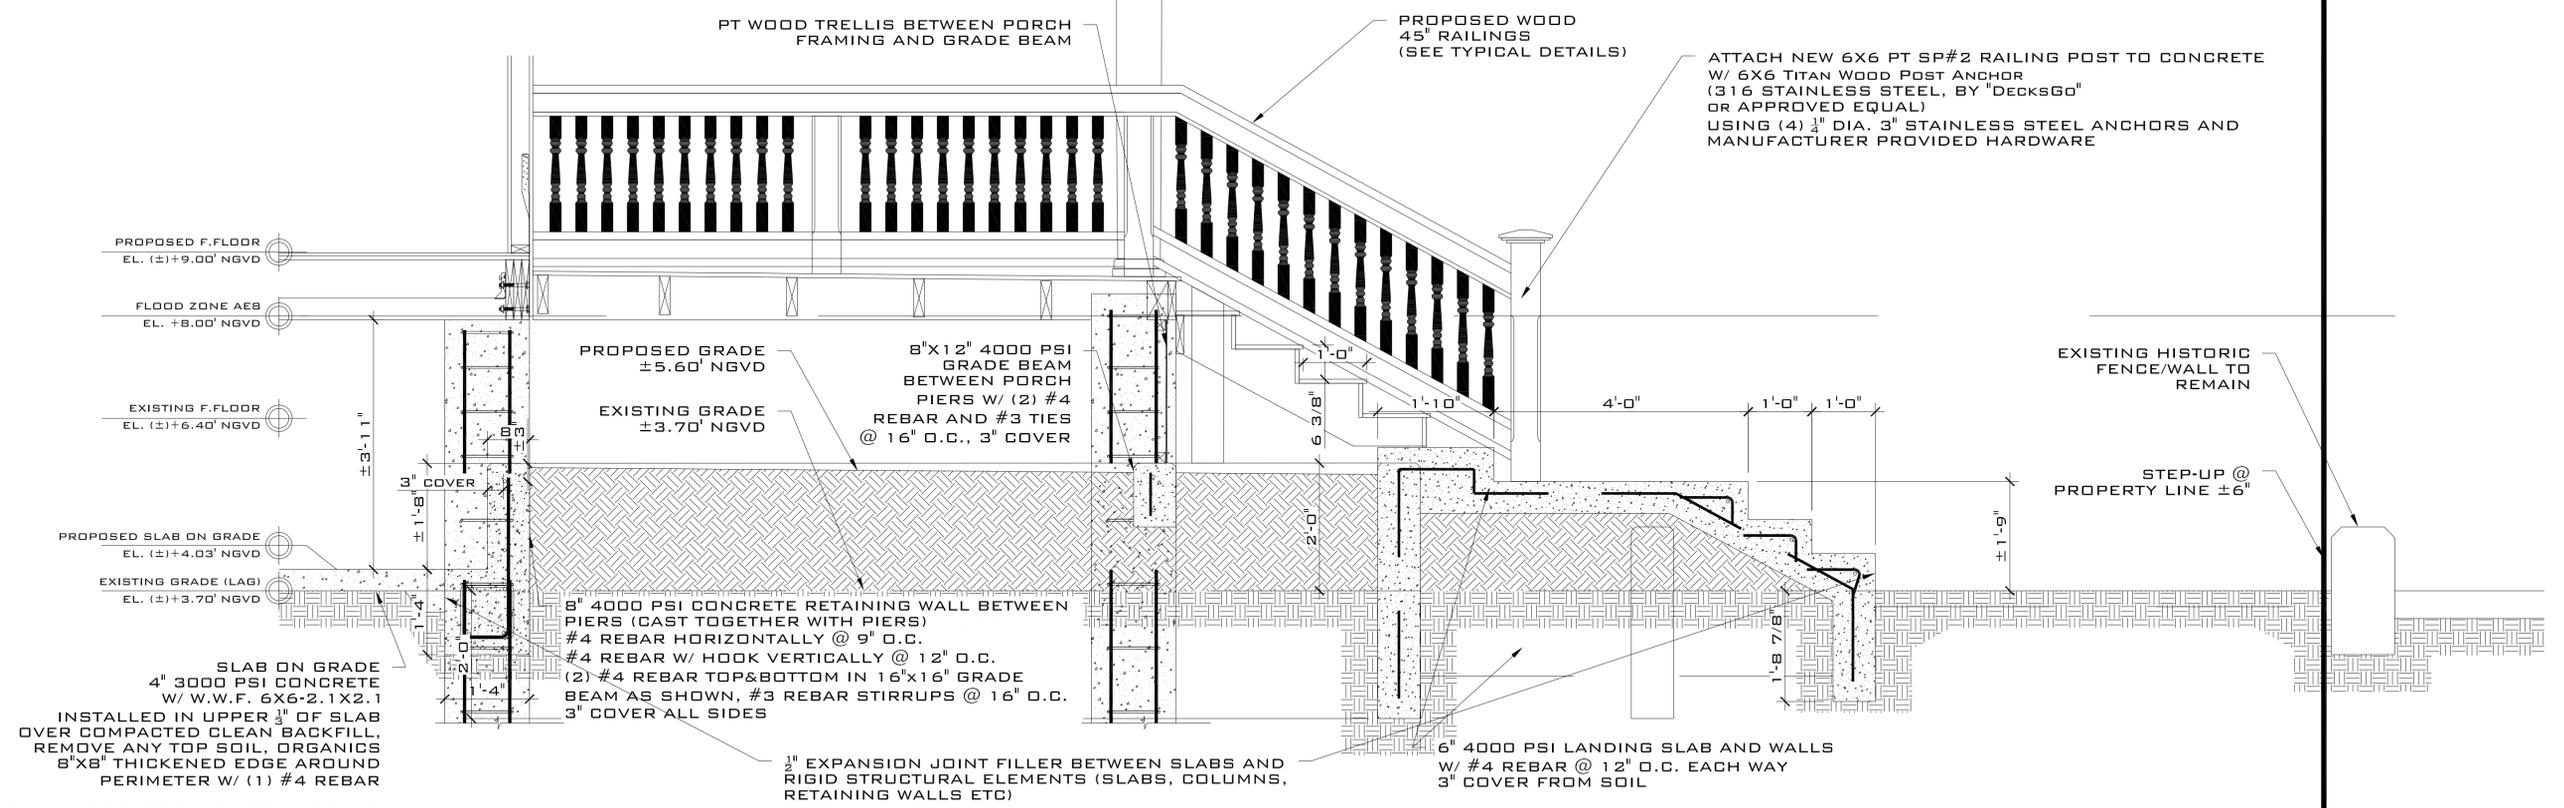
**TYPICAL WOOD RAILING SECTION**  
SCALE: 3/4" = 1'-0"



**TYPICAL WOOD RAILING**  
SCALE: 3/4" = 1'-0"



**DETAIL - RAILING ATTACHED TO COLUMNS**  
N.T.S.



**SECTION 1-1**  
SCALE: 3/4" = 1'-0"

REVISIONS	MARK	DESCRIPTION	DATE


**1301 WHITEHEAD STREET COMPLIANCE**

PROJECT NUMBER: 1301 WHITEHEAD STREET, KEY WEST, FL 33040

FOR ADDRESS: 1301 WHITEHEAD STREET, KEY WEST, FL 33040

CONTACT: PETER JANKER EMAIL: PSJANKER@YAHOO.COM

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**ROBERT BARNES ASSOCIATES**  
ARCHITECTURE AND PLANNING

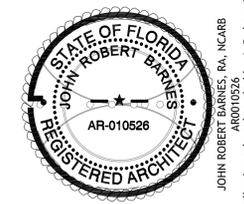221 NORTH BREVARD AVENUE  
FORT MYERS, FL 33901  
(813) 938-0088  
PROJECTS@ROBERTBARNESASSOCIATES.COM


DRAWING TITLE		PROJECT NUMBER		DATE	
RAILING DETAILS		JRB		MAY 23, 2025	
DATE ISSUED	SCALE	DRAWN BY	CHECKED BY	DATE PLOTTED	PLOTTED BY
MAY 23, 2025	AS SHOWN	JRB	JRB	5/23/25 (4:58PM)	JRB
PROJECT LOCATION: 1301 WHITEHEAD STREET, KEY WEST, FL 33040					
DRAWING NUMBER: A6.0					

**A6.0**

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**Typical Wall Section**  
SC. 3/4" = 1' - 0"

**Wind Loads - Components & Cladding : h ≤ 60'**

Base pressure (q<sub>h</sub>) = 84.5 psf      K<sub>h</sub> = 1.139      400.0-#      30.0-#  
 (K<sub>d</sub> q<sub>h</sub>) = 80.3 psf      h = 26.0 ft      400.0-#  
 Minimum parapet ht = 0.0 ft      a = 3.0 ft      400.0-#

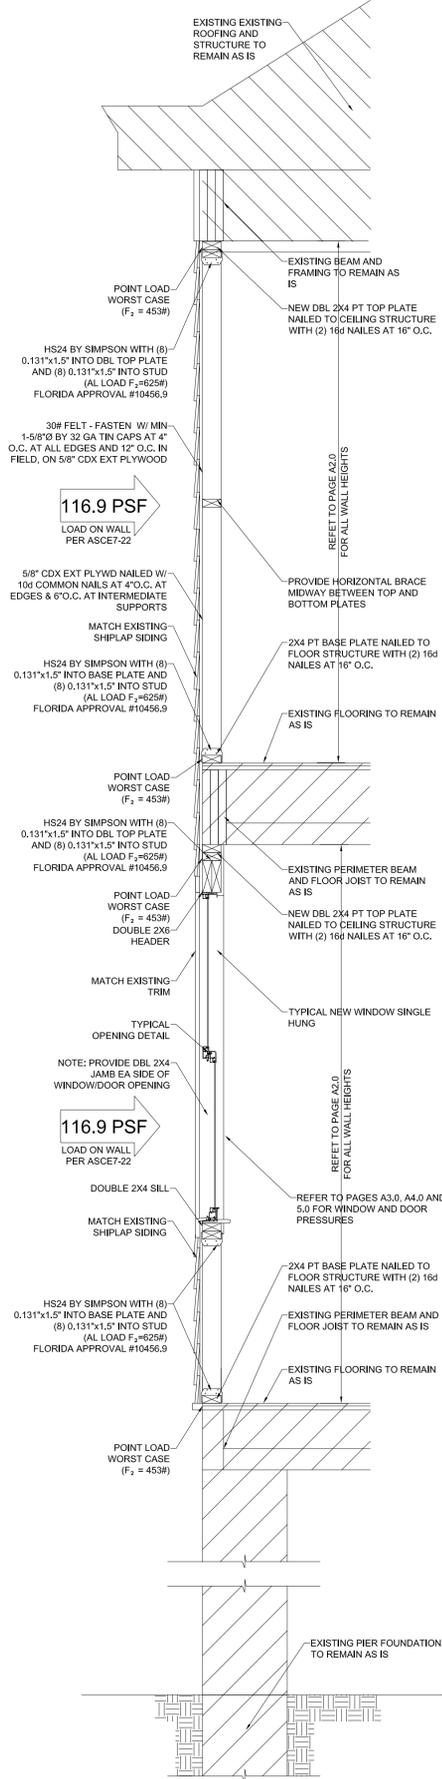Roof Angle (θ) = 30.3 deg      GC<sub>pf</sub> = +/-0.18      **DEAD LOAD = 10 PSF**  
 Type of roof = Hip      K<sub>d</sub> q<sub>h</sub> = 80.3 psf      **LIVE LOAD = 20 PSF**

Roof	GC <sub>pf</sub> +/- GC <sub>pf</sub>				Surface Pressure (psf)				User input		
	10 sf	50 sf	100 sf	500 sf	10 sf	50 sf	100 sf	500 sf	Design	80 sf	200 sf
Negative Zone 1	-1.60	-1.15	-0.95	-0.85	-128.3	-92.8	-77.2	-77.2	-87.2	-82.2	-77.2
Negative Zone 2	-2.14	-1.44	-1.14	-1.14	-172.1	-116.9	-91.8	-91.8	-101.9	-96.8	-91.8
Negative Zone 3	-2.25	-1.50	-1.18	-1.18	-180.9	-120.7	-94.8	-94.8	-104.9	-99.8	-94.8
Positive All Zones	0.88	0.60	0.48	0.48	70.7	48.2	38.5	38.5	48.6	43.5	38.5
Overhang Zone 3 @zone 4	-3.17	-2.30	-1.92	-1.80	-254.7	-169.9	-144.4	-144.4	-154.5	-149.2	-144.4
Overhang Zone 3 @zone 5	-3.47	-2.48	-2.05	-1.80	-278.8	-188.8	-164.4	-164.4	-174.5	-169.2	-164.4

Overhang pressures in the table above assume an internal pressure coefficient (C<sub>pi</sub>) of 0.0  
 Overhang soffit pressure equals adj wall pressure (which includes internal pressure of 14.5 psf)

**Wind Loads - Components & Cladding : h ≤ 60'**

Base pressure (q<sub>h</sub>) = 84.5 psf      K<sub>h</sub> = 1.139      400.0-#      30.0-#  
 (K<sub>d</sub> q<sub>h</sub>) = 80.3 psf      h = 26.0 ft      400.0-#  
 Minimum parapet ht = 0.0 ft      a = 3.0 ft      400.0-#

Roof Angle (θ) = 30.3 deg      GC<sub>pf</sub> = +/-0.18      **DEAD LOAD = 10 PSF**  
 Type of roof = Hip      K<sub>d</sub> q<sub>h</sub> = 80.3 psf      **LIVE LOAD = 20 PSF**

Walls	GC <sub>pf</sub> +/- GC <sub>pf</sub>				Surface Pressure at h				User input		
	10 sf	50 sf	100 sf	500 sf	10 sf	50 sf	100 sf	500 sf	Design	80 sf	200 sf
Negative Zone 4	-1.28	-1.10	-1.05	-0.98	-102.8	-88.9	-84.3	-78.7	-92.5	-86.6	-84.3
Negative Zone 5	-1.58	-1.23	-1.12	-0.98	-128.9	-98.5	-90.0	-78.7	-115.9	-98.5	-90.0
Positive Zone 4 & 5	1.18	1.00	0.95	0.88	84.8	60.8	53.3	50.0	64.8	53.3	50.0

**LUMBER AND FRAMING**  
 FRAMING LUMBER SHALL CONFORM WITH THE PROVISIONS OF THE AMERICAN  
 SOFTWOOD LUMBER STANDARD PS-20 (LATEST EDITION) AND EACH PIECE SHALL  
 BEAR THE GRADE STAMP OF AN APPROVED GRADING AGENCY

FRAMING LUMBER GRADES: THE FOLLOWING GRADES SHALL BE THE MINIMUM  
 ACCEPTABLE GRADES, UNLESS OTHERWISE NOTED ON THE DRAWINGS.

ITEM	MIN GRADE
STUD ONLY:	
2" TO 4" THICK; 2" TO 4" WIDE ...	NO. 2 SOUTHERN PINE
STRUCTURAL LIGHT FRAMING:	
2" TO 4" THICK; 2" TO 4" WIDE ...	NO. 2 SOUTHERN PINE
STRUCTURAL JOISTS & HEADERS:	
2" TO 4" THICK; 6" AND WIDER ...	NO. 2 SOUTHERN PINE
POSTS:	
4"x4" AND LARGER ...	NO. 2 SOUTHERN PINE OR NO. 2 DOUGLAS FIR

BOLT HOLES SHALL BE 1/16" LARGER THAN THE BOLT SIZE. RE-TIGHTEN ALL NUTS  
 PRIOR TO CLOSING IN.  
 STANDARD CUT WASHERS SHALL BE USED UNDER BOLT HEADS AND NUTS  
 AGAINST WOOD.

ALL LUMBER IN CONTACT WITH MASONRY OR CONCRETE SHALL BE PRESSURE  
 TREATED OR OTHERWISE PROTECTED BY AN APPROVED SEPARATING  
 MATERIAL. BOLTS SHALL BE PLACED 9" FROM ANY NOTCH GREATER THAN 1/2 THE  
 WIDTH OF A MEMBER.


DO NOT NOTCH JOISTS, RAFTERS OR BEAMS. OBTAIN ENGINEER'S OR  
 ARCHITECT'S APPROVAL FOR ANY HOLES OR NOTCHES NOT DETAILED. HOLES  
 THROUGH SILLS, PLATES, STUDS AND DOUBLE PLATED IN INTERIOR BEARING AND  
 SHEAR WALLS SHALL NOT EXCEED 1/3 THE PLATE WIDTH. USE BORED HOLES  
 LOCATED IN THE CENTER OF THE STUD OR PLATE.

2" SOLID BLOCKING SHALL BE PLACED BETWEEN JOISTS OR RAFTERS AT ALL  
 SUPPORTS.

ALL NAILING SHALL CONFORM TO THE MINIMUM STANDARDS OF THE  
 INTERNATIONAL BUILDING CODE OR THE 2023 FLORIDA BUILDING CODE.

ALL NAILS AND SCREWS SHALL BE STAINLESS STEEL OR GALVANIZED PER FEMA  
 BULLETIN 2-08 REQUIREMENTS.

ALL LUMBER AND FRAMING WORK AT BELOW FLOOD ELEVATIONS SHALL BE IN  
 ACCORDANCE WITH FEMA 2-08 AND NFIP AND ASCE 24 AND IRC. MINIMUM FRAMING  
 LUMBER SHALL BE CLASS V PRESERVATIVE-TREATED BORATE AND ALL PLYWOOD  
 USED SHALL BE MARINE GRADE.

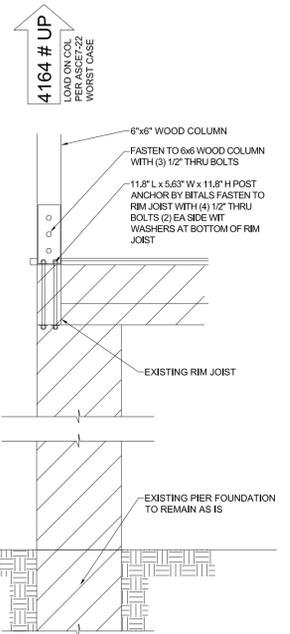

**Typ Column Connection**  
SC. 3/4" = 1' - 0"



**Weather Enclosure - Front Side Elevation (Remains the same)**  
SC. 1/4" = 1' - 0"

THIS PAGE FOR WEATHER PROOFING WALLS ONLY.  
 SEE SHEETS A3.0, A4.0 AND A5.0 FOR PROPOSED  
 AND EXISTING ELEVATIONS

EXISTING DIMENSIONS TO BE FIELD  
 VERIFIED BY CONTRACTOR



**Weather Enclosure - Left Side Elevation**  
SC. 1/4" = 1' - 0"

DATE

REVISIONS

MARK

DESCRIPTION

**1301 WHITEHEAD STREET COMPLIANCE**

PROJECT NUMBER: 1301 WHITEHEAD STREET, KEY WEST, FL 33040

ARCHITECT: ROBERT BARNES & ASSOCIATES, 221 NORTH BROWNE AVENUE, HOMESTEAD, FLORIDA 33030

REGISTERED ARCHITECT: JOHN ROBERT BARNES, RA, NCARB, AR010526

PROJECT MANAGER: JRB

DESIGNED BY: ROBERT BARNES

CHECKED BY: JRB

DATE DESIGNED: APRIL 2025

DATE CHECKED: APRIL 2025


DATE: MAY 27, 2025

SCALE: 1/32" = 1' - 0"

**WEATHER ENCLOSURE ELEVATIONS & SECTION**

DRAWING NUMBER: **A8.0**

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**Weather Enclosure - Rear Side Elevation**  
SC.1/4" = 1' - 0"

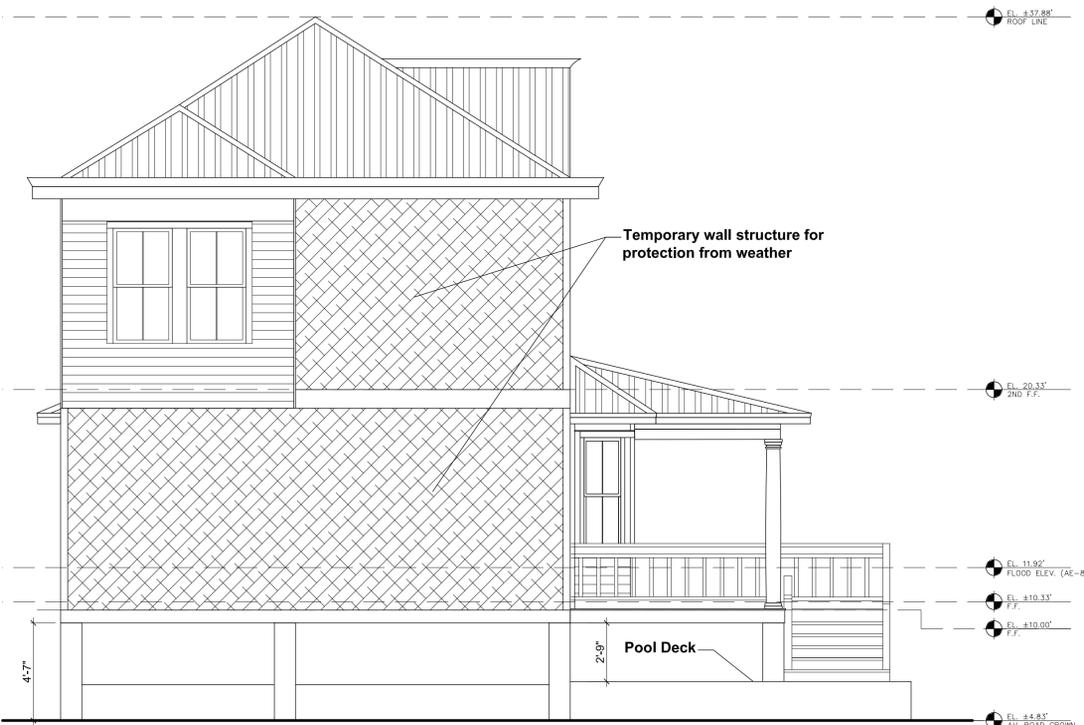THIS PAGE FOR WEATHER PROOFING WALLS ONLY.  
SEE SHEETS A3.0, A4.0 AND A5.0 FOR PROPOSED  
AND EXISTING ELEVATIONS



**Weather Enclosure - Right Side Elevation**  
SC.1/4" = 1' - 0"

EXISTING DIMENSIONS TO BE FIELD  
VERIFIED BY CONTRACTOR


REVISIONS	MARK	DESCRIPTION	DATE

**1301 WHITEHEAD STREET COMPLIANCE**

PROJECT OWNER: 1301 WHITEHEAD STREET, KEY WEST, FL 33040

ARCHITECT: PETER JANKER EMAIL: PSJANKER@YAHOO.COM

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<b>WEATHER ENCLOSURE ELEVATIONS CONTINUED</b>		PROJECT NUMBER: JRB	DATE: MAY 23, 2025
DATE: APRIL 2025	PROJECT NUMBER: AS SHOWN	DATE: MAY 23, 2025	PROJECT NUMBER: JRB
DESIGNED BY: ROBERT BARNES	CHECKED BY: JRB	DATE: MAY 23, 2025	PROJECT NUMBER: JRB
PROJECT: RBBOARDER1301WHITEHEAD-ENCLOSURE PLANS ELEV. WEATHERPROOFING	DATE: MAY 23, 2025	PROJECT NUMBER: JRB	DATE: MAY 23, 2025
PROJECT: CUISERS@DANADESKTOP1301WHITEHEAD STREET COMPLIANCE	DATE: MAY 23, 2025	PROJECT NUMBER: JRB	DATE: MAY 23, 2025
PROJECT: CUISERS@DANADESKTOP1301WHITEHEAD STREET COMPLIANCE	DATE: MAY 23, 2025	PROJECT NUMBER: JRB	DATE: MAY 23, 2025

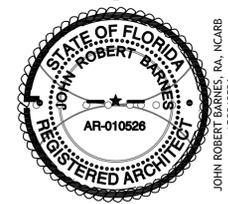**A9.0**

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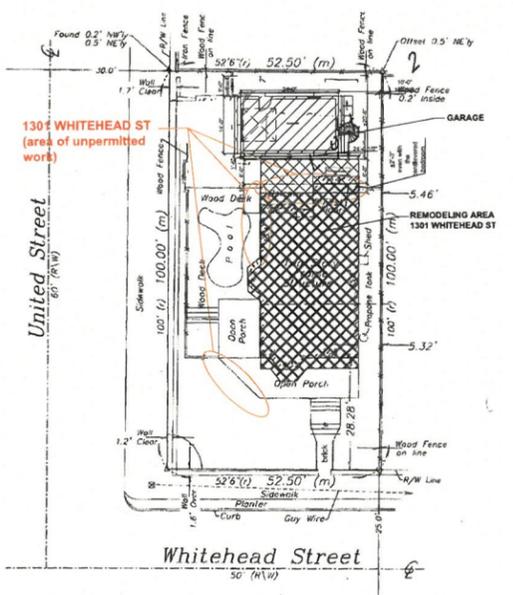
PLANS SUBMITTED ON JUNE 16, 2024

UPDATED PLANS  
RECEIVED ON 6/16/25;  
W/ ELEVATIONS FOR TWO-STORY  
GARAGE. NOT PART OF THIS  
APPLICATION REVIEW & HAS NOT  
BEEN PROPERLY REVIEWED BY  
PLANNING OR HARC.

NOT PART OF  
APPLICATION  
REVIEW


LEGEND	
	EXISTING TO REMAIN
	EXISTING ELEMENTS TO BE DEMOLISHED
	NEW 4" FRAMING WALL
	EXISTING OPENING TO BE INFILLED

SITE DATA	
TOTAL SITE AREA:	5,250.00 SQ FT
LAND USE:	HRRI
FLOOD ZONE:	AE5
MAXIMUM IMPERVIOUS SURFACE RATIO:	
REQUIRED	50% (3,150.00 SQ FT)
EXISTING	47.80% (2,509.4 SQ FT)
PROPOSED	48.85% (2,554.4 SQ FT)
MAXIMUM BUILDING COVERAGE:	
REQUIRED	30% (1,575.00 SQ FT)
EXISTING	39.45% (2,071.2 SQ FT)
PROPOSED	40.30% (2,118.5 SQ FT)
OPEN SPACE MINIMUM:	
REQUIRED	35% (1,837.50 SQ FT)
EXISTING	46.31% (2,431.5 SQ FT)
PROPOSED	45.45% (2,386.5 SQ FT)
SETBACKS	
FRONT:	
REQUIRED	10'-0"
EXISTING	±16'-4"
STREET SIDE:	
REQUIRED	5'-0"
EXISTING	±11'-0"
SIDE:	
REQUIRED	5'-0"
EXISTING	5'-0" TO 3'-6"
REAR:	
REQUIRED	20'-0"
EXISTING	24'-6"
PROPOSED	20'-2"
MAXIMUM HEIGHT:	
EXISTING	30 FT ±33'-4" (TO CROWN OF ROAD)




PLOT PLAN (NOT A SURVEY)  
SCALE: 1" = 20'-0"

THIS PLAN TO SHOW THE  
AREA OF WORK ONLY

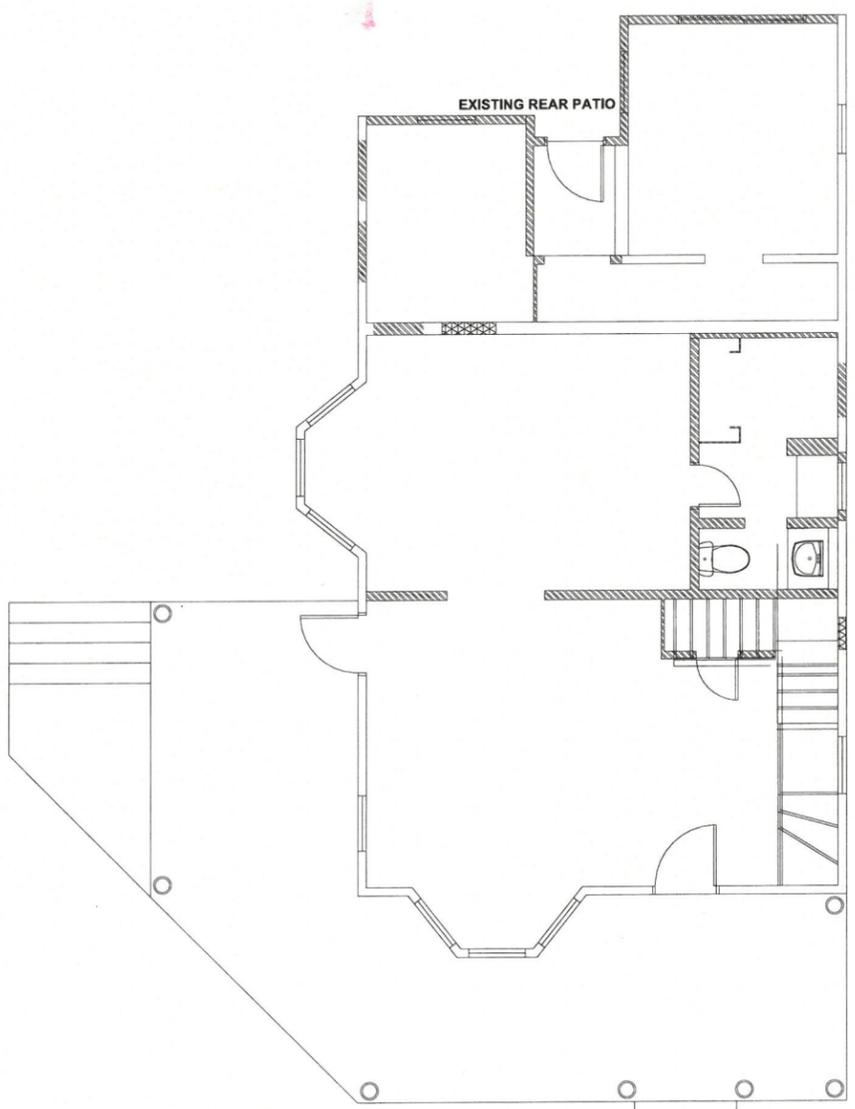


EXISTING/DEMO 1st FLOOR PLAN  
SCALE: 1/4" = 1'-0"

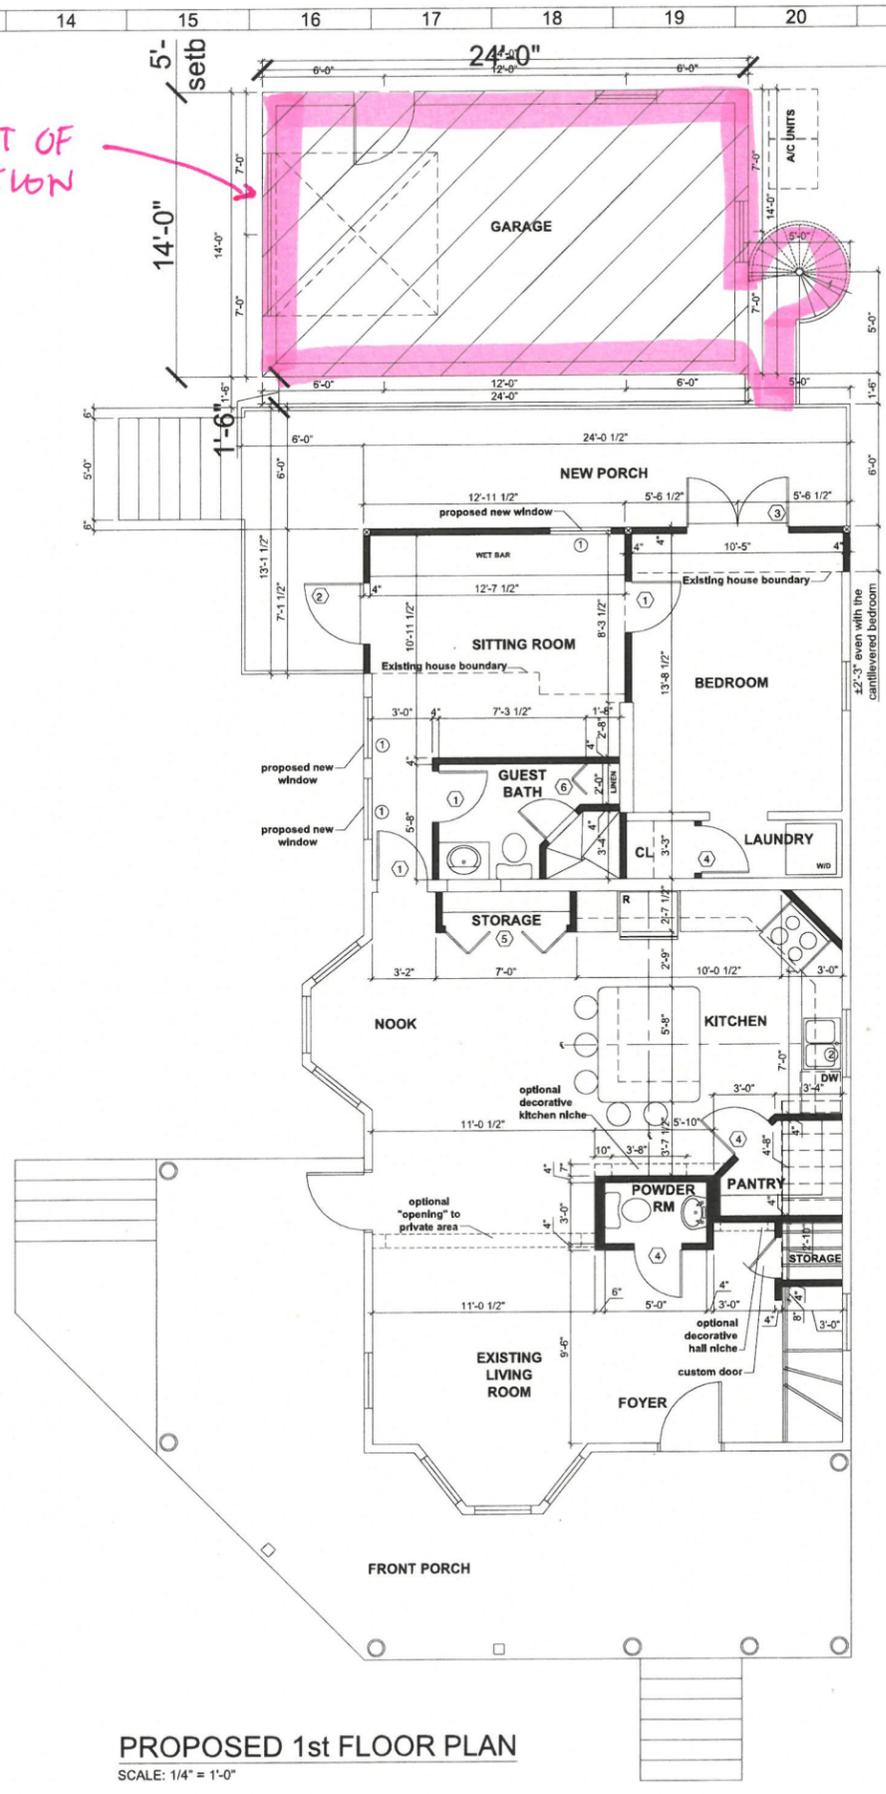

PROPOSED 1st FLOOR PLAN  
SCALE: 1/4" = 1'-0"

John Robert  
Barnes  
Digitally signed by  
John Robert Barnes  
Date: 2025.06.16  
18:54:32 -04'00'

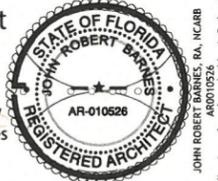

ROBERT BARNES ASSOCIATES  
ARCHITECTURE AND PLANNING  
221 NORTH KNOKE AVENUE  
HOMESTEAD, FLORIDA 33030  
PH: (305) 851-4008  
PROJECT: 1301 WHITEHEAD STREET  
ROBERTBARNESASSOCIATES.COM

EXISTING AND PROPOSED FIRST FLOOR PLANS	
DATE:	APRIL 2025
PROJECT:	1301 WHITEHEAD STREET
SCALE:	AS SHOWN
DESIGNED BY:	JOHN ROBERT BARNES
DRAWN BY:	JRB
DATE:	06/16/25
PROJECT:	1301 WHITEHEAD STREET
DATE:	06/16/25
TIME:	10:39 AM

A1.0

1301 WHITEHEAD STREET  
COMPLIANCE

1301 WHITEHEAD STREET, KEY WEST, FL 33040

PETER JANIKER EMAIL: PSJANKER@YAHOO.COM


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WINDOW SCHEDULE			
MARK	SIZE	TYPE	PRODUCT APPROVAL
①	2'6" x 5'3"	SINGLE HUNG	SERIES SH7700A ALUMINUM SINGLE HUNG WINDOWS LMI BY PGT NOA 23-0707.10 EXP = 08-23-28 DESIGN PRESSURES +65 PSF and -80 PSF
②	3'0" x 3'4"	SINGLE HUNG	

DOOR SCHEDULE			
MARK	SIZE	TYPE	PRODUCT APPROVAL
①	2'6" x 6'8"	WOOD SWING DOOR	SERIES EWD OUTSWING OPAQUE WOOD DOOR-L.M. LARGE AND SMALL MISSILE IMPACT BY EXCLUSIVE WOOD DOORS INC. NOA 23-1024.04 EXP = 08-11-26 DESIGN PRESSURES +70 PSF and -70 PSF
②	3'0" x 6'8"	WOOD PANEL DOOR	
③	5'0" x 6'8"	DOUBLE FRENCH DOOR	SERIES FD5555 OUTSWING PVC FRENCH DOORS W/WO SIDE LITES & TRANSM LMI BY PGT NOA 23-0717.01 EXP = 01-23-29 DESIGN PRESSURES +70 PSF and -70 PSF
④	2'4" x 6'8"	WOOD SWING DOOR	
⑤	2-3'0" x 6'8"	BI-FOLD DOOR	
⑥	2'0" x 6'8"	BI-FOLD DOOR	
⑦	2-2'0" x 6'8"	BI-FOLD DOOR	
⑧	2-2'6" x 6'8"	BI-FOLD DOOR	



LEGEND	
	EXISTING TO REMAIN
	EXISTING ELEMENTS TO BE DEMOLISHED
	NEW 4" FRAMING WALL
	EXISTING OPENING TO BE INFILLED

EXISTING DIMENSIONS TO BE FIELD VERIFIED BY CONTRACTOR

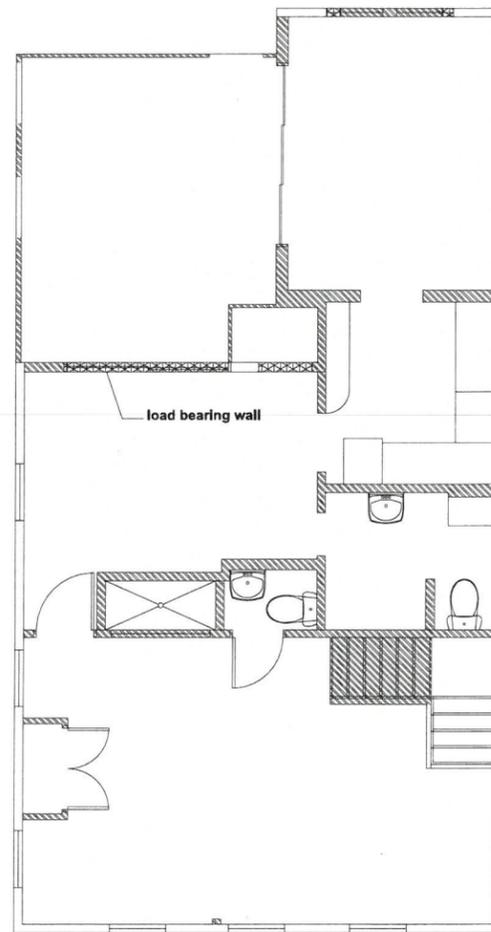

EXISTING/DEMO 2nd FLOOR PLAN  
SCALE: 1/4" = 1'-0"

NOT PART OF APPLICATION REVIEW

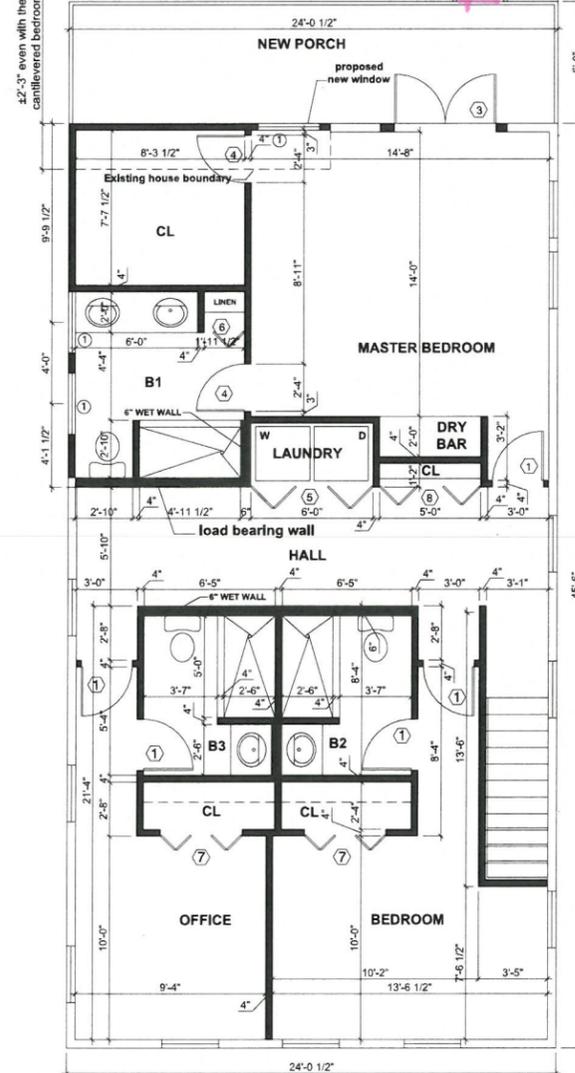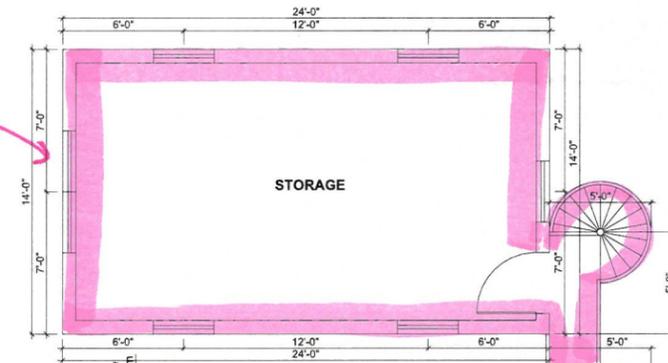

PROPOSED 2nd FLOOR PLAN  
SCALE: 1/4" = 1'-0"

REVISIONS	MARK	DESCRIPTION	DATE

**1301 WHITEHEAD STREET COMPLIANCE**  
PROJECT NUMBER: 1301 WHITEHEAD STREET, KEY WEST, FL 33040  
FOR ARCHITECT: PETER JANKEK EMAIL: P.JANKEK@YAHOO.COM  
DIRECTOR: PETER JANKEK  
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**ROBERT BARNES ARCHITECTURE AND PLANNING ASSOCIATES**  
711 NORTH HOWARD AVENUE  
HOMESTEAD, FL 33063  
(305) 847-4100  
PROJECTS@ROBERTBARNESASSOCIATES.COM  
ROBERTBARNESASSOCIATES.COM

EXISTING AND PROPOSED SECOND FLOOR PLANS	
DATE: APRIL 2025	PROJECT NUMBER: AS2 SHOWN
DESIGNED BY: JOHN ROBERT BARNES	CHECKED BY: [ ]
DRAWN BY: JOHN ROBERT BARNES	DATE: APRIL 2025
SCALE: 1/4" = 1'-0"	DATE: APRIL 2025
PROJECT: 1301 WHITEHEAD STREET COMPLIANCE	DATE: APRIL 2025
PROJECT NUMBER: 1301 WHITEHEAD STREET, KEY WEST, FL 33040	DATE: APRIL 2025
PROJECT: 1301 WHITEHEAD STREET COMPLIANCE	DATE: APRIL 2025
PROJECT: 1301 WHITEHEAD STREET COMPLIANCE	DATE: APRIL 2025

**A2.0**

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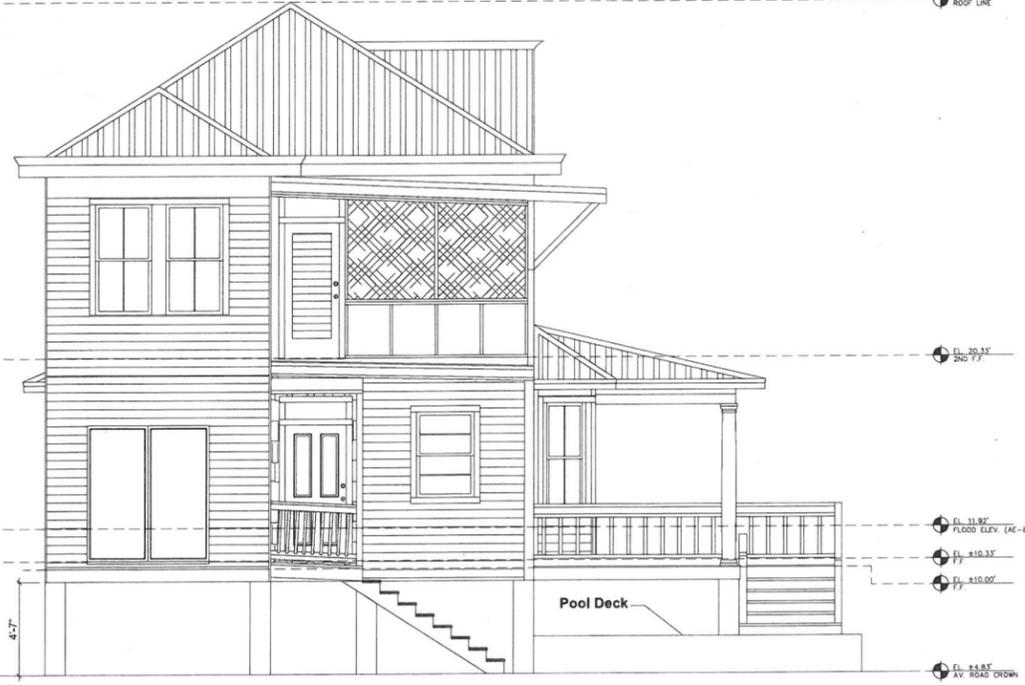


Existing Front Elevation  
SC. 1/4" = 1' - 0"




Proposed Front Elevation  
SC. 1/4" = 1' - 0"

EXISTING DIMENSIONS TO BE FIELD VERIFIED BY CONTRACTOR



Existing Rear Elevation  
SC. 1/4" = 1' - 0"

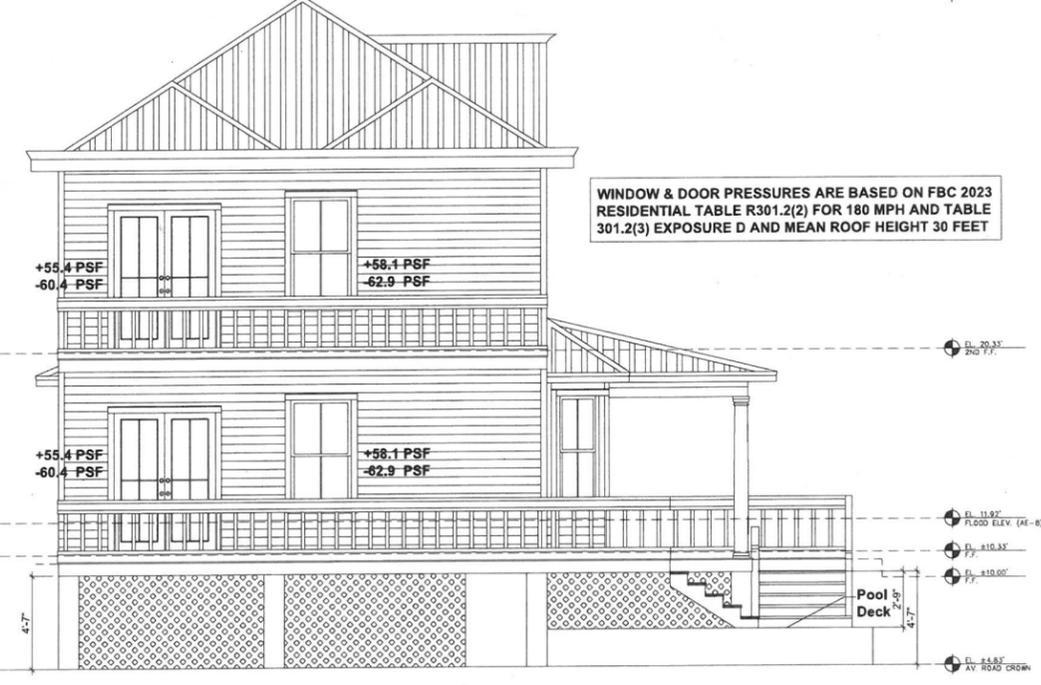

Proposed Rear Elevation  
SC. 1/4" = 1' - 0"


WINDOW & DOOR PRESSURES ARE BASED ON FBC 2023 RESIDENTIAL TABLE R301.2(2) FOR 180 MPH AND TABLE 301.2(3) EXPOSURE D AND MEAN ROOF HEIGHT 30 FEET

REVISIONS MARK	DESCRIPTION	DATE

1301 WHITEHEAD STREET  
COMPLIANCE

1301 WHITEHEAD STREET, KEY WEST, FL 33040

PETER JANKER EMAIL: PJANKER@YAHOO.COM

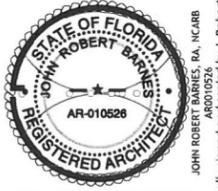

ROBERT BARNES & ASSOCIATES ARCHITECTURE AND PLANNING  
221 NORTH KROME AVENUE  
HOMESTEAD, FLORIDA 33030  
(305) 851-4008  
ROBERTBARNESANDASSOCIATES.COM

DATE	BY	FOR	SCALE	STATUS
APRIL 2025	AS SHOWN	AS SHOWN	AS SHOWN	AS SHOWN
APRIL 2025	AS SHOWN	AS SHOWN	AS SHOWN	AS SHOWN

EXISTING AND PROPOSED FRONT & REAR ELEVATIONS  
A3.0

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**Existing Right Side Elevation**  
 SC. 1/4" = 1' - 0"



**Proposed Right Side Elevation**  
 SC. 1/4" = 1' - 0"

EXISTING DIMENSIONS TO BE FIELD  
 VERIFIED BY CONTRACTOR

REVISIONS	MARK	DESCRIPTION	DATE

**1301 WHITEHEAD STREET  
 COMPLIANCE**

PROJECT / OWNER  
 1301 WHITEHEAD STREET, KEY WEST, FL 33040

ARCHITECT  
 PETER JANKER EMAIL: PSJANKER@YAHOO.COM

CONTRACT NO.  
 THESE DRAWINGS, SPECIFICATIONS, AND SCHEDULES SHALL BE THE PROPERTY OF THE ARCHITECT. THE CONTRACTOR SHALL BE RESPONSIBLE FOR OBTAINING ALL NECESSARY PERMITS AND APPROVALS FROM THE LOCAL, STATE, AND FEDERAL AUTHORITIES. THE CONTRACTOR SHALL BE RESPONSIBLE FOR VERIFYING THE ACCURACY OF ALL INFORMATION PROVIDED TO THE ARCHITECT. THE ARCHITECT SHALL NOT BE RESPONSIBLE FOR ANY ERRORS OR OMISSIONS IN THESE DRAWINGS, SPECIFICATIONS, AND SCHEDULES. © 2024



JOHN ROBERT BARNES, R.A., N.CARB

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 ARCHITECTURE AND PLANNING  
 © 2024  
 771 NORTH MEADOW AVENUE  
 HOMESTEAD, FL ORDA 33000  
 (305) 477-6150  
 PROJECTS@ROBERTBARNESASSOCIATES.COM  
 ROBERTBARNESASSOCIATES.COM

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EXISTING AND PROPOSED RIGHT SIDE ELEVATION		DATE	PROJECT NUMBER
DATE	PROJECT NUMBER	DATE	PROJECT NUMBER
APRIL 2025	AS SHOWN	16/25 (11:5AM)	
DESIGNED BY	DATE	DATE	DATE
JOHN ROBERT BARNES	16/25 (11:5AM)	16/25 (11:5AM)	16/25 (11:5AM)
PROJECT LOCATION	PROJECT NUMBER	PROJECT NUMBER	PROJECT NUMBER
1301 WHITEHEAD STREET, KEY WEST, FL 33040	1301 WHITEHEAD STREET, KEY WEST, FL 33040	1301 WHITEHEAD STREET, KEY WEST, FL 33040	1301 WHITEHEAD STREET, KEY WEST, FL 33040
DATE	DATE	DATE	DATE
16/25 (11:5AM)	16/25 (11:5AM)	16/25 (11:5AM)	16/25 (11:5AM)
16/25 (11:5AM)	16/25 (11:5AM)	16/25 (11:5AM)	16/25 (11:5AM)
16/25 (11:5AM)	16/25 (11:5AM)	16/25 (11:5AM)	16/25 (11:5AM)

SHAWING NUMBER  
**A4.0**



Existing Left Side (United St.) Elevation  
 SC. 1/4" = 1' - 0"

Proposed Left Side (United St.) Elevation  
 SC. 1/4" = 1' - 0"

EXISTING DIMENSIONS TO BE FIELD  
 VERIFIED BY CONTRACTOR

REVISIONS	MARK	DESCRIPTION	DATE

**1301 WHITEHEAD STREET COMPLIANCE**

PROJECT OWNER: 1301 WHITEHEAD STREET, KEY WEST, FL 33040  
 ARCHITECT: PETER JANKER EMAIL: PSJANKER@YAHOO.COM  
 CONTRACTOR: [REDACTED]

STATE OF FLORIDA REGISTERED ARCHITECT  
 JOHN ROBERT BARNES, R.A., H.CARB  
 AR-010528

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 22 NORTH HOME AVENUE  
 HOMESTEAD, FLORIDA 33030  
 (305) 847-4150  
 PROJECTS@ROBERTBARNESASSOCIATES.COM  
 ROBERTBARNESASSOCIATES.COM

**EXISTING AND PROPOSED LEFT SIDE ELEVATION**

DATE: APRIL 2025	PROJECT NUMBER: AS SHOWN	DATE PLOTTED: 6/16/25 (11:13AM)
DRAWN BY: ROBERT BARNES	CHECKED BY: AS SHOWN	DATE PLOTTED: 6/16/25 (11:13AM)
FILE NAME: 1301WHITEHEAD-01-PLANS-FEEDBACK-ORANGE.DWG	PROJECT LOCATION: 1301 WHITEHEAD STREET, KEY WEST, FL 33040	DATE PLOTTED: 6/16/25 (11:13AM)
PLOTTED BY: CLAUSSER@AANDKTOPJANKER RESIDENCE - 2025-01	DATE PLOTTED: JUNE 14, 2025	TIME PLOTTED: 11:25 AM


**A5.0**

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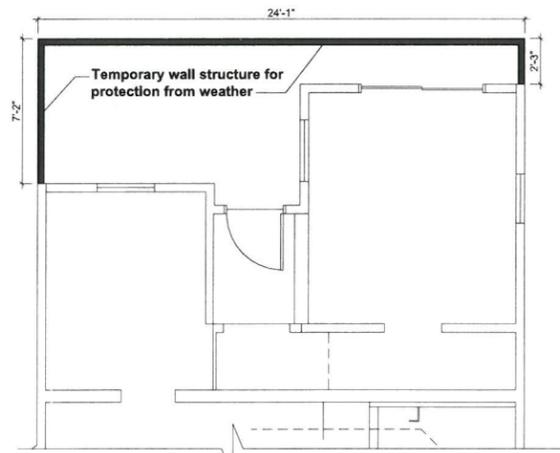




\* TEMPORARY STRUCTURE  
NOT PART OF THIS  
APPLICATION REVIEW.  
RECEIVED APPROVAL AT  
STAFF LEVEL.

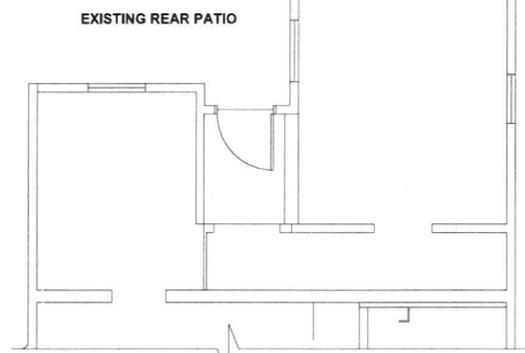


**EXISTING 1st FLOOR PLAN**  
SCALE: 1/4" = 1'-0"




**PROPOSED 1st FLOOR PLAN**  
SCALE: 1/4" = 1'-0"

THIS PAGE FOR WEATHER PROOFING WALLS AND FLOOR FRAMING ONLY. SEE SHEETS A1.0 AND A2.0 FOR PROPOSED AND EXISTING WINDOW AND DOOR LOCATIONS


EXISTING DIMENSIONS TO BE FIELD VERIFIED BY CONTRACTOR

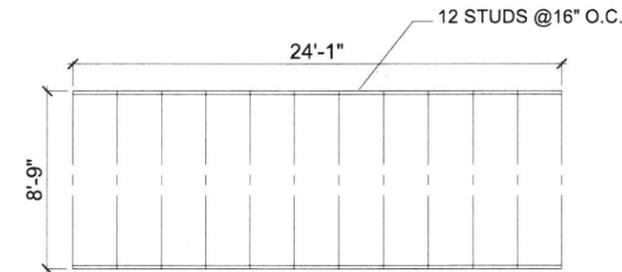


1ST FLOOR EAST WALL

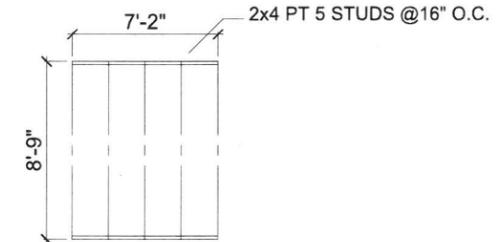


1ST FLOOR NORTH WALL

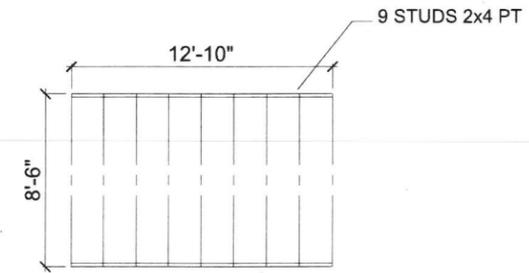


2ND FLOOR EAST WALL

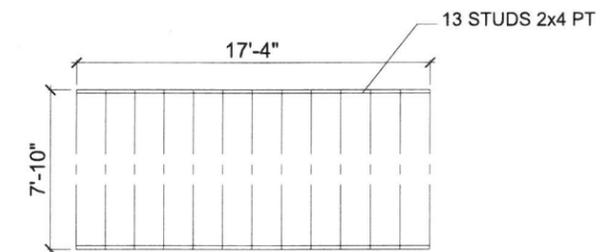


2ND FLOOR NORTH WALL PROPOSED DBL. 2x4 PT

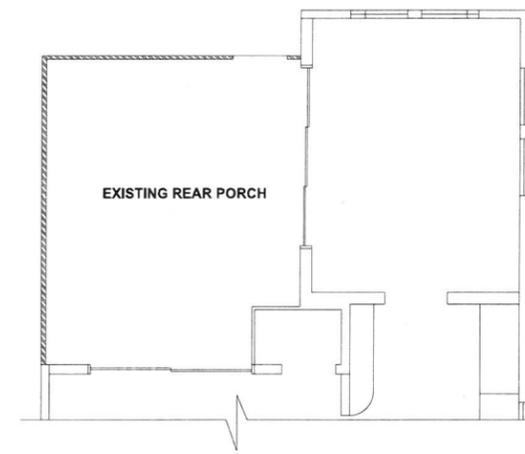

**EXISTING/DEMO 2nd FLOOR PLAN**  
SCALE: 1/4" = 1'-0"

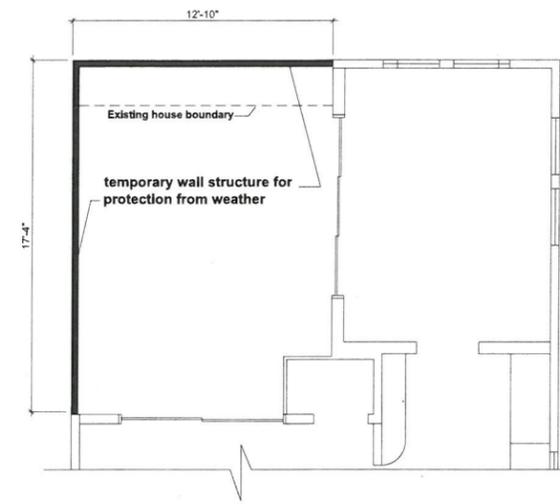

**PROPOSED 2nd FLOOR PLAN**  
SCALE: 1/4" = 1'-0"

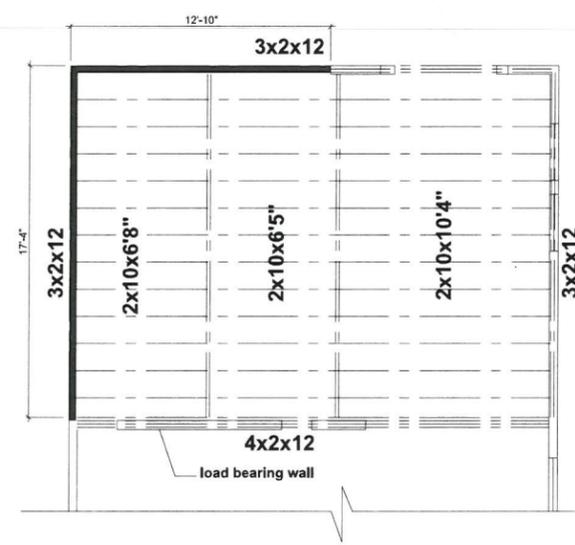

**2nd FLOOR FRAMING PLAN**  
SCALE: 1/4" = 1'-0"

**WALL WEATHER**  
SCALE: 1/4" = 1'-0"

REVISIONS	DATE
MARK	DESCRIPTION

**1301 WHITEHEAD STREET COMPLIANCE**

PROJECT OWNER:  
1301 WHITEHEAD STREET, KEY WEST, FL 33040  
ARCHITECT:  
PETER JANKER EMAIL: PJANKER@YAHOO.COM  
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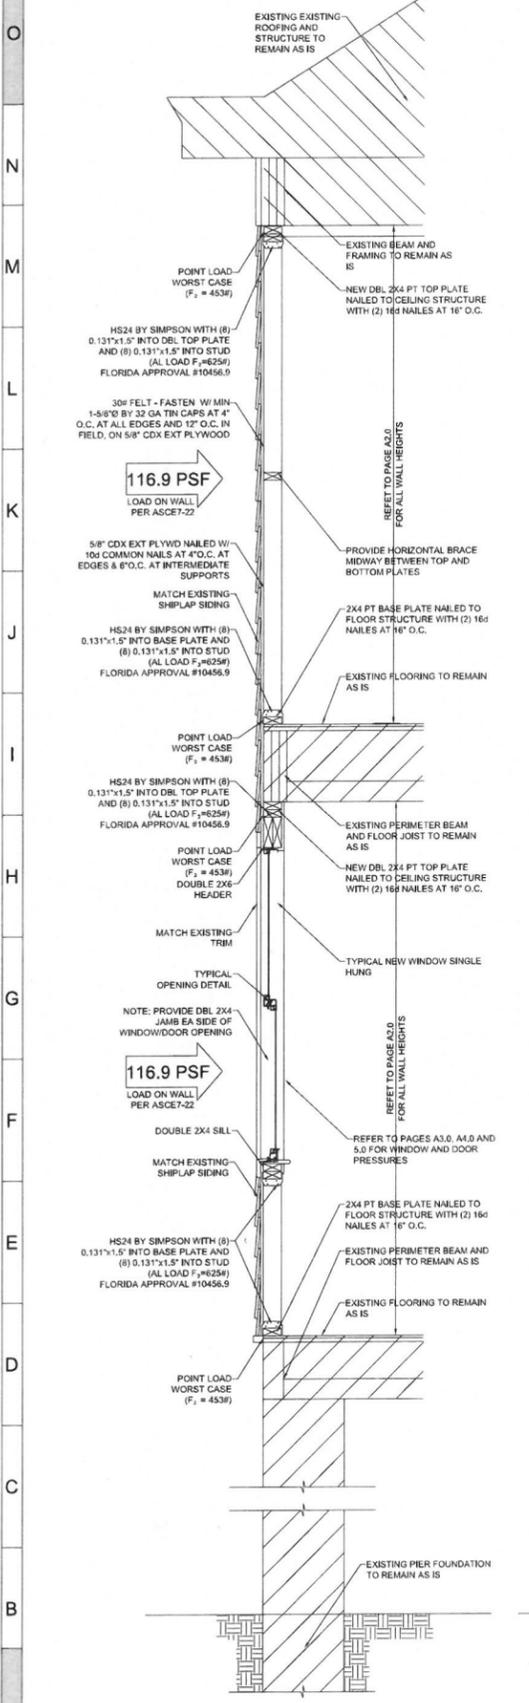


**ROBERT BARNES ARCHITECTURE AND PLANNING ASSOCIATES**  
ARCHITECTURE AND PLANNING  
271 NORTH HOWE AVENUE  
ROOM 100  
KEY WEST, FL 33040  
PHONE: (305) 474-4150  
PROJECT: 1301 WHITEHEAD STREET COMPLIANCE  
ROBERTBARNESASSOCIATES.COM

PARTIAL PLANS	
<b>WALL &amp; FLOOR FRAMING</b>	
DATE: 2025	SCALE: 1/4" = 1'-0"
PROJECT NUMBER: 1301 WHITEHEAD STREET COMPLIANCE	DATE: 05/27/2025
PROJECT NAME: 1301 WHITEHEAD STREET COMPLIANCE	PROJECT LOCATION: 1301 WHITEHEAD STREET, KEY WEST, FL 33040
PROJECT OWNER: 1301 WHITEHEAD STREET, KEY WEST, FL 33040	PROJECT NUMBER: 1301 WHITEHEAD STREET COMPLIANCE
PROJECT ARCHITECT: PETER JANKER	PROJECT DATE: 05/27/2025
PROJECT ENGINEER: JOHN ROBERT BARNES	PROJECT TIME: 10:00 AM

**A7.0**

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Typical Wall Section  
SC. 3/4" = 1' - 0"

**Wind Loads - Components & Cladding : h ≤ 60'**

Base pressure (q<sub>s</sub>) = 94.5 psf    K<sub>t</sub> = 1.130    300-0-R    300-0-R  
 Mid q<sub>s</sub> = 88.5 psf    h = 20.0 ft    400-0-R  
 Minimum parapet ht = 0.0 ft    a = 3.0 ft    400-0-R

Roof Angle (θ) = 30.3 deg    GCp1 = +0.18  
 Type of roof = Hip    Kd q = Kd q<sub>s</sub> = 80.3 psf

Roof	Area	GCp vs. GCs				Surface Pressure (psf)				User Input		
		10 sf	50 sf	100 sf	500 sf	10 sf	50 sf	100 sf	500 sf	Design	80 sf	200 sf
Negative Zone 1	-1.00	-1.15	-0.98	-0.98	-128.3	-92.1	-77.2	-77.2	-82.2	-77.2	-82.2	-77.2
Negative Zone 2	-2.14	-1.44	-1.14	-1.14	-172.1	-115.0	-91.9	-91.9	-95.5	-91.9	-95.5	-91.9
Negative Zone 3	-2.25	-1.50	-1.18	-1.18	-180.9	-120.7	-94.8	-94.8	-103.1	-94.8	-103.1	-94.8
Positive Zone 4	0.08	0.80	0.49	0.49	70.7	49.3	38.5	38.5	41.7	38.5	41.7	38.5
Overhang Zone 3 @ zone 4	-3.17	-2.30	-1.92	-1.92	-254.7	-184.6	-144.5	-144.5	-144.4	-144.4	-144.4	-150.2
Overhang Zone 3 @ zone 5	-3.47	-2.48	-2.05	-1.80	-278.8	-198.8	-154.4	-154.4	-154.4	-154.4	-154.4	-159.8

Overhang pressures in the table above assume an internal pressure coefficient (GCi) of 0.0  
 Overhang soffit pressure equals ad wall pressure (which includes internal pressure of 14.3 psf)

**Wind Loads - Components & Cladding : h ≤ 60'**

Base pressure (q<sub>s</sub>) = 94.5 psf    K<sub>t</sub> = 1.130    400-0-R    300-0-R  
 Mid q<sub>s</sub> = 80.3 psf    h = 20.0 ft    400-0-R  
 Minimum parapet ht = 0.0 ft    a = 3.0 ft    400-0-R

Roof Angle (θ) = 30.3 deg    GCp1 = +0.18  
 Type of roof = Hip    Kd q = Kd q<sub>s</sub> = 80.3 psf

Walls	Area	GCp vs. GCs				Surface Pressure (psf)				User Input		
		10 sf	100 sf	200 sf	500 sf	10 sf	100 sf	200 sf	500 sf	Design	100 sf	200 sf
Negative Zone 4	-1.28	-1.10	-1.05	-0.98	-102.6	-88.0	-84.3	-78.7	-92.8	-88.0	-84.3	-84.3
Negative Zone 5	-1.58	-1.23	-1.12	-0.98	-139.6	-98.5	-90.3	-78.7	-115.9	-98.5	-90.3	-80.0
Positive Zone 4 & 5	1.18	1.00	0.95	0.88	84.9	80.6	76.3	70.7	84.6	80.6	76.3	

**LUMBER AND FRAMING**  
 FRAMING LUMBER SHALL CONFORM WITH THE PROVISIONS OF THE AMERICAN SOFTWOOD LUMBER STANDARD PS-20 (LATEST EDITION) AND EACH PIECE SHALL BEAR THE GRADE STAMP OF AN APPROVED GRADING AGENCY.

FRAMING LUMBER GRADES: THE FOLLOWING GRADES SHALL BE THE MINIMUM ACCEPTABLE GRADES, UNLESS OTHERWISE NOTED ON THE DRAWINGS.

ITEM	MIN GRADE
STUD ONLY:	
2" TO 4" THICK; 2" TO 4" WIDE ...	NO. 2 SOUTHERN PINE
STRUCTURAL LIGHT FRAMING:	
2" TO 4" THICK; 2" TO 4" WIDE ...	NO. 2 SOUTHERN PINE
STRUCTURAL JOISTS & HEADERS:	
2" TO 4" THICK; 6" AND WIDER ...	NO. 2 SOUTHERN PINE
POST:	
4"x4" AND LARGER ...	NO. 2 SOUTHERN PINE OR NO. 2 DOUGLAS FIR

BOLT HOLES SHALL BE 1/16" LARGER THAN THE BOLT SIZE. RE-TIGHTEN ALL NUTS PRIOR TO CLOSING IN.  
 STANDARD CUT WASHERS SHALL BE USED UNDER BOLT HEADS AND NUTS AGAINST WOOD.

ALL LUMBER IN CONTACT WITH MASONRY OR CONCRETE SHALL BE PRESSURE TREATED OR OTHERWISE BE PROTECTED BY AN APPROVED SEPARATING MATERIAL. BOLTS SHALL BE PLACED 9" FROM ANY NOTCH GREATER THAN 1/2 THE WIDTH OF A MEMBER.

DO NOT NOTCH JOISTS, RAFTERS OR BEAMS. OBTAIN ENGINEER'S OR ARCHITECT'S APPROVAL FOR ANY HOLES OR NOTCHES NOT DETAILED. HOLES THROUGH SILLS, PLATES, STUDS AND DOUBLE PLATED IN INTERIOR, BEARING AND SHEAR WALLS SHALL NOT EXCEED 1/3 THE PLATE WIDTH. USE BORED HOLES LOCATED IN THE CENTER OF THE STUD OR PLATE.

2" SOLID BLOCKING SHALL BE PLACED BETWEEN JOISTS OR RAFTERS AT ALL SUPPORTS.

ALL NAILING SHALL CONFORM TO THE MINIMUM STANDARDS OF THE INTERNATIONAL BUILDING CODE OR THE 2023 FLORIDA BUILDING CODE.

ALL NAILS AND SCREWS SHALL BE STAINLESS STEEL OR GALVANIZED PER FEMA BULLETIN 2-08 REQUIREMENTS.


ALL LUMBER AND FRAMING WORK AT BELOW FLOOD ELEVATIONS SHALL BE IN ACCORDANCE WITH FEMA 2-08 AND NFIP AND ASCE 24 AND IRC. MINIMUM FRAMING LUMBER SHALL BE CLASS 1 PRESERVATIVE-TREATED BORATE AND ALL PLYWOOD USED SHALL BE MARINE GRADE.



Weather Enclosure - Front Side Elevation (Remains the same)  
 SC. 1/4" = 1' - 0"

THIS PAGE FOR WEATHER PROOFING WALLS ONLY.  
 SEE SHEETS A3.0, A4.0 AND A5.0 FOR PROPOSED AND EXISTING ELEVATIONS

EXISTING DIMENSIONS TO BE FIELD VERIFIED BY CONTRACTOR

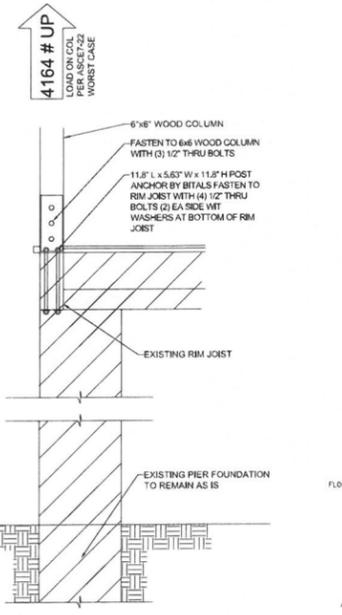

Typ Column Connection  
 SC. 3/4" = 1' - 0"



Weather Enclosure - Left Side Elevation  
 SC. 1/4" = 1' - 0"

DATE: \_\_\_\_\_  
 REVISIONS: \_\_\_\_\_  
 MARK: \_\_\_\_\_

**1301 WHITEHEAD STREET COMPLIANCE**

PROJECT NUMBER: 1301 WHITEHEAD STREET, KEY WEST, FL 33040  
 ARCHITECT: PETER JANKER EMAIL: PSJANKER@YAHOO.COM  
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STATE OF FLORIDA  
 JOHN ROBERT BARNES, RA, NCARB  
 REGISTERED ARCHITECT  
 AR-010526

ROBERT BARNES ASSOCIATES  
 ARCHITECTURE AND PLANNING  
 221 NORTH IRVING AVENUE  
 ROOM 200  
 MIAMI, FLORIDA 33136  
 PHONE: (305) 371-6150  
 FAX: (305) 371-6150  
 WWW: WWW.RBAASSOCIATES.COM

WEATHER ENCLOSURE ELEVATIONS & SECTION  
 DATE: APRIL 2025  
 SCALE: AS SHOWN  
 DRAWN BY: JRB  
 CHECKED BY: JRB  
 PROJECT NUMBER: 1301 WHITEHEAD STREET COMPLIANCE  
 CLIENT: CALISSA D'AMANES/PTOP/1301 WHITEHEAD STREET COMPLIANCE  
 DATE: MAY 27, 2025  
 TIME: 1:20 PM

**A8.0**

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# NOTICING

# Public Meeting Notice

The Historic Architectural Review Commission will hold a public meeting at 5:00 p.m., June 24, 2025, at City Hall, 1300 White Street, Key West, Florida. The purpose of the hearing will be to consider a request for:

**AFTER THE FACT – RENOVATIONS TO CONTRIBUTING STRUCTURE. ENCLOSURE AND EXTENSION OF REAR/SIDE SECOND STORY PORCH AND EXTENSION OF REAR FIRST FLOOR. FULL WIDTH TWO-STORY OPEN PORCH IN REAR. ADDITION OF HIP ROOF OVER SECOND STORY COVERED PORCH. PARTIAL DEMOLITION OF REAR SECTION OF FIRST FLOOR AND SECOND STORY COVERED PORCH.**

**#1301 WHITEHEAD STREET**

**Applicant – Peter Janker    Application #C2025-0061**

If you wish to see the application or have any questions, you may visit the Planning Department during regular office hours at 1300 White Street, call 305-809-3975 or visit our website at [www.cityofkeywest-fl.gov](http://www.cityofkeywest-fl.gov).

**THIS NOTICE CAN NOT BE REMOVED FROM THE SITE UNTIL HARC FINAL DETERMINATION**

**ADA ASSISTANCE:** It is the policy of the City of Key West to comply with all requirements of the Americans with Disabilities Act (ADA). Please call the TTY number at 800-955-8771 or 800-955-8770 (Voice) or the ADA Coordinator at 305-809-3811 at least five business days in advance for sign language interpreters, assistive listening devices, or materials in accessible format.

# HARC POSTING AFFIDAVIT

STATE OF FLORIDA:  
COUNTY OF MONROE:

BEFORE ME, the undersigned authority, personally appeared Peter S. Jankov, who, first being duly sworn, on oath, depose and says that the following statements are true and correct to the best of his/her knowledge and belief:

1. That a legal notice for Public Notice of Hearing of the Historic Architectural Review Commission (HARC) was placed on the following address:  
1301 Whitehead Street on the  
16 day of June, 2025.

This legal notice(s) contained an area of at least 8.5"x11".

The property was posted to notice a public hearing before the Key West Historic Architectural Review Commission to be held on 24 June 2025, 2025.

The legal notice(s) is/are clearly visible from the public street adjacent to the property.

The Certificate of Appropriateness number for this legal notice is C 2025-0061


2. A photograph of that legal notice posted in the property is attached hereto.  
*emailed to city 16 June 2025*

Signed Name of Affiant: Peter S. Jankov  
Date: 17 June 2025  
Address: 1301 Whitehead St.  
City: Key West, FL  
State, Zip: 33040

The forgoing instrument was acknowledged before me on this 17 day of June, 2025.

By (Print name of Affiant) Peter Stanley Jankov who is personally known to me or has produced 45 Department of Defense identification and who did take an oath.

NOTARY PUBLIC  
Sign Name: Levi Pattinson  
Print Name: Levi Pattinson  
Notary Public - State of Florida (seal)  
My Commission Expires: 5-8-2027

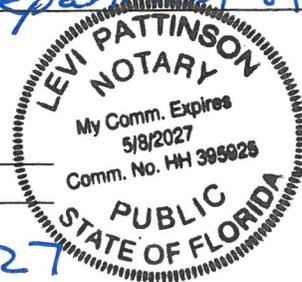

# Public Meeting Notice

Public Meeting Notice for the proposed project on the subject of the application for a license to operate a public house on the premises of the property at 1000 West Street, Baltimore, Maryland. The meeting will be held on the premises of the property at 1000 West Street, Baltimore, Maryland, on the 15th day of the month of August, 2024, at 7:00 PM. The meeting will be held in the presence of the Baltimore Police Department and the Baltimore Fire Department. The meeting will be held in the presence of the Baltimore Police Department and the Baltimore Fire Department. The meeting will be held in the presence of the Baltimore Police Department and the Baltimore Fire Department.

**1000 WEST STREET**

Application - Beer License - Application # 2024-0001

For more information on the application process, please visit the Planning Department website at <https://www.baltimore.gov/planning>.

# PROPERTY APPRAISER INFORMATION

# Monroe County, FL

## \*\*PROPERTY RECORD CARD\*\*

### Disclaimer

The Monroe County Property Appraiser's office maintains data on property within the County solely for the purpose of fulfilling its responsibility to secure a just valuation for ad valorem tax purposes of all property within the County. The Monroe County Property Appraiser's office cannot guarantee its accuracy for any other purpose. Likewise, data provided regarding one tax year may not be applicable in prior or subsequent years. By requesting such data, you hereby understand and agree that the data is intended for ad valorem tax purposes only and should not be relied on for any other purpose.

By continuing into this site you assert that you have read and agree to the above statement.

### Summary

Parcel ID 00036120-000000  
 Account# 1036986  
 Property ID 1036986  
 Millage Group 10KW  
 Location 1301 WHITEHEAD St, KEY WEST  
 Address  
 Legal Description KW FILER BOYLE SUB N-476 PT LOT 2 SQR 3 TR 16 OR283-55  
 OR533-713 OR1083-2085 OR1248-1308 OR1514-47  
 OR2018-809 OR2540-2267 OR3168-1859 OR3180-1520  
 OR3322-141 OR3325-0522  
 (Note: Not to be used on legal documents.)  
 Neighborhood 6108  
 Property Class SINGLE FAMILY RESID (0100)  
 Subdivision  
 Sec/Twp/Rng 06/68/25  
 Affordable No  
 Housing



### Owner

JANKER PETER S  
 1301 Whitehead St  
 Key West FL 33040

JANKER DIXIE L  
 1301 Whitehead St  
 Key West FL 33040

### Valuation

	2024 Certified Values	2023 Certified Values	2022 Certified Values	2021 Certified Values
+ Market Improvement Value	\$321,784	\$310,904	\$319,086	\$289,103
+ Market Misc Value	\$13,372	\$13,372	\$13,372	\$13,853
+ Market Land Value	\$1,285,200	\$1,077,300	\$834,750	\$617,400
= Just Market Value	\$1,620,356	\$1,401,576	\$1,167,208	\$920,356
= Total Assessed Value	\$816,718	\$792,931	\$769,836	\$747,414
- School Exempt Value	(\$109,172)	(\$106,793)	(\$104,484)	(\$30,000)
= School Taxable Value	\$707,546	\$686,138	\$665,352	\$717,414

### Historical Assessments

Year	Land Value	Building Value	Yard Item Value	Just (Market) Value	Assessed Value	Exempt Value	Taxable Value	Maximum Portability
2024	\$1,285,200	\$321,784	\$13,372	\$1,620,356	\$816,718	\$109,172	\$707,546	\$500,000
2023	\$1,077,300	\$310,904	\$13,372	\$1,401,576	\$792,931	\$106,793	\$686,138	\$500,000
2022	\$834,750	\$319,086	\$13,372	\$1,167,208	\$769,836	\$104,484	\$665,352	\$397,372
2021	\$617,400	\$289,103	\$13,853	\$920,356	\$747,414	\$30,000	\$717,414	\$172,942
2020	\$612,675	\$296,155	\$14,334	\$923,164	\$737,095	\$30,000	\$707,095	\$186,069
2019	\$645,750	\$237,853	\$14,815	\$898,418	\$720,523	\$30,000	\$690,523	\$177,895
2018	\$568,575	\$244,649	\$15,296	\$828,520	\$707,089	\$30,000	\$677,089	\$121,431

The Maximum Portability is an estimate only and should not be relied upon as the actual portability amount. Contact our office to verify the actual portability amount.

### Land

Land Use	Number of Units	Unit Type	Frontage	Depth
RESIDENTIAL DRY (010D)	5,250.00	Square Foot	52.5	100

**Buildings**

<b>Building ID</b>	2873	<b>Exterior Walls</b>	ABOVE AVERAGE WOOD
<b>Style</b>	2 STORY ELEV FOUNDATION	<b>Year Built</b>	1938
<b>Building Type</b>	S.F.R. - R1 / R1	<b>EffectiveYearBuilt</b>	2005
<b>Building Name</b>		<b>Foundation</b>	CONC BLOCK
<b>Gross Sq Ft</b>	2942	<b>Roof Type</b>	IRR/CUSTOM
<b>Finished Sq Ft</b>	1944	<b>Roof Coverage</b>	ASPHALT SHINGL
<b>Stories</b>	2 Floor	<b>Flooring Type</b>	SFT/HD WD
<b>Condition</b>	AVERAGE	<b>Heating Type</b>	NONE with 0% NONE
<b>Perimeter</b>	292	<b>Bedrooms</b>	3
<b>Functional Obs</b>	0	<b>Full Bathrooms</b>	2
<b>Economic Obs</b>	0	<b>Half Bathrooms</b>	0
<b>Depreciation %</b>	27	<b>Grade</b>	550
<b>Interior Walls</b>	WALL BD/WD WAL	<b>Number of Fire Pl</b>	0

Code	Description	Sketch Area	Finished Area	Perimeter
OPX	EXC OPEN PORCH	140	0	0
FLA	FLOOR LIV AREA	1,944	1,944	0
OOU	OP PR UNFIN UL	252	0	0
OPF	OP PRCH FIN LL	354	0	0
PUF	SC PRCH FIN UL	252	0	0
<b>TOTAL</b>		<b>2,942</b>	<b>1,944</b>	<b>0</b>

**Yard Items**

Description	Year Built	Roll Year	Size	Quantity	Units	Grade
UTILITY BLDG	1950	1951	8 x 11	1	88 SF	3
FENCES	1955	1956	0x0	1	280 SF	3
RES POOL	1992	1983	0x0	1	180 SF	5
WOOD DECK	1982	1983	0x0	1	273 SF	2

**Sales**

Sale Date	Sale Price	Instrument	Instrument Number	Deed Book	Deed Page	Sale Qualification	Vacant or Improved	Grantor	Grantee
5/9/2025	\$0	Quit Claim Deed	2500127	3325	0522	11 - Unqualified	Improved		
4/21/2025	\$0	Warranty Deed	2497666	3322	0141	11 - Unqualified	Improved		
4/20/2022	\$0	Warranty Deed	2380827	3180	1520	11 - Unqualified	Improved		
4/20/2022	\$0	Warranty Deed	2371694	3168	1859	11 - Unqualified	Improved		
10/28/2011	\$833,300	Warranty Deed		2540	2267	02 - Qualified	Improved		
4/1/1998	\$220,000	Conversion Code		1514	0047	O - Unqualified	Improved		
2/1/1973	\$37,500	Conversion Code		533	713	Q - Qualified	Improved		


**Permits**

Number	Date Issued	Status	Amount	Permit Type	Notes
24-1346	06/10/2024	Active	\$78,000	Residential	remove and install new foundation. Install misc floor framing as per plans . Foundation
24-1388	05/20/2024	Active	\$350	Residential	Cap off water for lifting of 1301 whitehead reconnection of water and sewer once home is moved to new foundation
12-2951	12/21/2012	Completed	\$1,100	Residential	PAINTING OF RESIDENCE-REMOVE ONE KITCHEN SO THERE IS ONLY ONE IN HOME. WILL NOT INCLUDE FRONT WALL SINCE IT'S ON CITY PROPERTY- WILL REQUIRE AN EASEMENT
03-7/18/3	07/18/2003	Completed	\$600		RELOCATE POOL PUMP
13-2339	07/08/2003	Completed	\$1,500		REPLASTER POOL
9902993	08/23/1999	Completed	\$9,550		13 SQS V-CRIMP ROOF
9803552	11/15/1998	Completed	\$5,000		EXTERIOR REPAIRS

**View Tax Info**

[View Taxes for this Parcel](#)

**Sketches (click to enlarge)**

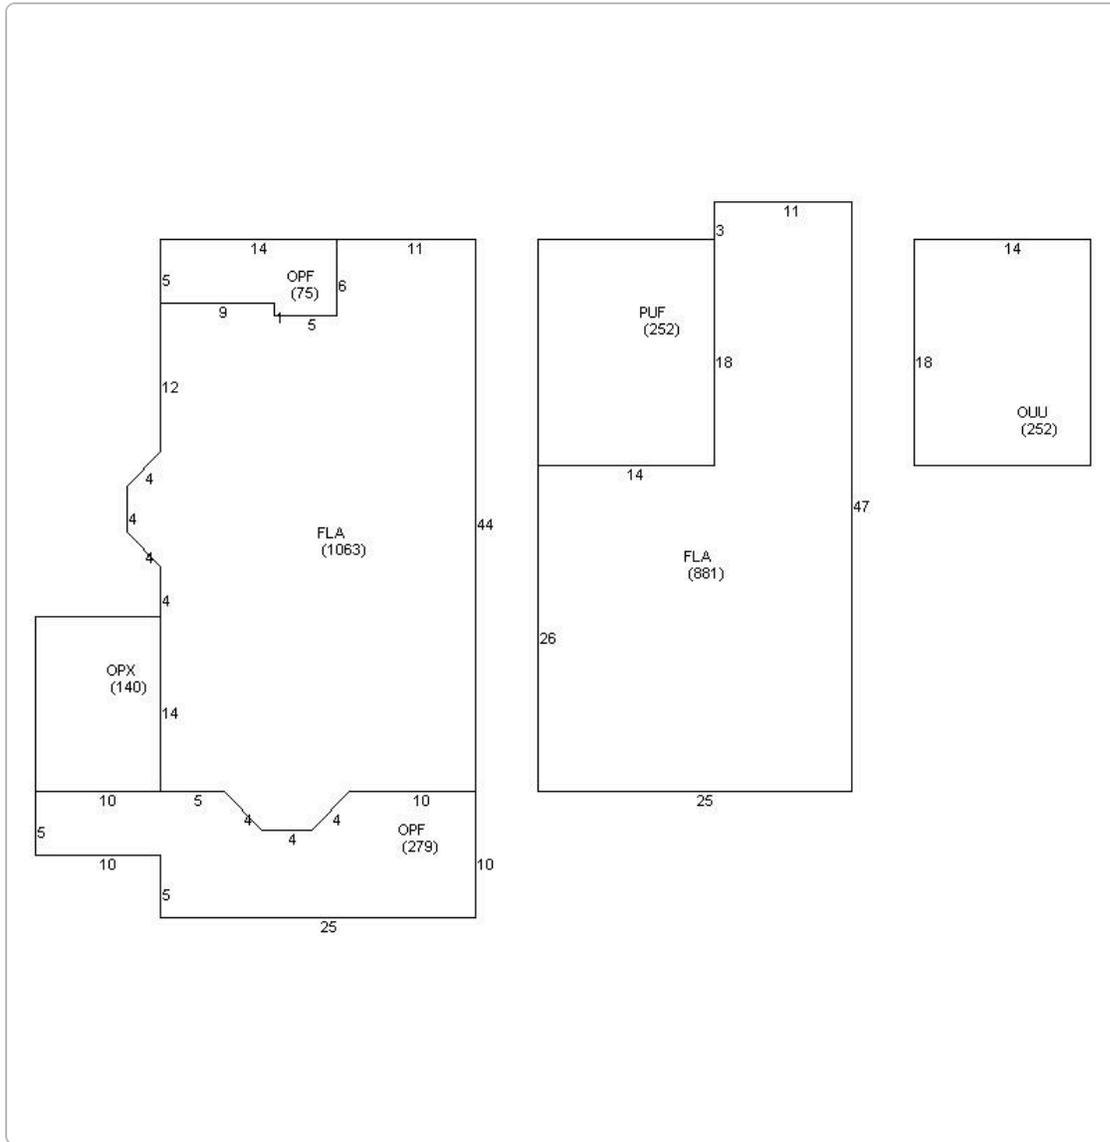

Photos



### Map



### TRIM Notice

[2024 TRIM Notice \(PDF\)](#)

The Monroe County Property Appraiser's office maintains data on property within the County solely for the purpose of fulfilling its responsibility to secure a just valuation for ad valorem tax purposes of all property within the County. The Monroe County Property Appraiser's office cannot guarantee its accuracy for any other purpose. Likewise, data provided regarding one tax year may not be applicable in prior or subsequent years. By requesting such data, you hereby understand and agree that the

[User Privacy Policy](#) | [GDPR Privacy Notice](#)  
Last Data Upload: 5/31/2025, 1:32:00 AM

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# SUPPORTING MATERIALS

## Daniela Salume

---

**From:** Peter Janker <psjanker@yahoo.com>  
**Sent:** Monday, June 9, 2025 10:12 PM  
**To:** Daniela Salume; J. Robert Barnes  
**Cc:** Matthew Crawford  
**Subject:** [EXTERNAL] Re: [EXTERNAL] Re: [EXTERNAL] Re: [EXTERNAL] 1301 Whitehead Street

**CAUTION:** This email originated from outside of the organization. Do not click links or open attachments unless you recognize the sender and know the content is safe.

Daniela

I have scheduled travel this summer that takes me out of the area. Hence the need to get this building secured by the first week of July. Hence the importance of getting the permit for the temporary enclosure.

Plan is to work on the main house exterior and interior in the fall and then move the accessory building, once the main house is done.

The plan is to make the accessory structure two stories similar to what's been done by my neighbor except one stall garage instead of two. The bottom would be a garage and the top would be storage. That structure would be moved back in the yard and closer to the pool as previously approved by the HARC committee.

V/r

Peter

[Sent from Yahoo Mail for iPhone](#)

On Monday, June 9, 2025, 5:26 PM, Daniela Salume <daniela.salume@cityofkeywest-fl.gov> wrote:

Hey Peter,

We can plan to bring the accessory structure to a later HARC Commission meeting. Could you please share your expected timeline so we can coordinate accordingly?

Best Regards,

Daniela Salume, *MFL*

- 8 New one-story frame addition to rear and side to non-historic house-  
**#700 Amelia Street- Halloran Construction (H15-01-0355)**
- A motion was made by Mr. Richard Logan, seconded by Ms. Lori Thompson, that the Item be Approved the condition that the revised drawing of the shed roof be approved by staff. The motion passed by a unanimous vote.**
- 9a Relocation, elevation of historic house and modification to footers. New side and rear additions. New accessory structure. New pool and site work including partial site regrading- **#1301 Whitehead Street - Thomas E. Pope (H15-01-1528)**
- A motion was made by Mr. Bert Bender, seconded by Ms. Letisia Powell, that the Item be Postponed. The motion passed by a unanimous vote.**
- 9b Demolition of rear additions. Demolition of shed- **#1301 Whitehead Street - Thomas E. Pope (H15-01-1528)**
- A motion was made by Mr. Bert Bender, seconded by Ms. Letisia Powell, that the Item be Postponed. The motion passed by a unanimous vote.**
- 10 New two-story frame house on vacant lot with pool, fences and site improvements- **#1408 Whalton Street- Thomas E. Pope (H15-01-1987)**
- A motion was made by Vice Chair Richard McChesney, seconded by Ms. Janet Hinkle, that the Item be Approved. The motion passed by a unanimous vote.**
- 11a Renovations to existing house including new foundations as needed. New small enclosure on existing porch with roof extension. New dormers over contributing house- **#6 Pinder Lane- Thomas E. Pope (H16-01-0004)**
- A motion was made by Mr. Richard Logan, seconded by Ms. Janet Hinkle, that the Item be Approved with the condition that the roof dormers are removed from the application. The motion passed by a unanimous vote.**
- 11b Partial demolition of roof of contributing house. Demolition of non-historic wall- **#6 Pinder Lane- Thomas E. Pope (H16-01-0004)**
- A motion was made by Mr. Bert Bender, seconded by Ms. Letisia Powell, that the Item be Approved with the condition that the demolition only covers the wall, not the roof. The motion passed by a unanimous vote.**
- 12a New exterior staircase and deck over rear addition- **#311 Elizabeth Street- Michael M. Ingram (H15-01-1864)**
- A motion was made by Mr. Bert Bender, seconded by Mr. Richard Logan, that the Item be Postponed. The motion passed by a unanimous vote.**

- 2 ~~Relocation~~, Elevation of historic house 2'-6" and modification to footers. ~~New side and rear additions.~~ New Relocate and elevate accessory structure and enclose front portion. New side trellis and new railings on existing porches. ~~New pool and steps,~~ site work including partial site regrading. New mansard roof at rear to cover existing roof deck- **#1301 Whitehead Street- Tom Pope One Call Construction (H15-01-1528)**

**A motion was made by Commissioner Bender, seconded by Commissioner Powell, that the Action Item have staff approve to raise the existing house 2'-6" and all site work that is associated with the raise of the existing house. The rest of the items all be postponed. The motion carried by the following vote:**

**Yes:** 7 - Commissioner Bender, Commissioner Logan, Commissioner Moody, Commissioner Powell, Commissioner Shepler, Vice Chair McChesney, and Chairman Green

- 3 Demolition of rear addition walls. ~~Demolition of shed~~ **#1301 Whitehead Street- Tom Pope One Call Construction (H15-01-1528)**

**A motion was made by Commissioner Bender, seconded by Commissioner Moody, that the Action Item be Postponed. The motion carried by the following vote:**

**Yes:** 7 - Commissioner Bender, Commissioner Logan, Commissioner Moody, Commissioner Powell, Commissioner Shepler, Vice Chair McChesney, and Chairman Green

## New Business

- 4 New plans for a one-story wood frame single-family house with site improvements. Previous approved plans for the site included a two-story frame house- **#322 Amelia Street- William Shepler (17-03-0005)**

**A motion was made by Commissioner Bender, seconded by Commissioner Powell, that the Action Item be Approved. The motion carried by the following vote:**

**Recuse:** 1 - Commissioner Shepler

**Yes:** 6 - Commissioner Bender, Commissioner Logan, Commissioner Moody, Commissioner Powell, Vice Chair McChesney, and Chairman Green



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**Historic Architectural Review Commission  
Staff Report for Item 2**

**To:** Chairman Bryan Green and Historic Architectural Review  
Commission Members

**From:** Enid Torregrosa, MSHP  
Historic Preservation Planner

**Meeting Date:** March 28, 2017

**Applicant:** One Call Construction, Contractor

**Application Number:** H15-01-1528

**Address:** #1301 Whitehead Street

**\*Review of this project is under the old guidelines for additions, alterations, and new construction, as the Commission postponed the item on the February 23, 2016 meeting.**

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**Description of Work:**

~~Relocation~~, Elevation of historic house 2'-6" and modification to footers. New ~~side and rear~~ additions. New Relocate and elevate accessory structure and enclose front portion. New side trellis and new railings on existing porches. New ~~pool and steps~~, site work including partial site regrading. New mansard roof at rear to cover existing roof deck.

**Site Facts:**

The building under review, build circa 1912, is a contributing resource to the historic district. The building is located on the south corner of Whitehead and United Streets. The two-story frame structure has a one story front porch that wraps towards United Street, accentuating its corner setting. The house has dense vegetation, particularly towards Whitehead Street. The house sits on concrete piers and its first story finish floor is elevated approximately 2'-3/4" from grade.

By reviewing the Sanborn maps, there is evidence that on the back portion of the house there used to be a 20' tall water tower with a motor. The water tower is not depicted in the 1926 or subsequent Sanborn maps. Historically the house has had a one-story wrap porch, fronting Whitehead and United Streets. Two bay windows are located on the first floor,

each facing a street. The backside portion of the house also used to have a porch facing United Street. The southern back portion of the house has been a two-story structure at least since 1941; aerial photos taken by the Navy in 1941 are evidence of this fact. Currently the second floor addition bumps out from the first floor towards the east elevation.

By comparing the 1962 Sanborn map and the circa 1965 photo with a current survey, we found changes in the footprint of the house, particularly on the back portion of the house. The historic backside porch, facing United Street, is enclosed with a flush wall to the historic fabric. Other non-historic alterations include a second floor balcony with a roof deck, swimming pool, decks, and wooden fences. The Sanborn maps from 1926, 1948 and 1962 all depict an accessory structure, facing United Street, dedicated to a car. This structure still remains in the same location.

Adjacent structures are all residential by design and use, being the ones on its adjacent proximity historic and contributing structures, all two stories and two and a half stories frame structures. Across Whitehead Street, there is the Trumbo Annex Navy residential complex. The owners and applicant has stated that on a heavy rain, the entire site gets flooded and they need to protect their home.

#### **Guidelines and Ordinance Cited on Review:**

- Secretary of The Interior's Standards and Guidelines for Rehabilitation ( pages 16-23), specifically Standards 1, 2, 4, 9 and 10)
- Roofing (page 26), specifically guideline 3 and 4.
- Roof decks (page 28a), specifically first paragraph and guideline 1.
- Additions, alterations and new construction (pages 36-38a), specifically all guidelines on page 37, and guidelines 1, 2, 4, 5, and 6 of page 38a.
- Outbuildings (page 40-41), specifically guidelines 8, and 9.

#### **Staff Analysis**

The Certificate of Appropriateness in review is for a proposed two-story frame addition to be attached to the rear of a contributing structure; the new addition will have a mansard like roof that will hide an existing non-historic roof-deck. The design also includes the enclosure of the existing rear second floor porch. The plan also includes the elevation of the building, up to 4' - 8" at finished floor, due to flood issues. Another component of the design is the relocation of the existing carport, where the building will be setback approximately 19' from the street and will be very close to the proposed rear addition of the main house. The carport/ garage will no longer be used as such.

The proposed rear addition, side enclosure, and new mansard roof will be visible from United Street (guideline 5-p.37). Although the addition will be lower in height than the existing main house, its proposed mansard roof will obscure the rear roof-line, which is historic. The two-story new addition attached to the east facade will incorporate a porch

towards the southeast portion, at both levels, while having and enclosed facades towards the northeast and north sides of the house. The design proposes to keep a roof deck, which staff has not found any approvals for it; staff reviewed aerial photographs and in 1994, a two-story addition towards the northeast corner of the building can be seen. Still staff have questions as to when the roof-deck was approved and build. In order to disguise the inappropriate roof deck the design proposes a new mansard roof. According to the applicant, they will maintain the existing roof used as the deck, will trim portions of the north side and will remove existing railings.

The historic house is proposed to be elevated approximately 2'-6" from its current piers. This request is due to flooding problems that the owners had experienced during heavy rains. By raising the house, the main building will be approximately 4'-3" taller than the adjacent house on United Street and approximately 2'-7 1/2" taller than the adjacent house on Whitehead Street. On Whitehead Street and due to the height differences on the existing four houses there will be no major visual impact that will interfere with the essential form and the integrity of surrounding properties (guideline 2- p.38). The design includes regrading of the front and side yards in order to make the footers visually lower.

The proposed new addition will have two over two wood impact resistance windows and their exterior walls will have wood lap siding. All trims in the new addition will be made of wood and the new mansard roof will be finished with metal v-crimp.

The plan also includes the relocation of an existing carport/ garage that faces United Street. The renovated structure will be enclosed on its existing open sides and the front will receive a double wood door. The structure will be approximately two feet next to the proposed new rear addition to the house and will be slightly elevated from its actual level. The guidelines for outbuildings recognize repairs or restorations of pre-existing historically appropriate outbuildings. (guideline 8-p.40) According to the circa 1965 photograph the actual structure was really a garage, with a front double door.

The design also includes a new pool deck, re-grading of the lot, a new pergola, and entry door on the rear addition, and facing United Street. Because the house will be elevated, railings are proposed on the existing wrap-around porch as well as new stoops will be needed at the front elevation to access the front porch

### **Consistency with Guidelines**

It is staff's opinion that the project fails some of the cited guidelines. Staff opines that the proposed mansard roof over the rear addition is a foreign roof form; this type of roof is not found either on the historic house or on surrounding historic buildings.

Staff also finds that the relocation of the accessory structure will change the character of it, as it will be too close to the rear proposed addition, and reading almost as an adjoining structure. Although the front portion of the garage is altered, it is still an important element to the site. The garage was not original to the site but is historic as the 1926 Sanborn maps depict it for the first time. Staff understands the merits to setback the carport/garage in

order to create a usable driveway, and there is a desire from the owners to keep the form and character of the accessory structure.

It is staff's opinion that raising the house to the proposed height will have no adverse effect on the immediate surrounding context. The proposed trellis facing United Street is in keeping with the scale and mass and its proportions are sensible to the historic fabric.

- 7 Major Development Plan- New pavilion for a restaurant and refurbish of existing cable hut. New ramps for the proposed restaurant and for the hospitality house. Repairs to existing cable hut- **Mallory Square-Pike Architects (17-03-0008)**

A motion was made by Commissioner Moody, seconded by Commissioner Powell, that the Action Item be Denied. The motion carried by the following vote:

Yes: 7 - Commissioner Bender, Commissioner Moody, Commissioner Powell, Commissioner Shepler, Vice Chair McChesney, Chairman Green, and Commissioner Logan

- 8 Removal of non-historic portions of walls and roof of existing cable hut- **Mallory Square- Pike Architects (17-03-0008)**

This Action item was denied due to the Major Development Plan for item 7 being denied.

### Old Business

- 9 New rear additions with deck on the roof. Relocate and elevate accessory structure and enclose front portion. New side entry roof and new railings on existing porches. New steps and site work including partial site regrading. Enclosure of second floor existing rear side north porch - **#1301 Whitehead Street- One Call Construction (H15-01-1528)**

A motion was made by Commissioner Bender and seconded by Commissioner Powell, that the Rear Extension of the house be Denied due to Secretary of the Interior Standards Section 1 & 2, and to approve the work on the garage. The motion carried by the following vote:

No: 1 - Commissioner Logan

Yes: 6 - Commissioner Bender, Commissioner Moody, Commissioner Powell, Commissioner Shepler, Vice Chair McChesney, and Chairman Green

- 10 Demolition of rear wall -**#1301 Whitehead Street- One Call Construction (H15-01-1528)**

A motion was made by Commissioner Bender, seconded by Commissioner Powell, that the Action Item be Denied. The motion carried by the following vote:

Yes: 7 - Commissioner Bender, Commissioner Moody, Commissioner Powell, Commissioner Shepler, Vice Chair McChesney, Chairman Green, and Commissioner Logan

### Comments from Commissioner's



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**Historic Architectural Review Commission  
Staff Report for Item 9**

**To:** Chairman Bryan Green and Historic Architectural Review  
Commission Members

**From:** Enid Torregrosa, MSHP  
Historic Preservation Planner

**Meeting Date:** May 23, 2017

**Applicant:** One Call Construction, Contractor

**Application Number:** H15-01-1528

**Address:** #1301 Whitehead Street

**\*Review of this project is under the old guidelines for additions, alterations, and new construction, as the Commission postponed the item on the February 23, 2016 meeting.**

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**Description of Work:**

New rear additions with deck on the roof. Relocate and elevate accessory structure and enclose front portion. New side entry roof and new railings on existing porches. New steps and site work including partial site regrading. Enclosure of second floor existing rear side north porch.

**Site Facts:**

The building under review, build circa 1912, is a contributing resource to the historic district. The building is located on the south corner of Whitehead and United Streets. The two-story frame structure has a one story front porch that wraps towards United Street, accentuating its corner setting. The house has dense vegetation, particularly towards Whitehead Street. The house sits on concrete piers and its first story finish floor is elevated approximately 2'-3/4" from grade.

By reviewing the Sanborn maps, there is evidence that on the back portion of the house there used to be a 20' tall water tower with a motor. The water tower is not depicted in the 1926 or subsequent Sanborn maps. The existing one-story wrap porch, fronting Whitehead and United Streets is an original feature of the house. Two bay windows are located on the first floor, each facing a street. The backside portion of the house also used to have a porch

facing United Street. The southern back portion of the house has been a two-story structure at least since 1941; aerial photos taken by the Navy in 1941 are evidence of this fact. Currently the second floor addition bumps out from the first floor towards the east elevation.

By comparing the 1962 Sanborn map and the circa 1965 photo with a current survey, we found changes in the footprint of the house, particularly on the back portion of the house. The historic northeast porch, facing United Street, was enclosed with a flush wall to the historic fabric. Other non-historic alterations include a second floor balcony with a roof deck, swimming pool, decks, and wooden fences. The Sanborn maps from 1926, 1948 and 1962 all depict an accessory structure, facing United Street, dedicated to a car. This structure, although altered, remains in the same location. According to the circa 1965 photograph the actual structure was a garage, with a front double door.

Adjacent structures are all residential by design and use, being the ones on its adjacent proximity historic and contributing structures, all two stories and two and a half stories frame structures. Across Whitehead Street, there is the Trumbo Annex Navy residential complex. The owners have stated that on a heavy rain, the entire site gets flooded and they need to protect their home.

#### **Guidelines and Ordinance Cited on Review:**

- US Secretary of the Interior's Standards and Guidelines for Rehabilitation (pages 16-23), specifically Standards 1, 2, 4, 9 and 10.
- Roof decks (page 28a), specifically first paragraph, and guideline 1.
- Entrances, porches and doors (pages 32-33), specifically guideline 8, for proposed new entry porch facing United Street.
- Additions, alterations and new construction (pages 36-38a), specifically all guidelines on page 37, and guidelines 1, 4, 5, and 6. For the relocation of the accessory structure guideline 1 page 38, second sentence.
- Outbuildings (page 40-41), specifically guideline 8 of page 40.

#### **Staff Analysis**

The Certificate of Appropriateness in review is for a proposed one-story frame addition attached to the southeast portion of a contributing structure. The new addition will have a small roof deck that will be accessible from a second floor master bedroom. The design also includes the expansion in footprint of the northwest portion of the house, which is the latest addition to the house. The proposed changes to the northeast includes the enclosure of the second floor porch, having the wall that will face United Street been setback 6" from the north wall of the main house. Nevertheless, the plans depict an increase of the footprint towards the east portion of the house at both stories; enlarging the existing massing of the non-historic portion of the house. It is evident that the existing second floor porch and its roof deck, which faces United Street, are rudimentary in nature, and they are not appropriate to the historic fabric. The proposed new addition will have two over two wood

impact resistance windows and their exterior walls will have wood lap siding. All trims in the new addition will be made of wood.

The design proposes to keep a roof deck with existing not-to-code railings, for which staff has not found any approvals for its construction; staff reviewed aerial photographs and in 1994, a two-story addition towards the northeast corner of the building is visible. Still, staff has questions as to when HARC reviewed and approved the roof-deck. According to the applicant, they are not going to do anything to the existing roof deck nor the railings.

Another component of the design is the relocation of the existing carport. The accessory structure is proposed to be moved 5 feet from the street side property line and 8 feet from the rear property boundary. As previously mentioned, portions of the existing carport, are still historic; the front gable and columns are not original to the structure. The plan depicts a small increase in height for the accessory structure, through elevating its foundations. The structure will not be a garage.

The design also includes a new pool deck, re-grading of the lot, a new entry porch with a door on the rear addition, and facing United Street. The proposed entry porch roof seems out of scale and proportions with the existing side elevation, and it reads as prominent as character defining elements in the north façade, like a bay window and the wrap porch.

On March 28, 2017, the Commission approved for staff to review the proposed elevation of the building, up to 4'- 8" at finished floor, due to flood issues. As part of the Commission's motion on that specific meeting was for staff to approve site regarding related to the increase in height of the footings. This was a motion approved as a request from the owner of the house that urged the Commission to consider this specific issue. Still, in conversations with staff after the meeting the owner explained that elevating the house at this point without approvals of any additions did not work for him.

### **Consistency with Guidelines**

It is staff's opinion that the project fails many of the cited guidelines as well as the US Secretary of the Interior Standards and Guidelines. Staff opines that the actual second floor porch that faces United Street negatively affects the symmetry and proportions of the historic building; the proposed enclosure and expansion will create a volume that does not protect the integrity of the property and its environment. As mentioned by the owner in the last meeting, this portion of the house is an eyesore; expanding it and making it a volume attached to the historic house will perpetuate and accentuate a non-sensible addition.


Staff finds that the relocation of the accessory structure and its renovation by enclosing the front portion and adding a pair of doors will bring back the structure to a similar historic configuration. The structure is an important element to the site even though the front portion is altered. The garage was not original to the site but is historic as the 1926 Sanborn

maps depict it for the first time. The design promotes the preservation of the form and character of the accessory structure.

The proposed gable entry roof facing United Street detracts from character defining elements such as the bay window and wrap porch that faces the street, location, proportions, and form are incompatible with those elements.

Boundary Survey Map of Part of Lot 2, Square 3, Tract 16  
Island of Key West, Florida


# 1301 Whitehead

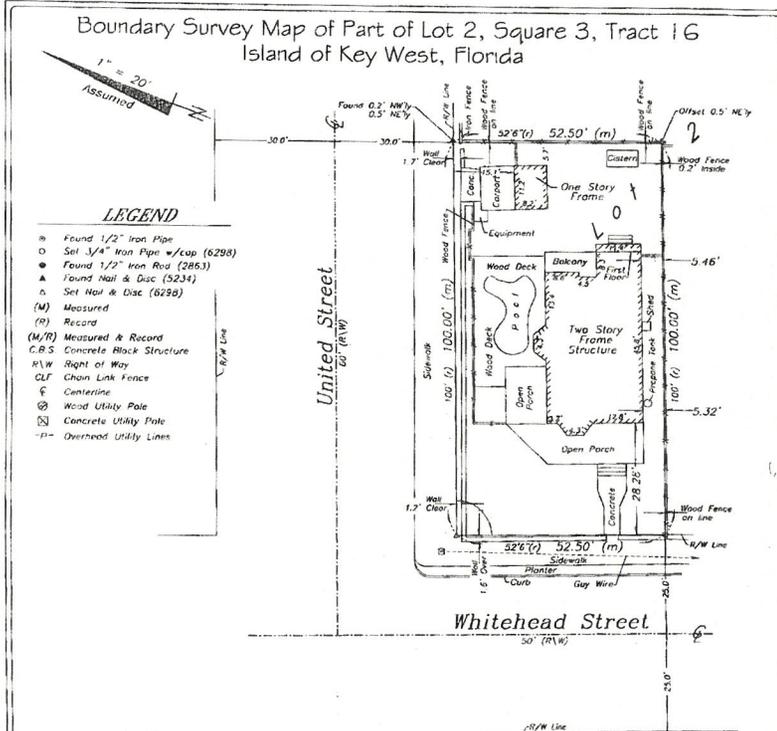

SHEET INDEX	
ID	Name
A-1	Cover Sheet
A-2	Site Information
A-3	Site Plan Existing Proposed
A-4	Existing Proposed
A-5	Whitehead St. Scale Elevation
A-6	United Scale Elevation
A-7	Proposed Sections
A-8	Existing Elevations
A-9	Perspective 1 Existing Trees
A-10	Perspective 1 No Trees
A-11	Perspective 2 Existing Trees
A-12	Perspective 2 No Trees
A-13	Rear View
A-14	Aerial View
A-15	Proposed Interior Layout
A-16	Accessory structure
A-17	Existing Floor plans

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## 1301 WHITEHEAD

**Owner**  
**Peter Janker**

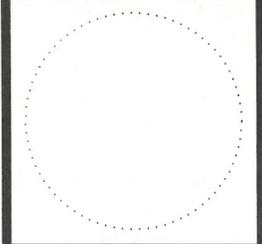PROJECT NO: #Pin  
DATE: 5/12/2017  
DRAWN BY: Gonz  
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**Cover Sheet**

**A-1**  
SHEET 1 OF 17



- NOTES:**
- The legal description shown hereon was furnished by the client or their agent.
  - Underground foundations and utilities were not located.
  - All angles are 90° (Measured & Record) unless otherwise noted.
  - Street address: 1301 Whitehead Street, Key West, FL.
  - This survey is not valid without the signature and the original raised seal of a Florida licensed surveyor and mapper.
  - Lands shown hereon were not abstracted for rights-of-way, easements, ownership, or other instruments of record.
  - North Arrow is assumed and based on the legal description.
  - Date of field work: October 11, 2011.
  - Ownership of fences is undeterminable, unless otherwise noted.
  - Adjoiners are not furnished.

**BOUNDARY SURVEY OF:** On the Island of Key West and known as Part of Lot 2, Square 3, Tract 16 of the Northwestern one-half of Lot 2, better described by metes and bounds as follows:  
**COMMENCING** at the intersection of the United Street and the Northwestern right of way line of Whitehead Street, said point of intersection to be the Point of Beginning of the parcel of land hereinafter described; thence run in a Southeasterly direction along the Northeasterly right of way of Whitehead Street 52 feet 6 inches in a point; thence run at a right angle in a Northeasterly direction 100 feet to a point; thence run at a right angle in a Northeasterly direction 52 feet 6 inches out to United Street, thence run at a right angle in a Southwesterly direction along the Southeasterly right of way of United Street 100 feet back to the Point of Beginning of the parcel of land herein described.

**BOUNDARY SURVEY FOR:** Peter S. Janker & Dixie L. Janker.  
BNC National Bank;  
Stones & Cardenas;  
Old Republic National Title Insurance Co.

J. LYNN O'FLYNN, INC.  
J. Lynn O'Flynn, PSM  
Florida Reg. #6298  
October 17, 2011

THIS SURVEY  
IS NOT  
ASSIGNABLE

J. LYNN O'FLYNN, Inc.  
Professional Surveyor & Mapper  
P.S.M. #6298  
3430 Duck Ave., Key West, FL 33040  
(305) 296-7422 FAX (305) 296-2244

SITE DATA:

TOTAL SITE AREA: ± 5,250.00 SQ.FT  
LAND USE: HDRR  
FLOOD ZONE: AE-8

MAXIMUM IMPERVIOUS SURFACE RATIO:

REQUIRED: 60% (3,150.00 SQ.FT)  
EXISTING: 51.63% (±2,712.67 SQ.FT)  
PROPOSED: 56.36% (±2,959.00 SQ.FT)

MAXIMUM BUILDING COVERAGE:

REQUIRED: 50% (2,625 SQ.FT)  
EXISTING: 29.83% (±1,567.20 SQ.FT)  
PROPOSED: 35.83% (±1,881 SQ.FT)

OPEN SPACE MINIMUM:

REQUIRED: 35% (1,837.50 SQ.FT)  
EXISTING: 51.63% (±2,712.67 SQ.FT)  
PROPOSED: 42.85% (±2,249 SQ.FT)

SETBACKS:

FRONT:  
REQUIRED: 10'-0"  
EXISTING: ±17'-11" (TO PORCH)  
PROPOSED: ±17'-11" (TO PORCH)

SIDE:  
REQUIRED: 5'-0"  
EXISTING: ±19'-9" (TO BUILDING)  
PROPOSED: ±5'-0" (TO PORCH)

SIDE:  
REQUIRED: 5'-3"  
EXISTING: ±5'-4" (TO BUILDING)  
PROPOSED: ±5'-3" (TO BUILDING)

REAR:  
REQUIRED: 20'-0"  
EXISTING: ±26'-1" (TO BUILDING)  
PROPOSED: ±20'-0" (TO BUILDING)

MAXIMUM HEIGHT:




EXISTING: ±30.0' (TO CRWON OF ROAD)  
PROPOSED: ±33.0' (TO CROWN OF ROAD)

ACCESSOTY STRUCTURE:

REAR SETBACK: 20'-0"  
WIDTH OF LOT: 52.50'  
AREA: 1050 SQ.FT

DIMS. OF STRUCT. 11'-3" x 16'-1/2"  
AREA OF STRUCT. 249 SQ.FT


ALLOWABLE ACC. STRUCT. 30% (315.00 SQ. FT)  
EXISTING 23.02% (241.67 SQ. FT)  
PROPOSED 27.71% (249.00 SQ. FT)

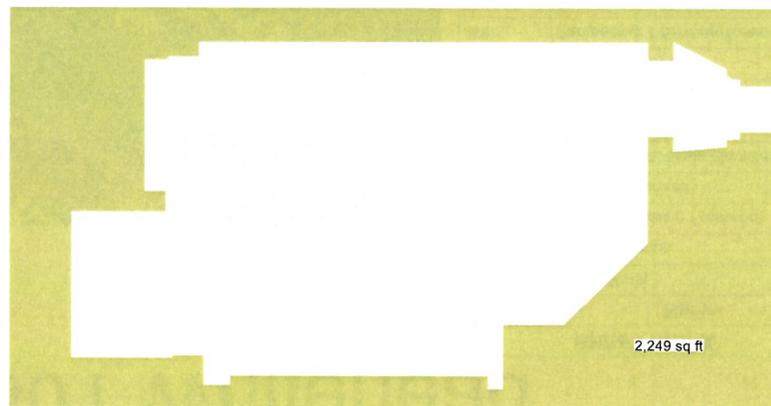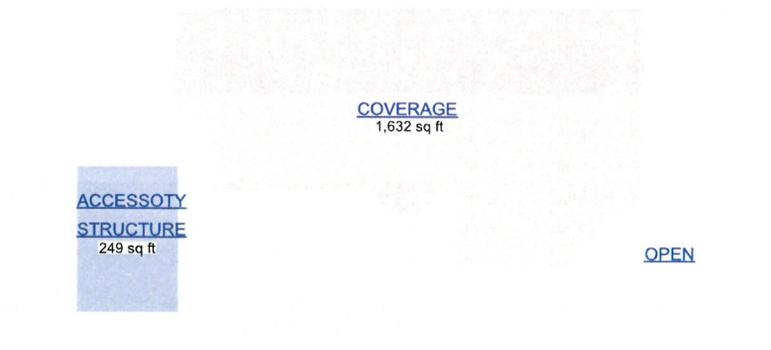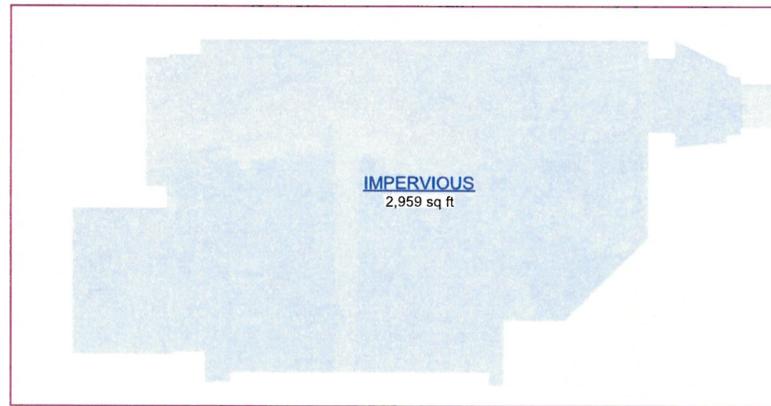

SCALE: 1/16" = 1'-0"

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**1301  
WHITEHEAD**

**Owner  
Peter Janker**

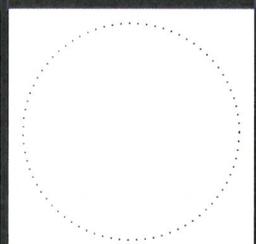PROJECT NO: #PIn



DATE: 5/12/2017

DRAWN BY: Gonz


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**Site  
Information**

**A-2**  
SHEET 2 OF 17

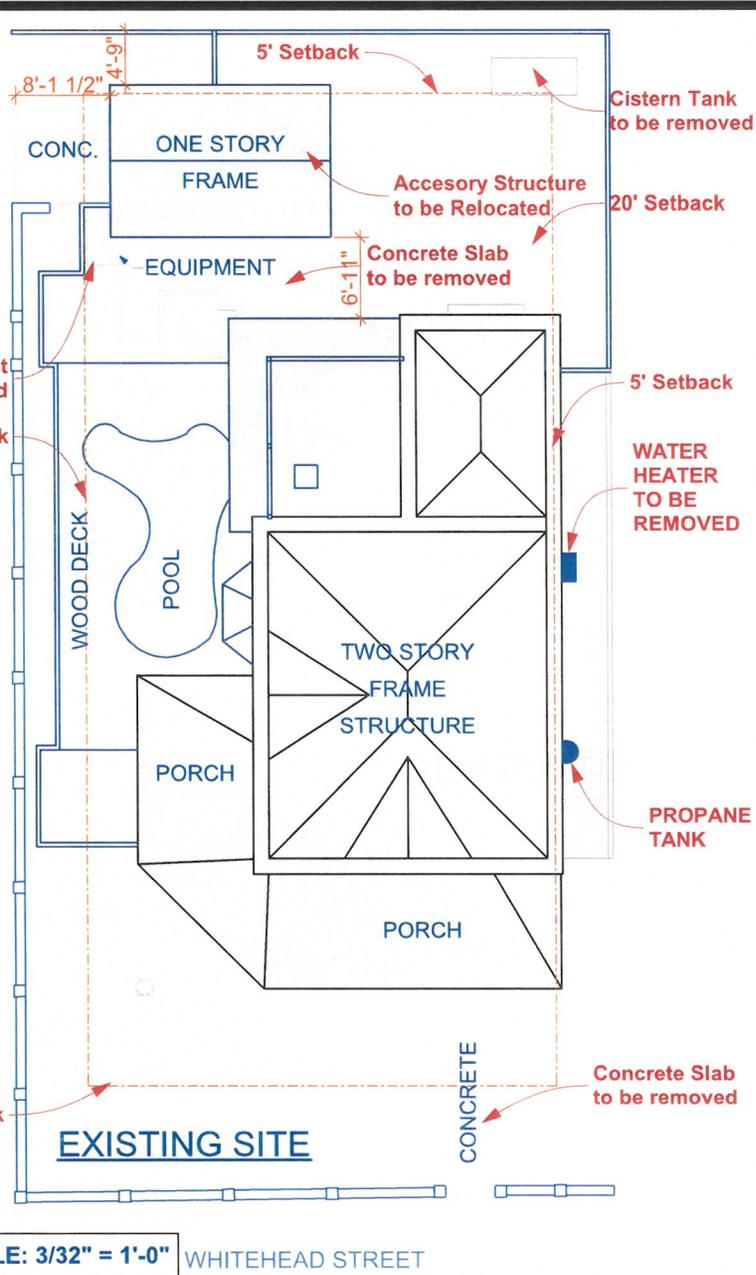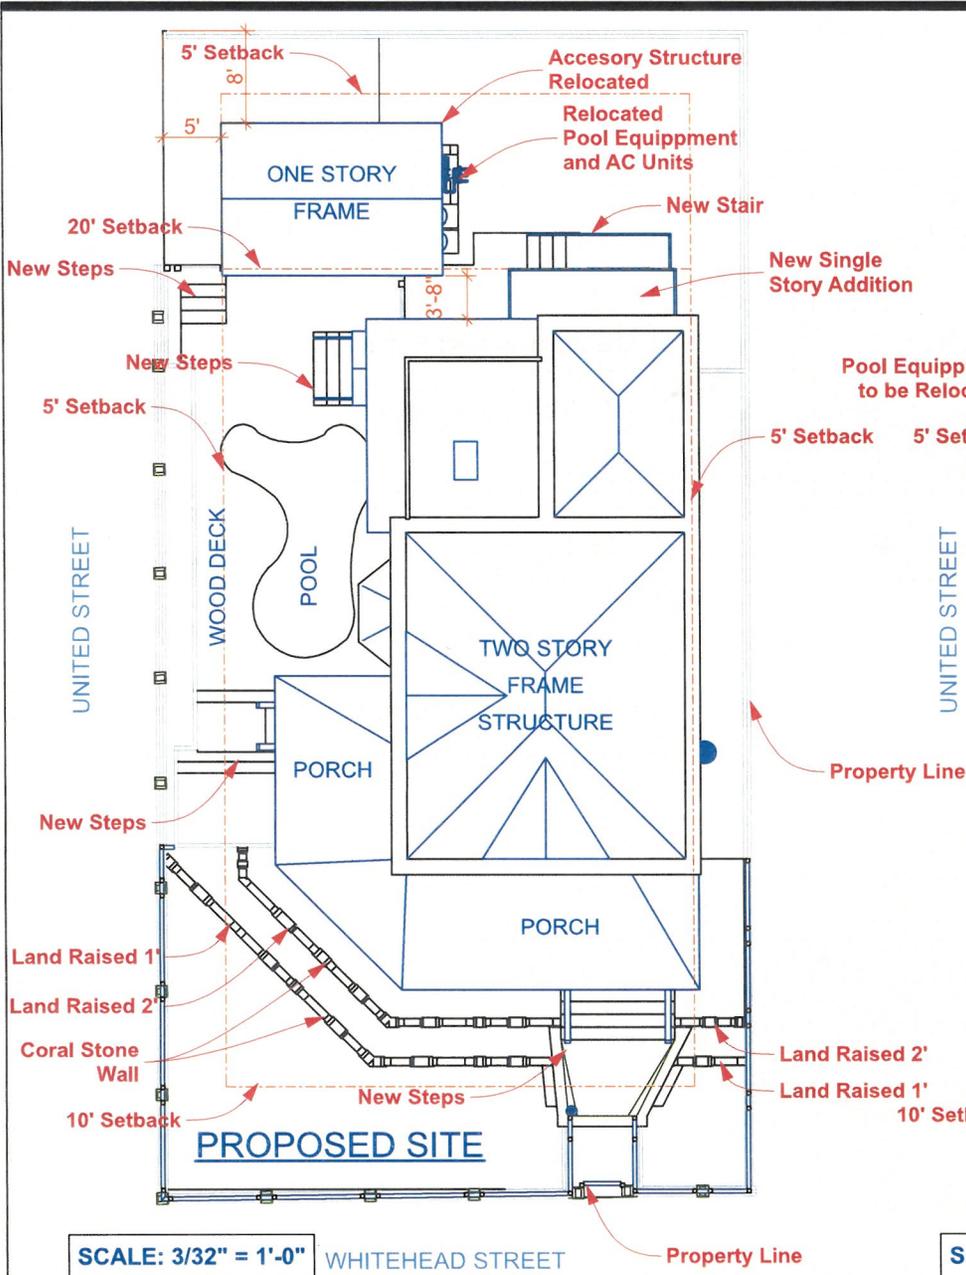

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**1301 WHITEHEAD**

**Owner Peter Janker**

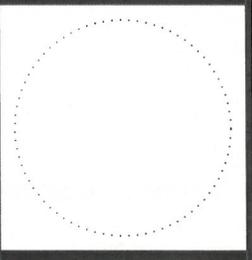PROJECT NO: #Pin  
 DATE: 5/12/2017  
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**Site Plan Existing Proposed**

**A-3**  
 SHEET 3 OF 17



EXISTING



PROPOSED

MATERIAL SELECTION

-FIBER CEMENT SIDING AND TRIM

-WOOD DECKING

-WOOD LATTICE

-WINDOWS:

-WOOD HARC APPROVED HIGH IMPACT, FOR EXISTING HOUSE

-CGI ALUMINIUM, IMPACT RATED, ALUMINUM FRAME, FOR NEW ADDITION

-LANDSCAPE:

-3/4" BLUE RIVER CRUSHED STONE

-RAILING:


-ALUMINUM FRAME, STAINLESS STEEL WIRES, FOR NEW ADDITION

-WOOD BALAUSTRES FOR HISTORIC SIDE

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**Owner**  
**Peter Janker**

PROJECT NO: **#Pin**

DATE: **5/12/2017**

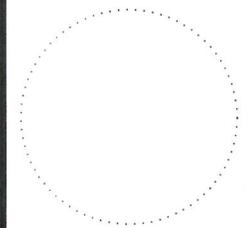
DRAWN BY: **Gonz**

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**Existing**  
**Proposed**

**A-4**

SHEET 4 OF 17

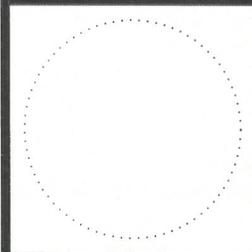

**1301  
WHITEHEAD**

**Owner  
Peter Janker**

PROJECT NO: #Pin  
 DATE: 5/12/2017  
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**Whitehead St.  
Scale Elevation**




**Existing Whitehead St. Streetscape**

SCALE: 3/32" = 1'-0"



**Proposed Whitehead St. Streetscape**

SCALE: 3/32" = 1'-0"

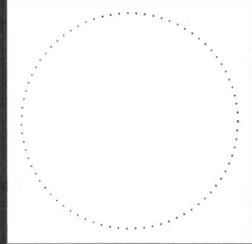

**1301**  
**WHITEHEAD**

**Owner**  
**Peter Janker**

PROJECT NO: #PIn  
 DATE: 5/12/2017  
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**United Scale**  
**Elevation**

**A-6**

SHEET 6 OF 17



406 UNITED

**Existing United St. Streetscape**  
 SCALE: 3/32" = 1'-0"



406 UNITED

**Proposed United St. Streetscape**  
 SCALE: 3/32" = 1'-0"




Rear Proposed Elevation

SCALE: 1/16" = 1'-0"



United St. (Side) Proposed Elevation

SCALE: 1/16" = 1'-0"

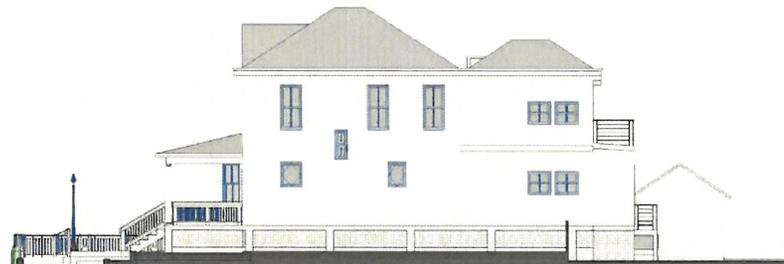


Side Proposed Elevation

SCALE: 1/16" = 1'-0"



Whitehead St (Front) Proposed Elevation


SCALE: 1/16" = 1'-0"

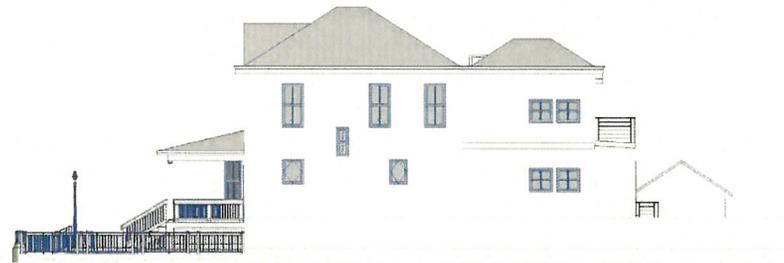

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**Proposed**  
**Sections**

**A-7**

SHEET 7 OF 17

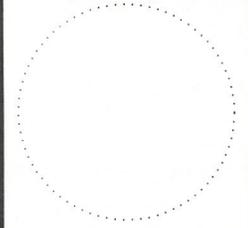

United St. (Side) Existing Elevation  
SCALE: 3/32" = 1'-0"



Whitehead St (Front) Existing Elevation  
SCALE: 3/32" = 1'-0"




Side Existing Elevation  
SCALE: 3/32" = 1'-0"



Rear Existing Elevation  
SCALE: 3/32" = 1'-0"

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PROJECT NO: #PIn

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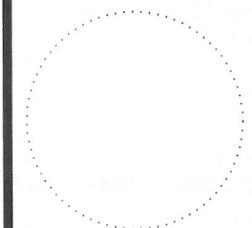
**Existing**  
**Elevations**

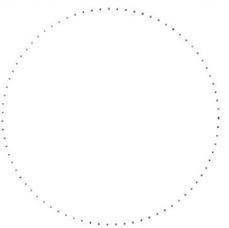**A-8**  
SHEET 8 OF 17



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WHITEHEAD**

**Owner  
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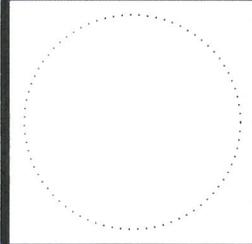
**Perspective 1  
Existing Trees**

**A-9**  
SHEET 9 OF 17



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**Perspective 1  
No Trees**


**A-10**

SHEET 10 OF 17




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**WHITEHEAD**

**Owner**  
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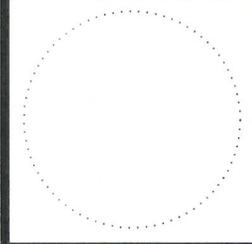
**Perspective 2**  
**Existing Trees**

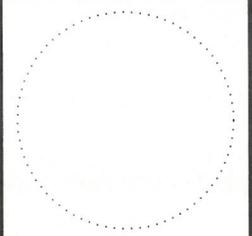**A-11**  
 SHEET 11 OF 17



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**1301**  
**WHITEHEAD**

**Owner**  
**Peter Janker**

PROJECT NO: **#P1n**


DATE: **5/12/2017**

DRAWN BY: **Gonz**

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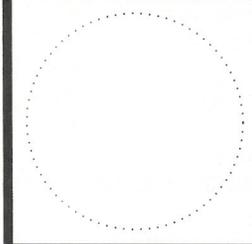
**Perspective 2**  
**No Trees**

**A-12**  
SHEET 12 OF 17

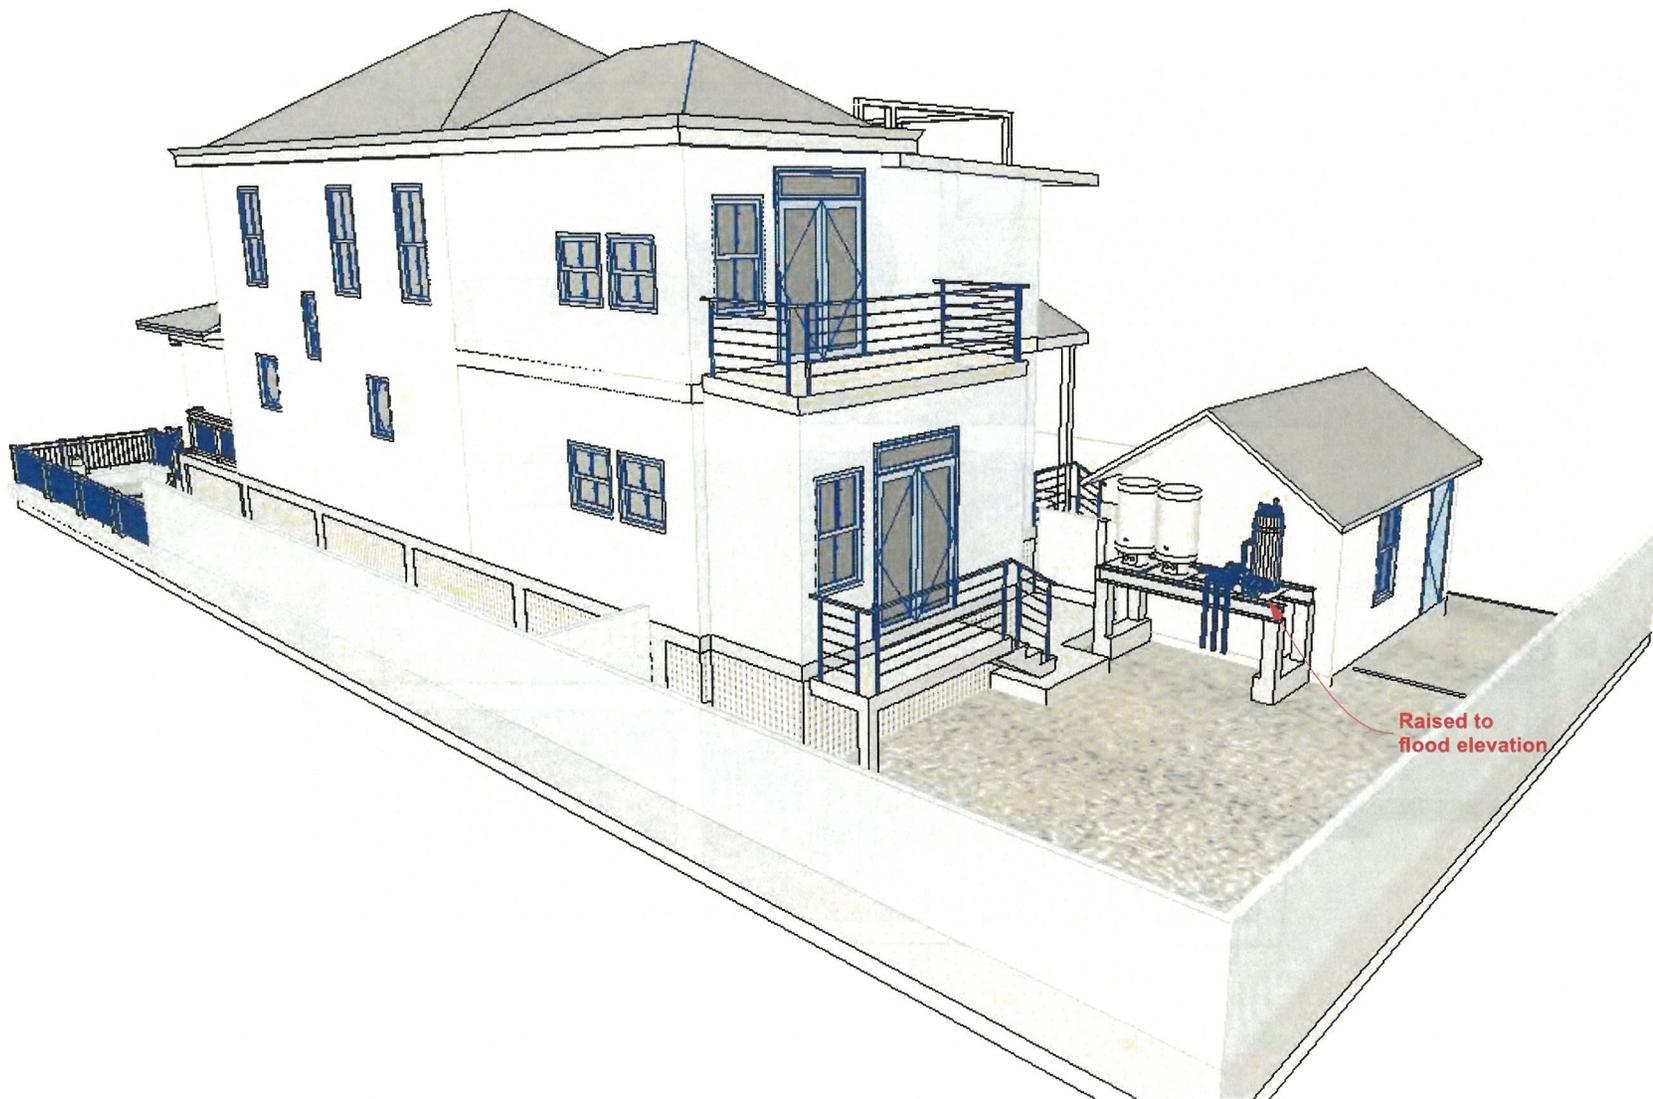


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**1301  
WHITEHEAD**

**Owner  
Peter Janker**


PROJECT NO: #PIn  
 DATE: 5/12/2017  
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**Rear View**

**A-13**

SHEET 13 OF 17



**1301  
WHITEHEAD**

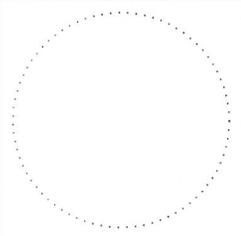**Owner  
Peter Janker**

PROJECT NO: #PIn

DATE: 5/12/2017


DRAWN BY: Gonz


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**Aerial View**

**A-14**

SHEET 14 OF 17



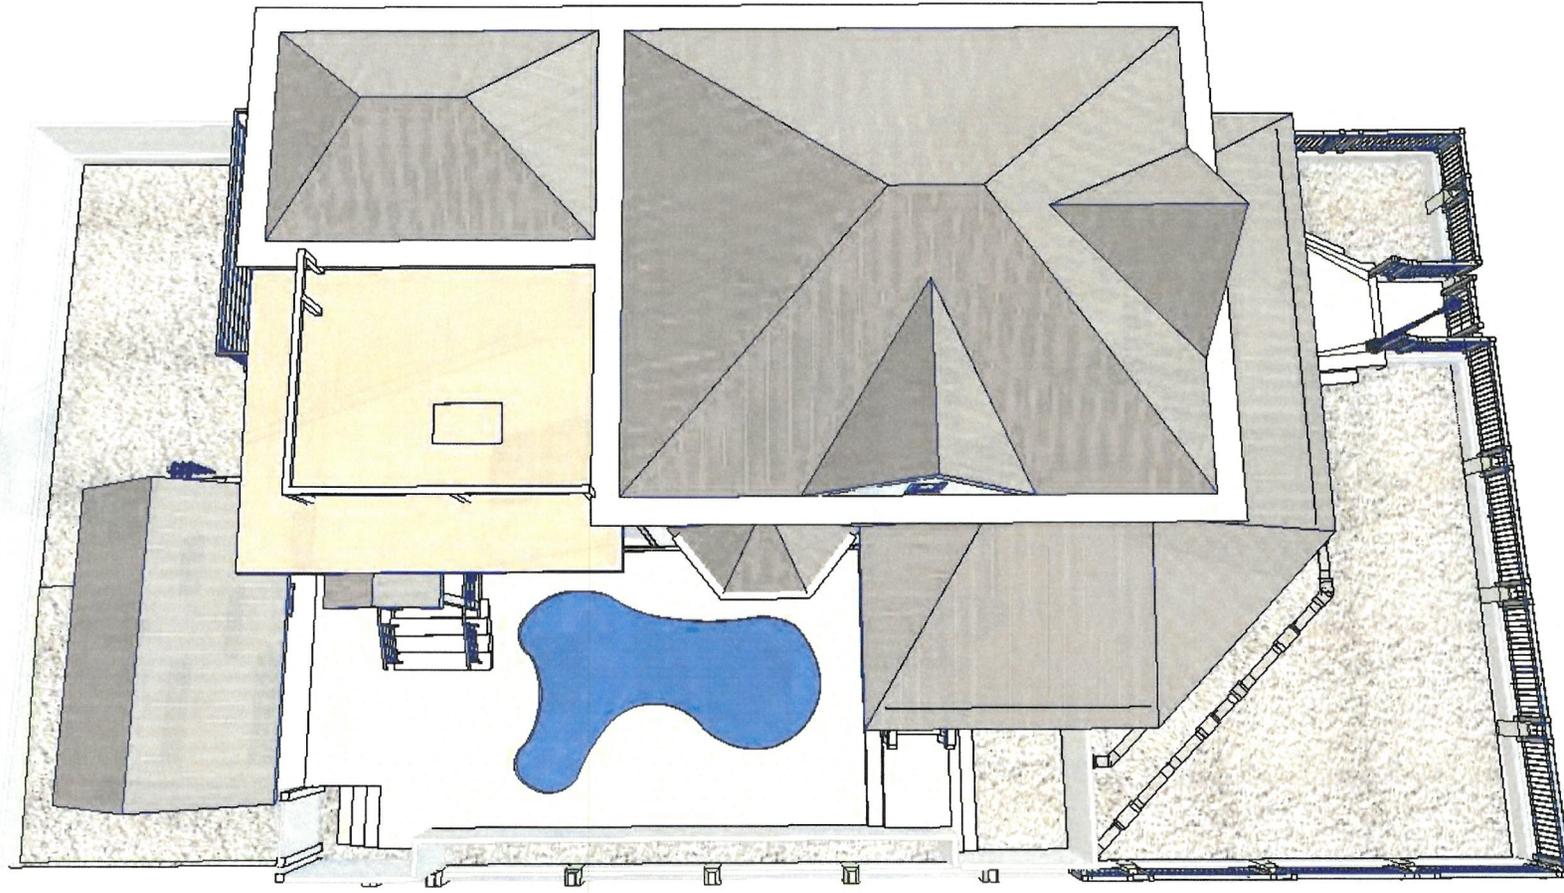

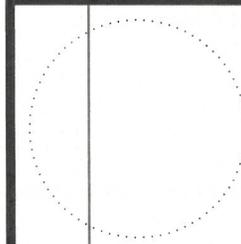**1301  
 WHITEHEAD**

**Owner  
 Peter Janker**


PROJECT NO: #Pln  
 DATE: 5/12/2017  
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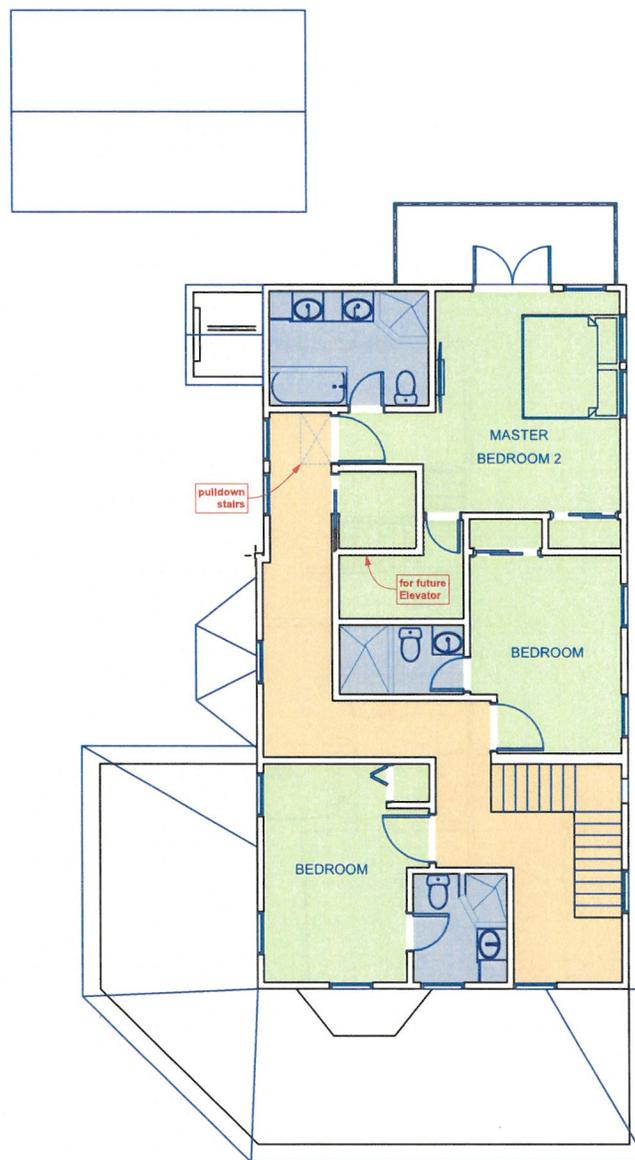
**Proposed  
 Interior Layout**

**A-15**


SHEET 15 OF 17



**1st FLOOR**  
**SCALE: 1/8" = 1'-0"**

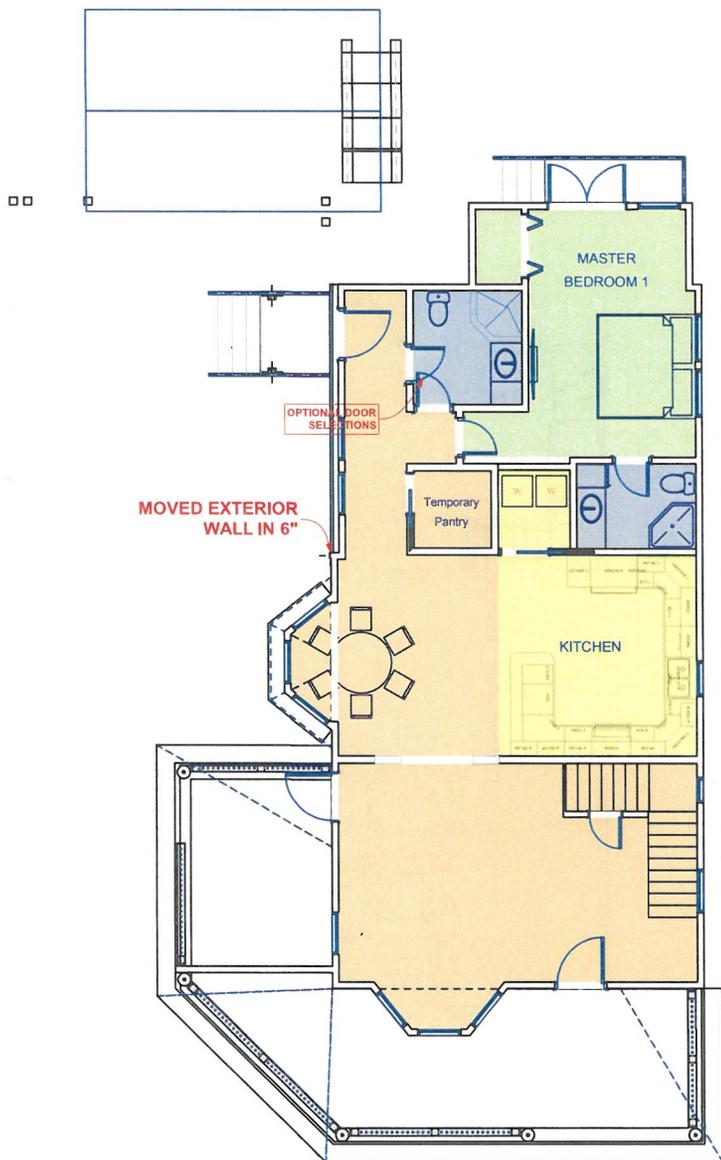

**2nd FLOOR**  
**SCALE: 1/8" = 1'-0"**

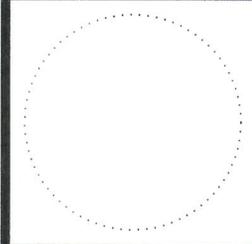

**1301  
 WHITEHEAD**


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 Peter Janker**

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**Existing Floor  
 plans**


**A-17**  
 SHEET 17 OF 17



**EXISTING FIRST FLOOR PLAN**

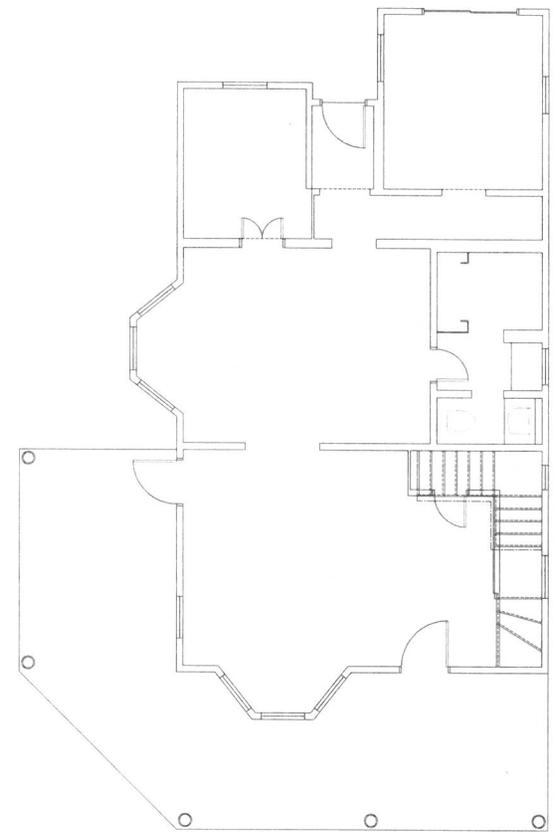**1**



SCALE: 1/8" = 1'-0"

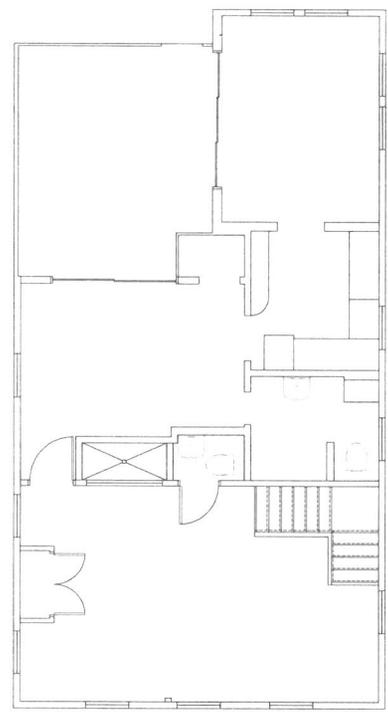

**EXISTING SECOND FLOOR PLAN**


**2**

SCALE: 1/8" = 1'-0"

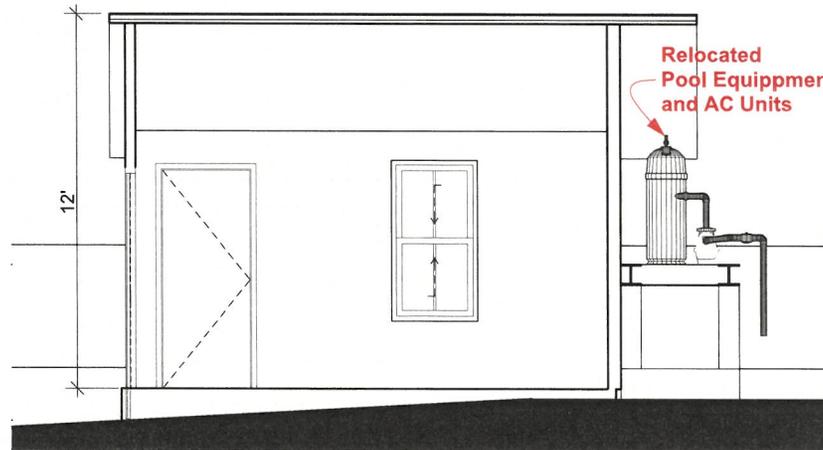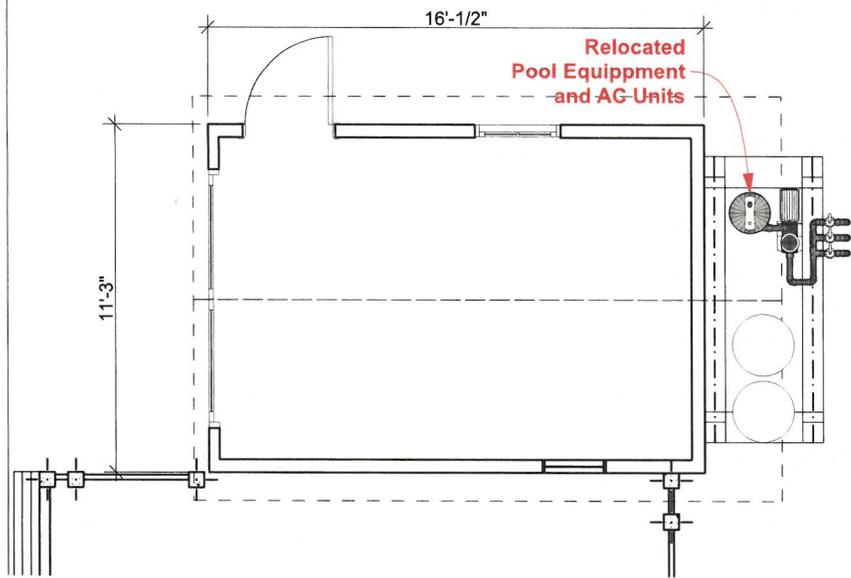


**1** SHED FLOORPLAN  
SCALE: 1/4" = 1'-0"

**2** SHED SECTION  
SCALE: 1/4" = 1'-0"

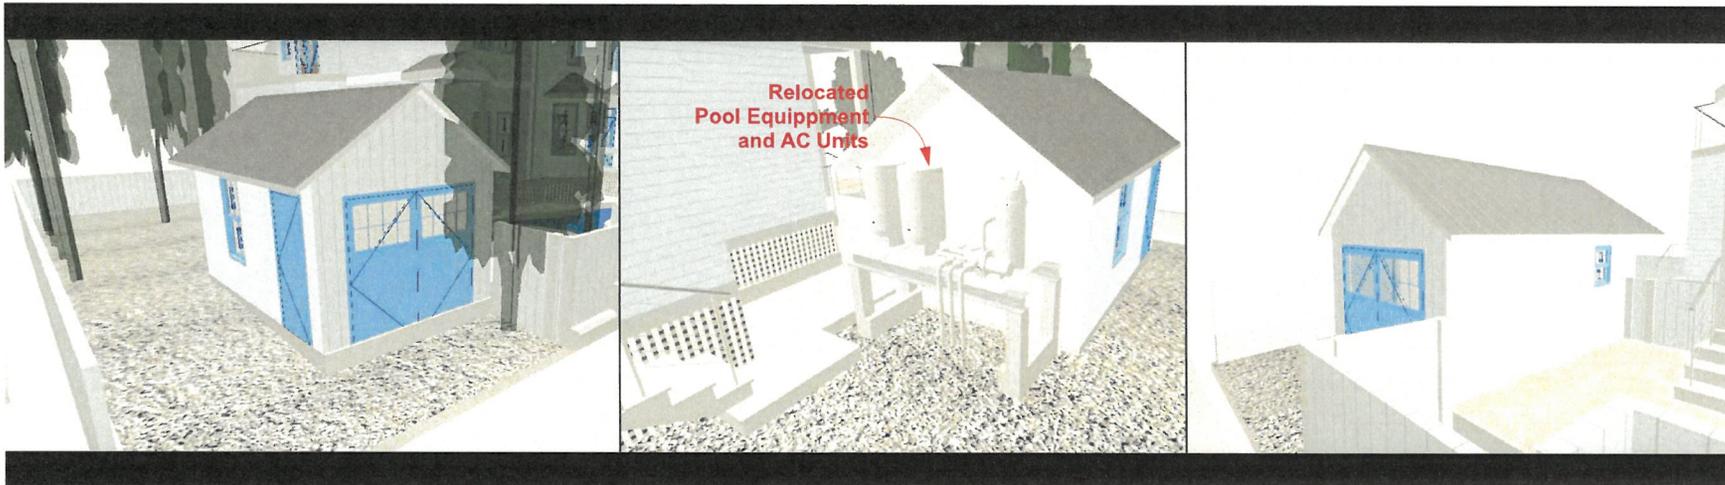

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**Accessory**  
**structure**

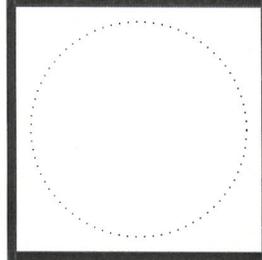**A-16**  
SHEET 16 OF 17



# City of Key West, FL

City Hall  
1300 White Street  
Key West FL 33040

## Action Minutes - Final

### Historic Architectural Review Commission

---

Monday, July 1, 2024

5:00 PM

City Hall

---

#### Special Meeting

**ADA Assistance:** It is the policy of the City of Key West to comply with all requirements of the Americans with Disabilities Act (ADA). Please call the TTY number 1-800-955-8771 or for voice 1-800-955-8770 or the ADA Coordinator at 305-809-3811 at least five business days in advance for sign language interpreters, assistive listening devices, or materials in accessible format.

**FOR VISUAL PRESENTATIONS:** For City Commission meetings the City Clerk's Office will need a copy of all presentations for the agenda at least 7 days before the meeting.

**Call Meeting To Order - 5:00 P.M.**

#### Roll Call

**Absent** 1 - Commissioner Osborn

**Present** 5 - Commissioner Green, Commissioner Nations, Commissioner Oropeza, Commissioner Thompson, and Chairman Burkee

#### Pledge of Allegiance to the Flag

**Approval of Agenda - The agenda was unanimously approved as presented.**

#### Administering the Oath by the Clerk of the Commission

#### Action Items

- 1 Elevating a historic house an additional 1'-3" from previously approved 2'-6" to meet future FEMA flood maps - **#1301 Whitehead Street - Peter Janker (H2024-0031)**

**Attachments:** [\\*Large File\\* 1301 Whitehead Street](#)

**A motion was made by Commissioner Oropeza, seconded by Commissioner Nations, to approve the Action Item by modifying the 2017 HARC approval with an extra 1'3" in height, with staff to approve the final design strategies for mitigating footers, design of footers, and future guardrails. The motion carried by the following vote:**

**No:** 1 - Commissioner Thompson

**Absent:** 1 - Commissioner Osborn

**Yes:** 4 - Commissioner Green, Commissioner Nations, Commissioner Oropeza, and  
Chairman Burkee

## Reports

**Adjournment - 5:45 P.M.**



---

## Historic Architectural Review Commission Staff Report for Item 1

To: Chairman Haven Burkee and Historic Architectural Review  
Commission Members

From: Enid Torregrosa-Silva, MSHP  
Historic Preservation Planner

Meeting Date: July 1st, 2024

Applicant: Peter Janker, Owner

Application Number: H2024-0031

Address: 1301 Whitehead Street

### **Description of Work:**

Elevating a historic house an additional 1'-3" from previously approved 2'-6" to meet future FEMA flood maps.

**For this application the owner submitted a copy of the 2017 plans with many elements that were denied by this Commission. The scope of work that the applicant included under the detailed project description includes elements that were not disclosed to staff during pre-application meeting and are contained on the denied plans. During pre-application meeting with staff the applicant did not brought any document, including plans or application.**


### **Site Facts:**

The site under review is located on the south corner of Whitehead and United Streets. The site consists of a principal historic frame vernacular house built circa 1912 and a carport that faces United Street. The historic house is a contributing resource to the historic district. The two-story frame structure has a one-story front porch that wraps towards United Street, accentuating its

corner setting. The house has dense vegetation, particularly towards Whitehead Street. The house sits on concrete piers and its first story finish floor is elevated approximately 2'-3/4" from grade.

By comparing the 1962 Sanborn map and the survey, we found changes in the footprint of the house, particularly on the back north side of the house. The historic backside porch, facing United Street, is enclosed with a flush wall to the historic fabric. Other non-historic alterations include a second-floor balcony with a roof deck, swimming pool, decks, and wooden fences. The Sanborn maps from 1926, 1948 and 1962 all depict an accessory structure, facing United Street, dedicated to one car. This structure remains in the same location.

Adjacent structures are all residential by design and use, being the ones on its adjacent proximity historic and contributing structures, all two stories and two and a half stories frame structures. Across Whitehead Street, there is the Trumbo Annex Navy residential complex. The owners and applicant stated that during heavy rains, the entire site gets flooded.

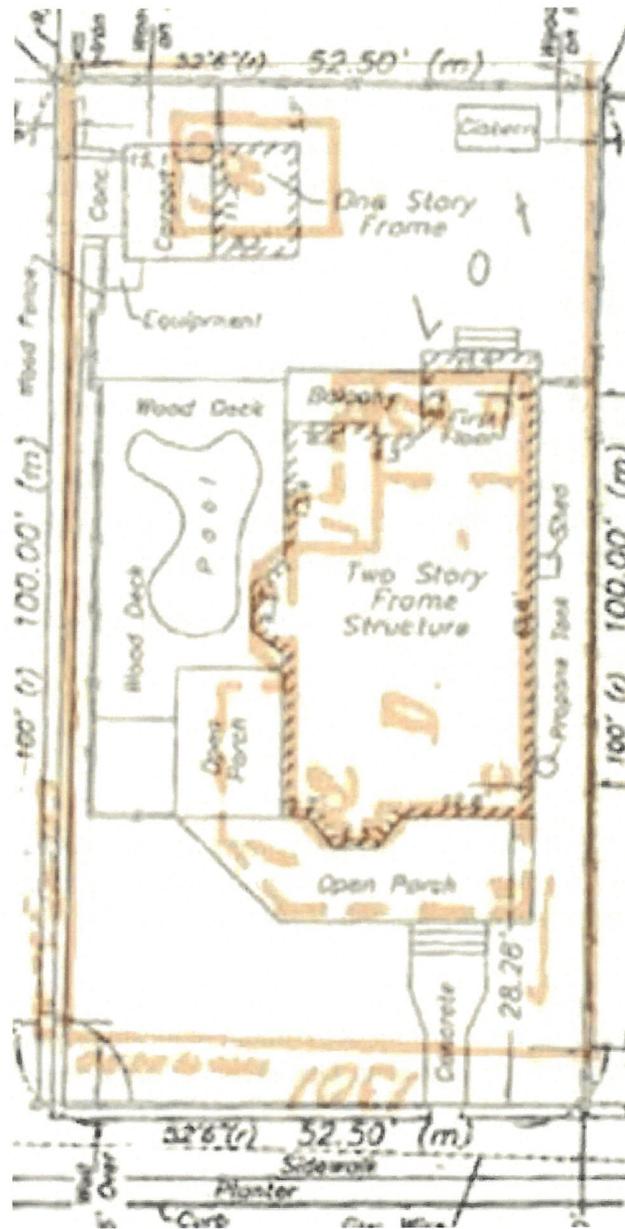

1962 Sanborn map and survey

### **Case history:**

On February 23, 2016, architect Thomas Pope presented plans for *Relocation, elevation of historic house and modification to footers. New side and rear additions. New accessory structure. New pool and site work including partial side regrading. Demolition of rear additions. Demolition of shed.* (H15-01-1528). The application was postponed by unanimous vote.

A year after the postponement staff received on February 23, 2017, an application with revised plans and scope of work from One Call Construction for the following scope of work: *Raise existing structure to 9' an increase of approximately 2'-6"*, relocate and elevate accessory building and enclose front portion. *New rear addition, new side trellis and porch area, embellish house with rails as needed per life safety, add lattice around base and raise grade.* On March 28, 2017, the commissioners unanimously postponed the item, but approved for staff to raise the house 2'-6" and all site work that is associated with the raise of the existing house. The rest of the items all be postponed.

On May 23, 2017, the Commission review modified plans for, *New rear additions with deck on the roof. Relocate and elevate accessory structure and enclose front portion. New side entry roof and new railings on existing porches. New steps and site work including partial site regrading. Enclosure of second-floor existing rear side north porch. Demolition of rear wall.* The Commission denied the proposed project, finding it inconsistent with Secretary of the Interior's Standards 1 and 2 but approved the proposed work on the garage.

On March 12, 2019, HARC staff approved with the following conditions a certificate of appropriateness under BLD2018-00002757;

*Enid Torregrosa*

08-  
HARC

*Conditions:*

*HARC NOTE: Only for raising the accessory structure with new footings up to two feet and three quarters of an inch from current grade, and relocating the structure, as approved by HARC Commission and as submitted in the HARC approved plans. \*\* ET*

*3/12/2019 10:17:54 AM*

The permit was never issued as the building department requested signed and sealed plans that were not provided by the applicant. Due to inaction the permit was cancelled;

*Gerald Leggett*

09-  
BUILDING

*Permit in call back for additional information for over 6 months without correspondence canceling permit*

*8/17/2019 9:01:47 AM*

After the permit was cancelled there were no new plans submitted.

On March 9, 2022, HARC staff at that time, Kathleen McDonald, Brandon Celli, HARC planner and the CBO all met with the owners of the property on site, to discuss the elevation of the carport and the plans that were required to be submitted as the owner wanted to elevate the carport higher than what the Commission approved. At that time staff explained to the applicant that due to the

expiration of the COA and the changes in height, new plans needed to be submitted to HARC for Commission approval. The owner also wanted to submit revised drawings for a rear addition for the house and staff was clear to him of what was denied and that substantial changes to the denied plans needed to be made and that any major changes to a project that has been approved by the Commission required their review again. Staff also explained to the owners that changing just dimensions in previous plans was not acceptable as plans need to be scaled. The CBO was also emphatic to him about the requirements.

Staff never received any plans, nor any permits were submitted for review.

On April 2, 2024, Samantha Jones General Contractors submitted BLD2024-0877 for the following scope of work:

*4/2/2024 3:09:28 PM (Veronica Cleare)*

*Foundation - Lift house, new piers & floor framing as per plans. \*\*NOC required\*\* HARC INSPECTION REQUIRED*

On April 5, 2024, HARC staff reviewed the file and send an email to the applicant as the submitted documents were incomplete and the only drawing- proposed footers depicted footers taller than 2'-6":

*Enid Torregrosa*

HARC

*Hi Sammy. This is an incomplete application. Please upload existing conditions photographs. Also, how many more feet to the existing finish floor elevation are you planning to elevate the house. Lastly, I need drawings showing treatment of site, as the HARC members were specific about the approved plans. I am attaching the approval letter. Enid*

*4/5/2024 1:22:51 PM*

On the email I send the copy of the COA, which stated that ***staff to raise the house 2'-6" and all site work that is associated with the raise of the existing house.*** It was not until May 14, 2024, 40 days after staff send the email, that the contractor responded.

In efforts to assist the contractor, and as established by the motion from HARC on March 28, 2017, that authorized HARC staff to approve the elevation of additional 2' - 6" staff decided to approve the elevation of the house up to that height.

By May 17, 2024, BLD2024-1375 was submitted for *Lift home to allow for foundation work. Lower house onto new foundation (Samantha Jones permit) Remove stairs and deck boards for*

access for lifting. Staff approved the Certificate of Appropriateness under the building permit with the following note:

*Enid Torregrosa*

*HARC*

*\*\*\*\*\*Certificate of Appropriateness approved as submitted scope of work. Please secure all architectural elements, including front porch and bay window during elevation and stay. House to be elevated with hydraulic jacks. Pool deck and exterior entry staircases not to be part of the elevation. Once a different contractor built new footers 2'-6" taller than the existing ones the building will rest in the new footers. ET\*\*\*\*\**

*5/17/2024 1:15:16 PM*

Staff signed off the COA under BLD2024-1346 for new footers.

*Enid Torregrosa*

*\*\*\*\*\*Certificate of Appropriateness approved for the removal of existing piers under the historic house and new foundations to be no taller than 2'-6" from existing foundation's height as per submitted plans. ET\*\*\*\*\**

*\*\*\*\*HARC Inspection Required\*\*\*\*\**

*5/31/2024 3:20:12 PM*

By June 10, 2024, the new footers permit was approved but at the time of this report it has not been picked up or paid for.

Although the owner and contractor have been advised that the change in height requires a public meeting and review by the Commission, the owner has been requesting staff to approve the new height.

Staff confer with counsel and with HARC Chairman about concerns of current rain season and having a historic house supported by wooden piles without footers. This issue prompted the request for a special meeting.



*Front entrance before the house was elevated.*



*Photograph taken looking south of side of front porch before elevation of house.  
Tapered concrete footer can be seen in this photograph.*




**Secretary of the Interior’s Standards and HARC Regulations Cited on Review:**

- SOIS (pages 16-23), specifically Standards 1, 2 and 9.
- Foundation and lattice infill (pages 34), specifically first paragraph and guidelines 1, 2, and 4.

**Staff Analysis:**

The Certificate of Appropriateness under review proposes to elevate a historic house an additional 1’-3”, raising the finish floor approximately 3-10’ from its original height. This will increase two more steps to the front and rear stairs. Due to the height increase all porches on the first floor will require railings, which the plans propose as turned wood balusters with a handrail with a minimum height of 36” from finish floor. Currently the front porch does not have railings.

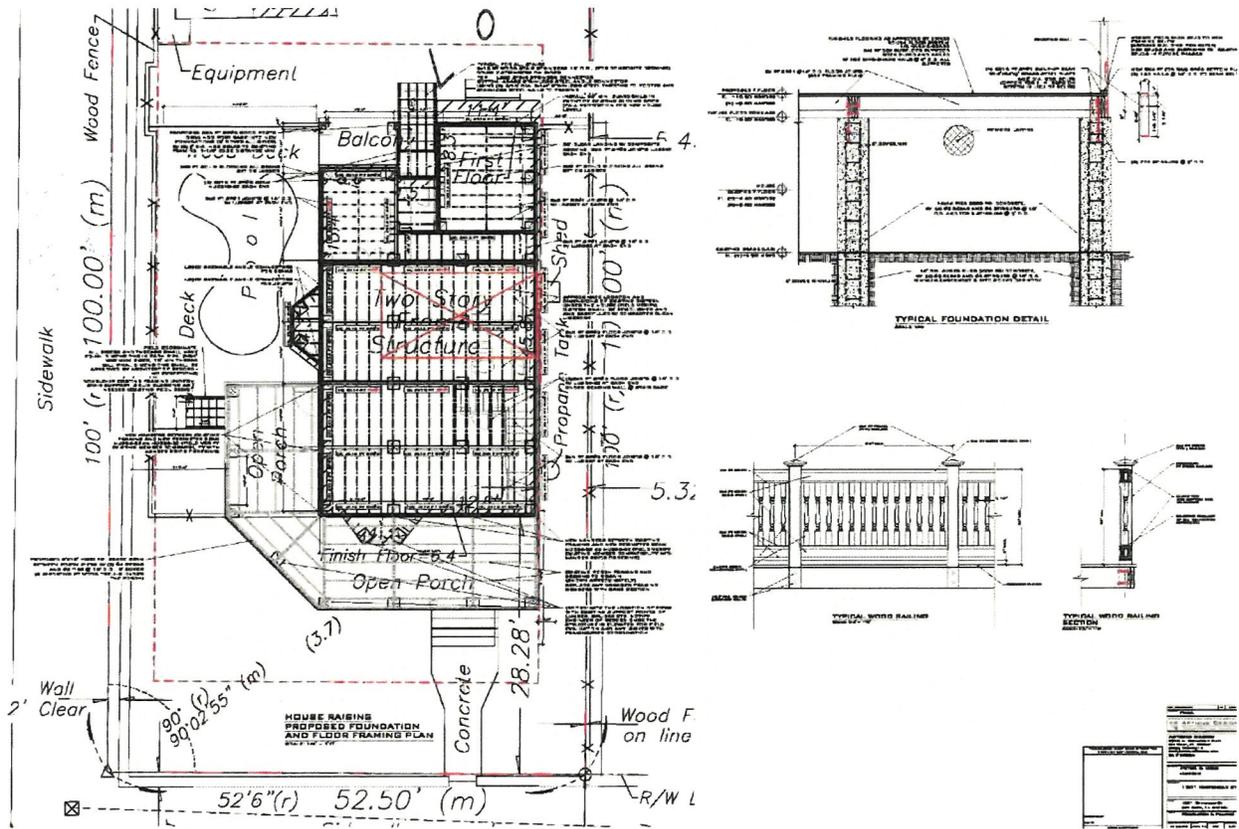

**Consistency with Cited Guidelines:**

It is staff's opinion that elevating the historic house is necessary for its protection due to its proximity to a prone flood area. The proposed height will be in keeping with the future proposed FEMA map. The original footers of the house were still standing before the house was elevated and some of them had a unique tapered form, which will be difficult to replicate with the new proposed height. The proposed square footprint of the new concrete piers will not be adverse to the character of the house. The adjacent historic houses stand over lower piers and the new high piers will create a visual difference in the historic fabric. Staff recommends that design strategies be consider on this case to make the new concrete footers look lower in height by using planters, regrading, double skirting, or any other design solution that would not jeopardize the historic character of the house, as the submitted documents did not included anything to this effect. The infill between the new footers will be covered with wooden lattice.