


CITY OF KEY WEST KEY WEST, FL FREDERICK DOUGLASS GYM **NEW CONSTRUCTION**

PLANNING SUBMITTAL ISSUED - 2021.12.09 UPDATE 2022.01.11 - LANDSCAPE & CIVIL UPDATE

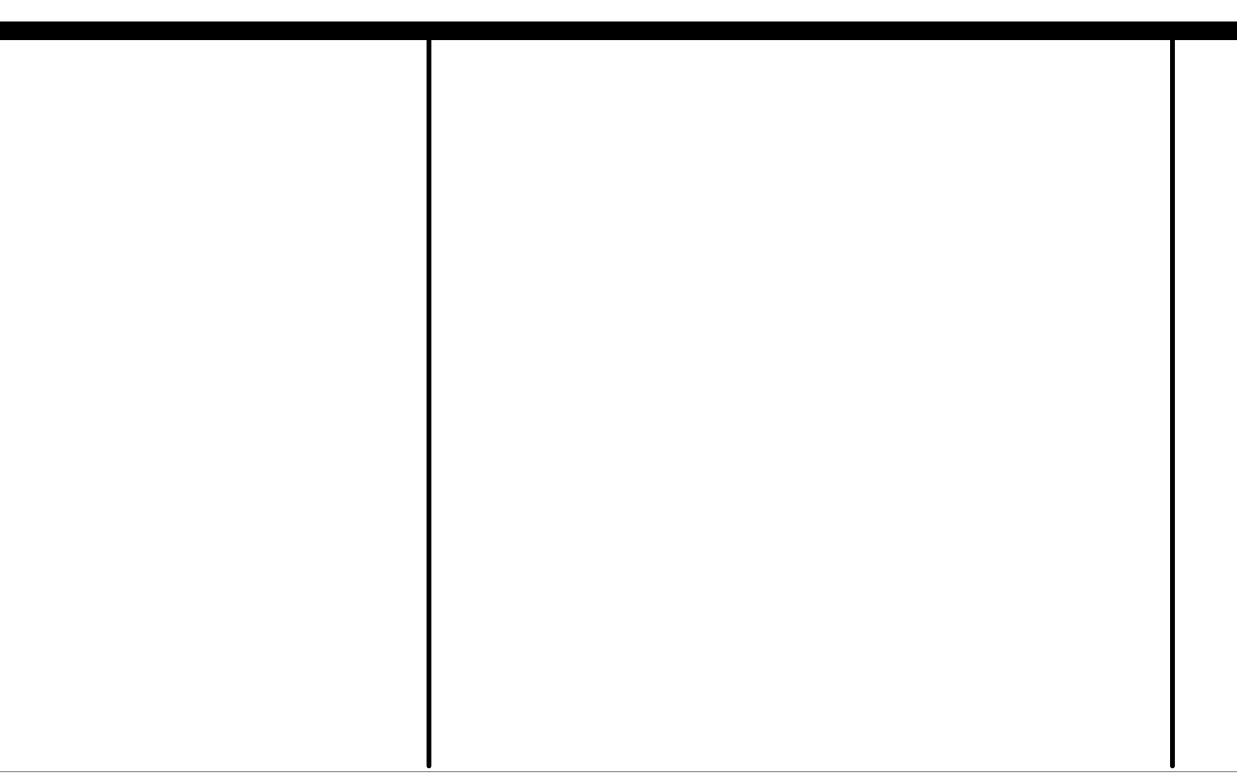


APPROVALS RECIVED 1. PROGRAMMING APPROVED 2. SCHEMATIC DESIGN APPROVED 3. TREE COMMISSION - CONCEPTUAL APPROVED APPROVED 4. HISTORIC ARCHITECTURAL REVIEW COMMISSION APPROVED 5. DESIGN REVIEW COMMIT APPROVED 6. PLANNING COMISSION APPROVED 7. DESIGN DEVELOPMEN 8. TREE COMMISSION - FINAL APPROVED 9. CONSTRUCTION DOCUMENTS APPROVED 10. BIDDING APPROVED 11. PERMITTING APPROVED

ARCHITECT Architecture. Enginee Interior Design, Asset Managemer Specialty Consulting Key Largo, Florida Key West, Florida Marathon, Florida URL: www.k2mdesian.c PROF. REG. AA26001059 uilding Relationshi ased on Trust and Result d | Columbus | Indianapolis | Kev Largo t | Marathon | Charlotte | Baltimore | Be Consultants: DOUGLASS GYM WEST Ш Х ОF FREDERICK CITY 00 WHITE PLOTTED: 1/11/2022 11:20:57 AM Drawing Size Project #: 30x42 19095 Drawn By: Checked By LBB/EHP EG COVER SHEET Sheet Number: G0.0.1 Date: 08/04/2021 ©2021 by K2M Design, Inc.

DATE

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C	XX/XX/XX

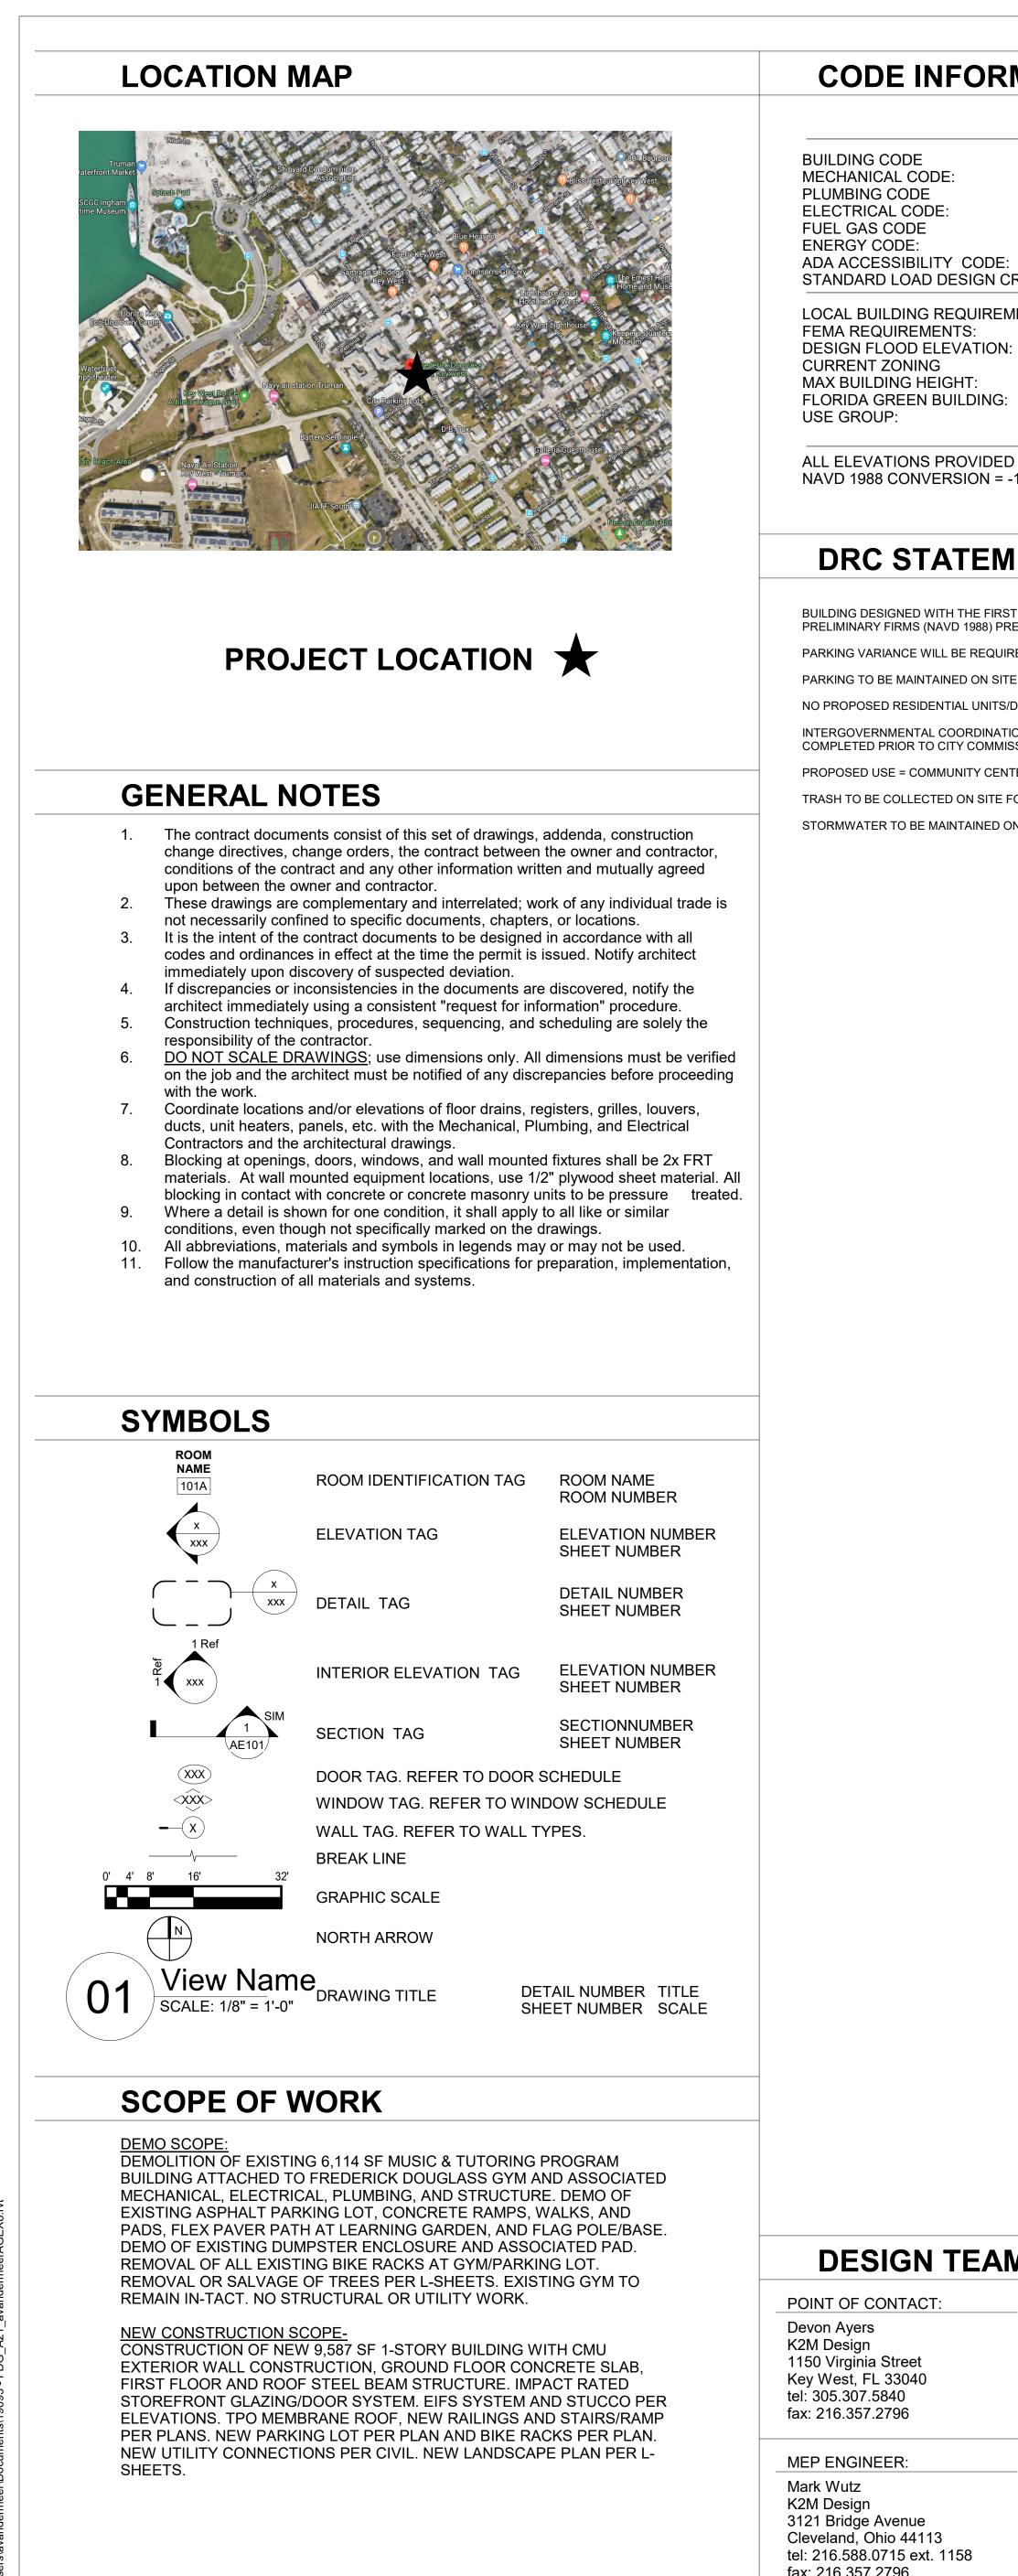

MECHANICAL CODE: PLUMBING CODE ELECTRICAL CODE: FUEL GAS CODE ENERGY CODE: ADA ACCESSIBILITY CODE: STANDARD LOAD DESIGN C

LOCAL BUILDING REQUIREM FEMA REQUIREMENTS: DESIGN FLOOD ELEVATION: CURRENT ZONING MAX BUILDING HEIGHT: FLORIDA GREEN BUILDING: USE GROUP:

ALL ELEVATIONS PROVIDED NAVD 1988 CONVERSION =

DRC STATEM

BUILDING DESIGNED WITH THE FIRST PRELIMINARY FIRMS (NAVD 1988) PRE PARKING VARIANCE WILL BE REQUIR PARKING TO BE MAINTAINED ON SITE NO PROPOSED RESIDENTIAL UNITS/D INTERGOVERNMENTAL COORDINAT COMPLETED PRIOR TO CITY COMMIS PROPOSED USE = COMMUNITY CENT TRASH TO BE COLLECTED ON SITE FO STORMWATER TO BE MAINTAINED OF

DESIGN TEAM INFORMATION

POINT OF CONTACT: 1150 Virginia Street Key West, FL 33040 tel: 305.307.5840 fax: 216.357.2796

MEP ENGINEER: 3121 Bridge Avenue Cleveland, Ohio 44113 tel: 216.588.0715 ext. 1158 fax: 216.357.2796

ΜΑΤΙΟ	Ν	BUILDING INFORMATION
	2020 FLORIDA BUILDING CODE, 6TH EDITION 2020 FLORIDA MECHANICAL CODE 2020 FLORIDA PLUMBING CODE 2020 NATIONAL ELECTRIC CODE (NEC) NFPA	FREDERICK DOUGLASS GYM EXPANSION 111 OLIVIA STREET KEY WEST, FLORIDA 33040
RITERIA	2020 FLORIDA FUEL GAS CODE 2020 FLORIDA ENERGY CONSERVATION CODE 2020 FLORIDA ACCESSIBILTY CODE ASCE 7-10	USE GROUP: ASSEMBLY A-3 EDUCATIONAL E
/IENTS:	CITY OF KEY WEST CODES AND ORDINANCES FLOOD ZONE: AE: 7' NGVD 1929 FLOOD ZONE: +8.0 FEET NGVD 1929 FLOOD PLAIN COMPLIANCE: ASCE 24-14" SUBURBAN COMMERCIAL 35' FROM COR	OCCUPANCY CALCULATIONS: A-3 15 SF/OCCUPANT E - CLASSROOM 20 SF NET/OCCUPANT E - COMMERCIAL KITCHEN 200 SF GROSS/OCCUPAN MECH 300 GROSS SF/OCCUPAN STORAGE 300 GROSS SF/OCCUPAN
	MIN REQUIREMENTS TO BE MET ASSEMBLY	EGRESS WIDTH = .20"/OCCUPANT 44" REQUIRED
) IN NGVD 19 -1.34'	929.	TRAVEL DISTANCE: MAX LENGTH OF TRAVEL = 200 FT COMMON PATH OF EGRESS = 75 FT
IENTS		NUMBER OF EXITS: REQUIRED = 2 PROVIDED = 3
T FINISHED FLO	OR AT OR ABOVE THE NEW BASE FLOOD ELEVATION SHOWN ON FEMA'S	CONSTRUCTION TYPE: TABLE 601 TYPE IIB
		BUILDING IS NOT SPRINKLED
ION TO BE PERF SSION APPROVA TER	WITH THIS APPLICATION. ORMED DURING THE REMAINING PHASES OF THE PROJECT AND AL. WASTE MANAGEMENT.	FIRE RESISTANCE RATINGS:SHAFT WALLS0 HRFIRE STAIR WALLS0 HRFIRE STAIR DOORS/WINDOWS0 HRFIRE SEPARATION @ LOBBY0 HRFIRE SEPARATION @ MAIN HALL0 HRLOBBY INTERIOR DOORS0 HRNON-LOAD BEARING EXT WALLS0 HR
ON SITE.		BUILDING SQUARE FOOTAGE: 1ST FLOOR - 9,587 SF
		BUILDING IS IN THE HISTORIC DISTRICT
		CONTRACTOR GENERAL NOTES: - ALL WORK TO BE IN ACCORDANCE WITH APPLICABLE - WORKMANSHIP TO MEET OR EXCEED ACCEPTED STATRADES. - VERIFY ALL DIMENSIONS, ELEVATIONS, AND FIELD CONSTRUCTION. NOTIFY ARCHITECT IF ANY CONFLIC COMMENCEMENT OF WORK. - FOR ANY TYPE I OR TYPE II CONSTRUCTION PROJEC WOOD (EXTERIOR OR INTERIOR GRADE) MUST BE US CONSTRUCTION MATERIALS. - FOR ALL WALL SYSTEMS WITH EIFS USE EXTERIOR OF SHEATHING OR CEMENTITIOUS BOARD ONLY.
		FIRE EXTINGUISHERS WILL BE PROVIDED AS REQUIRE JURISDICTION OR AS DIRECTED BY THE LOCAL FIRE D
		WALL R-VALUE (CONTINUOUS) = 6 WALL R-VALUE (CAVITY) = 13 ROOF R-VALUE = 39
		CONTRACTOR TO PROVIDE ESR REPORTS FOR CLOSE SELECTED FOR REVIEW BY DESIGN PROFESSIONAL.
		ADA COMPLIANCE STATEME
		This project has been designed in accordance to the 2010 AD 2020 Florida Accessibility Code.


INTERIOR DESIGN:	CIVIL ENGINEER:	IRRIGATION:	GEOTECHNICAL ENGINE
Valene Tabone K2M Design 3121 Bridge Avenue Cleveland, Ohio 44113 tel: 216.357.2794 fax: 216.357.2796	Jason Panicaro CW3 Engineers 5783 Bayshore Rd. Suite 113 N. Ft. Myers FL 33917 tel. 239.205.6473	Blue Island Lighting & Irrigation Inc. 3255 Flagler Avenue #307 Key West, FL 33040 tel. 305.293.8444	Nutting Engineers 2051 NW 112th Avenue #7 Miami, FL 33172 tel. 305.824.0060
STRUCTURAL ENGINEER:	ARCHITECT:	SURVEYOR:	
Steven S. Grasley K2M Design 1150 Virginia Street Key West, FL 33040 tel: 855.866.4526 fax: 216.357.2796	Scott Maloney K2M Design 3121 Bridge Avenue Cleveland, Ohio 44113 tel: 855.866.4526 fax: 216.357.2796	Florida Keys Land Surveying 19960 Overseas Highway Sugarloaf Key, FL 33042 tel. 305.394.3690	

DRAV		NDEX
		DRAWING INDEX
ISSUED FOR:	SET	
SCHEMATIC DESIGN SE DRC SUBMITTAL PLANNING SET		
SCHEMATIC DES DRC SUBMITTAL PLANNING SET	CONSTRUCTION	
SCHE DRC (DFSIG		
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	<u>ố ố</u> Number	Sheet Name
	G0.0.1 G0.0.2	COVER SHEET DRAWING INDEX, CODE INFO., SYMBOL LEGEND, &
X X X	G0.0.3	ABBREVIATIONS 3D VIEWS
X X X X X X X	G0.0.4 G0.0.5 V1.1.1	3D VIEWS MATERIALS & COLORS SITE SURVEY
	G0.1.1 G0.1.2	ACCESSIBILITY GUIDLINES ICC A117.1-2009 ACCESSIBILITY GUIDLINES ICC A117.1-2009
	G0.2.1 G2.1.1	UL DETAILS LIFE SAFETY PLANS
CIVIL		
X X X X	C 01 C 02	EXISTING CONDITIONS CONCEPT SITE PLAN
X X X X	C 03 C 04	CONCEPT DRAINAGE PLAN CONCEPT UTILITY PLAN
ARCHITECTU	IRAL AD1.1.1	DEMOLITION SITE PLAN/FLOOR PLAN
	AD1.1.1 A1.1.0 A1.1.1	SITE DATA TABLES ARCHITECTURAL SITE PLAN
	A1.1.1 A2.1.1 A2.2.1	FIRST FLOOR PLAN FIRST FLOOR REFLECTED CEILING PLAN
X X X X X	A2.2.1 A2.3.1 A3.1.1	ROOF PLAN EXTERIOR ELEVATIONS
	A3.1.1 A3.1.2 A3.2.1	EXTERIOR ELEVATIONS EXTERIOR ELEVATIONS BUILDING SECTIONS
	A3.2.2 A3.2.2 A3.2.3	BUILDING SECTIONS BUILDING SECTIONS
	A3.4.1 A6.1.1	ENLARGED SECTION DETAILS WINDOW/DOOR SCHEDULES
	A6.2.1 A6.2.2	DOOR DETAILS WINDOW DETAILS
	A7.1.1 A7.2.1	STAIR PLANS, SECTIONS, AND DETAILS ELEVATOR PLANS, SECTIONS, AND DETAILS
	A8.1.1 A8.2.1	ROOFING DETAILS EXTERIOR DETAILS
	A8.3.1 A9.1.1	INTERIOR DETAILS WALL TYPES
INTERIOR DE		
	I4.2.2 I2.1.1	INTERIOR ELEVATIONS FINISH PLANS
	I2.2.1 I2.3.1	CEILING PLAN FIRST FLOOR FURNITURE PLAN
	I4.2.1 I5.1.1	INTERIOR ELEVATIONS ENLARGED MILLWORK PLANS
	I5.2.1 I6.1.1	MILLWORK DETAILS & SECTIONS SCHEDULES - FINISH & FINISH LEGEND
STRUCTURA	I9.1.1	INTERIOR DETAILS
	L S0.1 S0.2	GENERAL NOTES GENERAL NOTES
	S0.2 S0.3 S1.1	SPECIAL INSPECTIONS
	S1.3	FOUNDATION PLAN MAIN HALL ROOF FRAMING PLAN ROOF FRAMING PLAN
	S1.4 S2.1	FOUNDATION TYPICAL DETAILS
	S2.2 S3.1 S3.2	FOUNDATION SECTIONS FRAMING TYPICAL DETAILS FRAMING SECTIONS
	S3.2 S4.1 S4.2	FRAMING SECTIONS ROOF TYPICAL DETAILS ROOF SECTIONS
MECHANICAL		
	- M0.1.1 M1.1.1	GENERAL NOTES AND SCHEDULES MECHANICAL PLANS - LEVEL 1
	M1.1.1 M2.3.1 M5.1.1	MECHANICAL PLANS - LEVEL 1 ROOF MECHANICAL PLAN MECHANICAL BUILDING AUTOMATION PLANS
	M5.1.1 M5.1.2	MECHANICAL BUILDING AUTOMATION PLANS
PLUMBING	P0.1.1	PLUMBING SCHEDULES, NOTES & SYMBOLS
	P1.1.1 P1.2.1	DMV PLUMBING PLANS DOMESTIC WATER PLUMBING PLANS
	P3.1.2 P5.1.1	SANITARY/VENT RISER DIAGRAM DETAILS
ELECTRICAL		
	E2.1.3 E0.1.1	MECHANICAL POWER PLAN LEGENDS & SCHEDULES
	E1.1.1 E2.1.1	ELECTRICAL SITE PLAN FIRST FLOOR POWER PLAN
	E2.2.1 E2.3.1	FIRST FLOOR LIGHTING PLAN TECHNOLOGY PLAN ONE LINE DIACRAM
	E3.1.1 E3.1.2	ONE LINE DIAGRAM PANEL SCHEDULES/RISER DIAGRAM ELECTRICAL DETAILS
	E5.1.1 E6.0.1	ELECTRICAL DETAILS ELECTRICAL ONE-LINE DIAGRAM ELECTRICAL SCHEDULES
	E6.1.1	ELECTRICAL SCHEDULES
LANDSCAPE X	L1.1.1	EXISTING LANDSCAPE PLAN
	L1.1.2 L5.1.1	REQUIRED LANDSCAPE PLAN LANDSCAPE/SITE DETAILS LANDSCAPE/SITE DETAILS
	LU. 1.Z	
	IR1.1.1 IR1.1.2	IRRIGATION SITE PLAN, NOTES AND DETAILS IRRIGATION SITE PLAN
X X	L5.1.1 L5.1.2	LANDSCAPE/SITE DETAILS LANDSCAPE/SITE DETAILS IRRIGATION SITE PLAN, NOTES AND DETAILS

ARCHITECT: Architecture, Engineering, Interior Design, Asset Management, Specialty Consulting Key Largo, Florida Key West, Florida Marathon, Florida URL: www.k2mdesign.com PROF. REG. AA26001059 Building Relationships Based on Trust and Results leveland | Columbus | Indianapolis | Key Largo | Key Nest | Marathon | Charlotte | Baltimore | Bentonville LIC. NO. AR931 COA: AA26001059 Consultants: Submissions
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 08/26/2021

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 ISSUED SD SET
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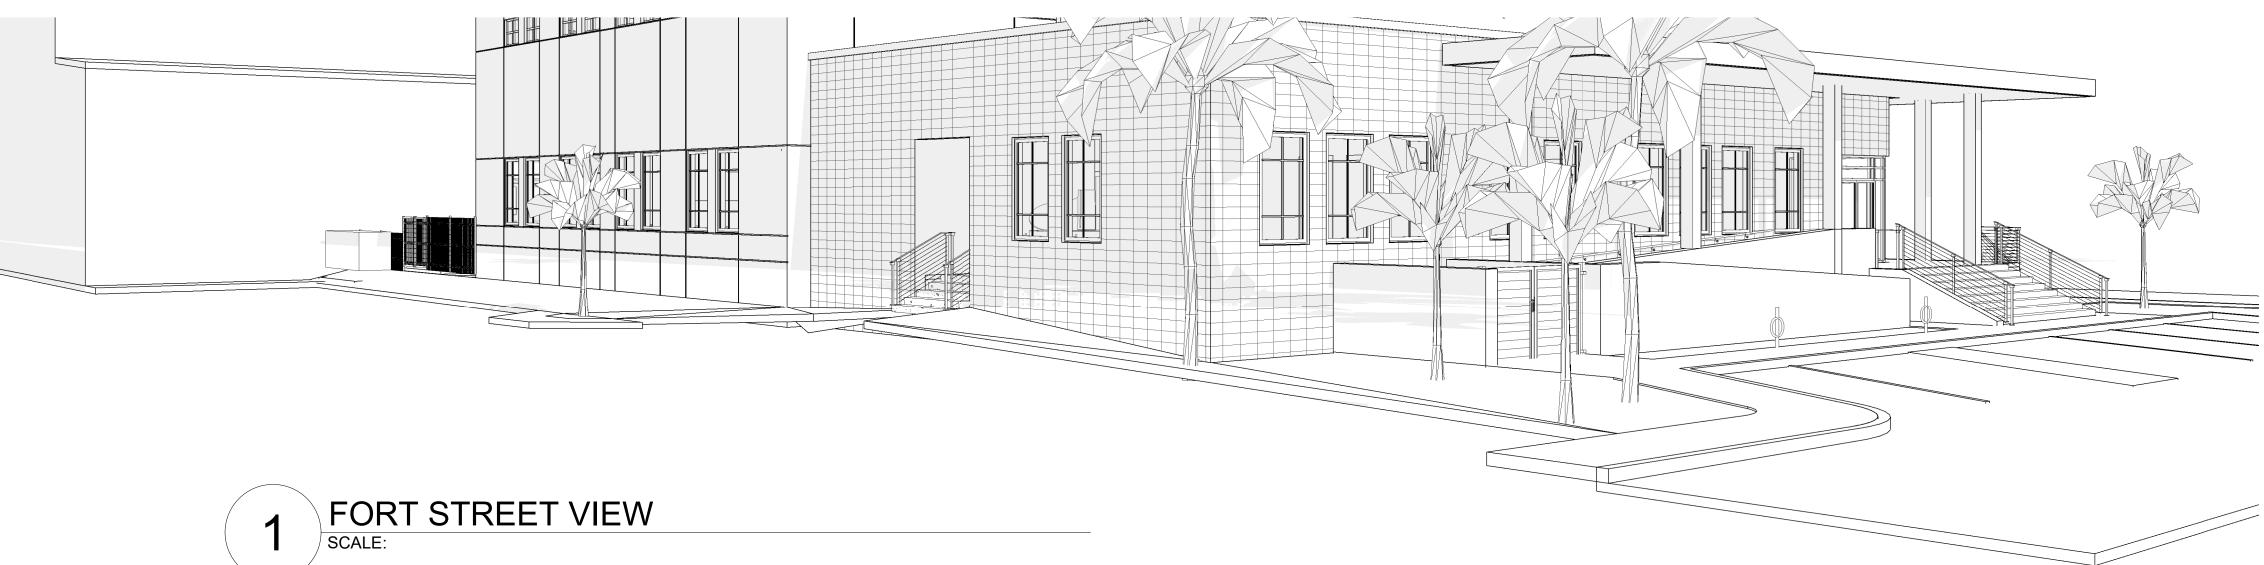
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 12/09/2021
 FREDERICK DOUGLASS GYM 111 OLIVIA STREET, KEY WEST, FL, 33040 KEY WEST ET, KEY WEST, FL, 3304 ЧO CITY 300 WHITE PLOTTED: 12/22/2021 4:23:16 PM Drawing Size Project #: 30x42 19095 Drawn By: Checked By: Designer Checker 3D VIEWS Sheet Number: G0.0.3 Date: 08/04/2021 ©2021 by K2M Design, Inc.




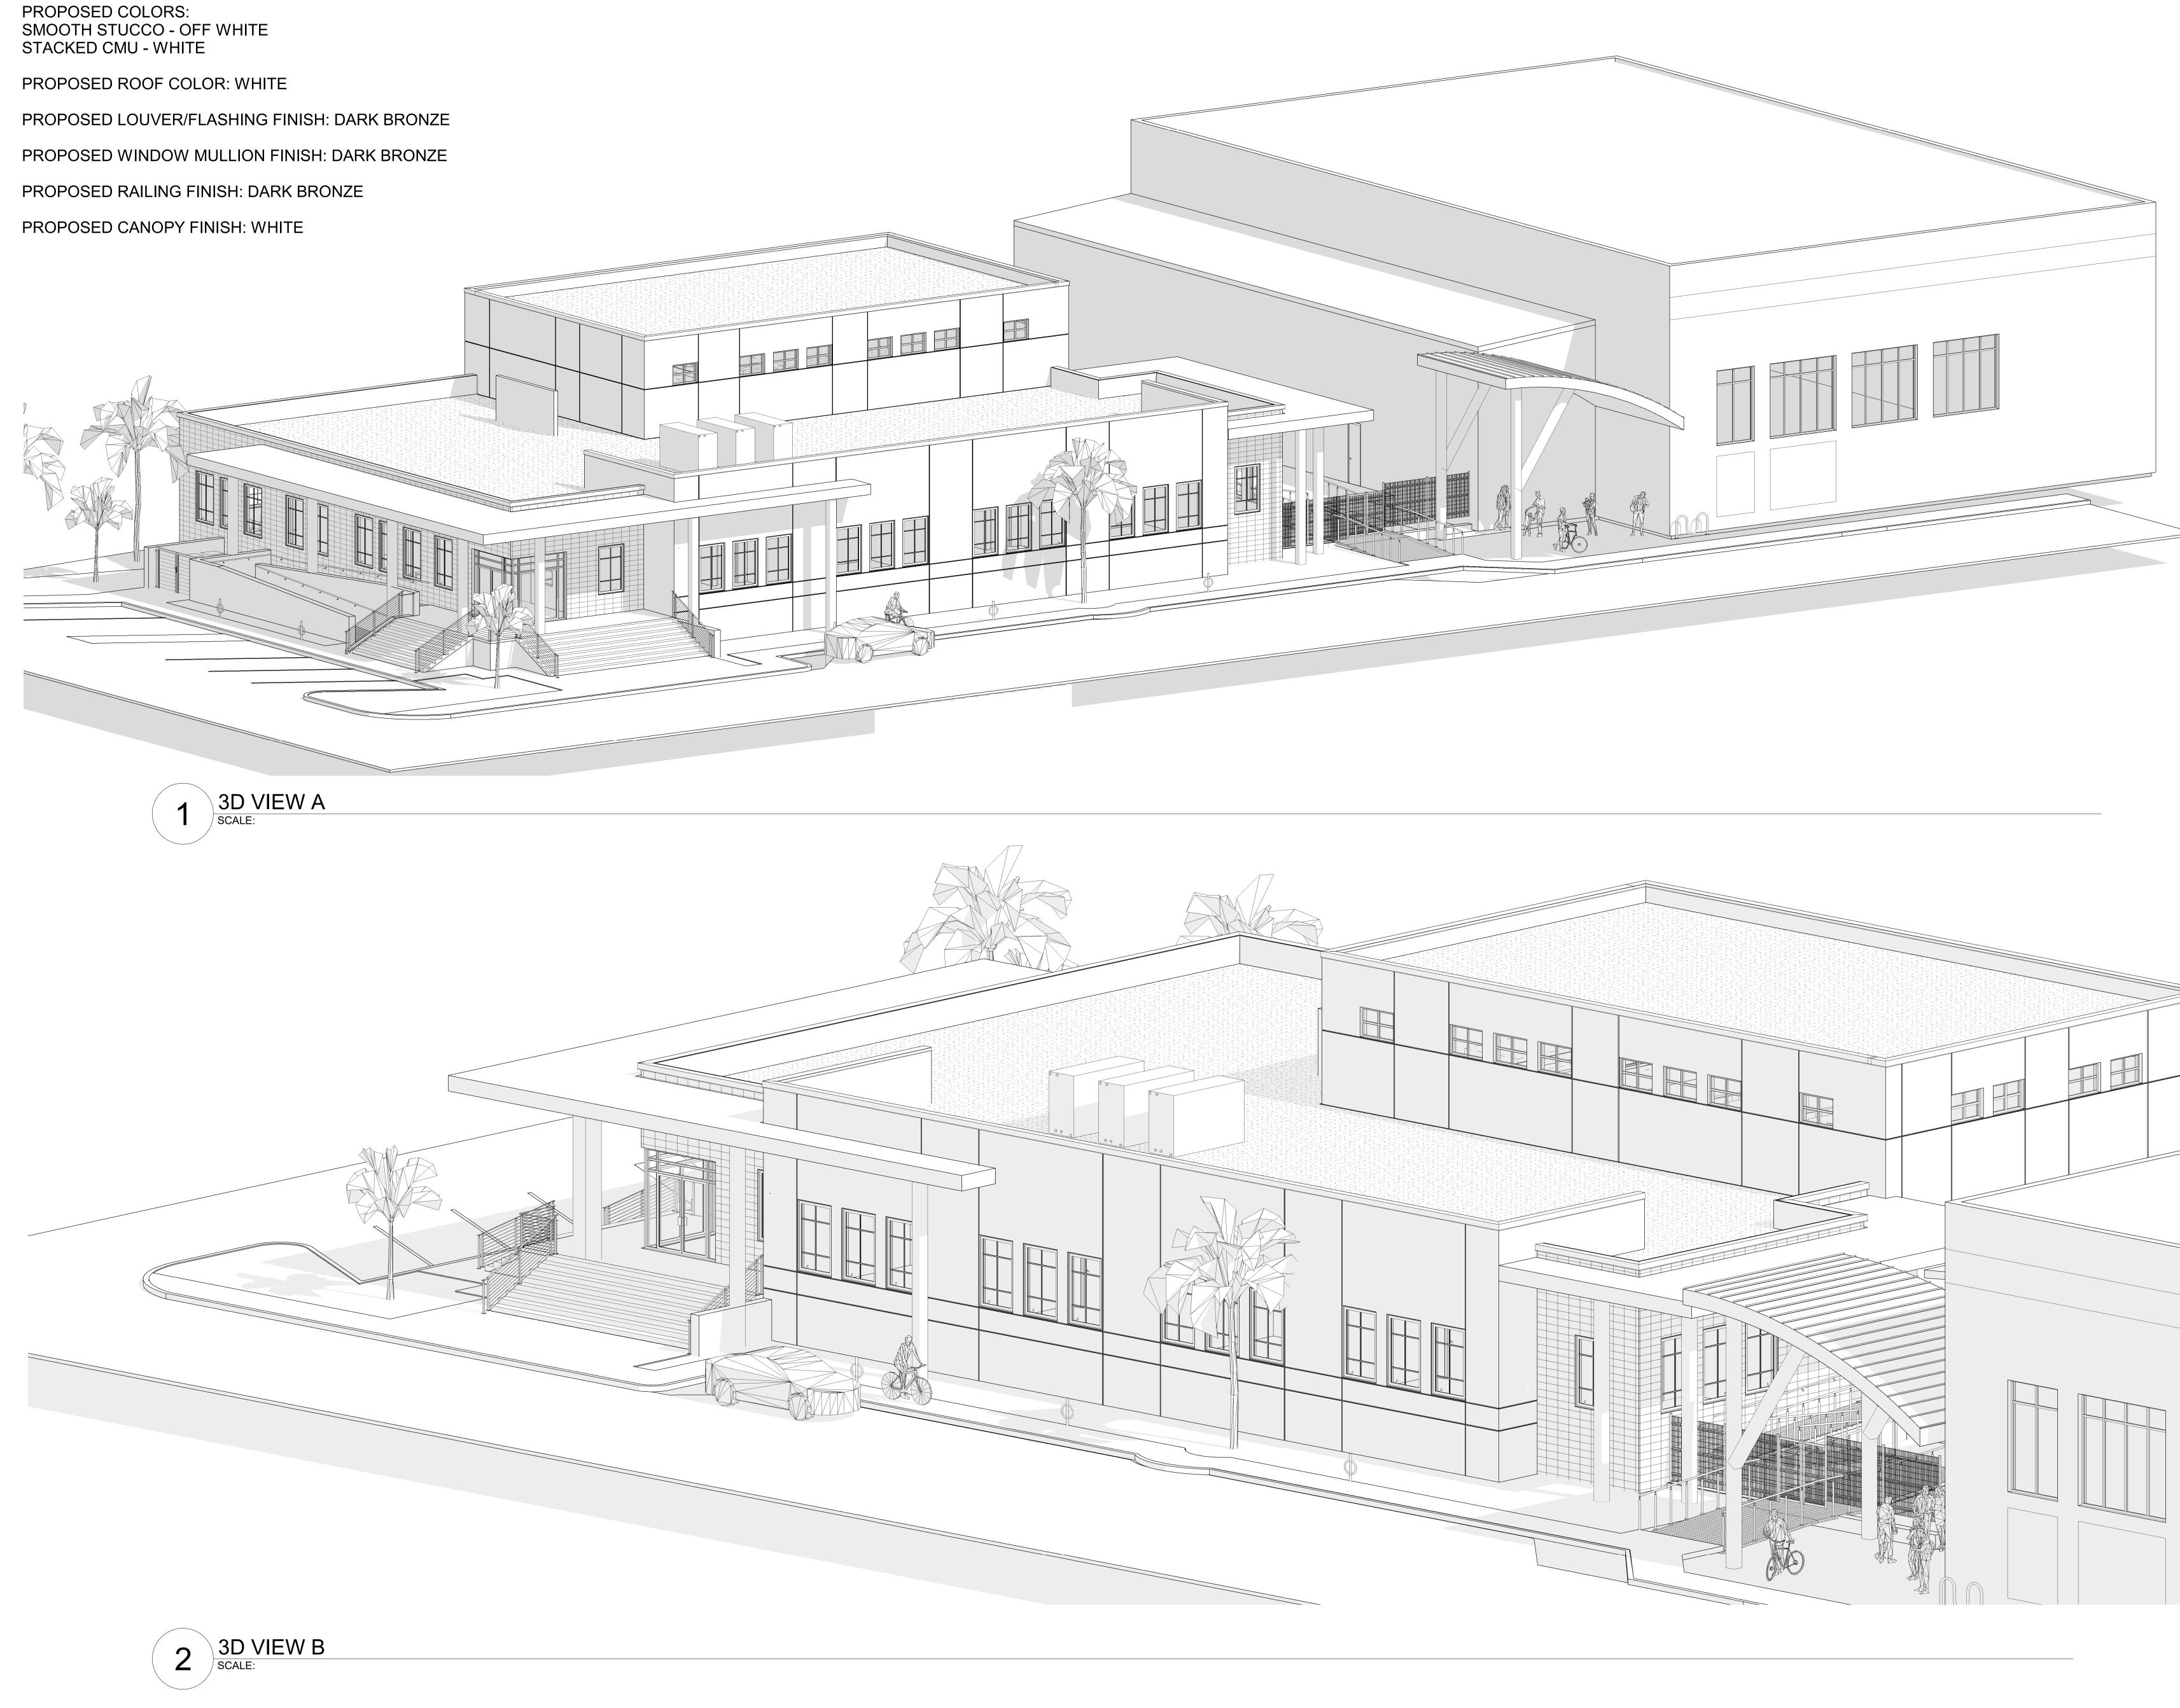







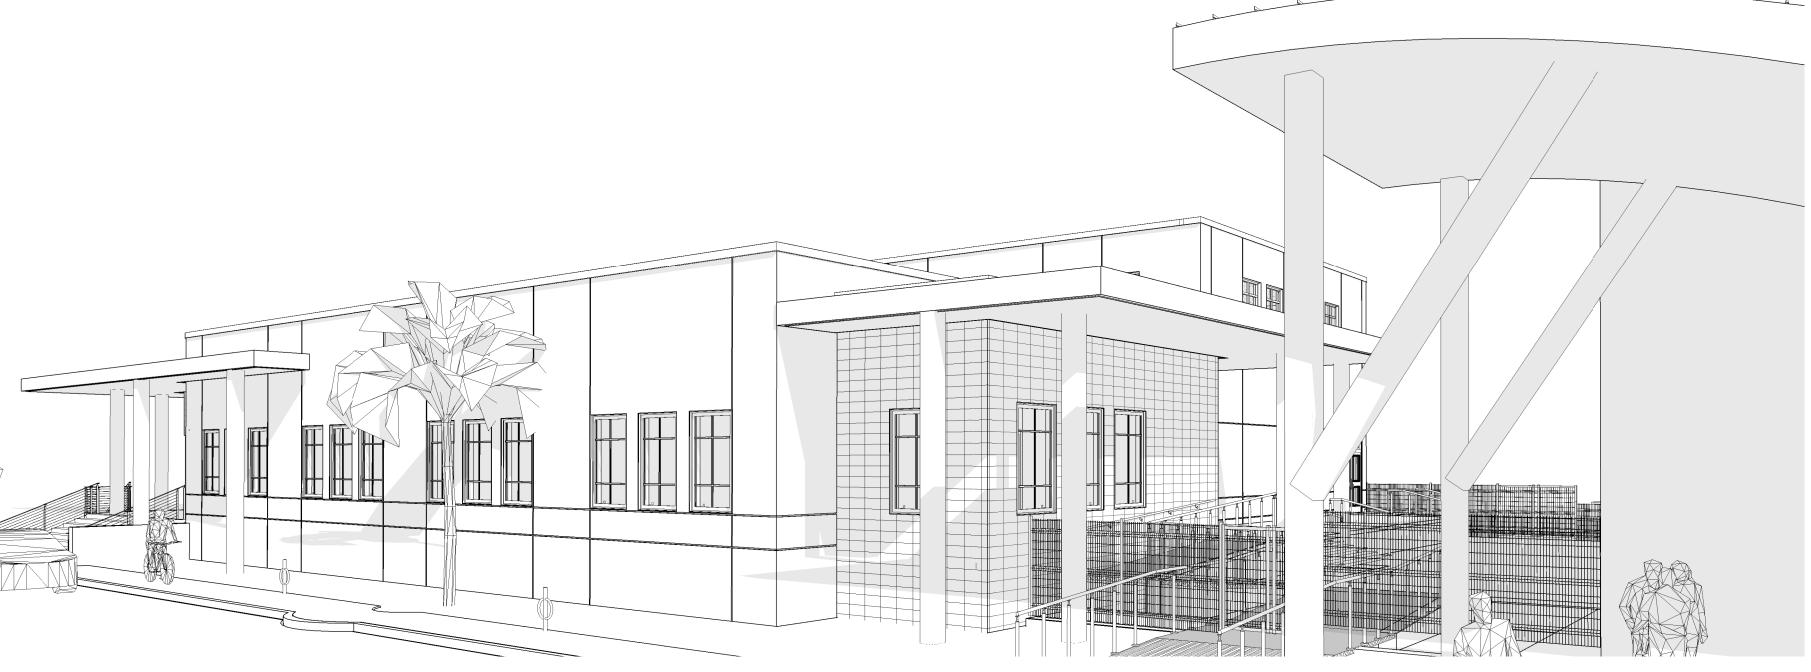

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COURTYARD ENTRANCE VIEW

2 FRONT ENTRANCE VIEW SCALE: 12" = 1'-0"


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 ISSUED SD SET
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 ISSUED PLANNING
 12/09/2021

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 FREDERICK DOUGLASS GYM 111 OLIVIA STREET, KEY WEST, FL, 33040 KEY WEST, FL, 3304 ЧO CITY 300 WHITE PLOTTED: 12/22/2021 4:23:25 PM Drawing Size Project #: 30x42 19095 Drawn By: Checked B VAM DA 3D VIEWS Sheet Number: G0.0.4 Date: 08/04/2021 ©2021 by K2M Design, Inc.

EXTERIOR MATERIAL CONCEPT




METAL CANOPY EXAMPLE

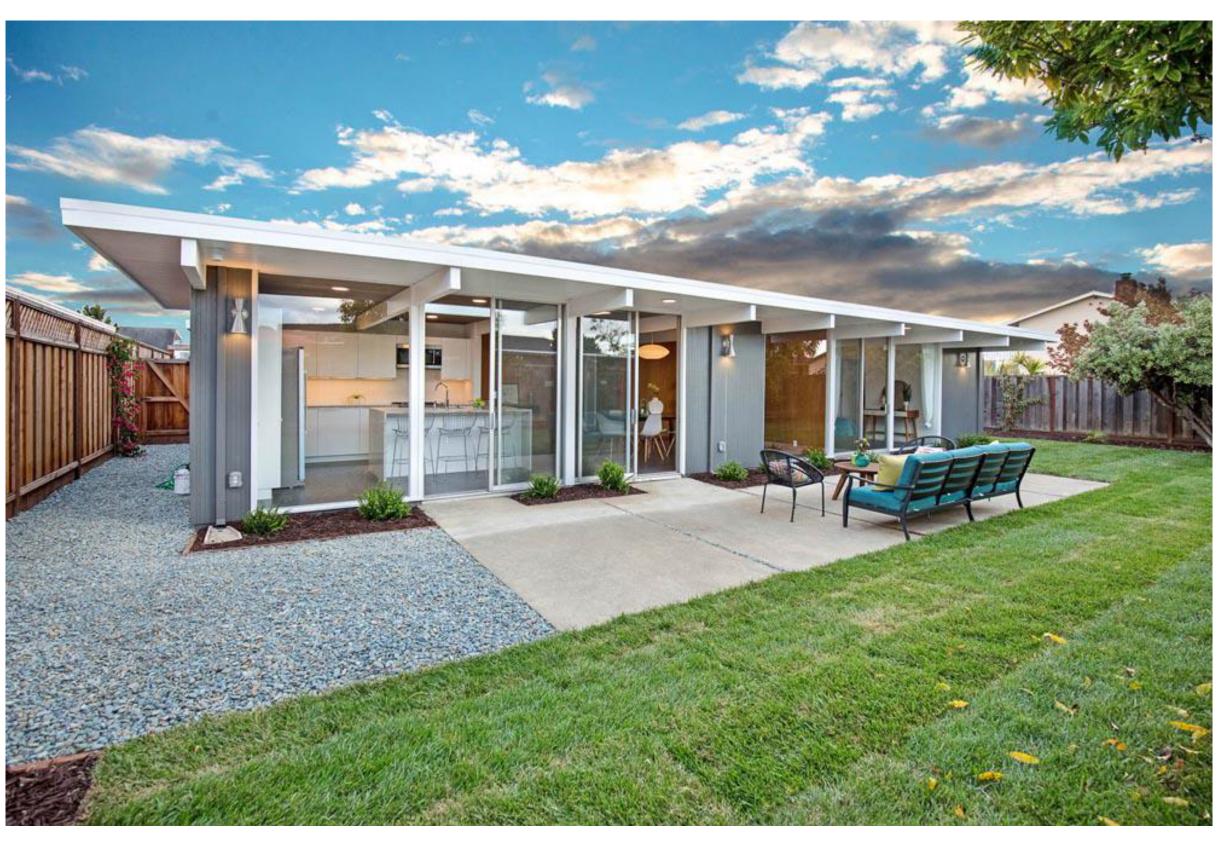


METAL CANOPY EXAMPLE



STUCCO FINISH OVER CMU - STACK BOND PATTERN

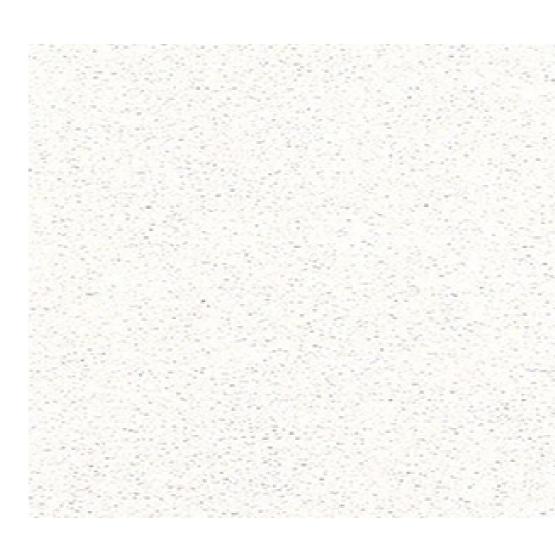


STUCCO FINISH - WHITE

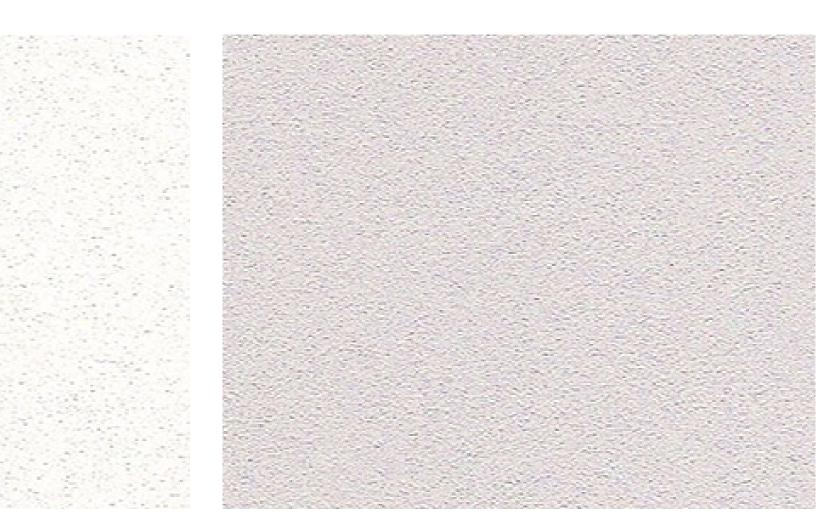


STUCCO FINISH - OFF WHITE

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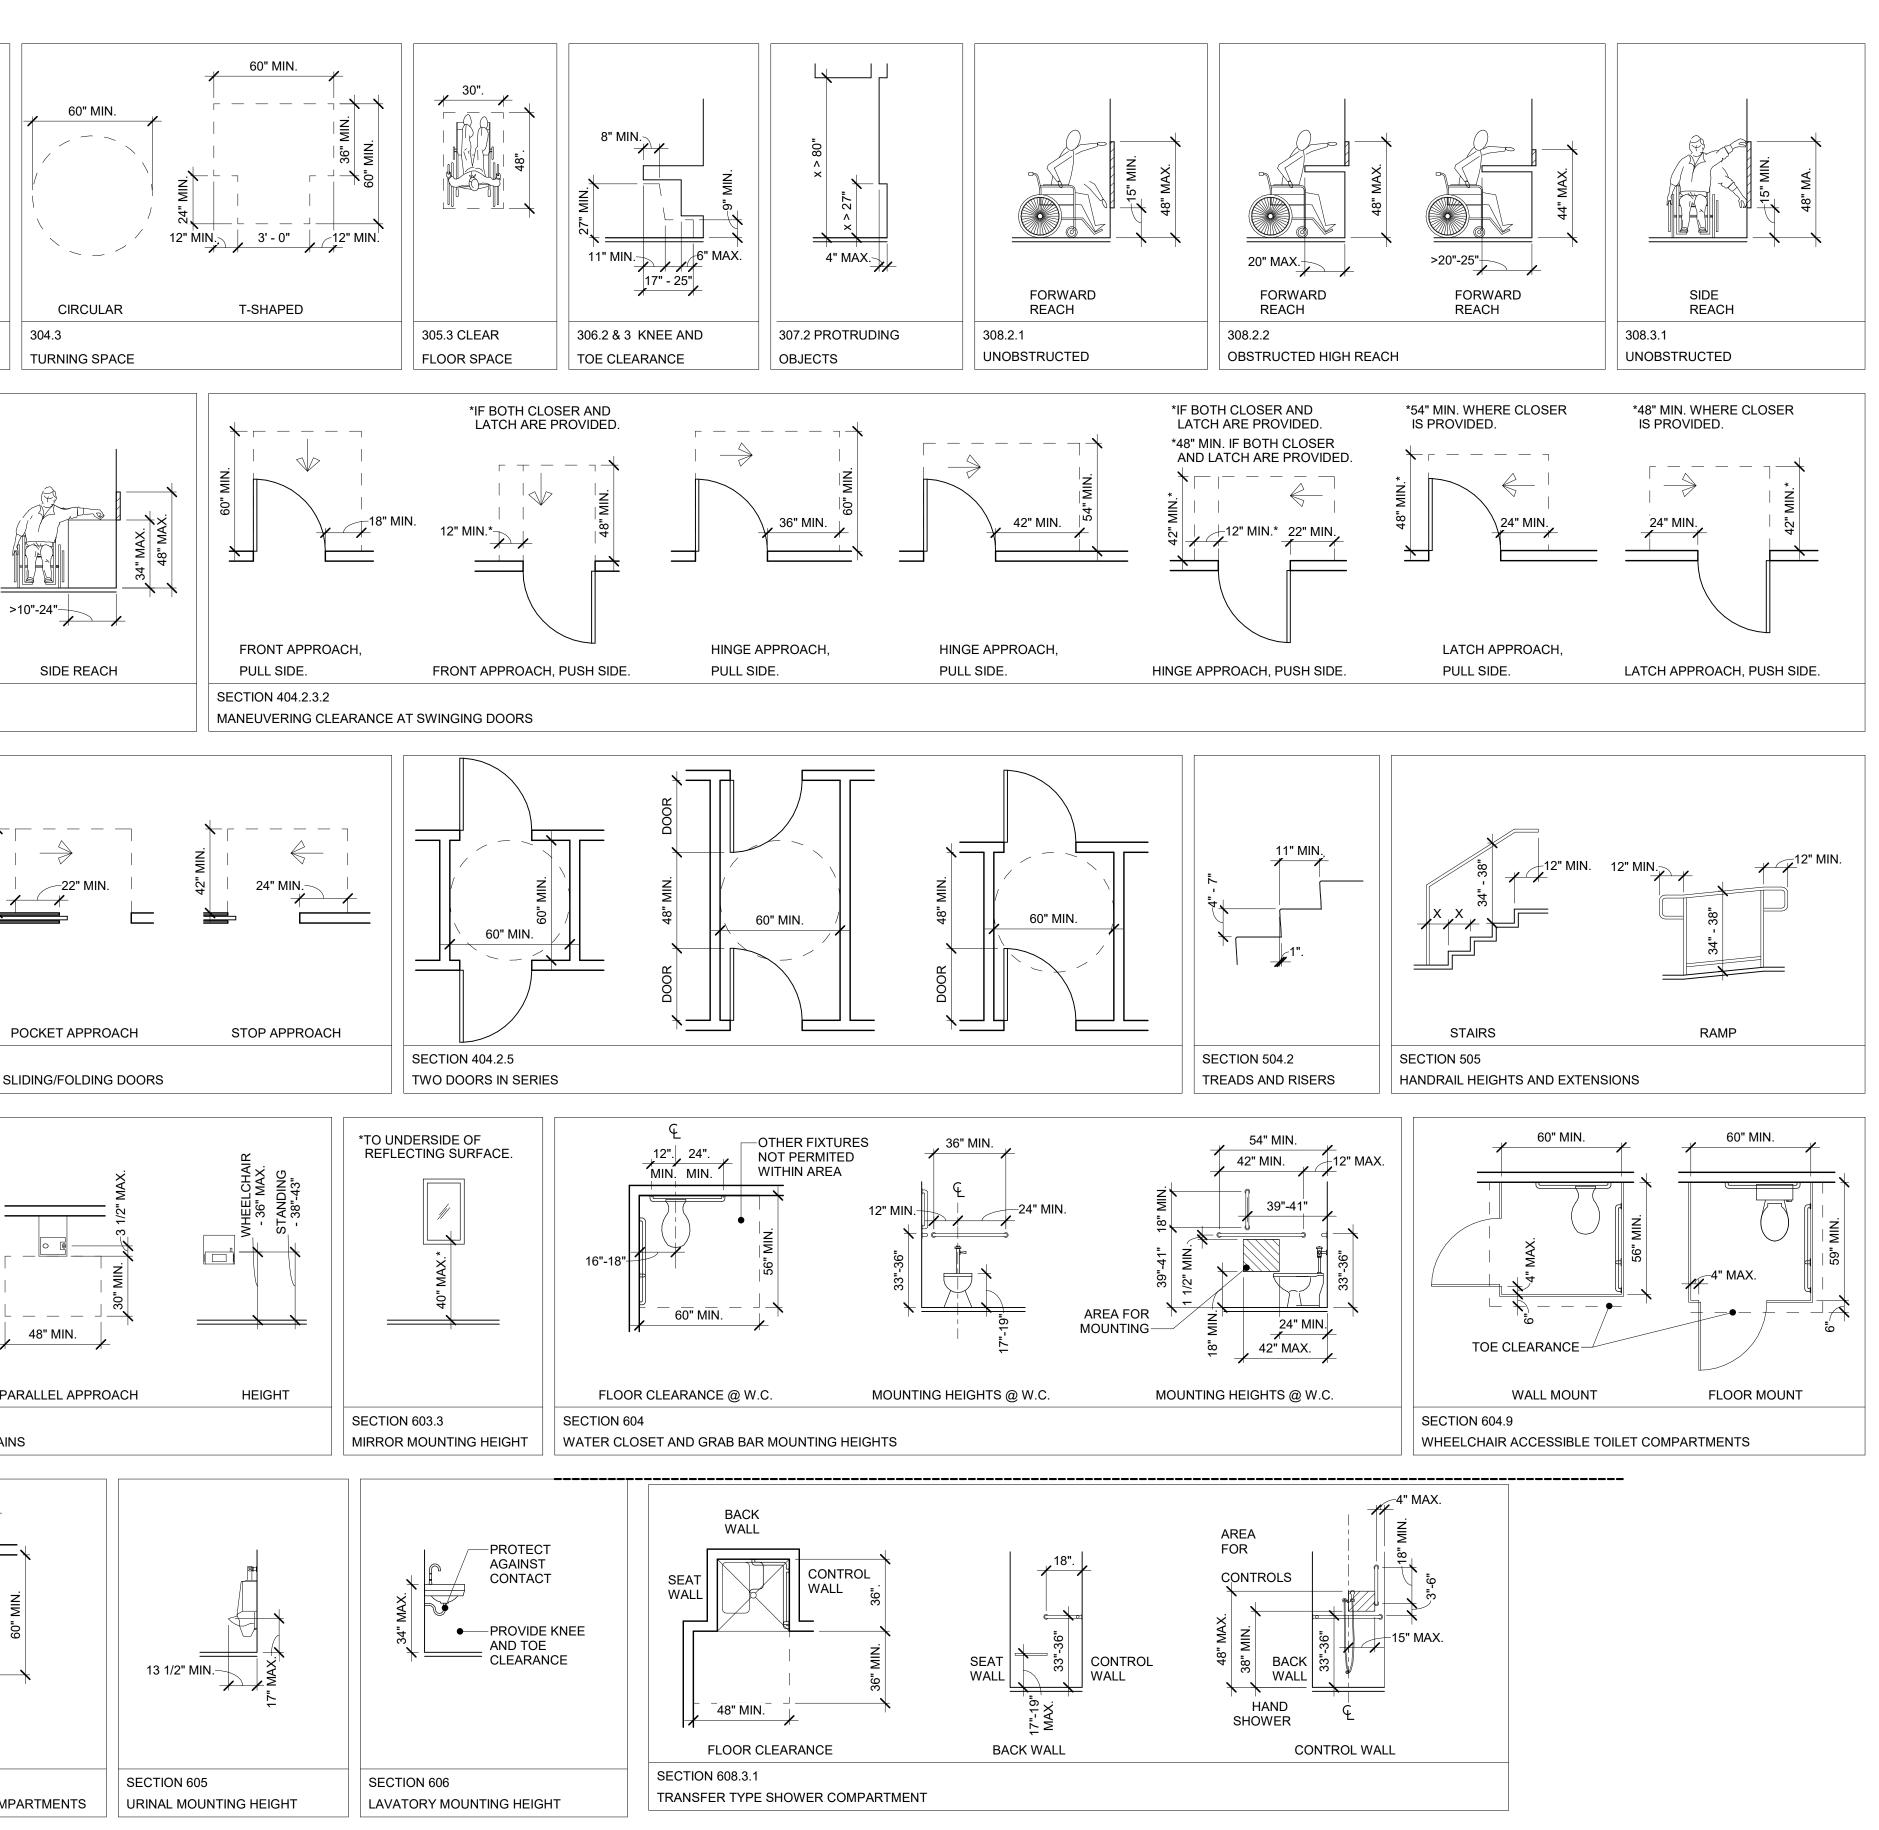


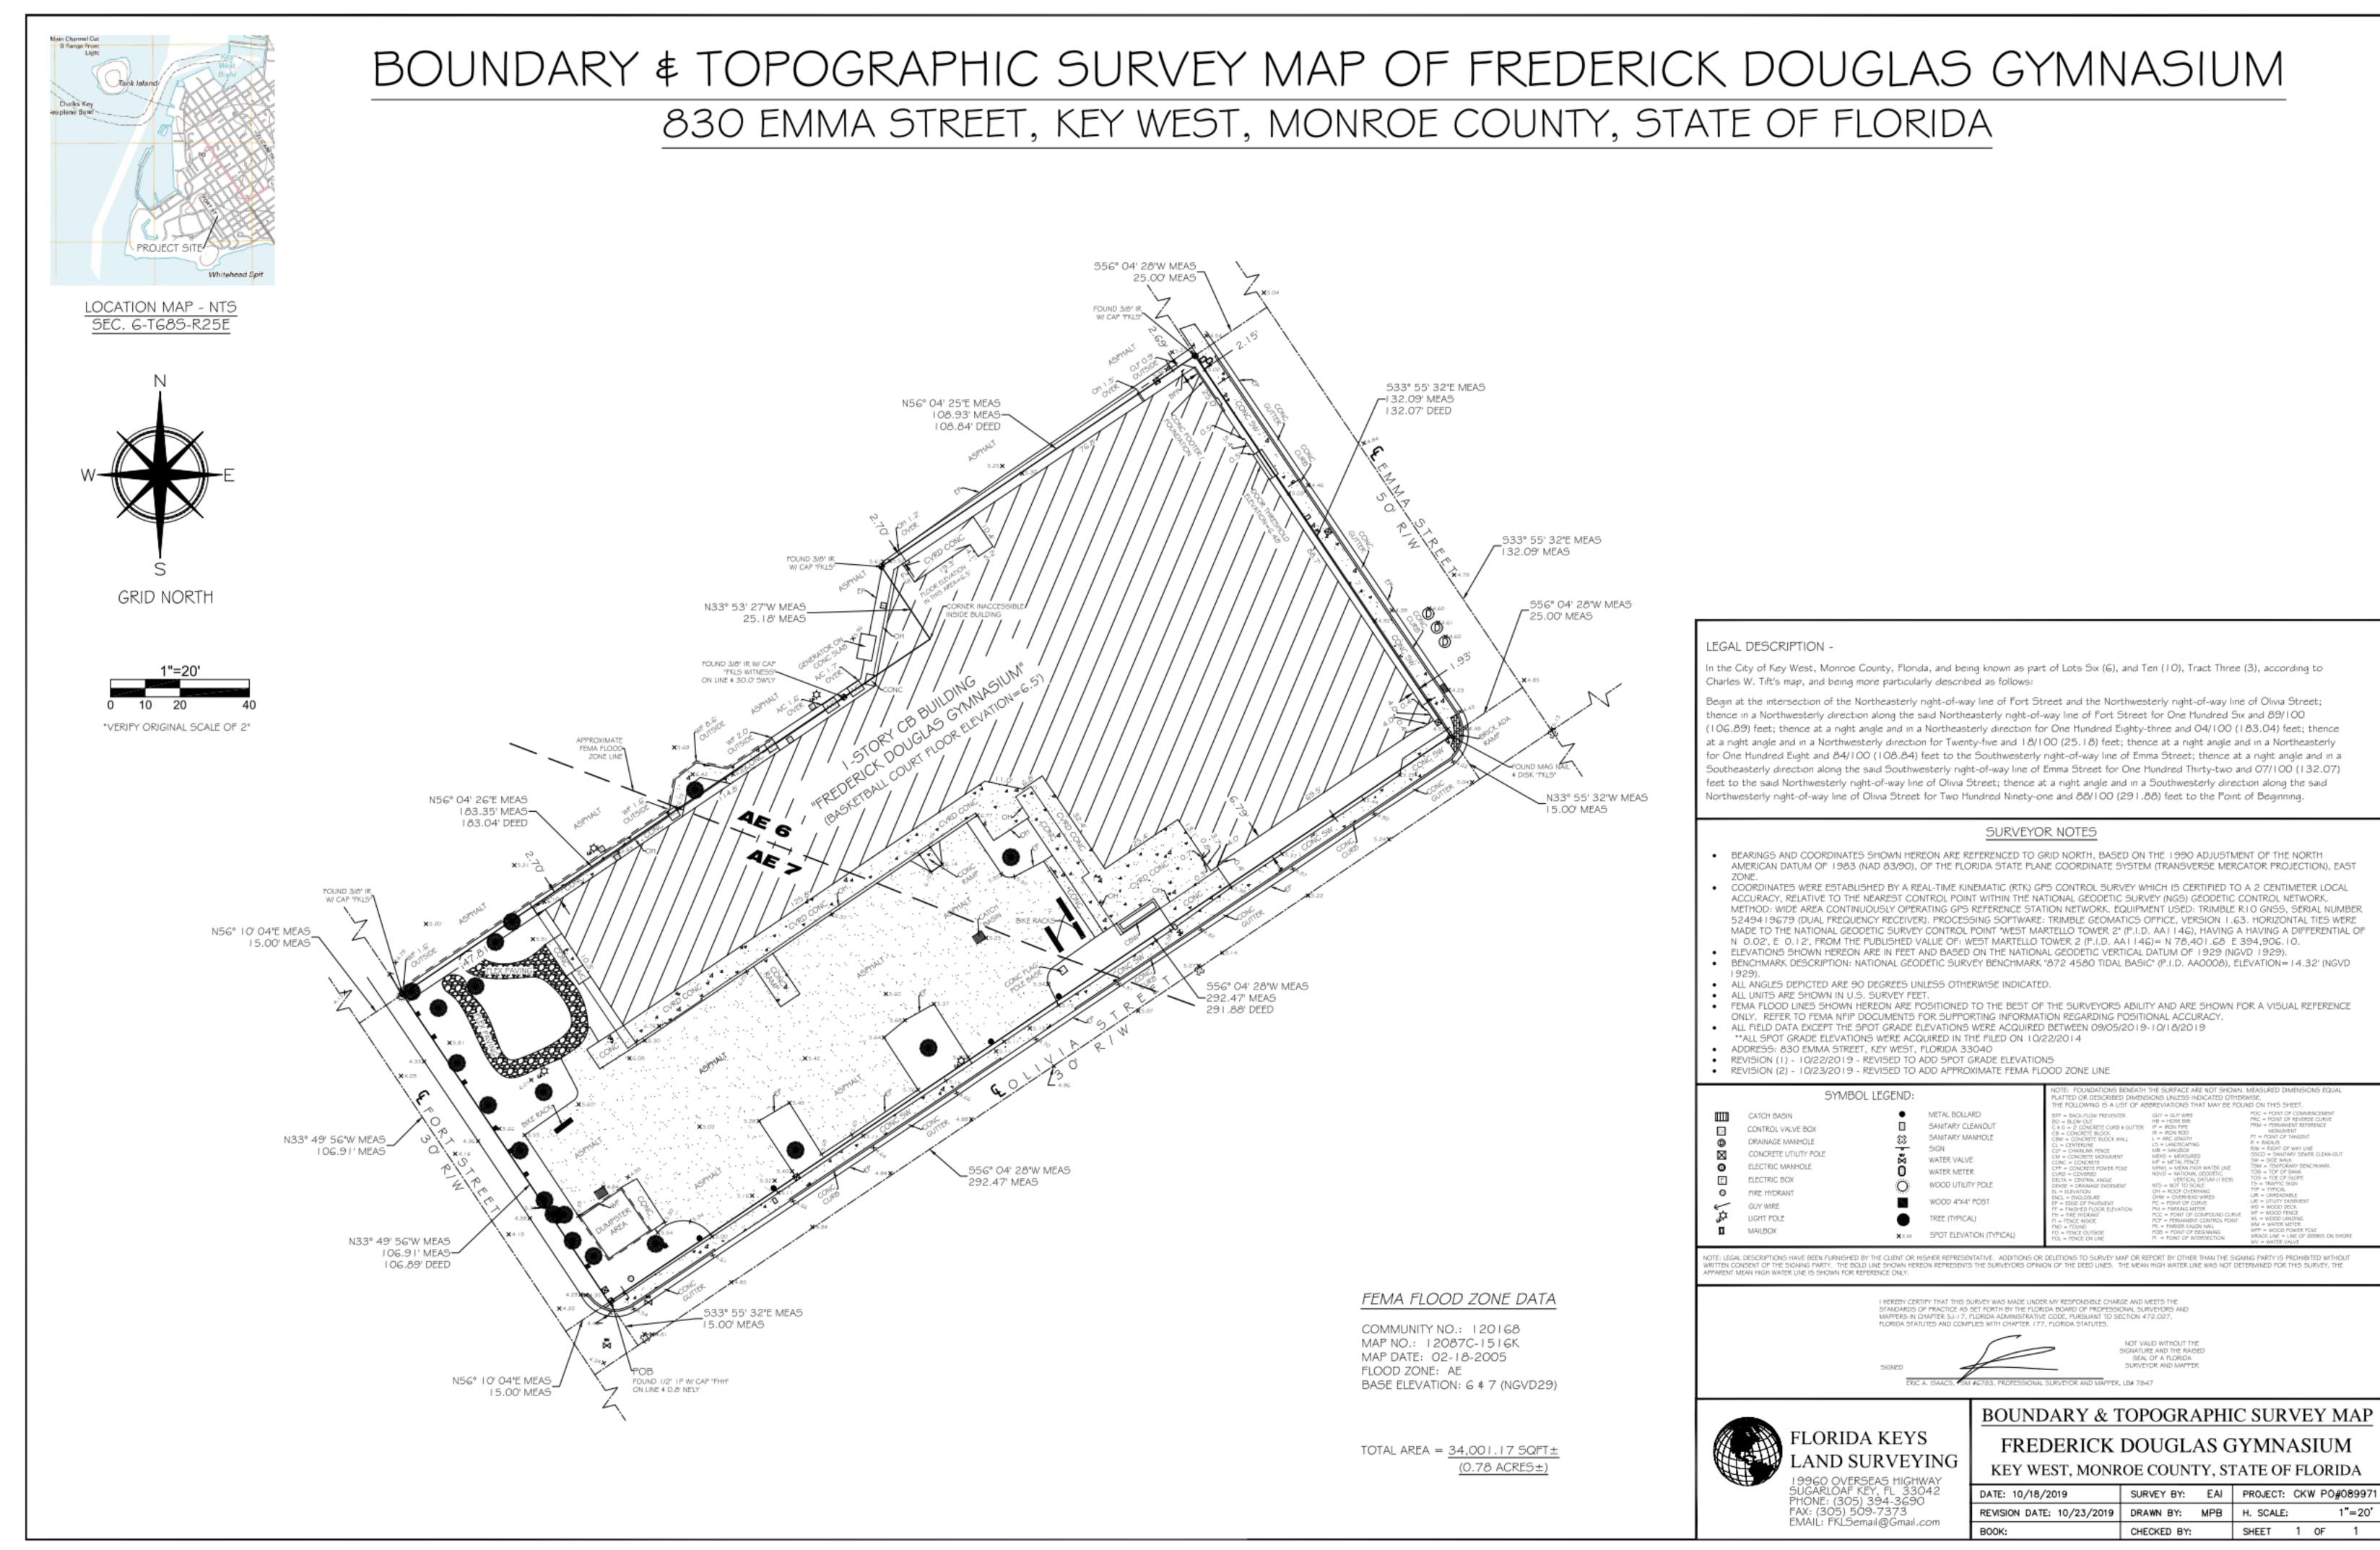ARCHITECT Architecture, Engineer Interior Design, Asset Managemen Specialty Consulting Key Largo, Florida Key West, Florida Marathon, Florida URL: www.k2mdesign.con PROF. REG. AA26001059 Building Relationships Based on Trust and Results eland | Columbus | Indianapolis | Key Largo | est | Marathon | Charlotte | Baltimore | Bent Consultants ISSUED DRC 09/17/202 ISSUED PLANNING 12/09/2021 \geq C DOUGLASS Ś Ш \geq Ш $\overline{\mathbf{Z}}$ REDERICK 0 F U S LL PLOTTED: 12/22/2021 4:23:33 PM Drawing Size | Project #: 30x42 19095 Drawn By: Checked By: LBB/EHP EG SITE SURVEY Sheet Number: V1.1.1 Date: 08/04/2021 ©2021 by K2M Design, Inc.



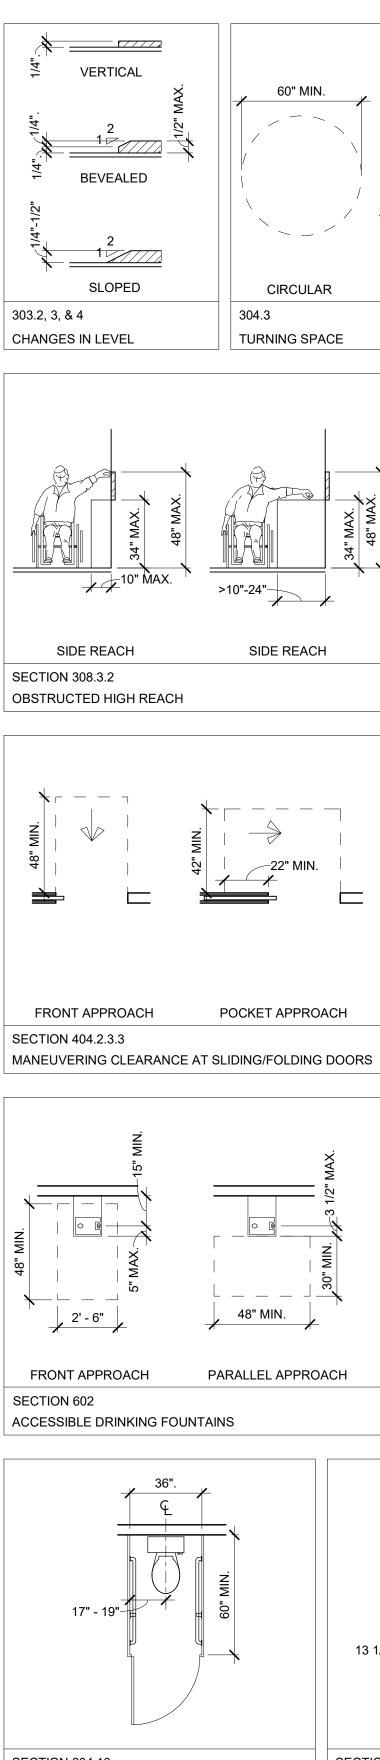

SECTION 604.10 AMBULATORY ACCESSIBLE COMPARTMENTS



NOTES


GENERAL NOTES: THESE DETAILS GOVERN IN THE EVENT OF ANY DISCREPANCIES ELSEWHERE IN THE DRAWINGS. NOTIFY ARCHITECT OF ANY DISCREPANCIES PRIOR TO INSTALLATION. OF ANY ITEMS. INCLUDED DETAILS MAY OR MAY NOT BE USED ON THIS PROJECT. DO NOT SCALE DRAWINGS.

ADDITI	ONAL ICC 117.1-2009 CODE REFERENCES:
1.	301.2 OVERLAP. UNLESS OTHERWISE SPECIFIED, CLEAR FLOOR SPACES, CLEARANCES AT FIXTURES,
	MANEUVERING CLEARANCES AT DOORS, AND TURNING SPACES SHALL BE PERMITTED TO OVERLAP.
2.	302.3 OPENINGS. OPENINGS IN FLOOR SURFACES SHALL BE OF A SIZE THAT DOES NOT PERMIT THE
	PASSAGE OF A 1/2" DIAMETER SPHERE, EXCEPT AS ALLOWED ELSEWHERE IN THIS CODE. ELONGATED
	OPENINGS SHALL BE PLACED SO THAT THE LONG DIMENSION IS PERPENDICULAR TO THE PREDOMINANT
	FION OF TRAVEL.
3.	304.4 DOOR SWING. UNLESS OTHERWISE SPECIFIED, DOORS SHALL BE PERMITTED TO SWING INTO TURNING SPACES.
4.	306.1 GENERAL. WHERE SPACE BENEATH AN ELEMENT IS INCLUDED AS PART OF CLEAR FLOOR SPACE
	AT AN ELEMENT, CLEARANCE AT AN ELEMENT, OR A TURNING SPACE, THE SPACE SHALL COMPLY WITH
	SECTION 306.
5.	307.4 VERTICAL CLEARANCE. VERTICAL CLEARANCE SHALL BE 80 INCHES MINIMUM. RAILS OR OTHER
0.	BARRIERS SHALL BE PROVIDED WHERE THE VERTICAL CLEARANCE IS LESS THAN 80 INCHES. THE
	LEADING EDGE OF SUCH RAILS OR BARRIER SHALL BE LOCATED 27 INCHES MAXIMUM ABOVE THE FLOOR
6.	309.4 OPERATION. OPERABLE PARTS SHALL BE OPERABLE WITH ONE HAND AND SHALL NOT REQUIRE
	TIGHT GRASPING, PINCHING, OR TWISTING OF THE WRIST. THE FORCE REQUIRED TO ACTIVATE
	OPERABLE PARTS SHALL BE 5.0 POUNDS MAXIMUM.
7.	403.5 CLEAR WIDTH. THE CLEAR WIDTH OF AN ACCESSIBLE ROUTE SHALL BE 36 INCHES MINIMUM.
7.1.	EXCEPTION: THE CLEAR WIDTH SHALL BE PERMITTED TO BE REDUCED TO 32 INCHES MINIMUM FOR A
	LENGTH OF 24 INCHES MAXIMUM PROVIDED THE REDUCED WIDTH SEGMENTS ARE SEPARATED BY
	SEGMENTS THAT ARE 48 INCHES MINIMUM IN LENGTH AND 36 INCHES MINIMUM IN WIDTH.
8.	404.2.4 THRESHOLDS. IF PROVIDED, THRESHOLDS AT DOORWAYS SHALL BE 1/2 INCH MAXIMUM IN HEIGHT
	RAISED THRESHOLDS AND CHANGES IN LEVEL AT DOORWAYS SHALL COMPLY WITH SECTIONS 302 AND 303.
8.1.	EXCEPTION: AN EXISTING OR ALTERED THRESHOLD SHALL BE PERMITTED TO BE 3/4 INCH MAXIMUM IN
0.1.	HEIGHT PROVIDED THAT THE THRESHOLD HAS A BEVELED EDGE ON EACH SIDE WITH A MAXIMUM SLOPE
OF 1.2	FOR THE HEIGHT EXCEEDING 1/4 INCH.
9.	404.2.6 DOOR HARDWARE. HANDLES, PULLS, LATCHES, LOCKS, AND OTHER OPERABLE PARTS ON
0.	ACCESSIBLE DOORS SHALL HAVE A SHAPE THAT IS EASY TO GRASP WITH ONE HAND AND DOES NOT
	REQUIRE TIGHT GRASPING, PINCHING, OR TWISTING OF THE WRIST TO OPERATE. OPERABLE PARTS OF
	SUCH HARDWARE SHALL BE 34 INCHES MINIMUM AND 48 INCHES MM) MAXIMUM ABOVE THE FLOOR.
	WHERE SLIDING DOORS ARE IN THE FULLY OPEN POSITION, OPERATING HARDWARE SHALL BE
	EXPOSED AND USABLE FROM BOTH SIDES.
10.	404.2.7.1 DOOR CLOSERS. DOOR CLOSERS SHALL BE ADJUSTED SO THAT FROM AN OPEN POSITION OF
	90 DEGREES, THE TIME REQUIRED TO MOVE THE DOOR TO AN OPEN POSITION OF 12 DEGREES SHALL
	BE 5 SECONDS MINIMUM.
11.	404.2.8 DOOR-OPENING FORCE. FIRE DOORS SHALL HAVE THE MINIMUM OPENING FORCE ALLOWABLE
	BY THE APPROPRIATE ADMINISTRATIVE AUTHORITY. THE FORCE FOR PUSHING OR PULLING OPEN DOORS OTHER THAN FIRE DOORS SHALL BE AS FOLLOWS:
	1. INTERIOR HINGED DOOR: 5.0 POUNDS MAXIMUM
	2. SLIDING OR FOLDING DOOR: 5.0 POUNDS MAXIMUM
	THESE FORCES DO NOT APPLY TO THE FORCE REQUIRED TO RETRACT LATCH BOLTS OR DISENGAGE
	OTHER DEVICES THAT HOLD THE DOOR IN A CLOSED POSITION.
12.	405.2 SLOPE. RAMP RUNS SHALL HAVE A RUNNING SLOPE GREATER THAN 1 :20 AND NOT STEEPER
	THAN 1 :12.
13.	405.3 CROSS SLOPE. CROSS SLOPE OF RAMP RUNS SHALL NOT BE STEEPER THAN 1 :48.
14.	504.5 NOSINGS. THE RADIUS OF CURVATURE AT THE LEADING EDGE OF THE TREAD SHALL BE 1/2 INCH
	MAXIMUM. NOSINGS THAT PROJECT BEYOND RISERS SHALL HAVE THE UNDERSIDE OF THE LEADING
	EDGE CURVED OR BEVELED. RISERS SHALL BE PERMITTED TO SLOPE UNDER THE TREAD AT AN ANGLE
	OF 30 DEGREES MAXIMUM FROM VERTICAL. THE PERMITTED PROJECTION OF THE NOSING SHALL BE 11/2 INCHES MAXIMUM OVER THE TREAD OR FLOOR BELOW.
15.	504.5.1 VISUAL CONTRAST. THE LEADING 2 INCHES (51 MM) OF THE TREAD SHALL HAVE VISUAL
10.	CONTRAST OF DARKON-LIGHT OR LIGHT-ON-DARK FROM THE REMAINDER OF THE TREAD.
16.	604.6 FLUSH CONTROLS. FLUSH CONTROLS SHALL BE HAND OPERATED OR AUTOMATIC. HAND
	OPERATED FLUSH CONTROLS SHALL COMPLY WITH SECTION 309. FLUSH CONTROLS SHALL BE
	LOCATED ON THE OPEN SIDE OF THE WATER CLOSET.
17.	604.9.3 DOORS. TOILET COMPARTMENT DOORS, INCLUDING DOOR HARDWARE, SHALL COMPLY WITH
	SECTION 404, EXCEPT IF THE APPROACH IS TO THE LATCH SIDE OF THE COMPARTMENT DOOR
	CLEARANCE BETWEEN THE DOOR SIDE OF THE STALL AND ANY OBSTRUCTION SHALL BE 42 INCHES
	MINIMUM. THE DOOR SHALL BE SELF-CLOSING. A DOOR I PULL COMPLYING WITH SECTION 404.2.6 SHALL
	BE PLACED ON BOTH SIDES OF THE DOOR NEAR THE LATCH. TOILET COMPARTMENT DOORS SHALL NOT
10	SWING INTO THE REQUIRED MINIMUM AREA OF THE COMPARTMENT.
18.	604.9.5.1 TOE CLEARANCE AT COMPARTMENTS. THE FRONT PARTITION AND AT LEAST ONE SIDE PARTITION SHALL PROVIDE A TOE CLEARANCE OF 9 INCHES MINIMUM ABOVE THE FLOOR AND
	EXTENDING 6 INCHES BEYOND THE COMPARTMENT SIDE FACE OF THE PARTITION, EXCLUSIVE OF
	PARTITION SUPPORT MEMBERS.
19.	604.9.6 GRAB BARS. GRAB BARS SHALL COMPLY WITH SECTION 609. SIDE WALL GRAB BARS COMPLYING
10.	WITH SECTION 604.5.1 LOCATED ON THE WALL CLOSEST TO THE WATER CLOSET, AND A REAR WALL
	GRAB BAR COMPLYING WITH SECTION 604.5.2, SHALL BE PROVIDED.
20.	604.10.3 DOORS. TOILET COMPARTMENT DOORS, INCLUDING DOOR HARDWARE, SHALL COMPLY WITH
	SECTION 404, EXCEPT IF THE APPROACH IS TO THE LATCH SIDE OF THE COMPARTMENT DOOR THE
	CLEARANCE BETWEEN THE DOOR SIDE OF THE COMPARTMENT AND ANY OBSTRUCTION SHALL BE 42
	INCHES MINIMUM. THE DOOR SHALL BE SELF-CLOSING. A DOOR PULL COMPLYING WITH SECTION 404.2.6
	SHALL BE PLACED ON BOTH SIDES OF THE DOOR NEAR THE LATCH. COMPARTMENT DOORS SHALL NOT
	SWING INTO THE REQUIRED MINIMUM AREA OF THE COMPARTMENT.
21.	604.10.4 GRAB BARS. GRAB BARS SHALL COMPLY WITH SECTION 609. SIDE WALL GRAB BARS
20	COMPLYING WITH SECTION 604.5.1 SHALL BE PROVIDED ON BOTH SIDES OF THE COMPARTMENT.
22.	607.5 CONTROLS. CONTROLS, OTHER THAN DRAIN STOPPERS, SHALL BE PROVIDED ON AN END WALL,
	LOCATED BETWEEN THE BATHTUB RIM AND GRAB BAR, AND BETWEEN THE OPEN SIDE OF THE BATHTUB AND THE CENTERLINE OF THE WIDTH OF THE BATHTUB. CONTROLS SHALL COMPLY WITH
	SECTION 309.4.
23.	607.6 HAND SHOWER. A HAND SHOWER WITH A HOSE 59 INCHES MINIMUM IN LENGTH, THAT CAN BE
- - .	USED AS BOTH A FIXED SHOWER HEAD AND AS A HAND SHOWER, SHALL BE PROVIDED. THE HAND
	SHOWER SHALL HAVE A CONTROL WITH A NONPOSITIVE SHUT-OFF FEATURE. WHERE PROVIDED, AN
	ADJUSTABLE HEIGHT HAND SHOWER MOUNTED ON A VERTICAL BAR SHALL BE INSTALLED SO AS TO
	NOT OBSTRUCT THE USE OF GRAB BARS.
24.	607.7 BATHTUB ENCLOSURES. ENCLOSURES FOR BATHTUBS SHALL NOT OBSTRUCT CONTROLS,
	FAUCETS, SHOWER AND SPRAY UNITS OR OBSTRUCT TRANSFER FROM WHEELCHAIRS ONTO BATHTUB
	SEATS OR INTO BATHTUBS. ENCLOSURES ON BATHTUBS SHALL OT HAVE TRACKS INSTALLED ON THE

SYMBOL LEGEND


RIM OF THE BATHTUB.


36" MIN.	MINIMUM CLEAR DIMENSION.	48" MAX.	MAXIMUM DIMENSION.
→ ^{33" - 36"} /	DIMENSION INDICATING A RANGE FROM MINIMUM TO MAXIMUM.	48". /	ABSOLUTE DIMENSION
<pre>x > 24"</pre>	DIMENSION GREATER THAN INDICATED DIMENSION.	x < 24"	DIMENSION GREATER
<pre>x > 24"</pre>	DIMENSION GREATER THAN OR EQUAL TO INDICATED DIMENSION.	x < 24"	DIMENSION GREATER EQUAL TO INDICATED
	BOUNDARY OF CLEAR FLOOR SPACE OR MANEUVERING CLEARANCE.	\langle	DIRECTION OF TRAVEL APPROACH.
	LOCATION ZONE OF ELEMENT, CONTROL, OR FEATURE.	Ę	CENTERLINE.

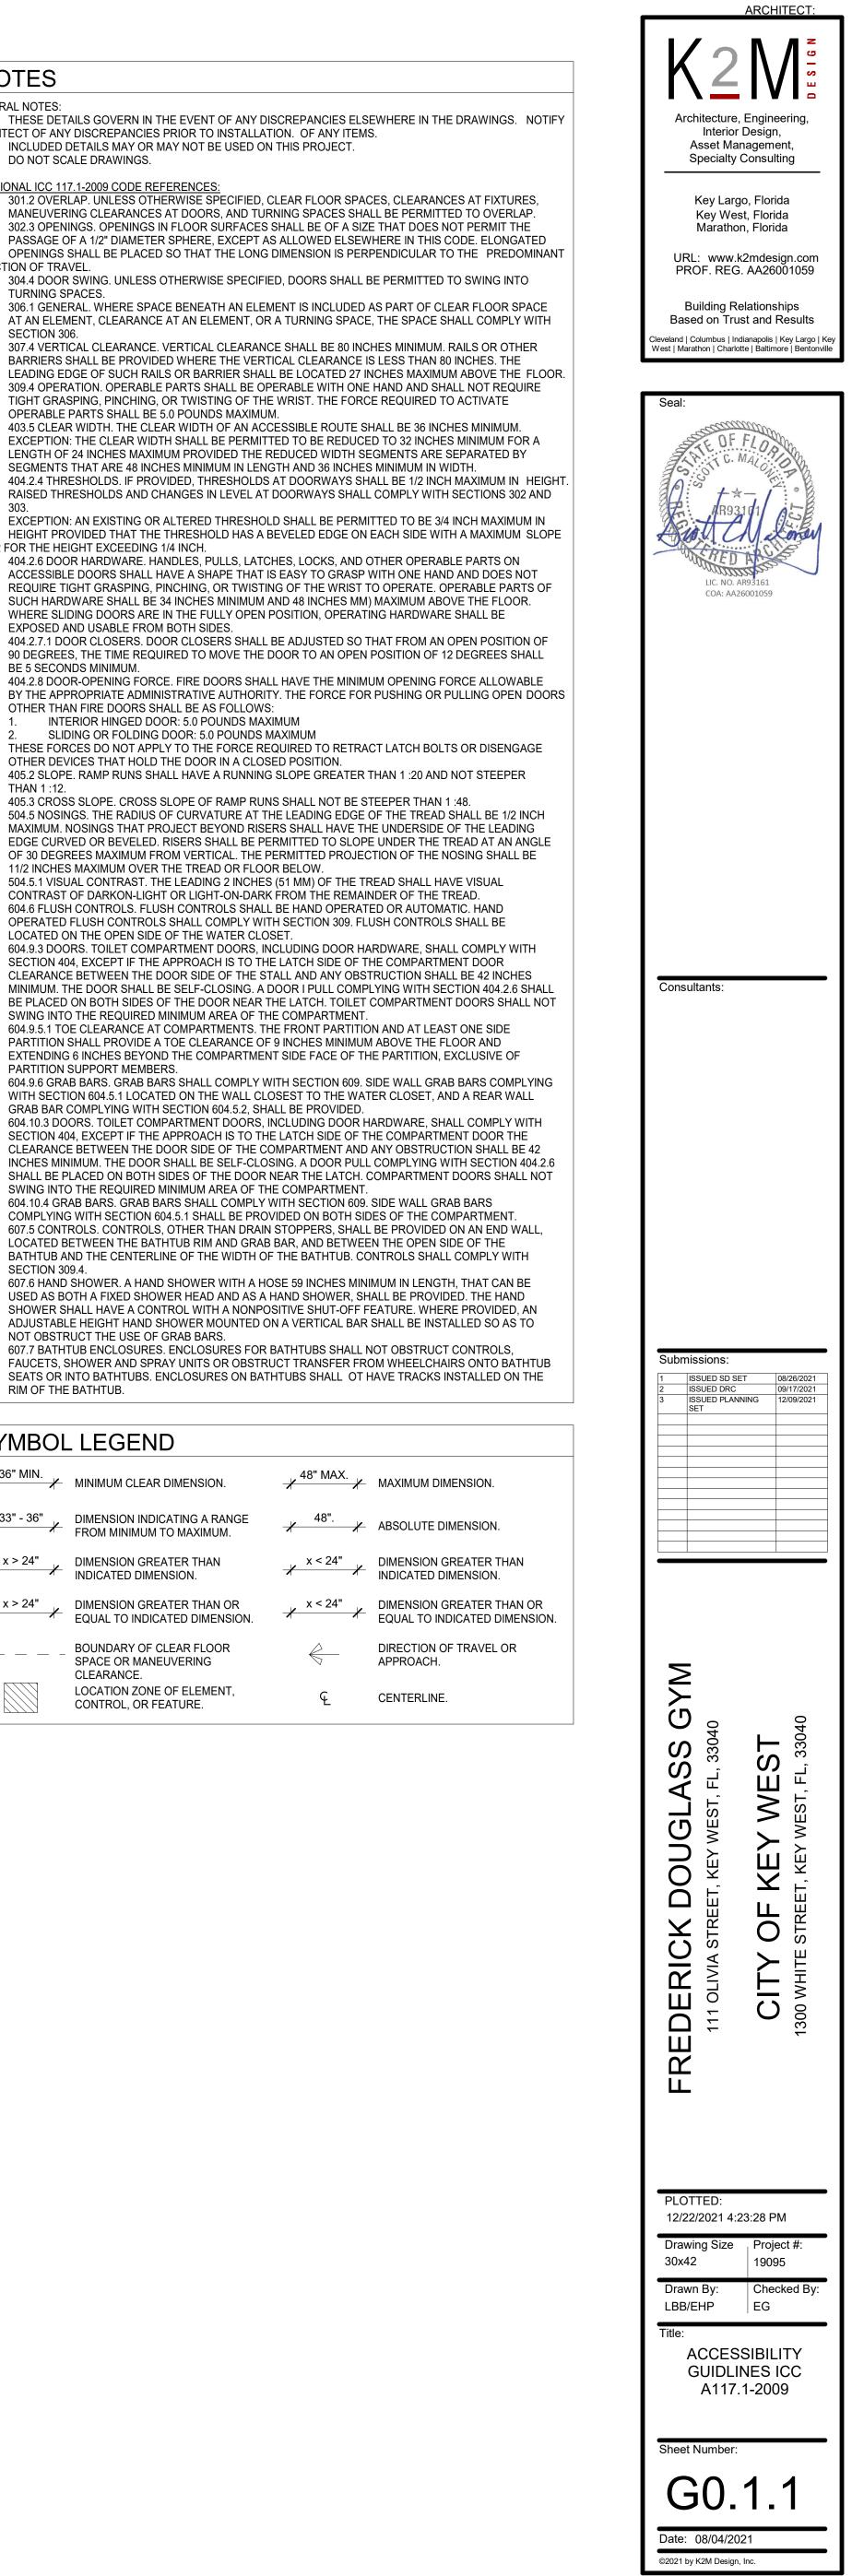




-6" MAX.	60" MIN. BACK WALL	∠ C(
END WALL		END WALL
2" MAX		
	FLOOR CLEARA	NCE
SECTIO	DN 608.3.2	
ROLL II	N TYPE SHOWER CO	MPARTM

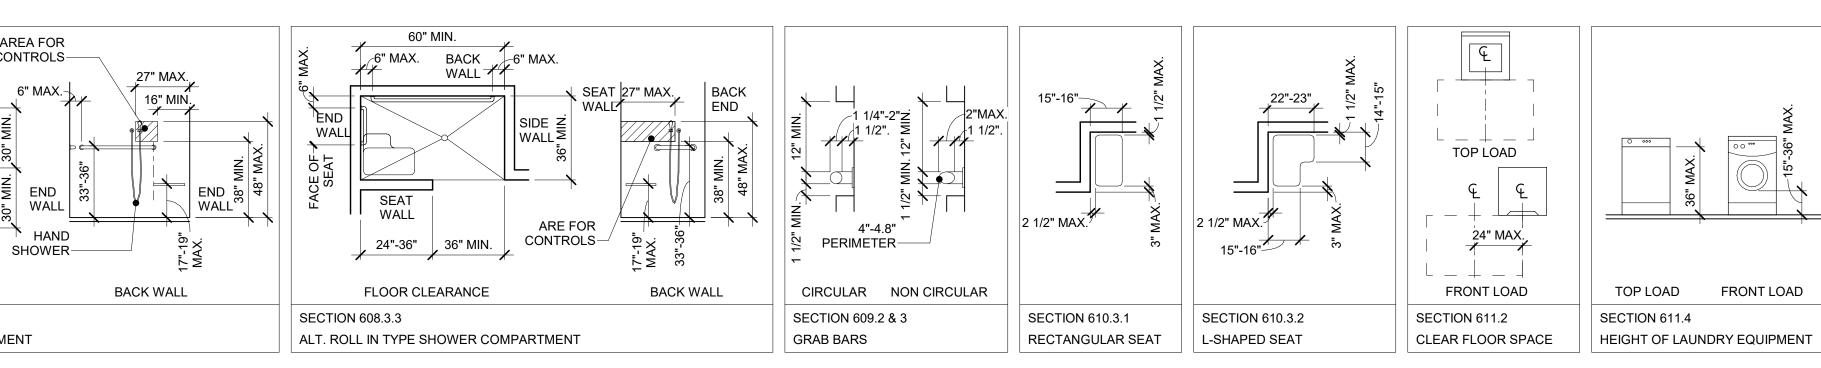


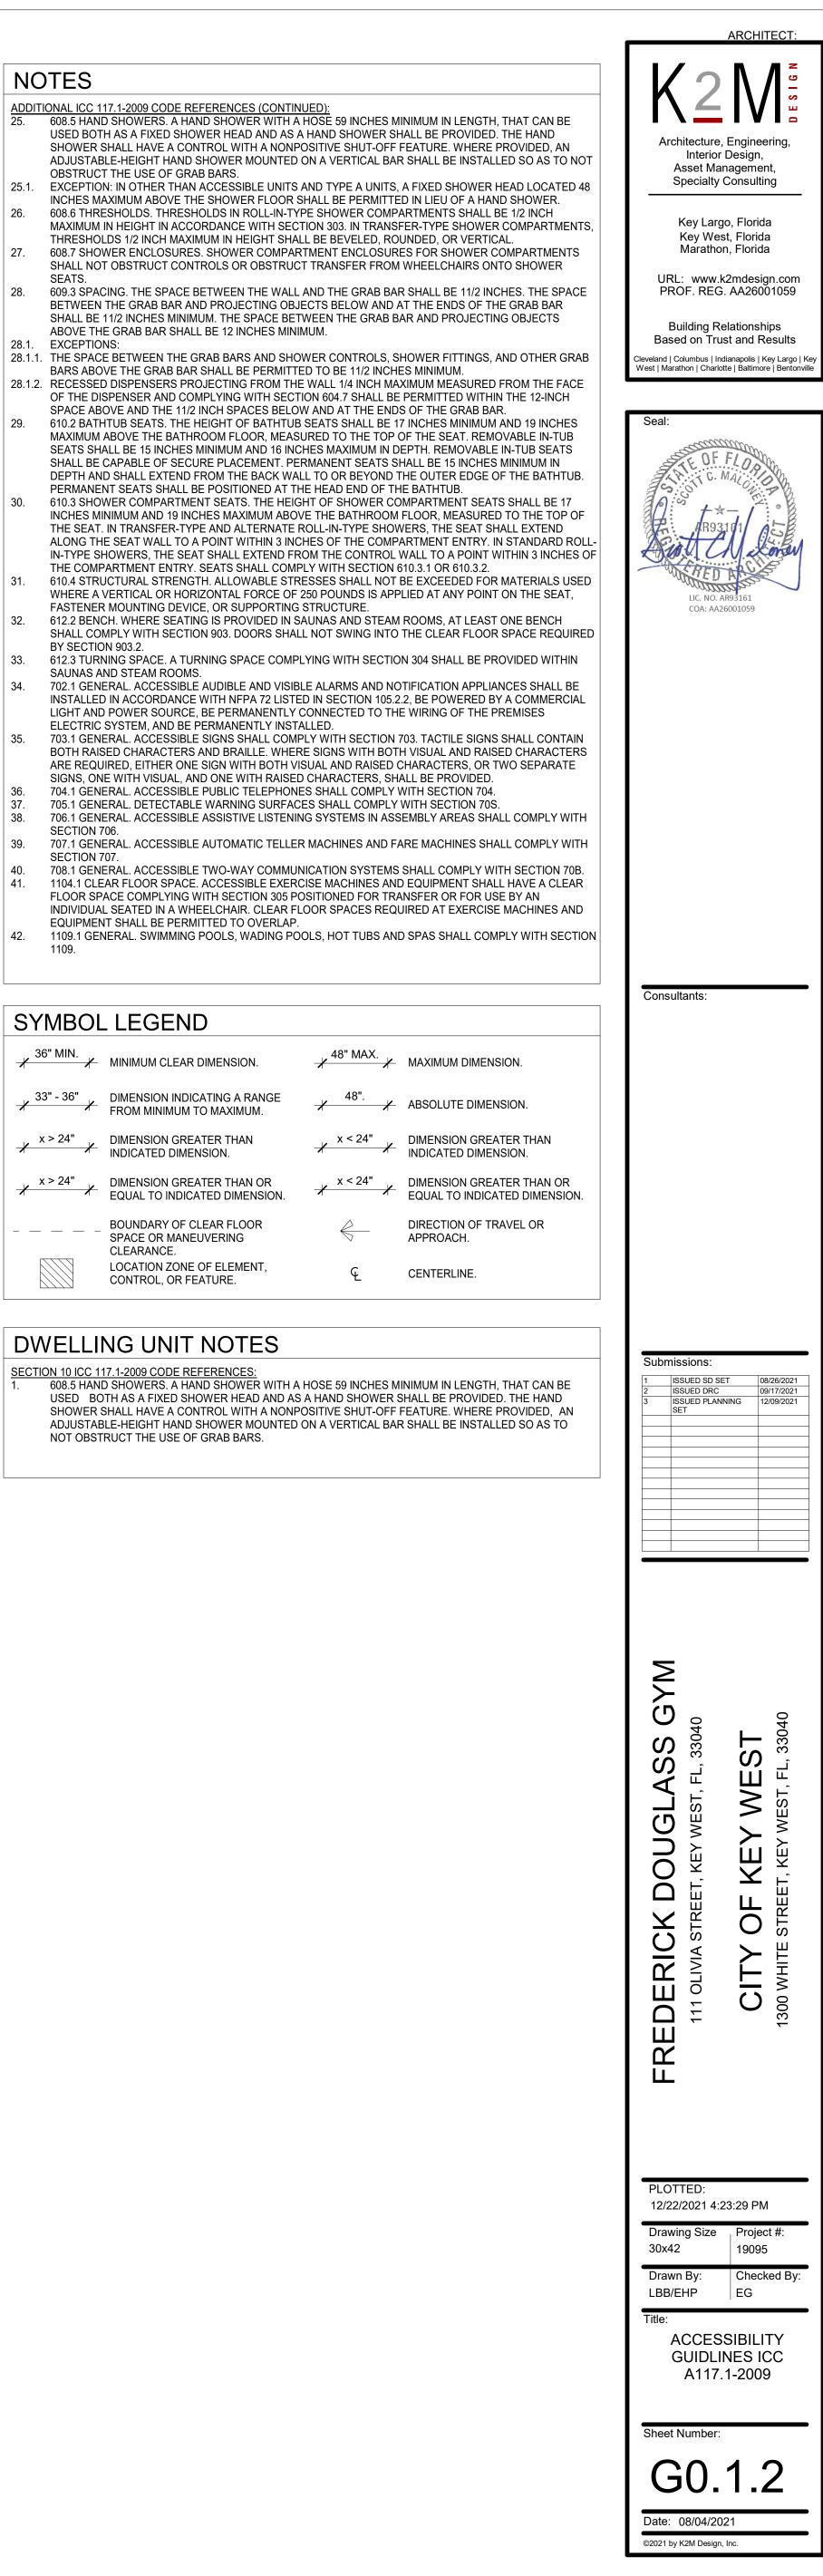


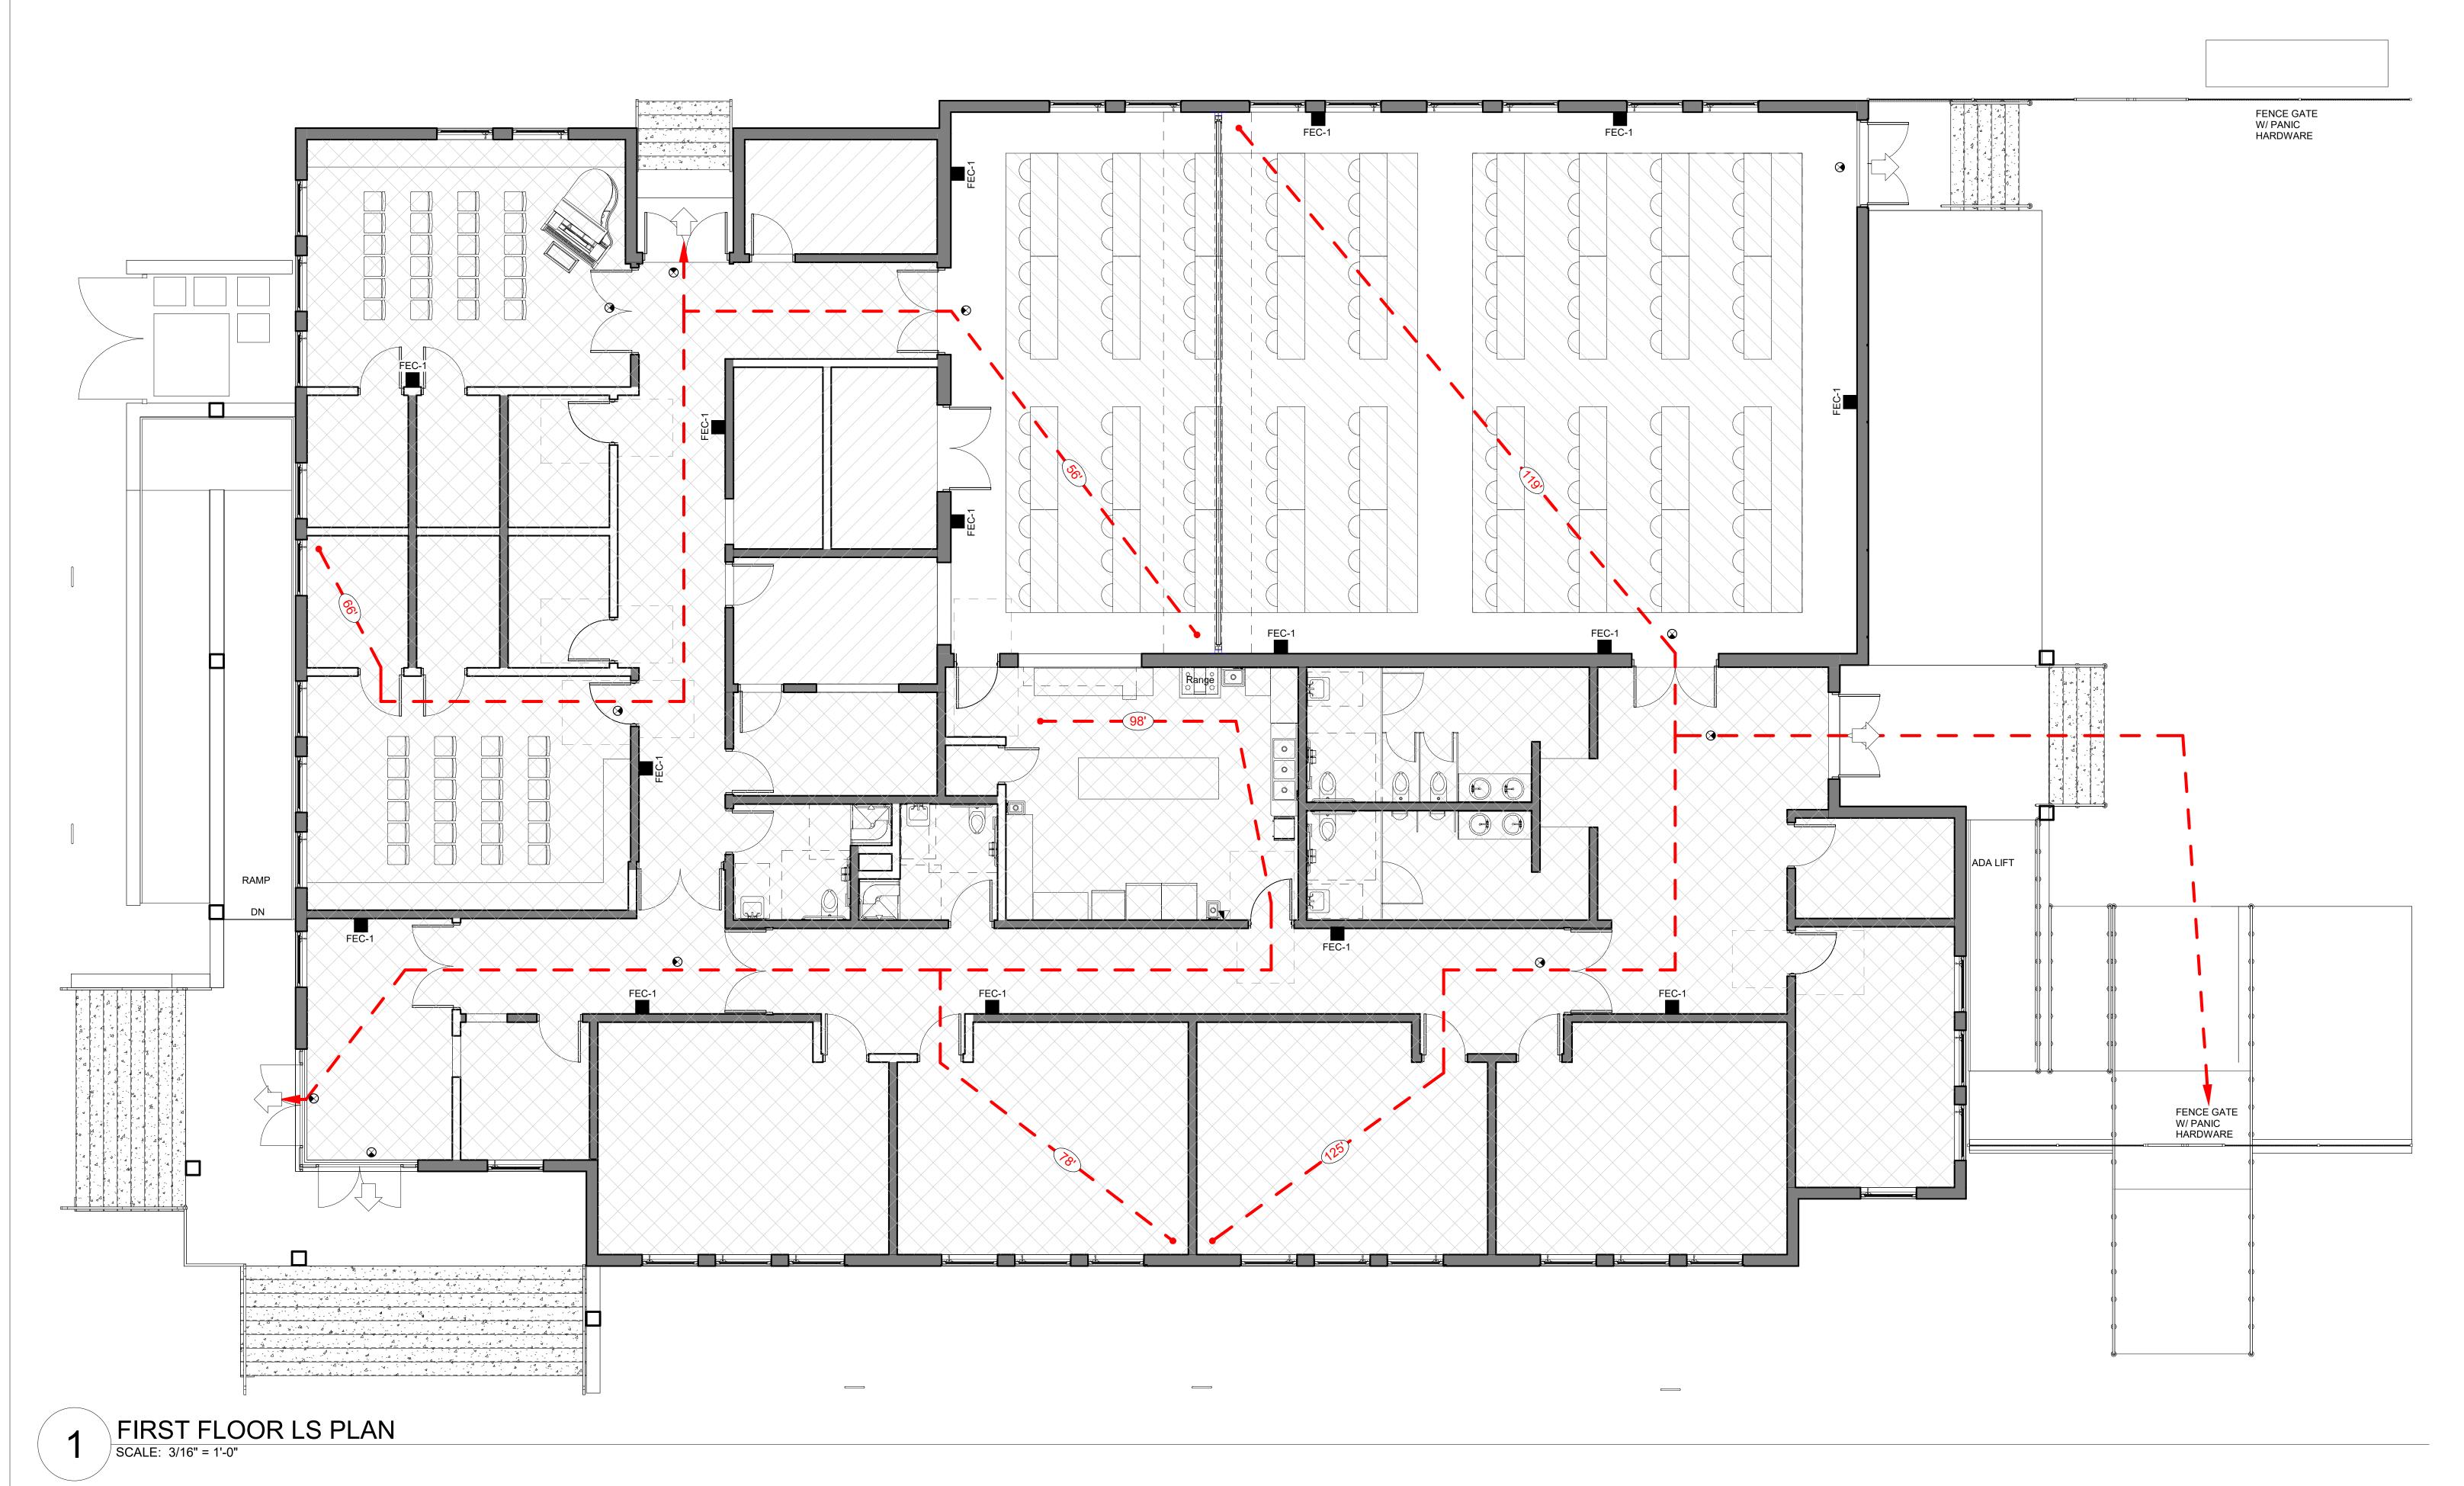



	OCCUPANCY PER SPACE					
ROOM					OCCUPANC	
#	ROOM NAME	AREA	USE GROUP	OCCUPANCY FACTOR	Y	REMARKS
101	MAIN HALL	1660 SF	Δ_3	15 SF/OCCUPANT	110	
110	THINK TANK	85 SF	E - CLASSROOM	20 SF NET/OCCUPANT	4	
111	INCUBATOR SPACE/ CONF RM		E - CLASSROOM	20 SF NET/OCCUPANT	11	
117	CLASSROOM 1	343 SF	E - CLASSROOM	20 SF NET/OCCUPANT	12	
119	CLASSROOM 2	343 SF	E - CLASSROOM	20 SF NET/OCCUPANT	12	
120	MULTI-PURPOSE	343 SF	E - CLASSROOM	20 SF NET/OCCUPANT	12	
120	CLASSROOM 3	343 SF	E - CLASSROOM	20 SF NET/OCCUPANT	12	
126	STUDIO EQUIPMENT ROOM	137 SF	STORAGE	300 GROSS SF/OCCUPANT	1	
127	RECORDING STUDIO	112 SF	E - CLASSROOM	20 SF NET/OCCUPANT	5	
128	MUSIC CLASSROOM	422 SF	E - CLASSROOM	20 SF NET/OCCUPANT	21	
129	PRACTICE	71 SF	E - CLASSROOM	20 SF NET/OCCUPANT	3	
130	PRACTICE	58 SF	E - CLASSROOM	20 SF NET/OCCUPANT	2	
131	PRACTICE	71 SF	E - CLASSROOM	20 SF NET/OCCUPANT	3	
132	PRACTICE	58 SF	E - CLASSROOM	20 SF NET/OCCUPANT	2	
135	MECH/ELEC	117 SF	MECH	300 GROSS SF/OCCUPANT	1	
136	PRACTICE	71 SF	E - CLASSROOM	20 SF NET/OCCUPANT	3	
137	PRACTICE	71 SF	E - CLASSROOM	20 SF NET/OCCUPANT	3	
139	OFFICE	94 SF	E - CLASSROOM	20 SF NET/OCCUPANT	4	
140	MUSIC CLASSROOM	402 SF	E - CLASSROOM	20 SF NET/OCCUPANT	20	
147	KITCHEN	415 SF	E - COMMERCIAL KITCHEN	200 GROSS SF/OCCUPANT	2	
148	STORAGE	102 SF	STORAGE	300 GROSS SF/OCCUPANT	1	
153	VESTIBULE	186 SF	E - CLASSROOM	20 SF NET/OCCUPANT	9	
161	MUSIC STORAGE	86 SF	STORAGE	300 GROSS SF/OCCUPANT	1	
				TOTAL OCCUPANTS:	254	


CODE DATA	LIFE SAFETY PLAN LEGEND:
FREDERICK DOUGLASS GYM EXPANSION 111 OLIVIA STREET KEY WEST, FLORIDA 33040	AED AUTOMATED EXTERNAL DEFIBRILLATOR PROVIDED AND INSTALLED BY OWNER.
USE GROUP: ASSEMBLY A-3 EDUCATIONAL E	EXIT SIGN
OCCUPANCY CALCULATIONS	TRAVEL DISTANCE
A-315 SF/OCCUPANTE - CLASSROOM20 SF NET/OCCUPANTE - COMMERCIAL KITCHEN200 SF GROSS/OCCUPANT	2 HOUR BUILDING ELEMENTS
MECH 300 GROSS SF/OCCUPANT STORAGE 300 GROSS SF/OCCUPANT EGRESS WIDTH = .20"/OCCUPANT 44" REQUIRED	FEC-1 INTERIOR FIRE EXTINGUISHER CABINET WND MP SERIES EXTINGUISHER RECESSED IN WALL AT 4'-8" A.F.F. TO TOP REFER TO DETAIL 7/A8.1.2
TRAVEL DISTANCE: MAX LENGTH OF TRAVEL = 200 FT COMMON PATH OF EGRESS = 75 FT	BUILDING EXIT
NUMBER OF EXITS: REQUIRED = 2 PROVIDED = 3	ASSEMBLY
CONSTRUCTION TYPE: TABLE 601 TYPE IIB BUILDING IS NOT SPRINKLED	EDUCATIONAL
BUILDING WILL BE EQUIPPED WITH A FULLY FUNCTIONAL FIRE ALARM SYSTEM FIRE RESISTANCE RATINGS: SHAFT WALLS 0 HR FIRE STAIR WALLS 0 HR FIRE STAIR WALLS 0 HR	STORAGE
FIRE STAIR DOORS/WINDOWS 0 HR FIRE SEPARATION @ LOBBY 0 HR FIRE SEPARATION @ MAIN HALL 0 HR	
LOBBY INTERIOR DOORS 0 HR NON-LOAD BEARING EXT WALLS 0 HR	GENERAL NOTES
BUILDING SQUARE FOOTAGE: 1ST FLOOR - 9,587 SF	 FINAL LOCATION AND QUANTITY OF FIRE EXTINGUISHERS TO BE COORDINATED WI FIRE INSPECTOR. REFER TO ELECTRICAL DRAWINGS FOR FIRE ALARM DESIGN.

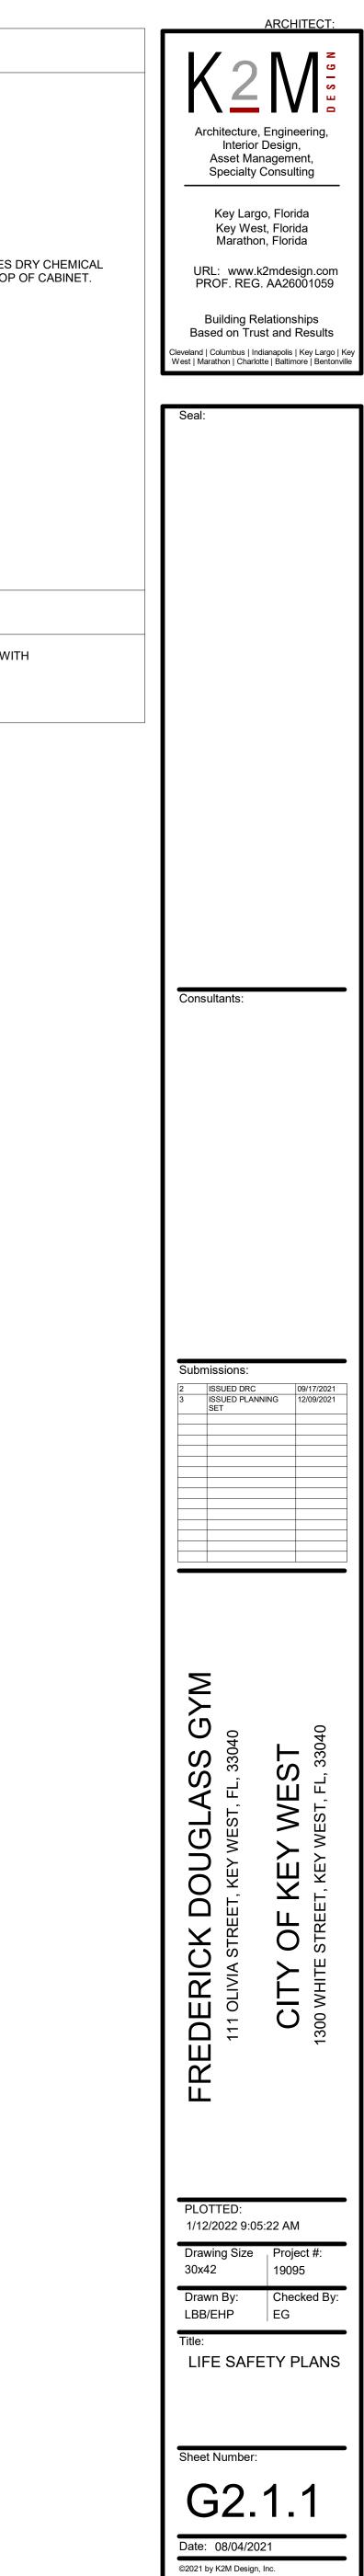


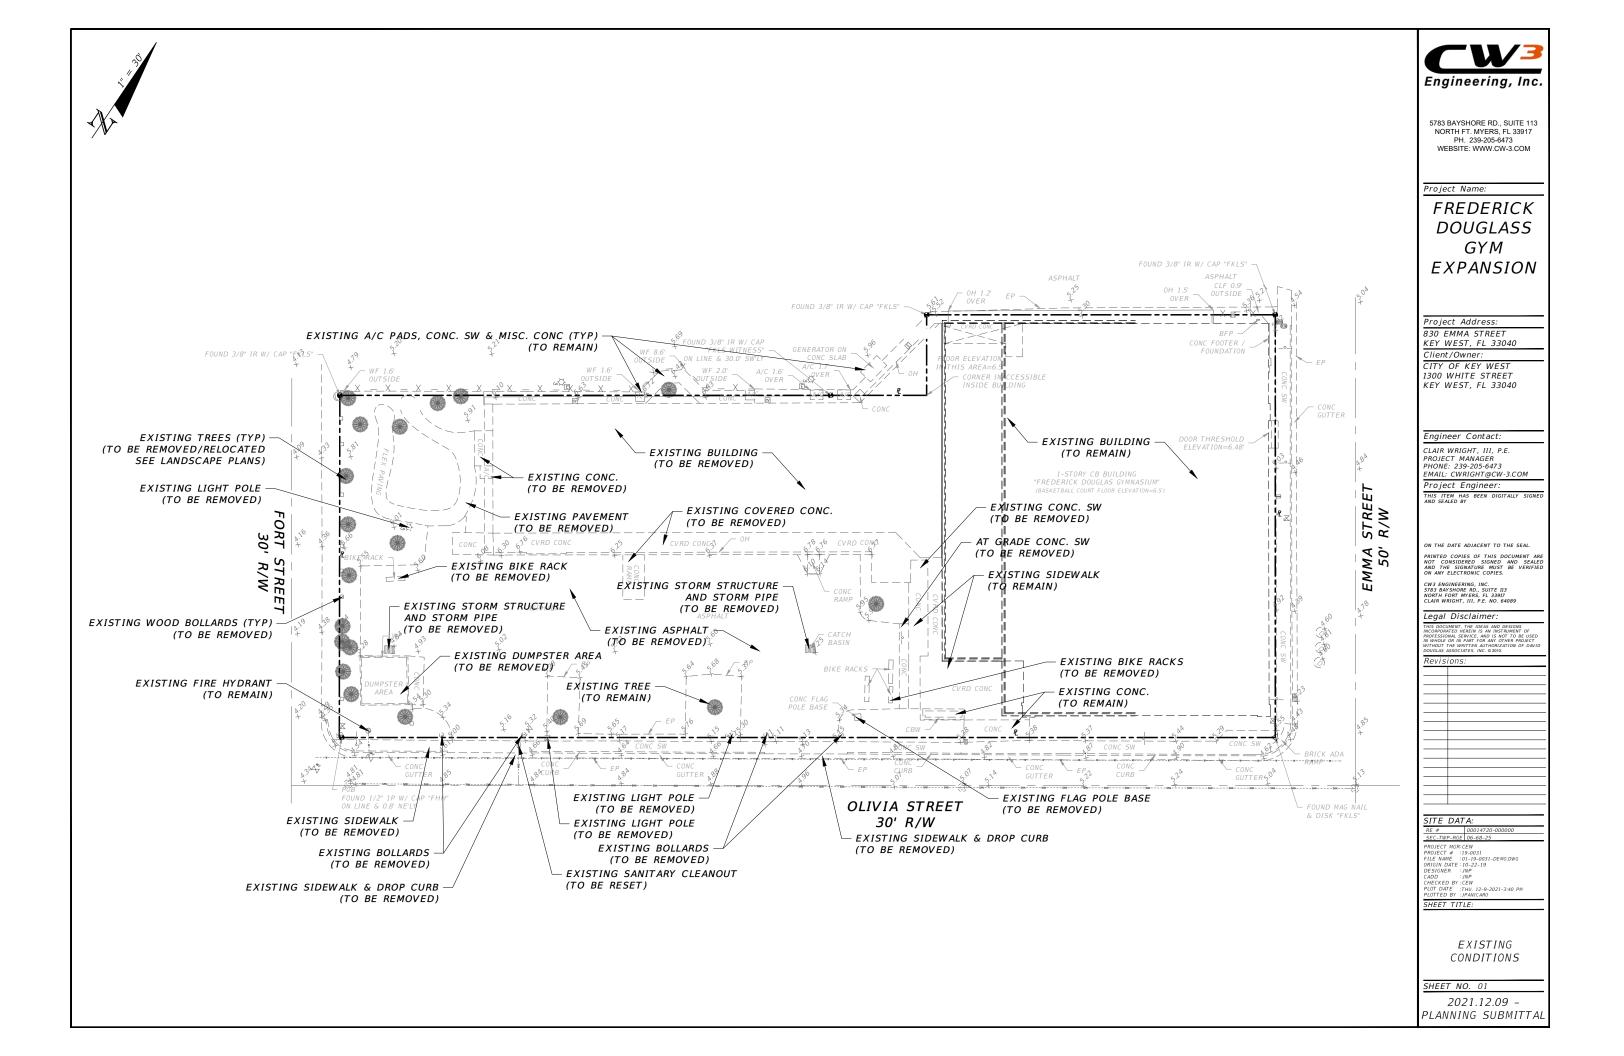

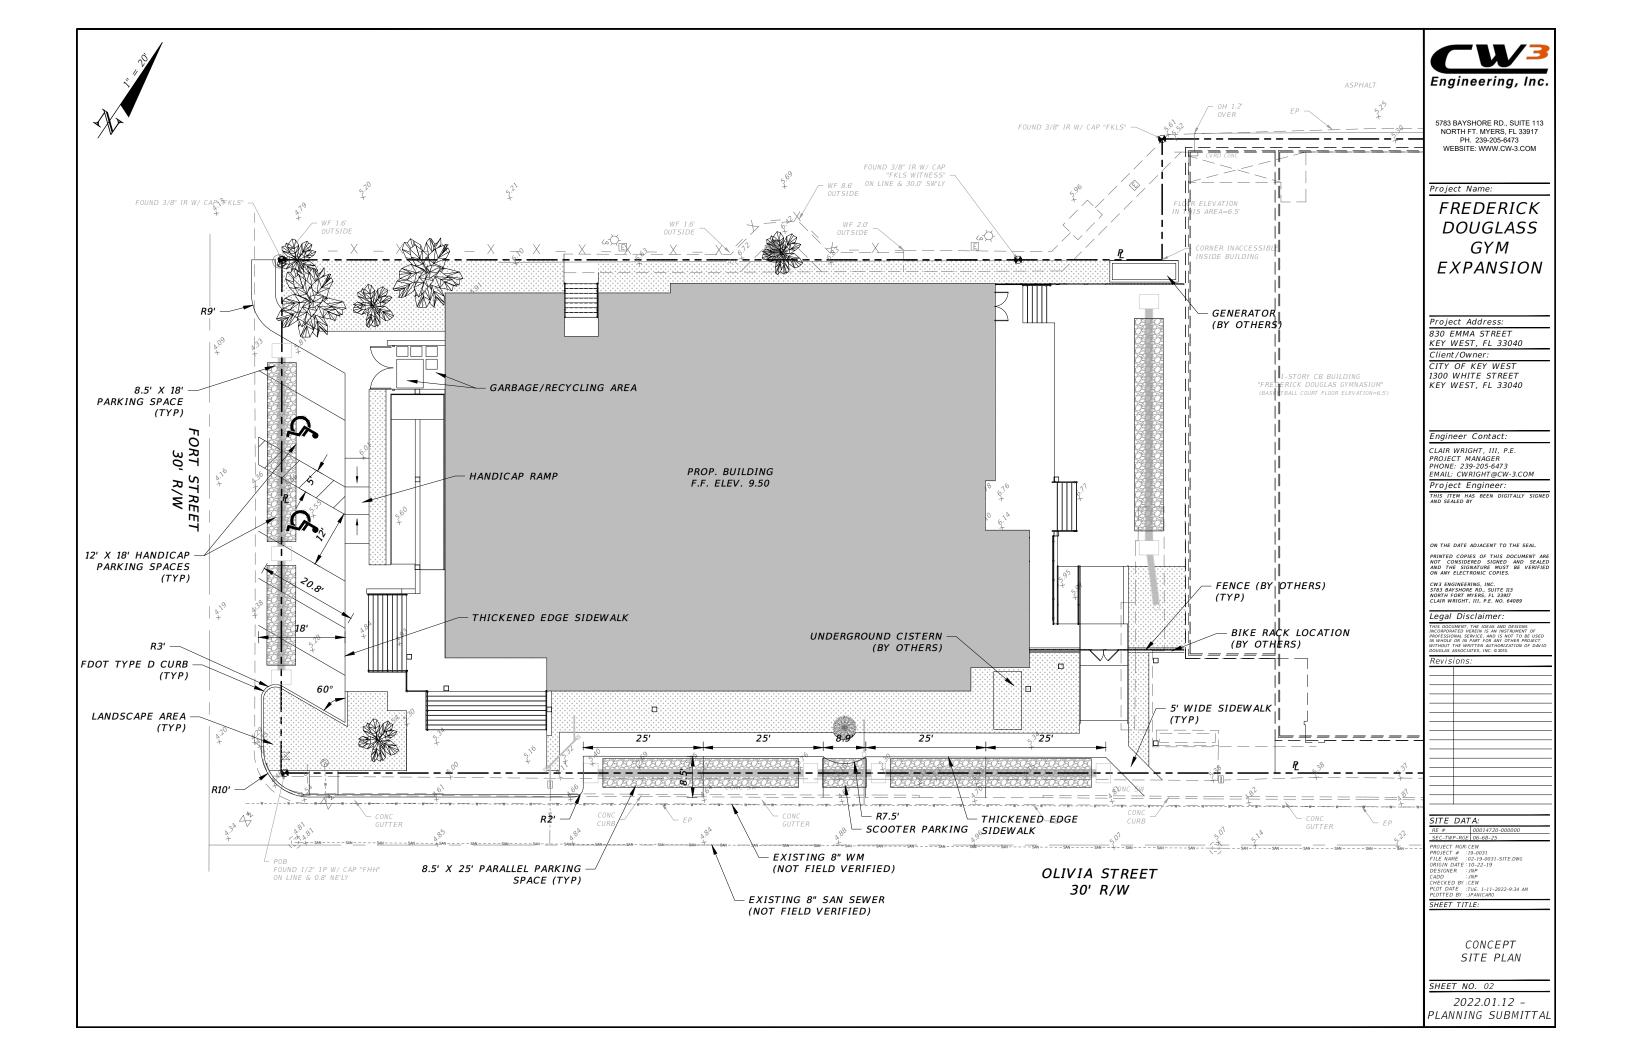

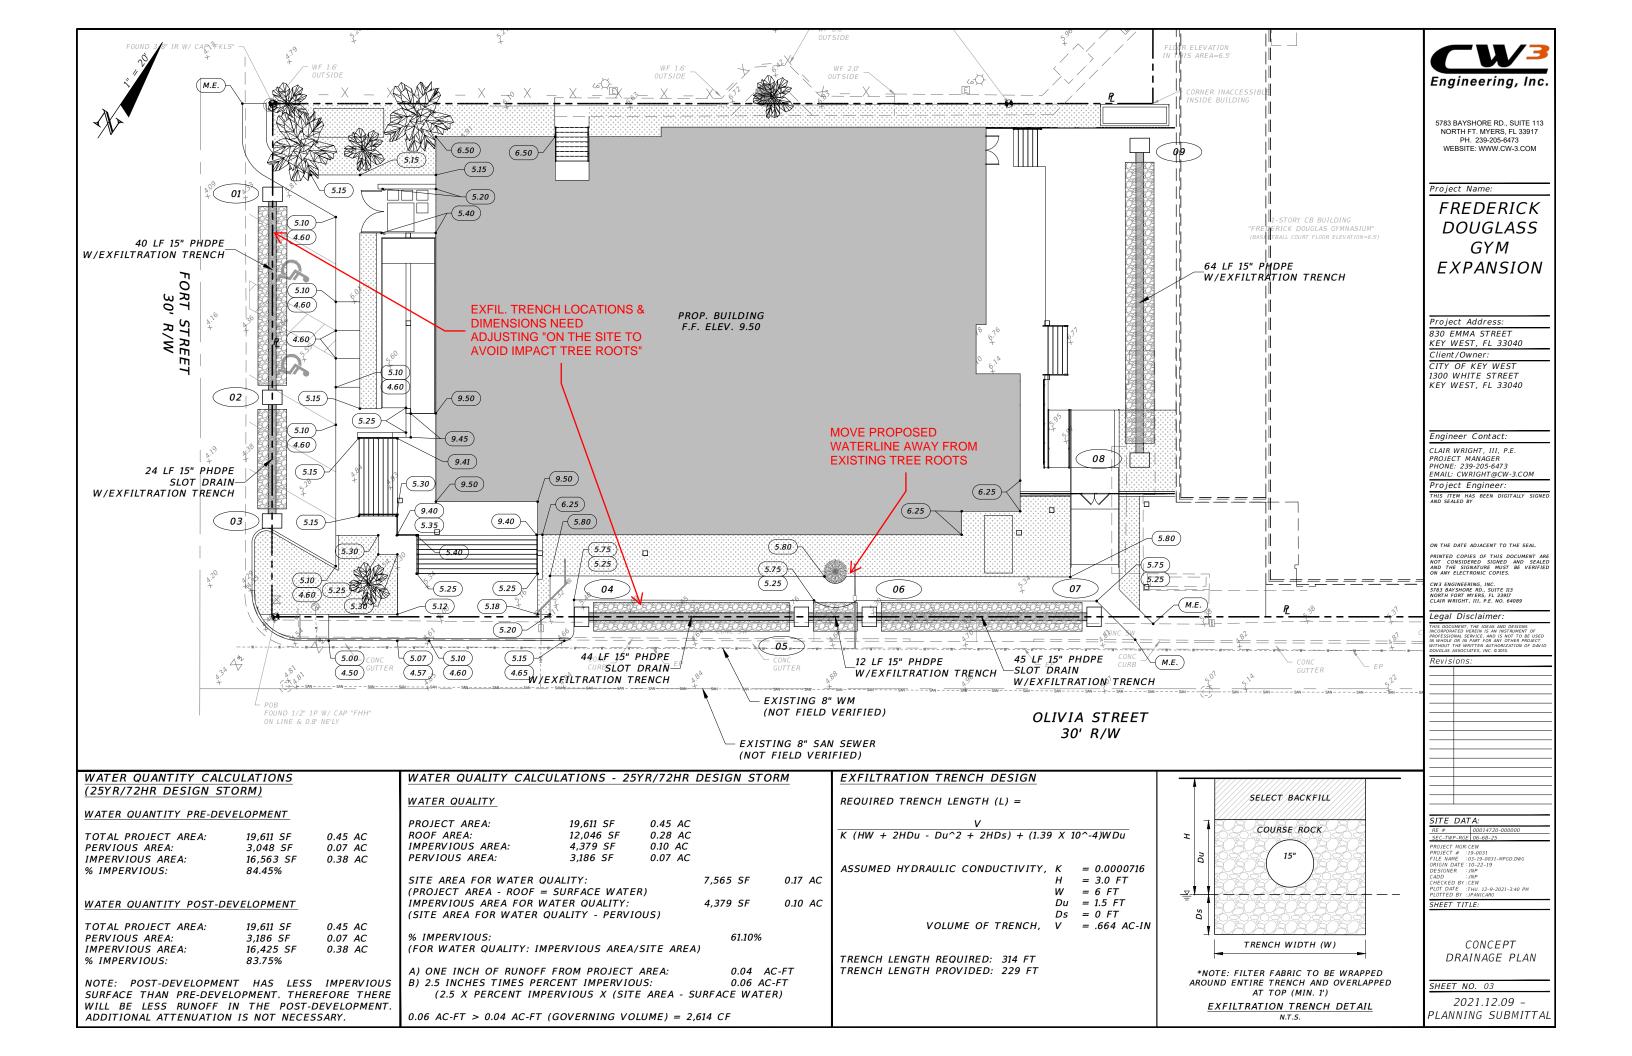

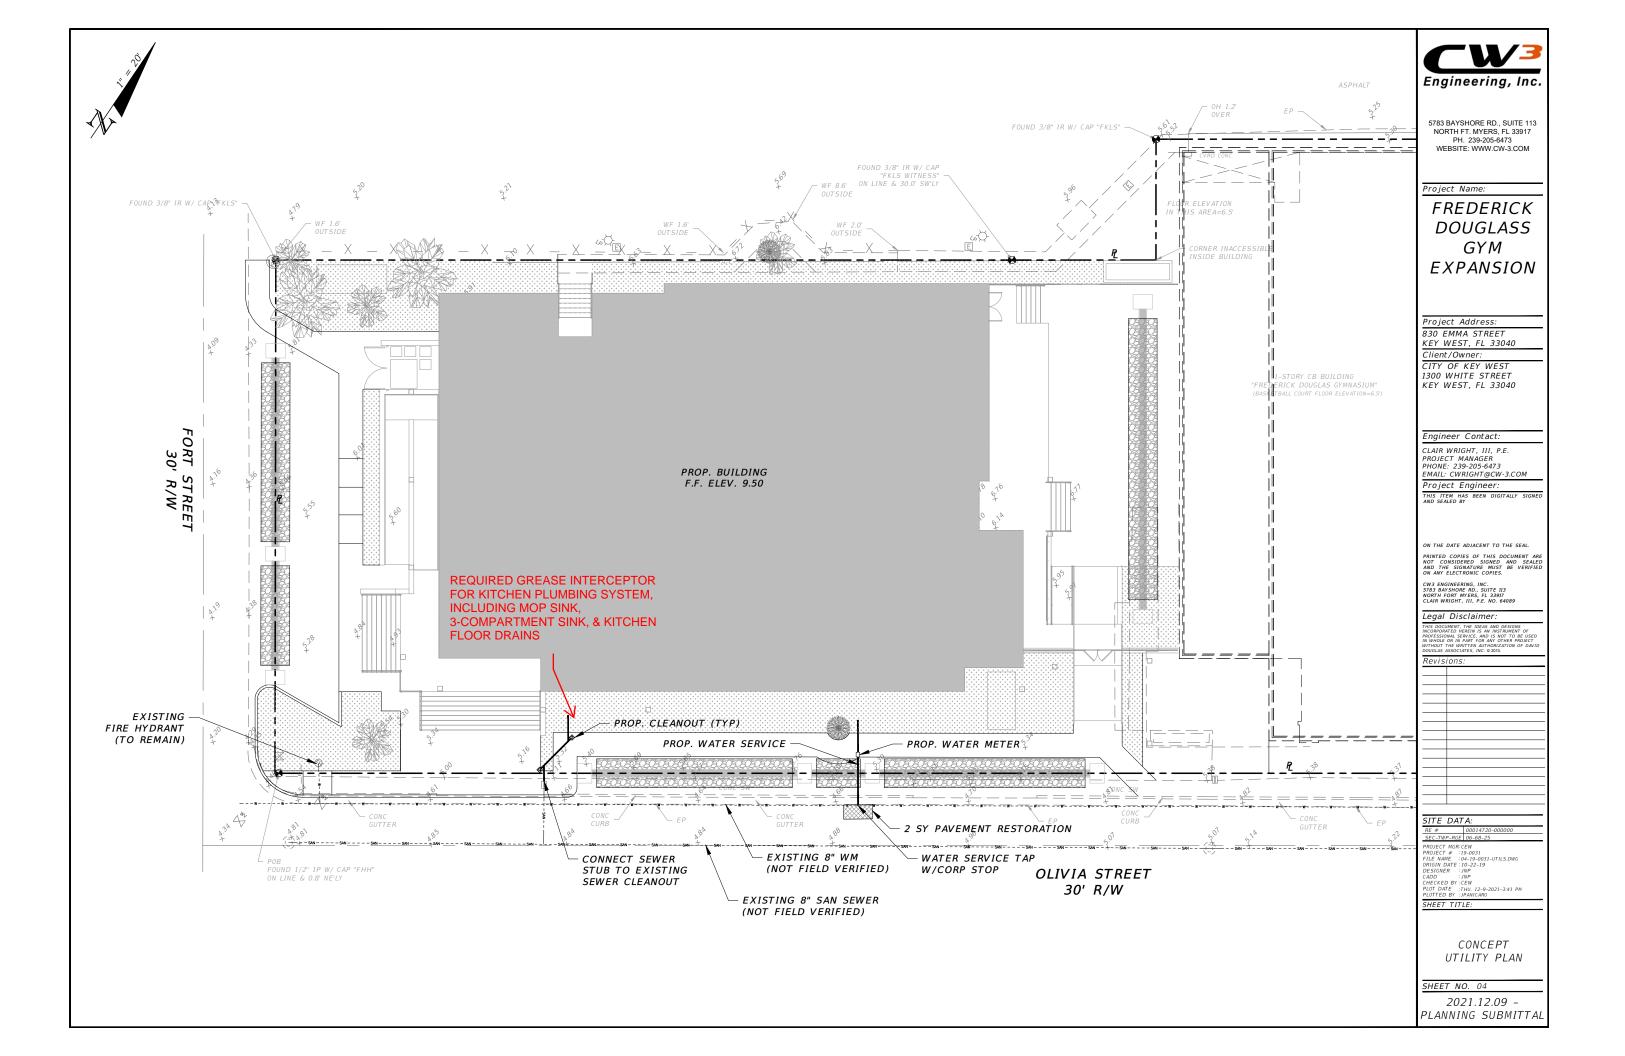

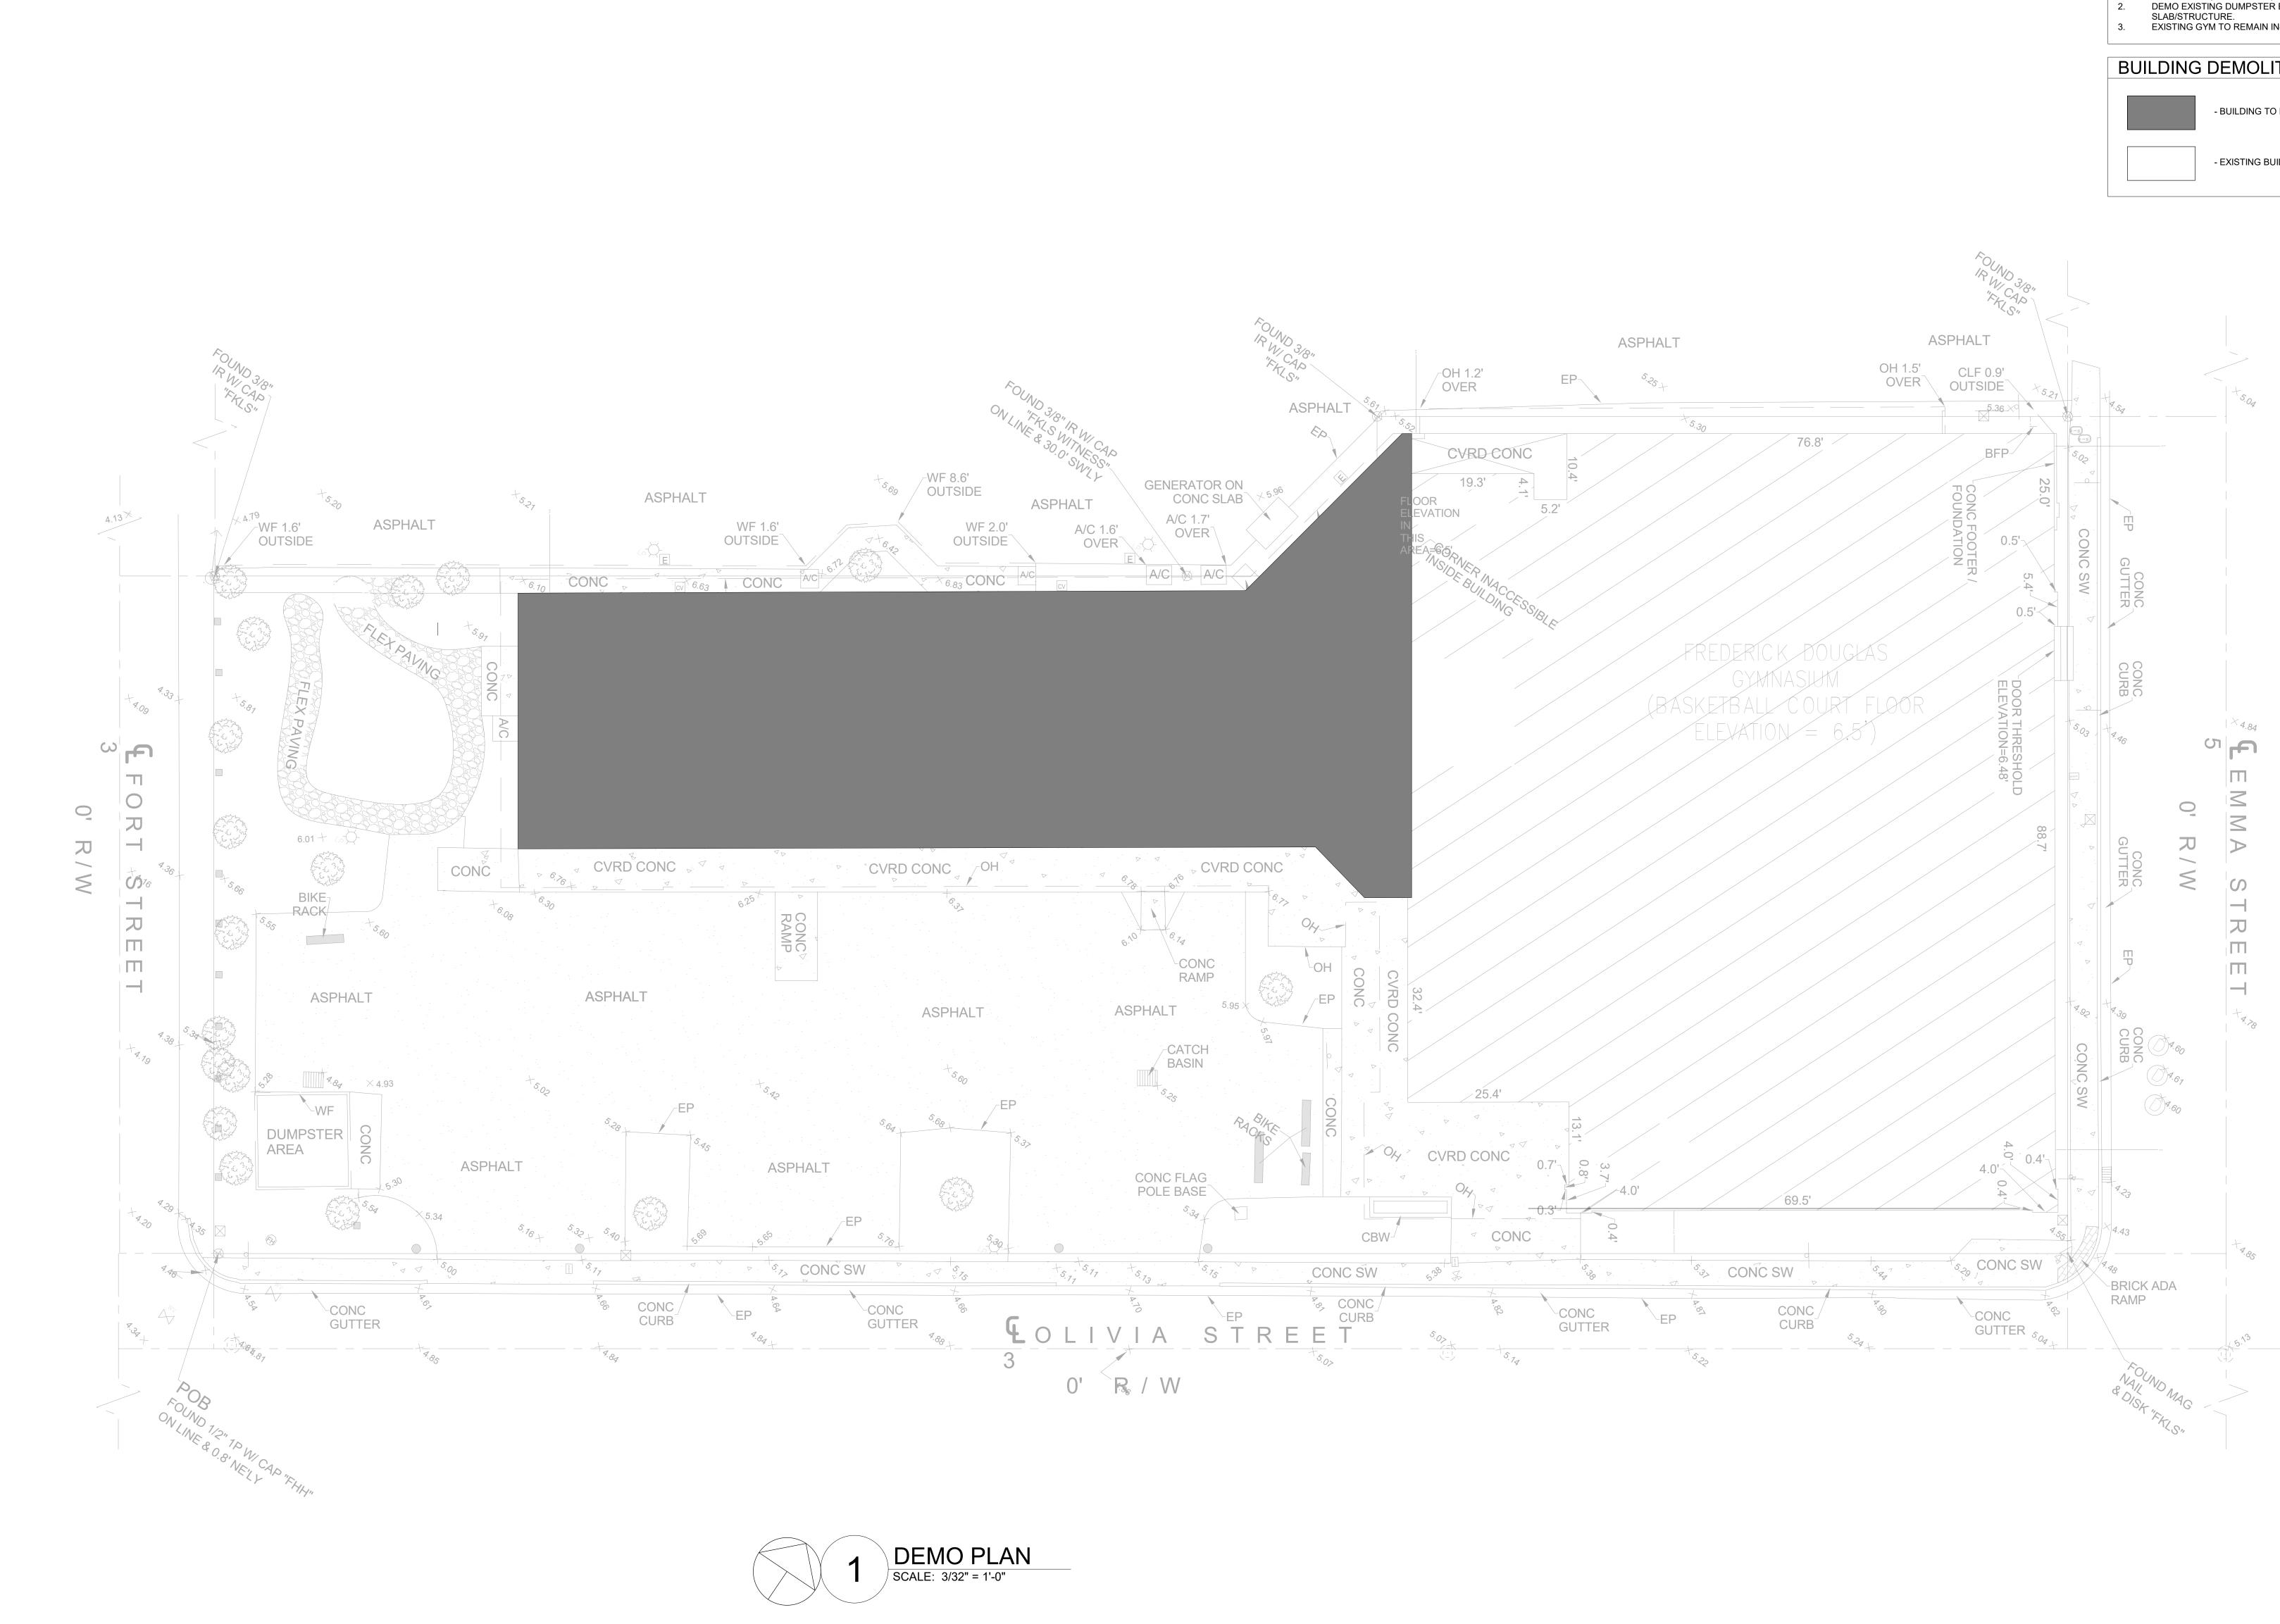

SITE DEMOLITION NOTES:

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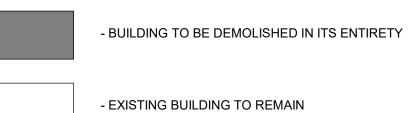
6.

- DEMO ALL EXISTING PAVEMENT AT PARKING LOT AND PATHWA EXISTING MUSIC PROGRAM BUILDING.
- DEMO EXISTING FLEXIBLE PAVEMENT AT LEARNING GARDEN. DEMO ALL EXISTING CONCRETE PADS AND WALKWAYS AT BUI PROTECT SIDEWALK AND CONCRETE ENTRYWAY AT GRADE
- FREDERICK DOUGLASS GYM ENTRANCE AND SURROUND.
- DEMO EXISTING DUMPSTER ENCLOSURE AND ASSOCIATED SLAB/STRUCTURE. 5.
- DEMO EXISTING CURB CUT AT EXIT FROM GYM PARKING LOT. REFER TO L-SHEETS FOR LANDSCAPE REMOVAL/RELOCATION REQUIREMENTS FOR TREE PROTECTION/TRANSPLANTING.
- REFER TO A2.1.1 FOR DEMOLITION PLAN OF BUILDING.

BUILDING DEMOLITION NOTES:

- DEMOLITION OF EXISTING 6,114 SF MUSIC & TUTORING PROGRAM BUILDING ATTACHED TO FREDERICK DOUGLASS GYM AND ASSOCIATED
- MECHANICAL, ELECTRICAL, PLUMBING, AND STRUCTURE. DEMO EXISTING DUMPSTER ENCLOSURE AND ASSOCIATED
- EXISTING GYM TO REMAIN IN-TACT. NO STRUCTURAL OR UTILITY WORK.

BUILDING DEMOLITION LEGEND:




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ARCHITECT:

Architecture, Engineering, Interior Design, Asset Management, Specialty Consulting Key Largo, Florida Key West, Florida Marathon, Florida URL: www.k2mdesign.com PROF. REG. AA26001059 Building Relationships Based on Trust and Results Cleveland | Columbus | Indianapolis | Key Largo | Key West | Marathon | Charlotte | Baltimore | Bentonville LIC. NO. AR93161 COA: AA26001059 Consultants: ISSUED DRC 09/17/202 12/09/202 FREDERICK DOUGLASS GYM 111 OLIVIA STREET, KEY WEST, FL, 33040 WEST EL 3302 KEY ЧO CITY 300 WHITE PLOTTED: 12/22/2021 4:23:00 PM Drawing Size Project #: 30x42 19095 Drawn By: Checked By: LBB/EHP EG DEMOLITION SITE PLAN/FLOOR PLAN Sheet Number: AD1.1.1

Date: 08/04/2021 ©2021 by K2M Design, Inc.

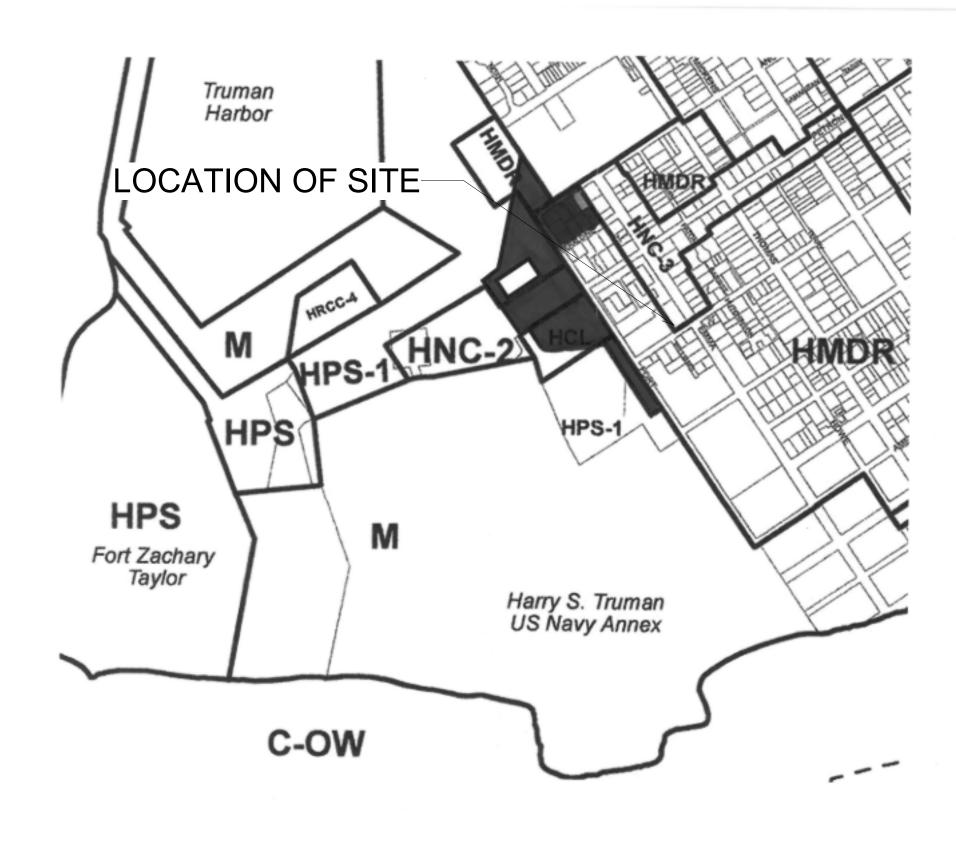

VICINITY MAP W/ LAND USE



SITE DATA TABLE							
	CODE REQUIREMENT	CODE REQUIRED SQ. FT.	EXISTING SITE	EXISTING SITE SQ. FT.	PROPOSED	PROPOSED SQ. FT.	VARIANCE REQUEST
Zoning	HNC-3						
Flood Zone	AE 7						
Size of Site	34,000 SF (Min. 4,000 SF)		34,000 SF				
Height	30'-0"		30'-0"		30'-0"		N/A
Front Setback	None		None		7'-9"		N/A
Side Setback	5'-0"		5'-0"		0'-0"		N/A
Side Setback	5'-0"		5'-0"		5'-0"		N/A
Street Side Setback	7'-6"		7'-6"		18'-0"		N/A
Rear Setback	15'-0"		0'-0"		5'-0"		YES
Residential Floor Area	N/A		N/A		N/A		N/A
Density	16 du/acre		0		N/A		N/A
F.A.R. (Commercial)	1		0		0		N/A
Building Coverage	40%	13,600 SF	62%	20,924 SF	71%	24,193 SF	YES
Impervious Surface	60%	20,400 SF	89%	30,361 SF	89%	30,361 SF	YES
Parking	27		19		10		N/A
	0		/		/		/
Handicap Parking**	3		2		2		N/A
Bicycle Parking	35%		8		21		N/A
	0		/		/		/
Open Space/Landscaping	20%	6,800 SF	11%	3,639 SF	11%	3,639 SF	YES
Number & Type of Units	N/A		N/A		N/A		N/A
Consumption Area or Number of Seats			N/A		N/A		N/A
**up to 25 - 1							
Zoning of Adjoining Sites	HNC-3 and HMDR***					+	


	Breakdowns	(SF)	
	Existing Develo	pments	
	Total Existing		
Lot Area		34,001.17	34,001.17
Existing Coverages			
Asphalt/Concrete	Parking Side	8,703	
	Side AC/Conc	39	
	Flex Pavers	525	
	Sidewalks on Back	22	
	Sidewalks on Front/Side	148	
Buildings	Buildings	20,644	500
	Dumpster	280	See Duilding (Lot
			Building/Lot
			Coverages
			Below
Impervious Surface		30,361	30,361
Impervious Surface %		89%	89%
Building Coverage		20,924	20,924
Building Coverage %		62%	62%
Open Space		3,640.00	3,640.00
Open Space %		11%	11%
	Proposed Develo	opments	
Lot Area		34,001.17	
Coverages			
Asphalt/Parking		1,340	
Buildings		24,193	
Pavement		4,715	
Impervious Surface		30,248	
Impervious Surface %		89%	
Building Coverage		24,193	
Building Coverage %		71%	
Open Space		3,753	
Open Space %		11%	


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 ISSUED SD SET
 08/26/2021

 ISSUED DRC
 09/17/2021

 ISSUED PLANNING
 12/09/2021


 SET
 12/09/2021
 FREDERICK DOUGLASS GYM 111 OLIVIA STREET, KEY WEST, FL, 33040 KEY WEST, FL, 3304 **OF** STRF^L CITY 300 WHITE PLOTTED: 12/22/2021 4:22:41 PM Drawing Size
30x42Project #:
19095Drawn By:
LBB/EHPChecked By:
EG Title: SITE DATA TABLES Sheet Number: A1.1.0 Date: 08/04/2021 ©2021 by K2M Design, Inc.

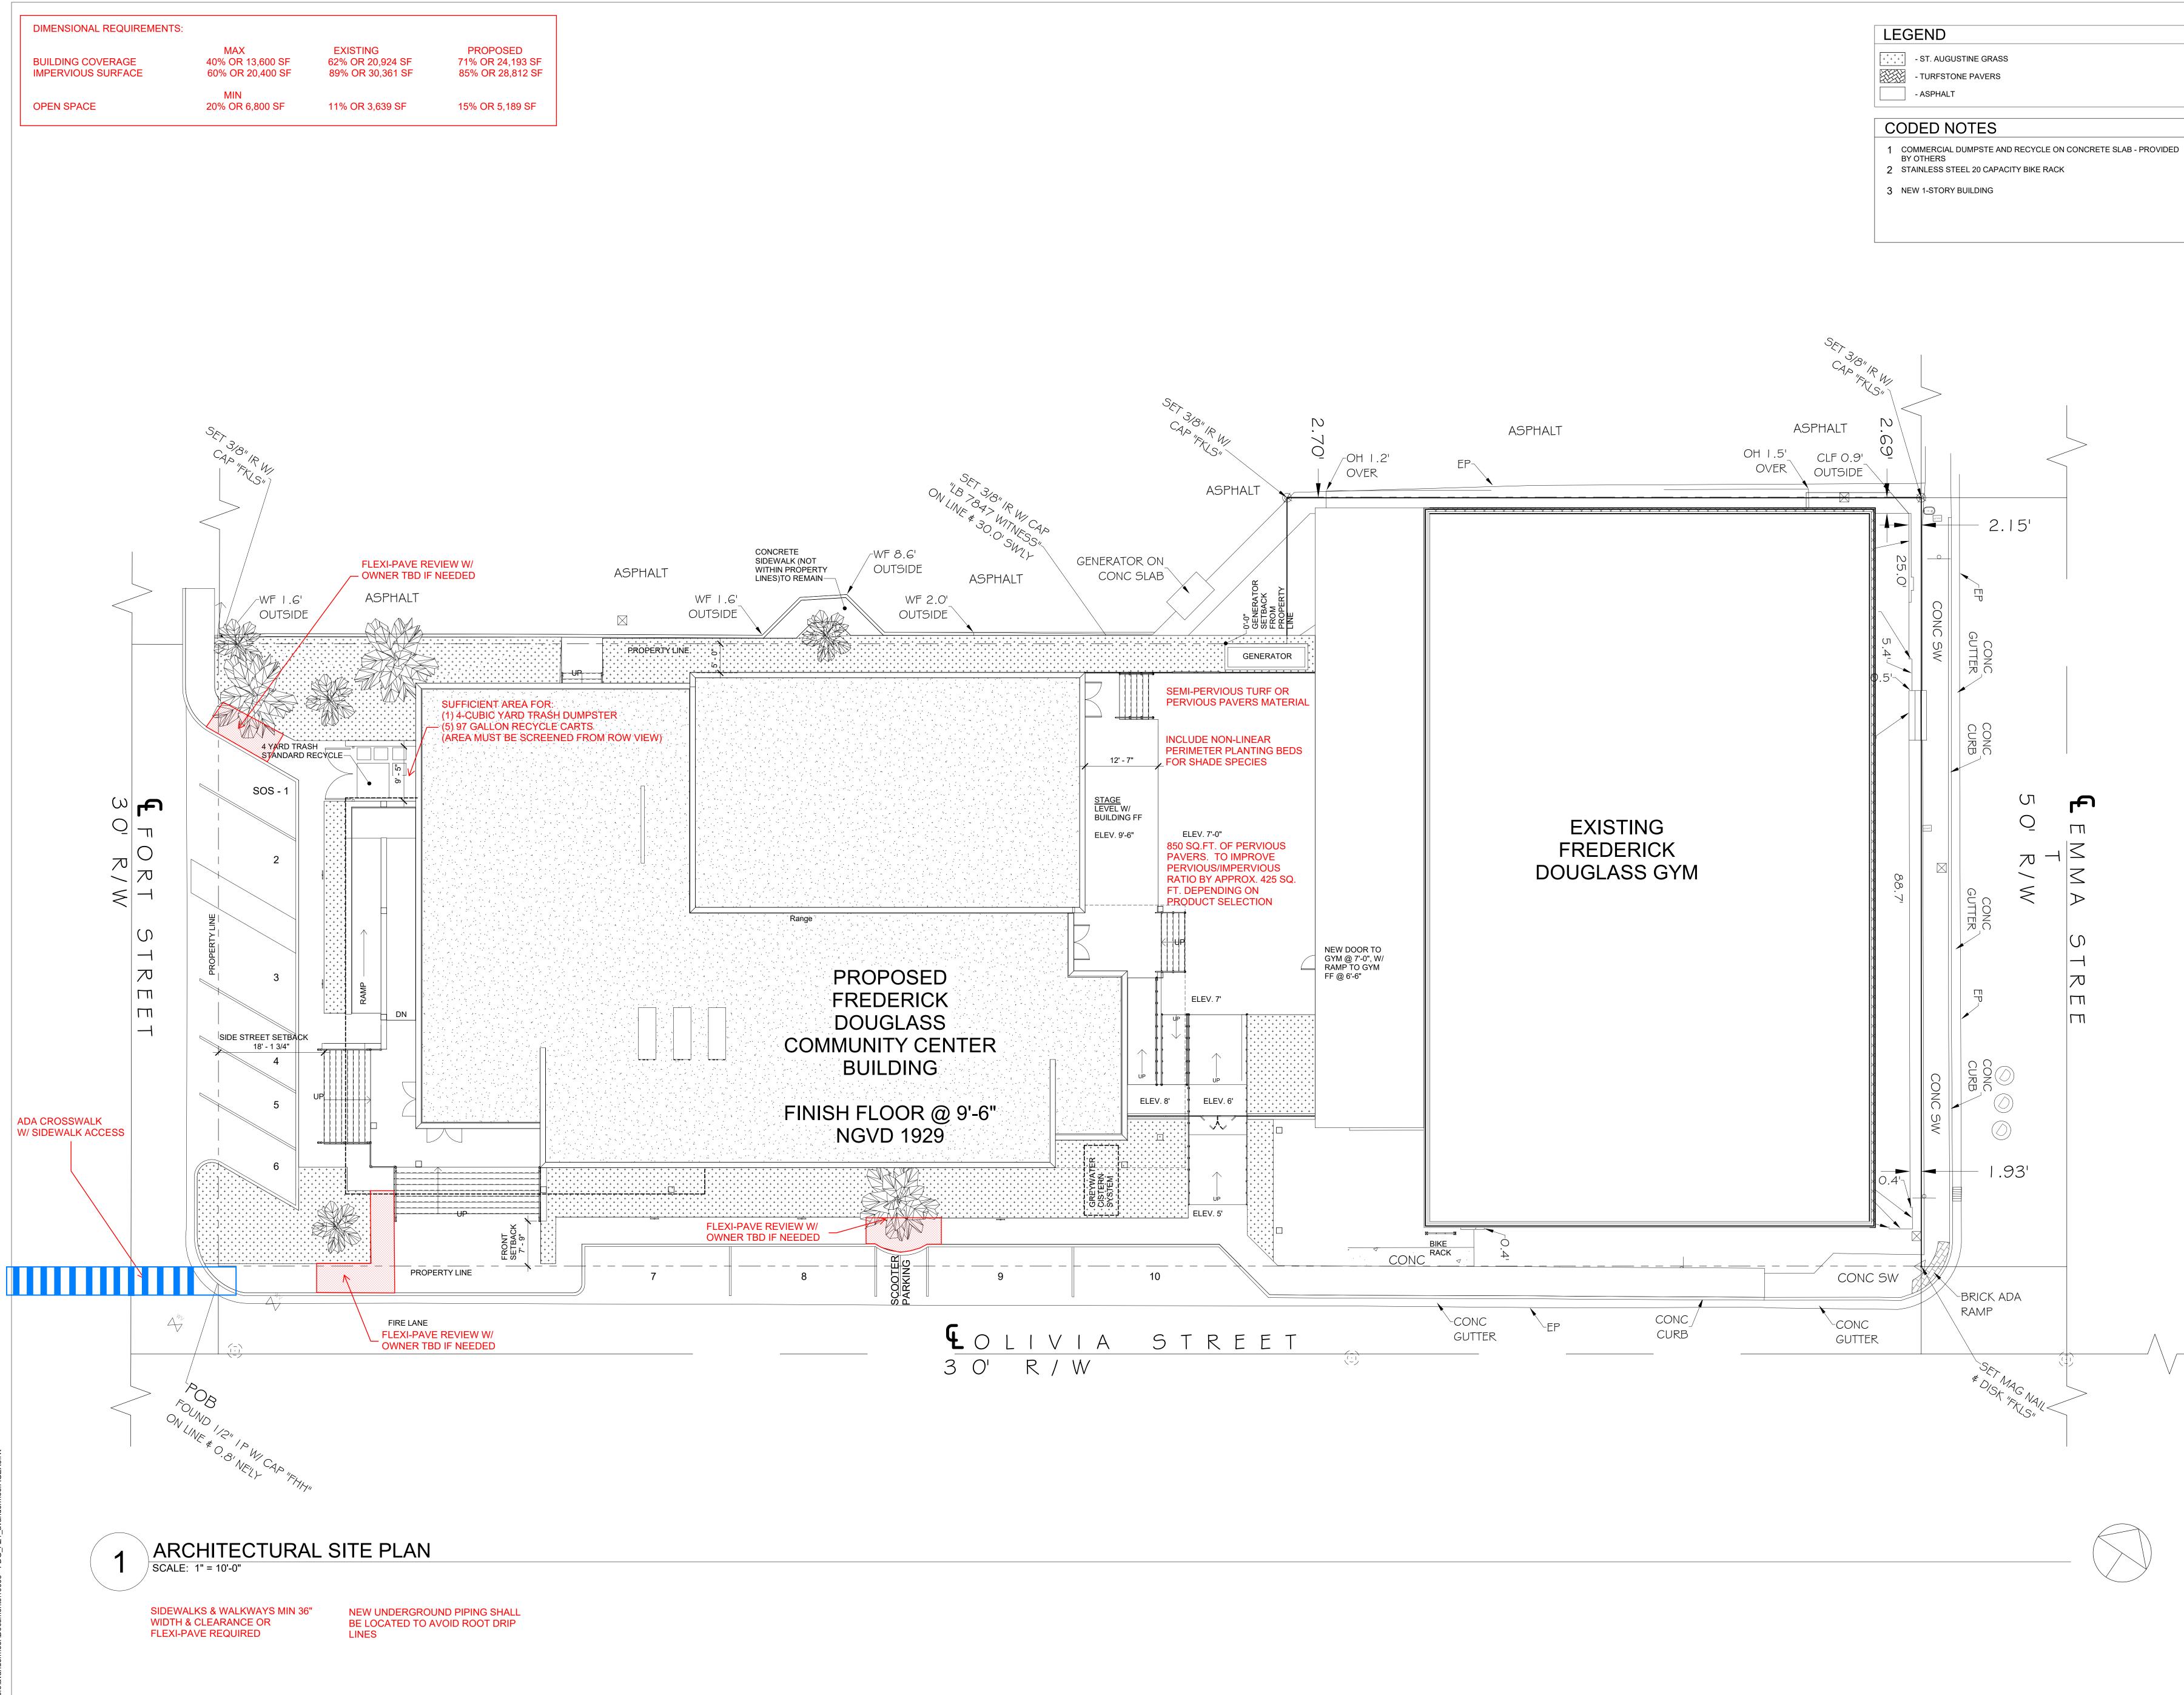


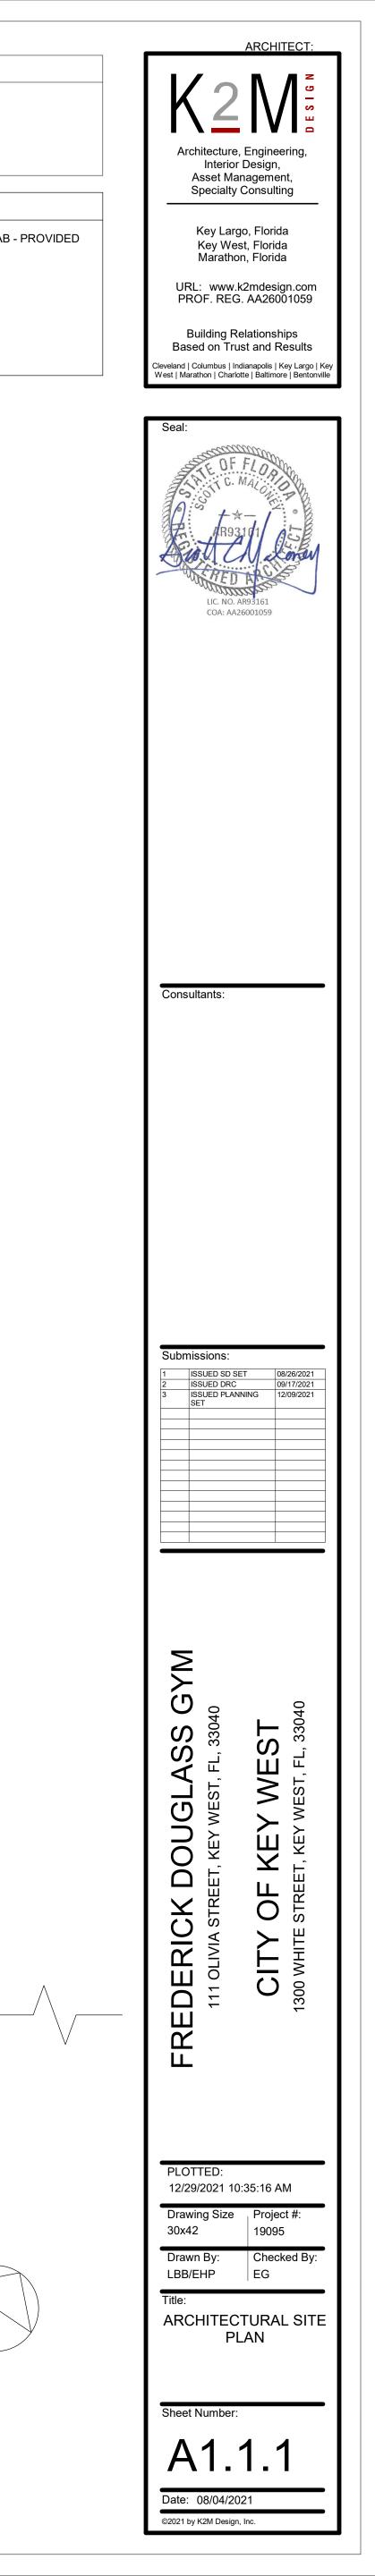






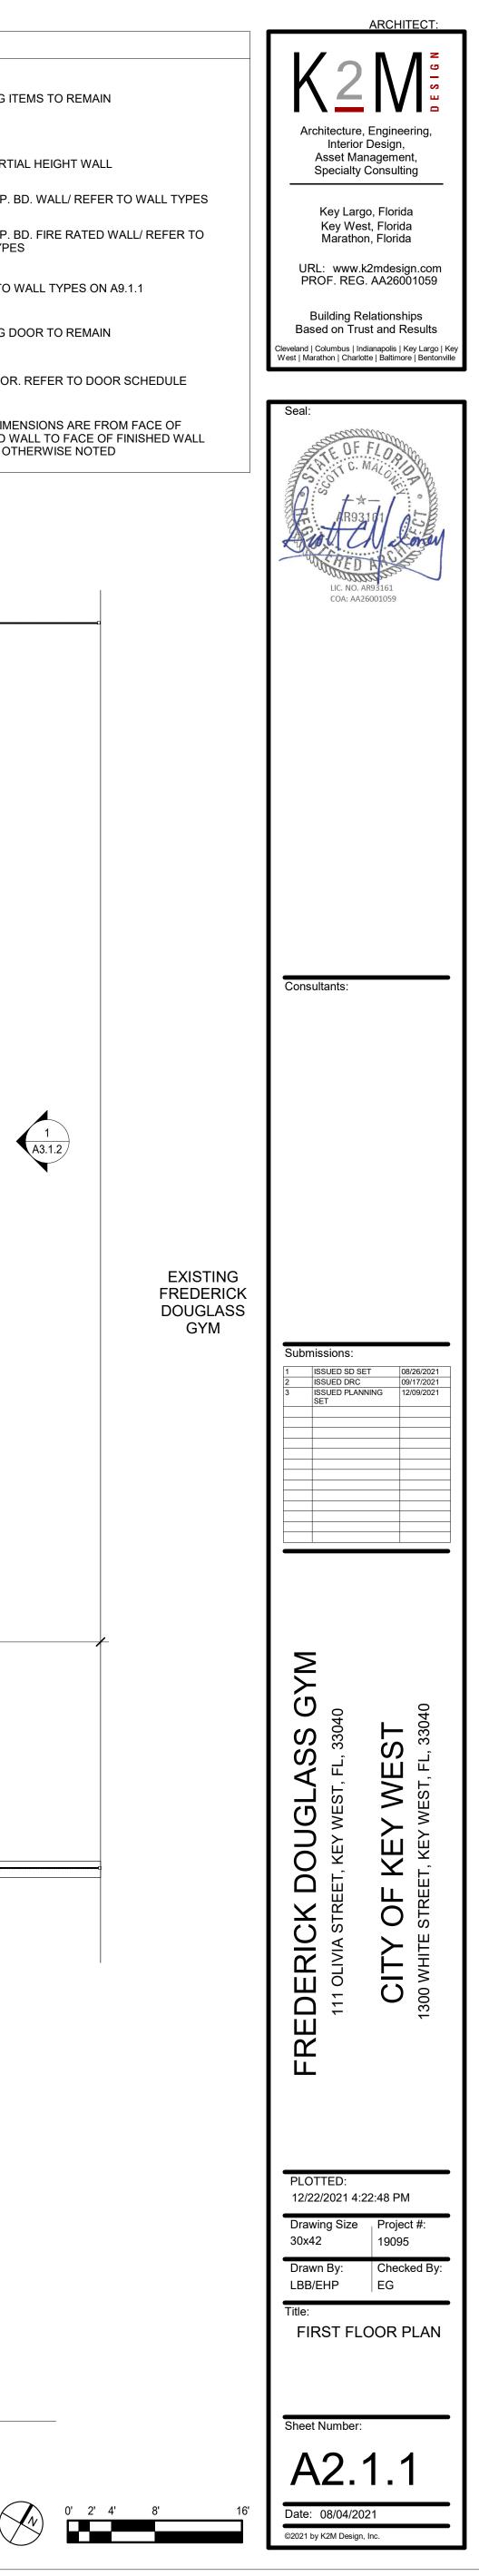

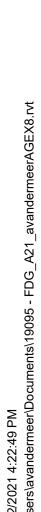


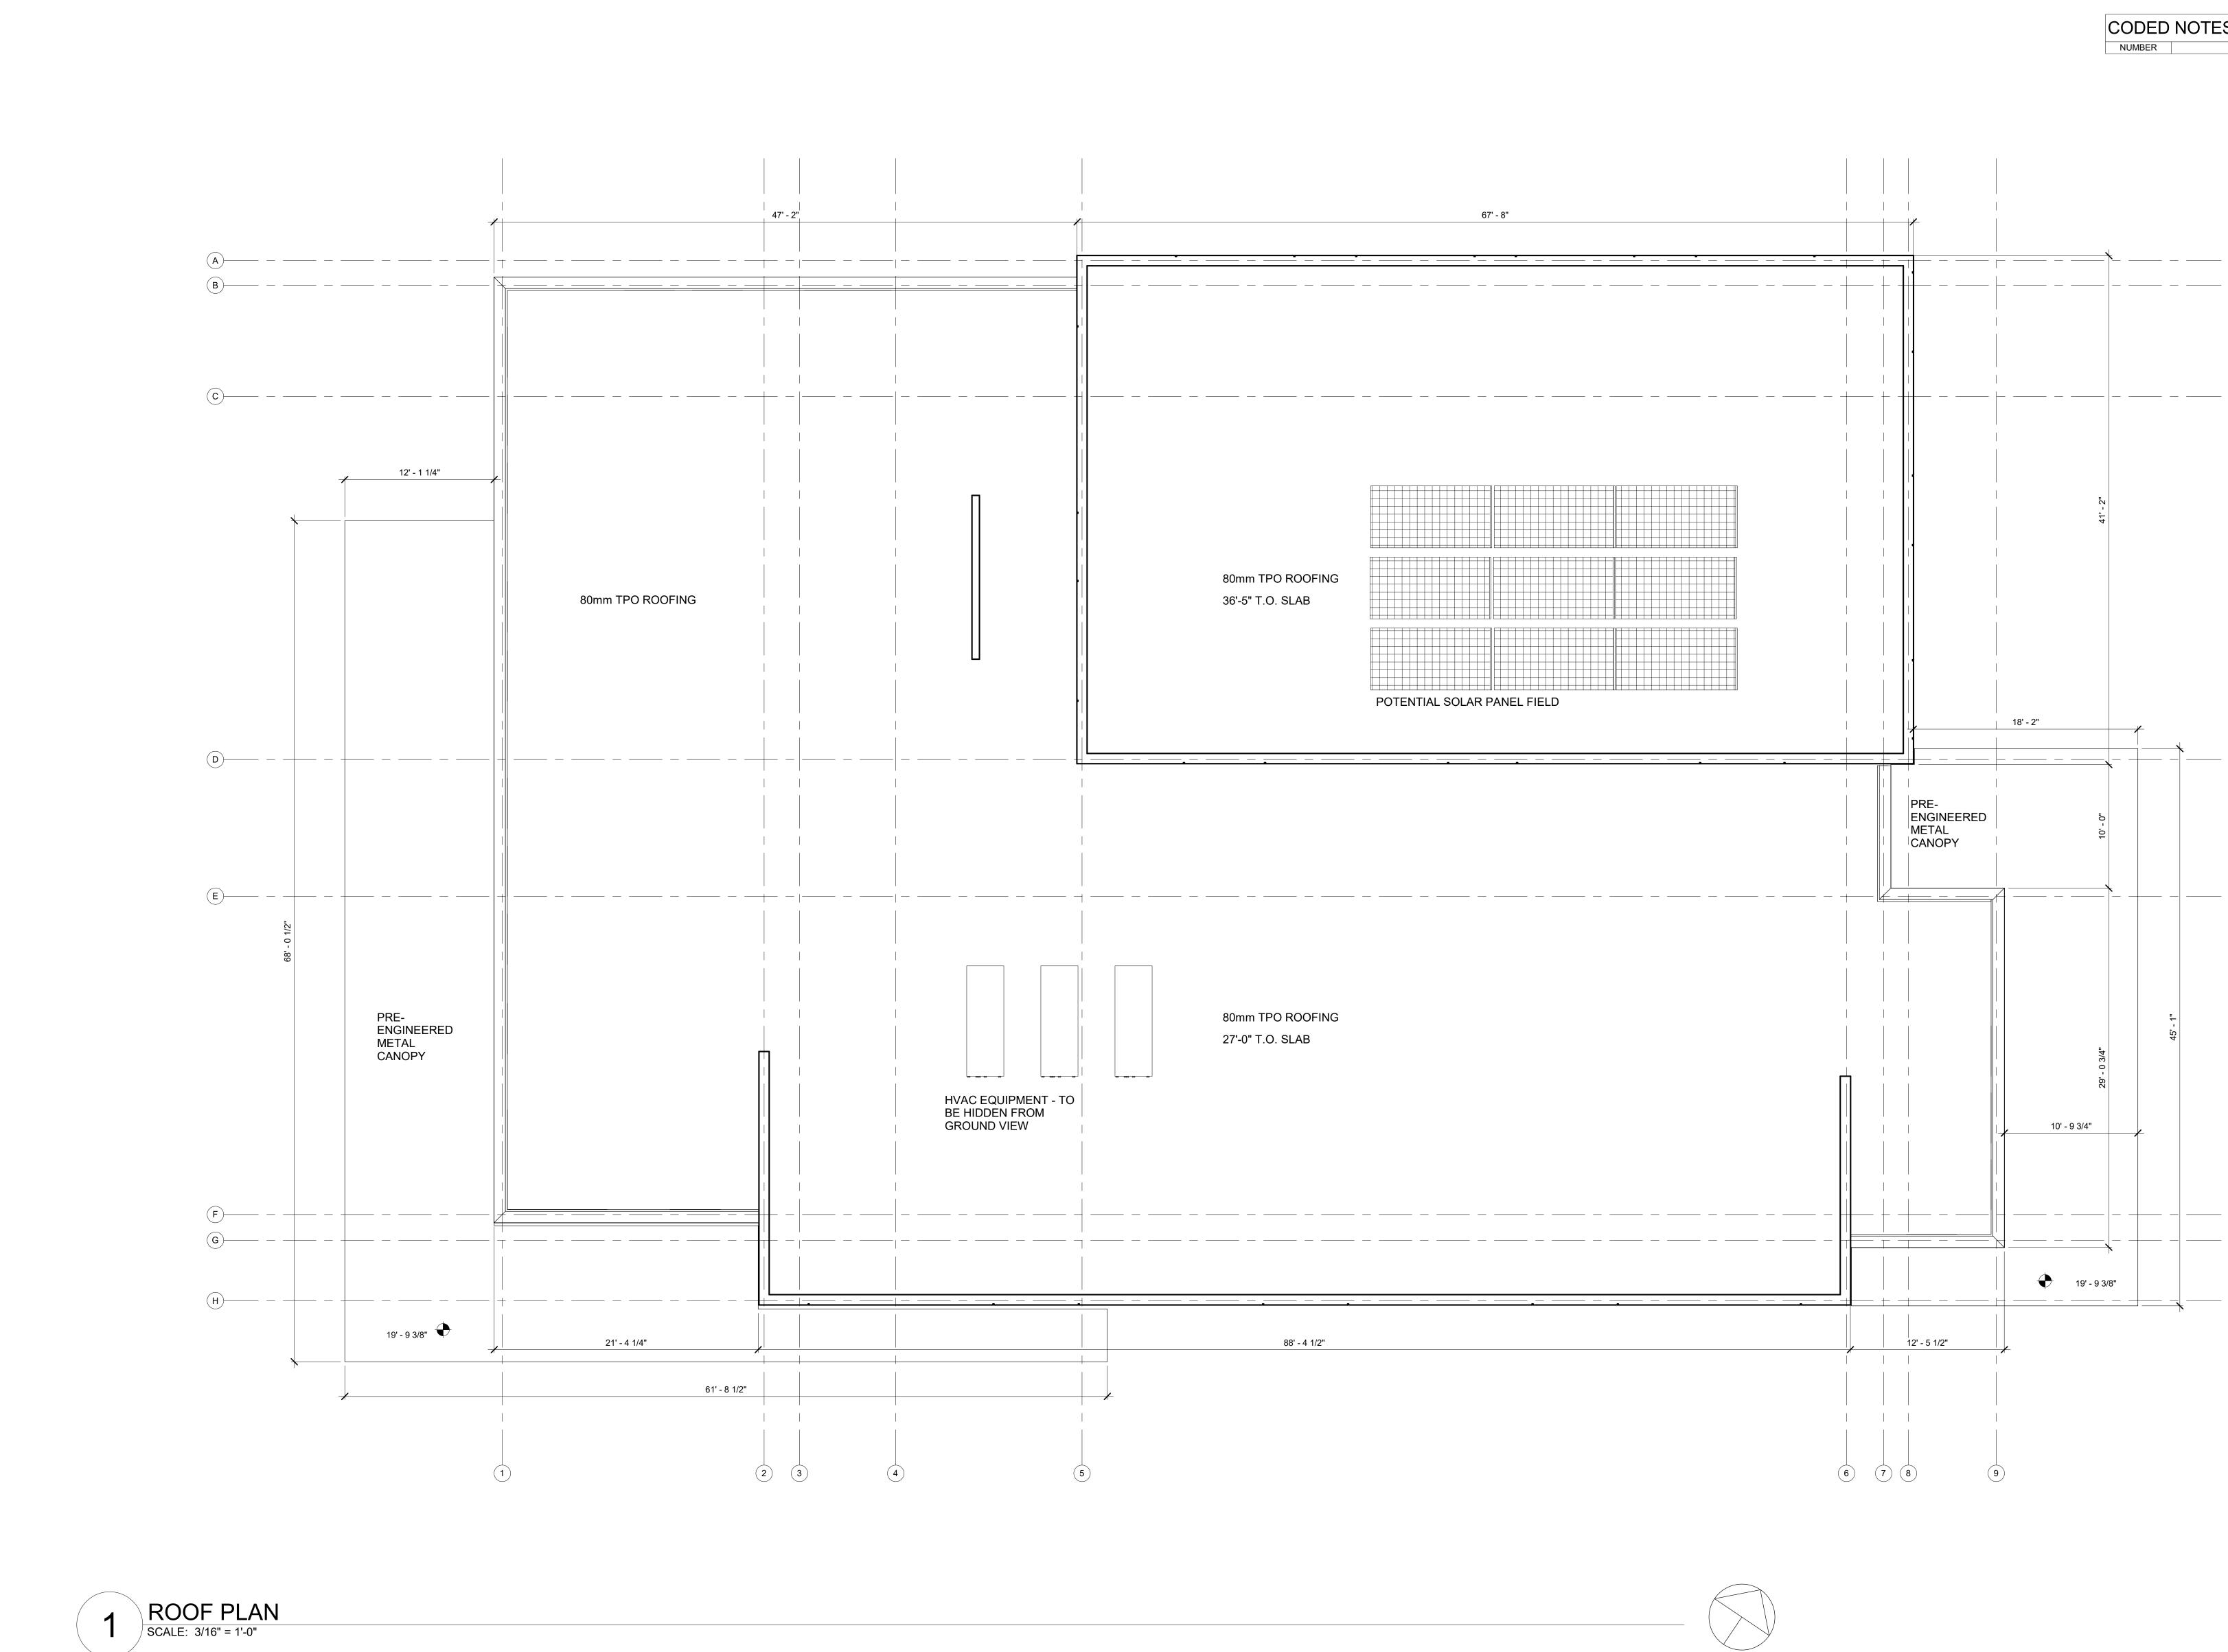


GENERAL ROOFING NOTES:


SAMPLE NOTE SAMPLE NOTE 2.

CODED NOTES ROOF PLAN NOTE

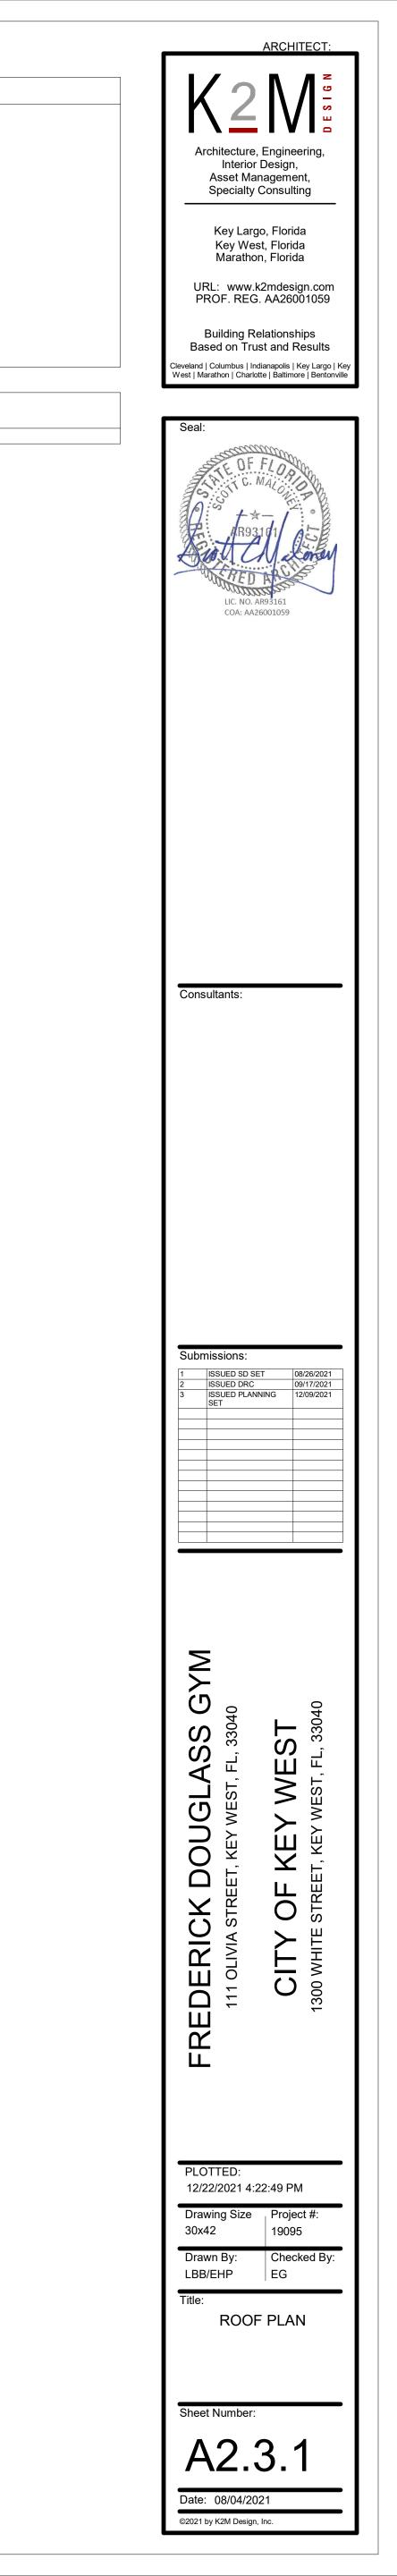



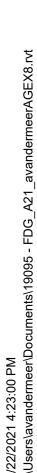

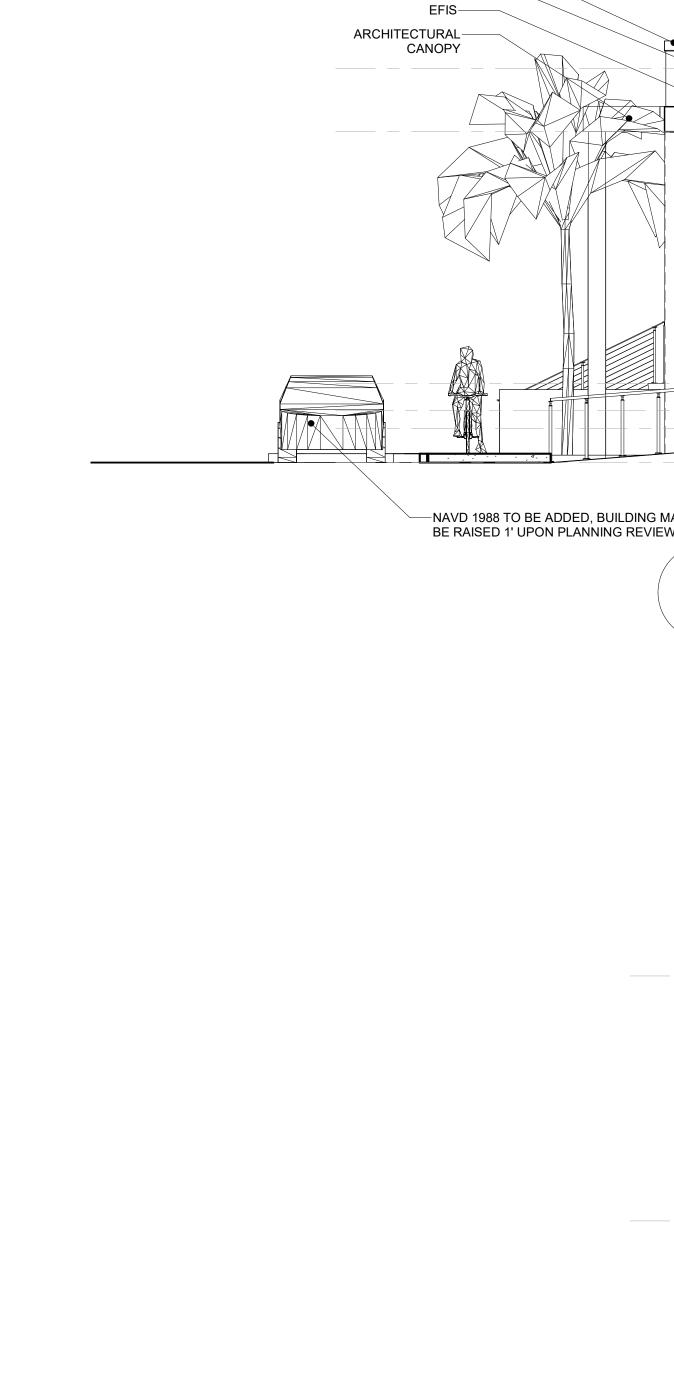



METAL COPING-







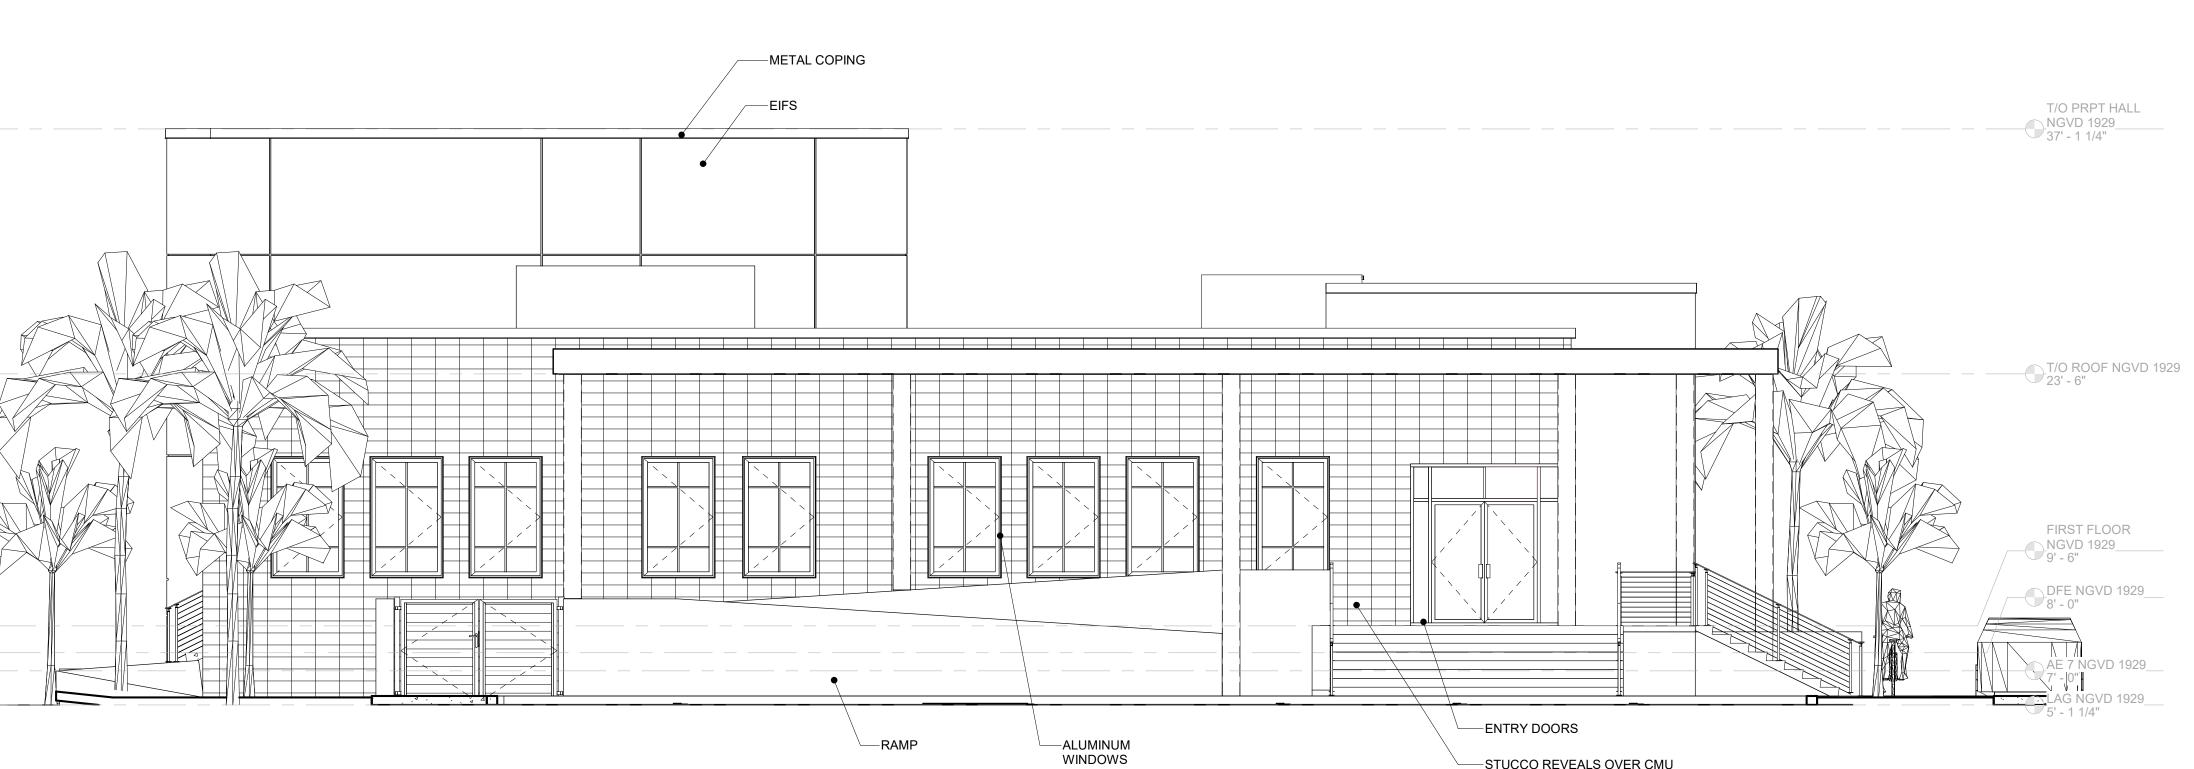

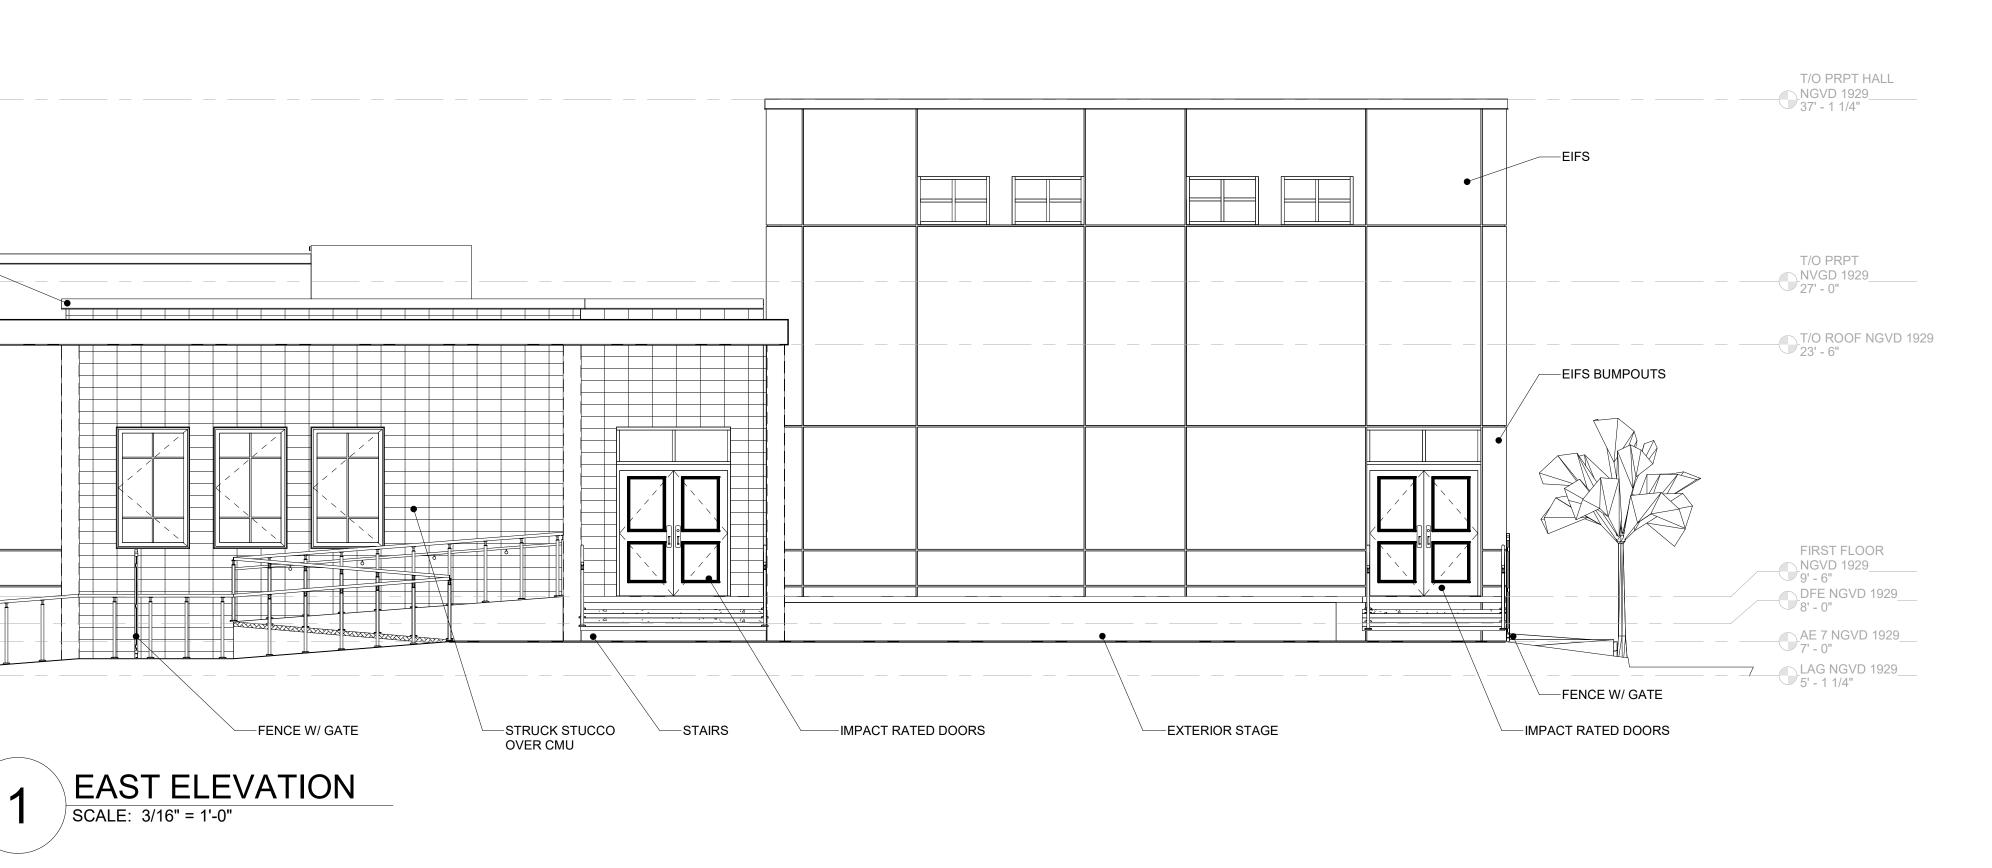


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 09/17/2021


 3
 ISSUED PLANNING
 12/09/2021

 SET
 12/09/2021
 12/09/2021
 GYM WEST, FL. 3304 FREDERICK DOUGLASS 111 OLIVIA STREET, KEY WEST, FL, 330 KEY W ОF CITY 300 WHITE PLOTTED: 12/22/2021 4:23:00 PM Drawing Size Project #: 30x42 19095 Drawn By: Checked By: LBB/EHP EG Title: EXTERIOR ELEVATIONS Sheet Number: A3.1.2 Date: 08/04/2021 ©2021 by K2M Design, Inc.

PLAN #	BOTANICAL NAME	COMMON NAME	SIZE	CONDITION	RATING	DISPOSITION	PROPOSED REPLACEMENT (AS REQUIRED)	REGULATED
1	TABEBUIA BAHAMENSIS	BAHAMA TABEBUIA		GOOD	3	RELOCATE	RELOCATED OFFSITE	YES
1A	CLUSIA MAJOR	PITCH APPLE		GOOD	3	RELOCATE	RELOCATED OFFSITE	YES
2	LYSILOMA LATISILIQUUM	WILD TAMARINO	15.2"	GOOD	3	REMAIN	N/A	YES
3	CANELLA WINTERANA	WILD CINNAMON	6.3"	POOR	3	REMOVE	N/A	YES
4	BURSERA SIMARUBA	GUMBO LIMBO	21.3"	GOOD	3	REMAIN	N/A	YES
5	THRINAX RADIATA	THATCH PALM		GOOD	3	RELOCATE	RELOCATED OFF SITE	YES
6	BUCIDA BUCERAS	BLACK OLIVE	3" & 4"	FAIR	3	REMOVE	N/A	NO
7	MYRCIANTHES FRAGRANS	SIMPSON STOPPER	4"	DEAD	3	REMOVE	DEAD	NO
8	EUGENIA SP	REDBERRY STOPPER		FAIR	3	RELOCATE	RELOCATED OFFSITE	YES
9	SABAL PALMETTO	CABBAGE PALM PUP		GOOD	3	RELOCATE	RELOCATED OFFSITE	YES
10	THRINAX RADIATA	THATCH PALM	10"	GOOD	3	RELOCATE	RELOCATED OFFSITE	YES
11	BURSERA SIMARUBA	GUMBO LIMBO	9.2"	FAIR	3	REMOVE	REMOVE	YES
12A	THRINAX RADIATA	THATCH PALM		GOOD	3	RELOCATE	RELOCATED OFF SITE	YES
12B	SABAL PALMETTO	SABAL PALM		GOOD	3	RELOCATE	RELOCATED OFF SITE	YES
13	THRINAX RADIATA	THATCH PALM		GOOD	3	RELOCATE	RELOCATED OFF SITE	YES
14	DELONIX REGIA	ROYAL POINCIANA		GOOD	3	REMAIN	N/A	YES
15	THRINAX RADIATA	THATCH PALM		GOOD	3	REMAIN	N/A	YES
16	DELONIX REGIA	ROYAL POINCIANA	15"	GOOD	3	REMAIN	N/A	YES
17	BURSERA SIMARUBA	GUMBO LIMBO		GOOD	3	REMAIN	N/A	YES
18	THRINAX RADIATA	THATCH PALM		GOOD	3	REMAIN	N/A	YES
19	PONGAM	PONGAMIA PINNATA	17"	GOOD	3	REMAIN	N/A	YES
20A	ADONIDIA MERRILLI	CHRISTMAS PALM		GOOD	1	RELOCATE	RELOCATED OFFSITE	NO
20A	ADONIDIA MERRILLI	CHRISTMAS PALM		GOOD	1	RELOCATE	RELOCATED OFFSITE	NO
21	LIGNUM VITAE	GUAYACAN		POOR	1	RELOCATE	RELOCATED OFFSITE	YES
22	CITHAREXYLUM SPINOSUM	FIDDLEWOOD		GOOD	3	RELOCATE	RELOCATED OFFSITE	YES
23	PITHECELLOBIUM KEYENSE	BLACKBEAD		GOOD	3	RELOCATE	RELOCATED OFFSITE	YES
24	CANELLA WINTERANA	WILD CINNAMON		FAIR	2	RELOCATE	RELOCATED OFFSITE	YES

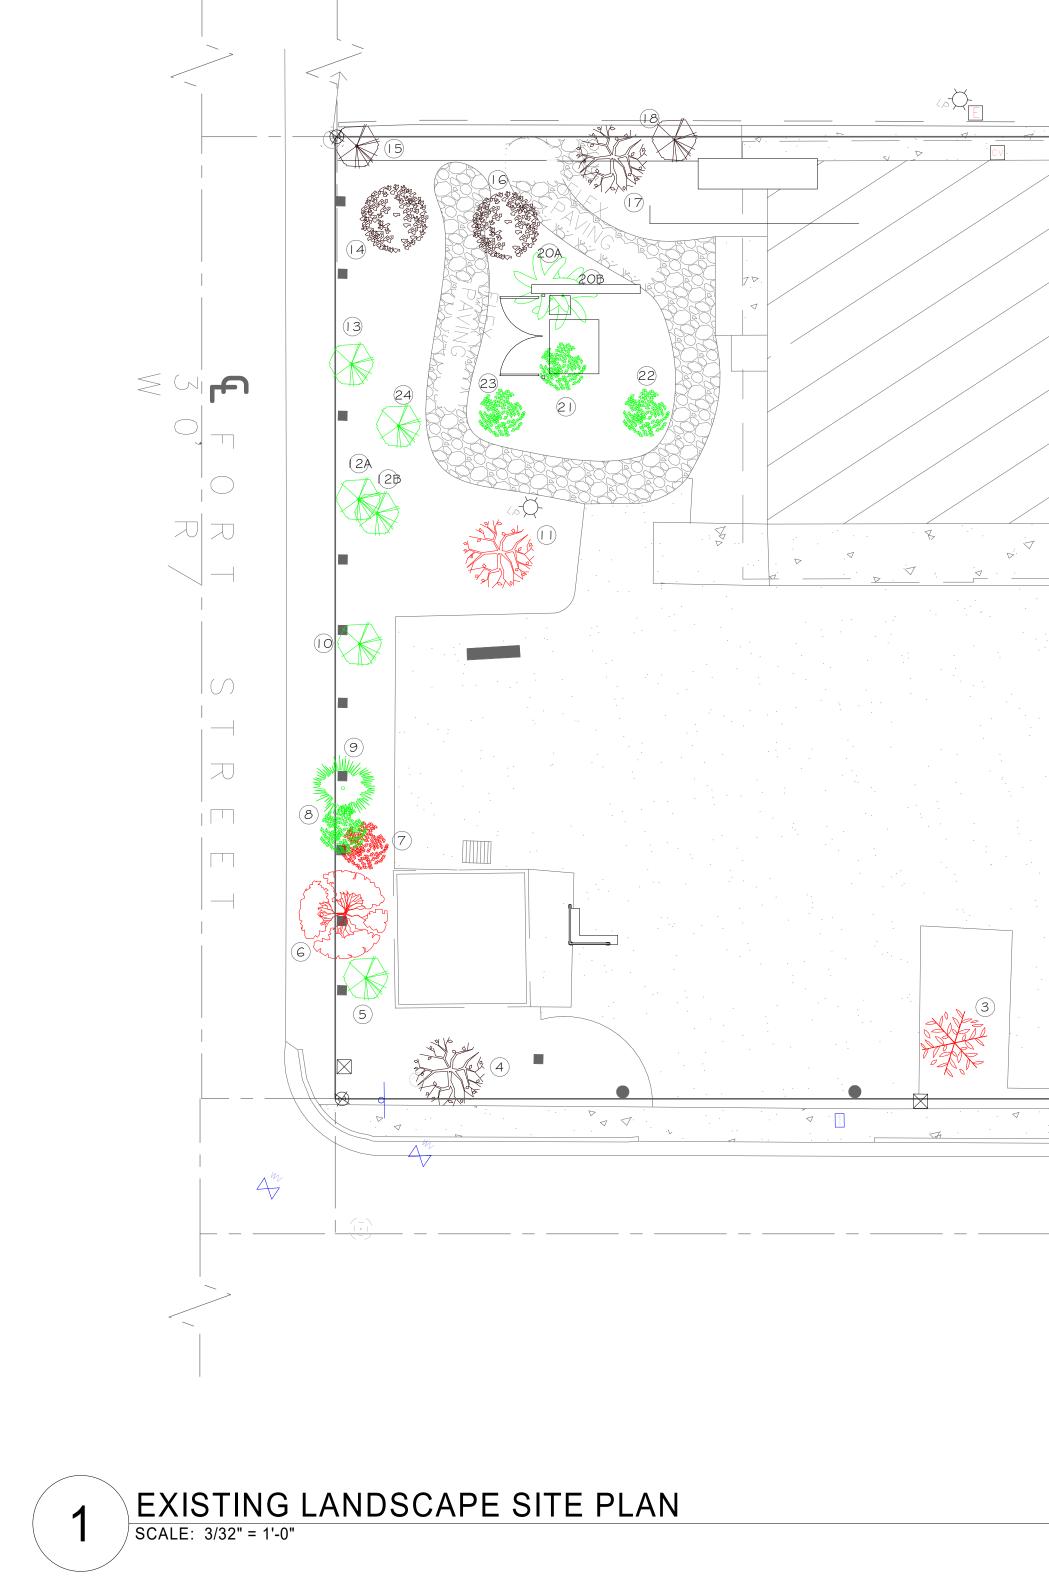

1 - Bahama Tabeubia (messy) 1A - Pitch Apple (gets too large and messy) 9 - Sabal Palmetto (out of character for design) 20A & B - Christmas Palm (messy seeds) 21 - Lignum - Vitae (quality of plant is poor)
22 - Fiddlewood (out of character for design)
23 - Blackbeed (out of character for design)

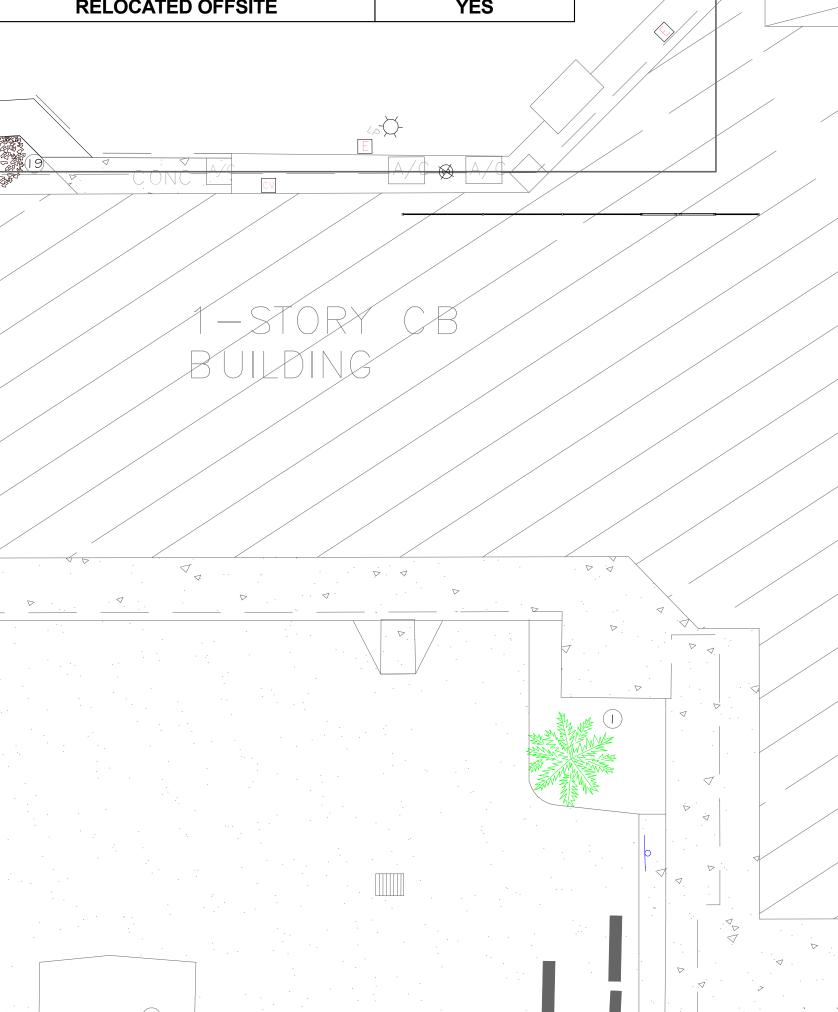

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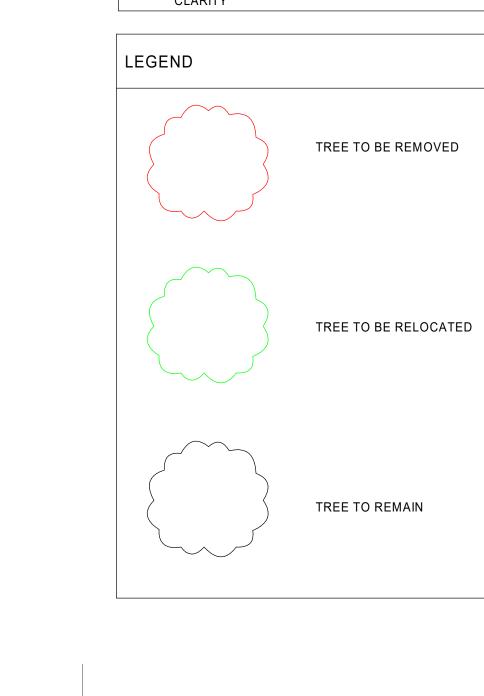
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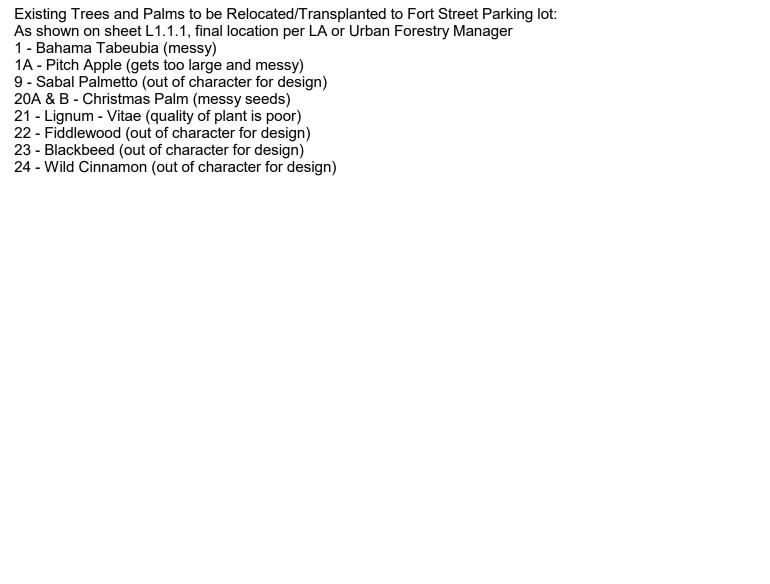
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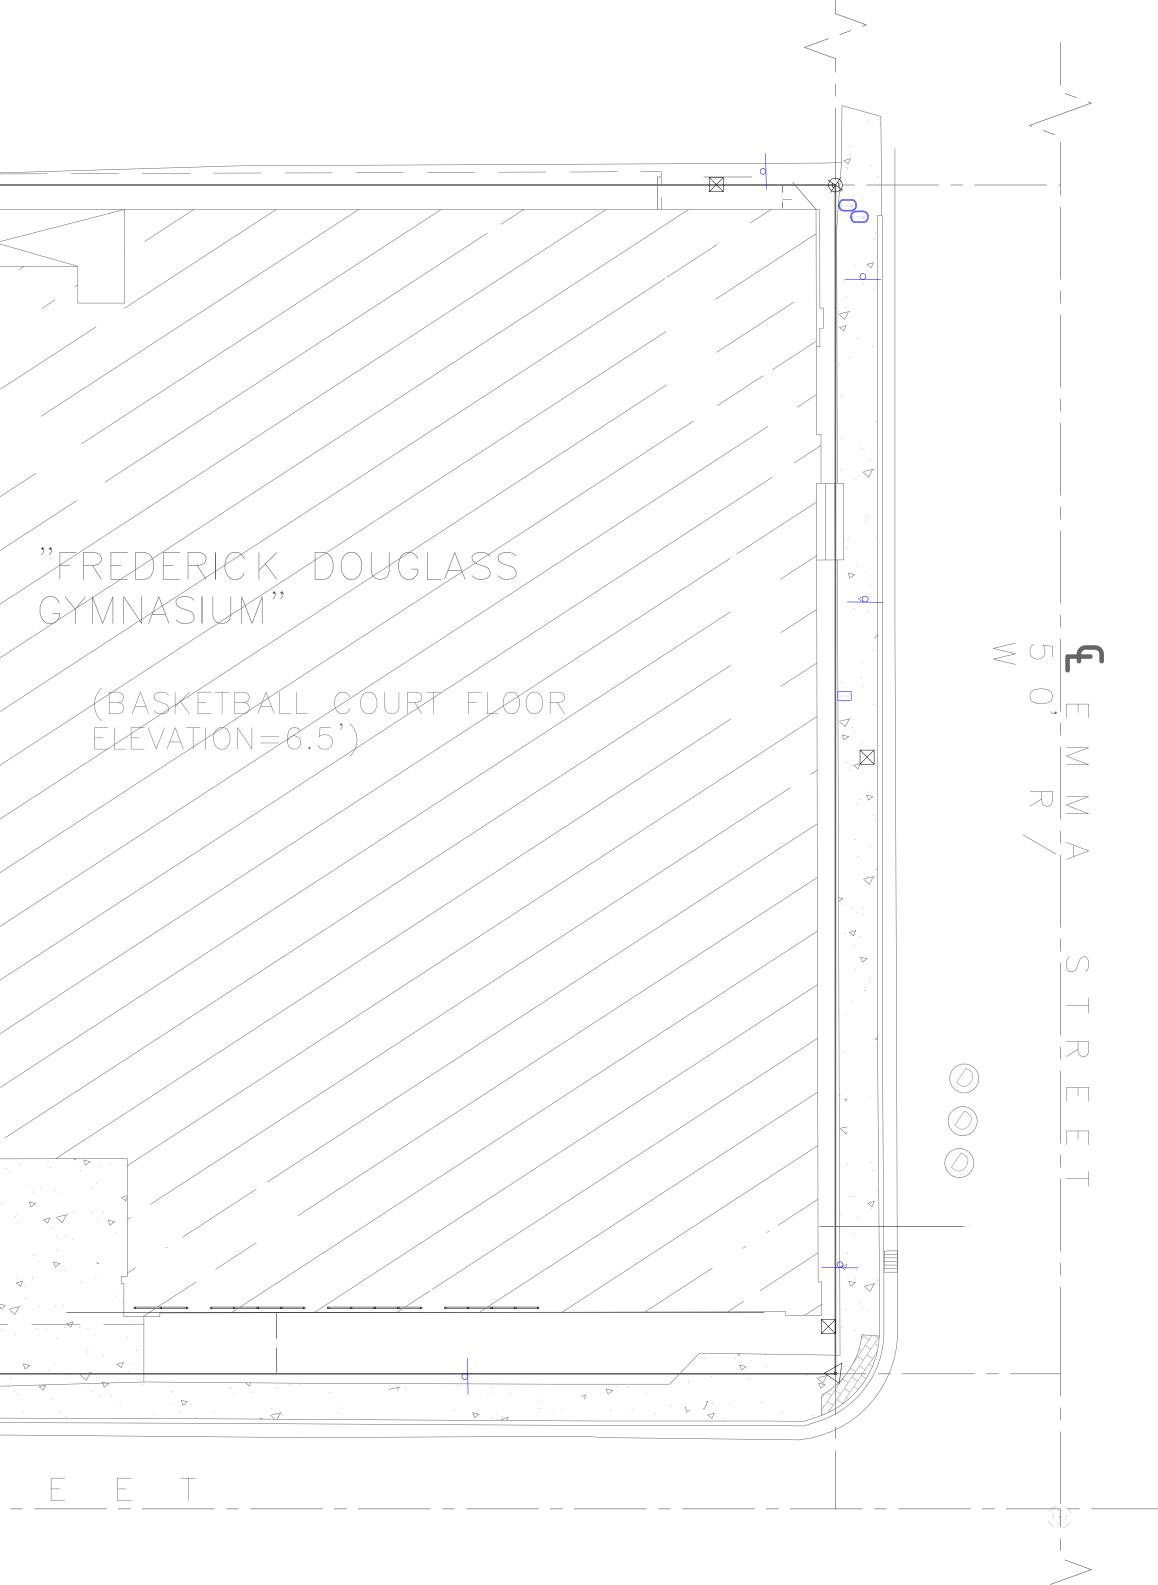
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GENERAL NOTES

- ALL PALMS TO BE 4' TLL MINIMUM PER CODE
- TREES TO BE RELOCATED TO BE REMOVED WITH SPUD AND MAINTAINED /WATERED DURING CONSTRUCTION
- COORDINATE TREE RELOCATIONS WITH SHEET L1.1.2 LANDSCAPE PLANS TO BE PRINTED IN COLOR TO INSURE CLARITY







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Required Landscape Calculations for Frederick Douglas Gym, City of Key West. 111 Olivia Street, Key West, Florida: Subject property zonings (HNC-3) (Sept. 21, 2021) rev. Jan. 7, 2021

Subject projectly Zohing- Grite 3 Cocyt is a factor and a second second

Protect existing tree and other vegetation indicated to remain in place against: unaccessary cutting, breaking or skinning of notes, skinning and bruking of bark, within dro line, excess foot or vehicular traffic or parking of vehicles within drip line. No activity of any cost is to take place in an area forced off as a protected area. Water, fartilize, wash off and spray trees and other vegetation to remain within line is of contract work as required to maintain their health during the corres of the Landscape Installation. Repair or replace trees and vegetation to remain within line rate damaged by landscape operations with a tree based on its community status only upon approval of the Landscape Architect. Landscape Contractor may be required to employ a licensed Arboriet approved by the Landscape Architect to repair damage to trees.

Relocating Trees: If at all possible root pruning should commence at the earliest date possible. The crown may be reduced by 1/3 or as directed by the Landscape Architect. As large a rootball as is practical shall be taken and at all limes the entire root pruned area shall be taken. The tree is to be pried off of Caprock if possible but in some cases Caprock will have to be taken with the rootball. The tree is to be immediately placed into its new location. Deeply water the tree daily for two months and every other day for another 2 months at the root system. It is recommended and may be required by the Landscape Architect to supply a mist head in the crown of the tree or to treat the tree with "vaporguard" or equal to insure successful relocation. Relocated trees are not guaranteed by the landscape contractor.

Relocating Palms: Transplantation will be similar to that for trees except trim all but 3-4 fronds off of the paim, all fruit and Rowers and in some cases the fronds will have to tied up. The paim shall be treated with "Lindare" and an approved fungicide The Landscape Architect also may require the paim to be bud poled. Relocated paims are not guaranteed by the landscape contractor.

Street Frontage: Required: ...5~(1 acre, 252 linear feet provided. 200 plant units required. Provided: 297 plant units provided

Existing Trees and Palms to relocated/Transplanted to Fort Street Parking

Existing Trees and Paims to relocated/Transplanted to Fort Street Parking lot: As shown on sheet L.1.1, final location per LA or Urban Forestry Manager 1 - Bahama Tabeubia (messy) 1A-Pitch Apple (gets to large and messy) 5 - Thatch Palm (phasing) 8 - Redberry stopper 9 - Sabal paimetho (out of character for design) 10 - Thatch Palm (phasing) 12A - Thatch Palm (phasing) 13 - Catistana Palm (messy seeds, Lethal yellow carrier) 21 - Lignum-Vitae (quality of plant is poor) 23 - Blackbeed (out of character for design) 23 - Blackbeed (out of character for design)

Provided: 4 existing Trees, 1-existing palms = 53 Landscape Units exist 156 new landscape units required. - 244 Units provided

6 - 12' tail min. Krugicraft forms and the second secon Total: 232 Units.

17 - 6' Thrinax morissii, Key Thatch Palm.=51units- These units exceed the red.

Perimeter Landscaping:. 76 l.f. provided Canopy Trees Required: 2.17 x 1 = 2 requit Provided: 2 existing or reloc 2.17 x 1 = 2 required 2 existing or relocated mature Trees 2- Guapira discolor, Biolly, 12' oa.

Shrubs Required: 2.17 x 10 = 22 Provided: 30 - 24⁴ native Shrubs will be planted, 1- 6¹ native Palm 35 Locustberry- Byrsonima lucida


Non Vehicular use areas:

Canopy Trees Required: Less than 30% and less than 2,000 s.f. NOS. = 4 trees Provided: 1 Existing tree and 3 - 12' tall min...Redberry Scopper

Screening: Locustberry- Byrsonima lucida 6' Capparis cynophallophora, 6' oa.


Required Landscape Plant List for Frederick Douglas Gym, City of Kay West. 111 Olivia Street, Kay West, Florida:

6 - Krugiodendron ferreum, Black Ironwood, 12-13' oa., 45 gallon.
20 - Thrinax moriselii. Key Thatch Palm., 6' oa., båb
6 - Eugenia rhombea, Redberry Stopper, 12-13' oa., 45 gallon
2- Guapria, Giscolor, Bolly, 12-13' oa., 45 gallon
3- Garparis, chronhaolhorat, Jamaican Caper, 6' pa, 45 gallon
55 - Locuetberry- Byrsonima lucida, 24-30', 7 gallon
2- Hymenocallis lattifolia 'keyensis', Key Lilly, 20-24', 3gallon
60-. Emodea linearis, Golden Creeper, 10-12", 1 gallon
32- Stachytarpheta jamaicensis, Native Blue Porterweed, 1g.
5-15-20", 3 g. (gallon) Sea Lavender

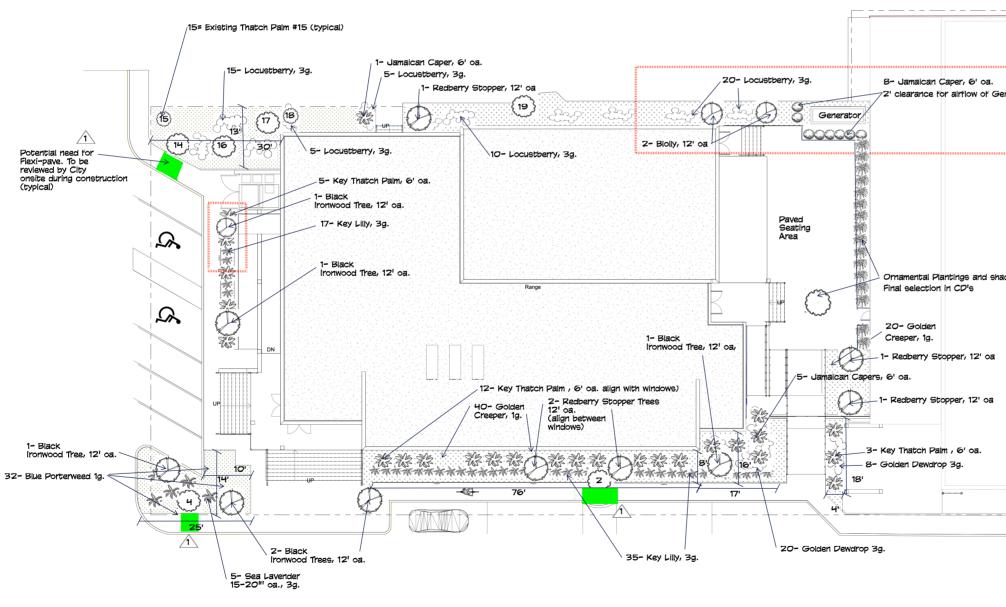

SITE PLAN - LANDSCAPE PLAN 1 SCALE: 3/32" = 1'-0"


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ade tree		Submissions: 1 IISBUD DRC 09972021 11/16/21 1/3/22 1/7/22 2/1/22 1/7/22
		FREDERICK DOUGLASS GYM 111 OLIVIA STREET, KEY WEST, FL, 33040 CITY OF KEY WEST 1300 WHITE STREET, KEY WEST, FL, 33040
		PLOTTED: 12/15/2021 2:36:25 PM Drawing Size 19095 Drawn By: Designer REQUIRED LANDSCAPE PLAN
Note: Reproduction or any other use of this plan without prior writt	en consent or permission is strictly prohibited.	Sheet Number: L1.1.2 Date: 12/9/21 C0021 by K2M Design, Inc.

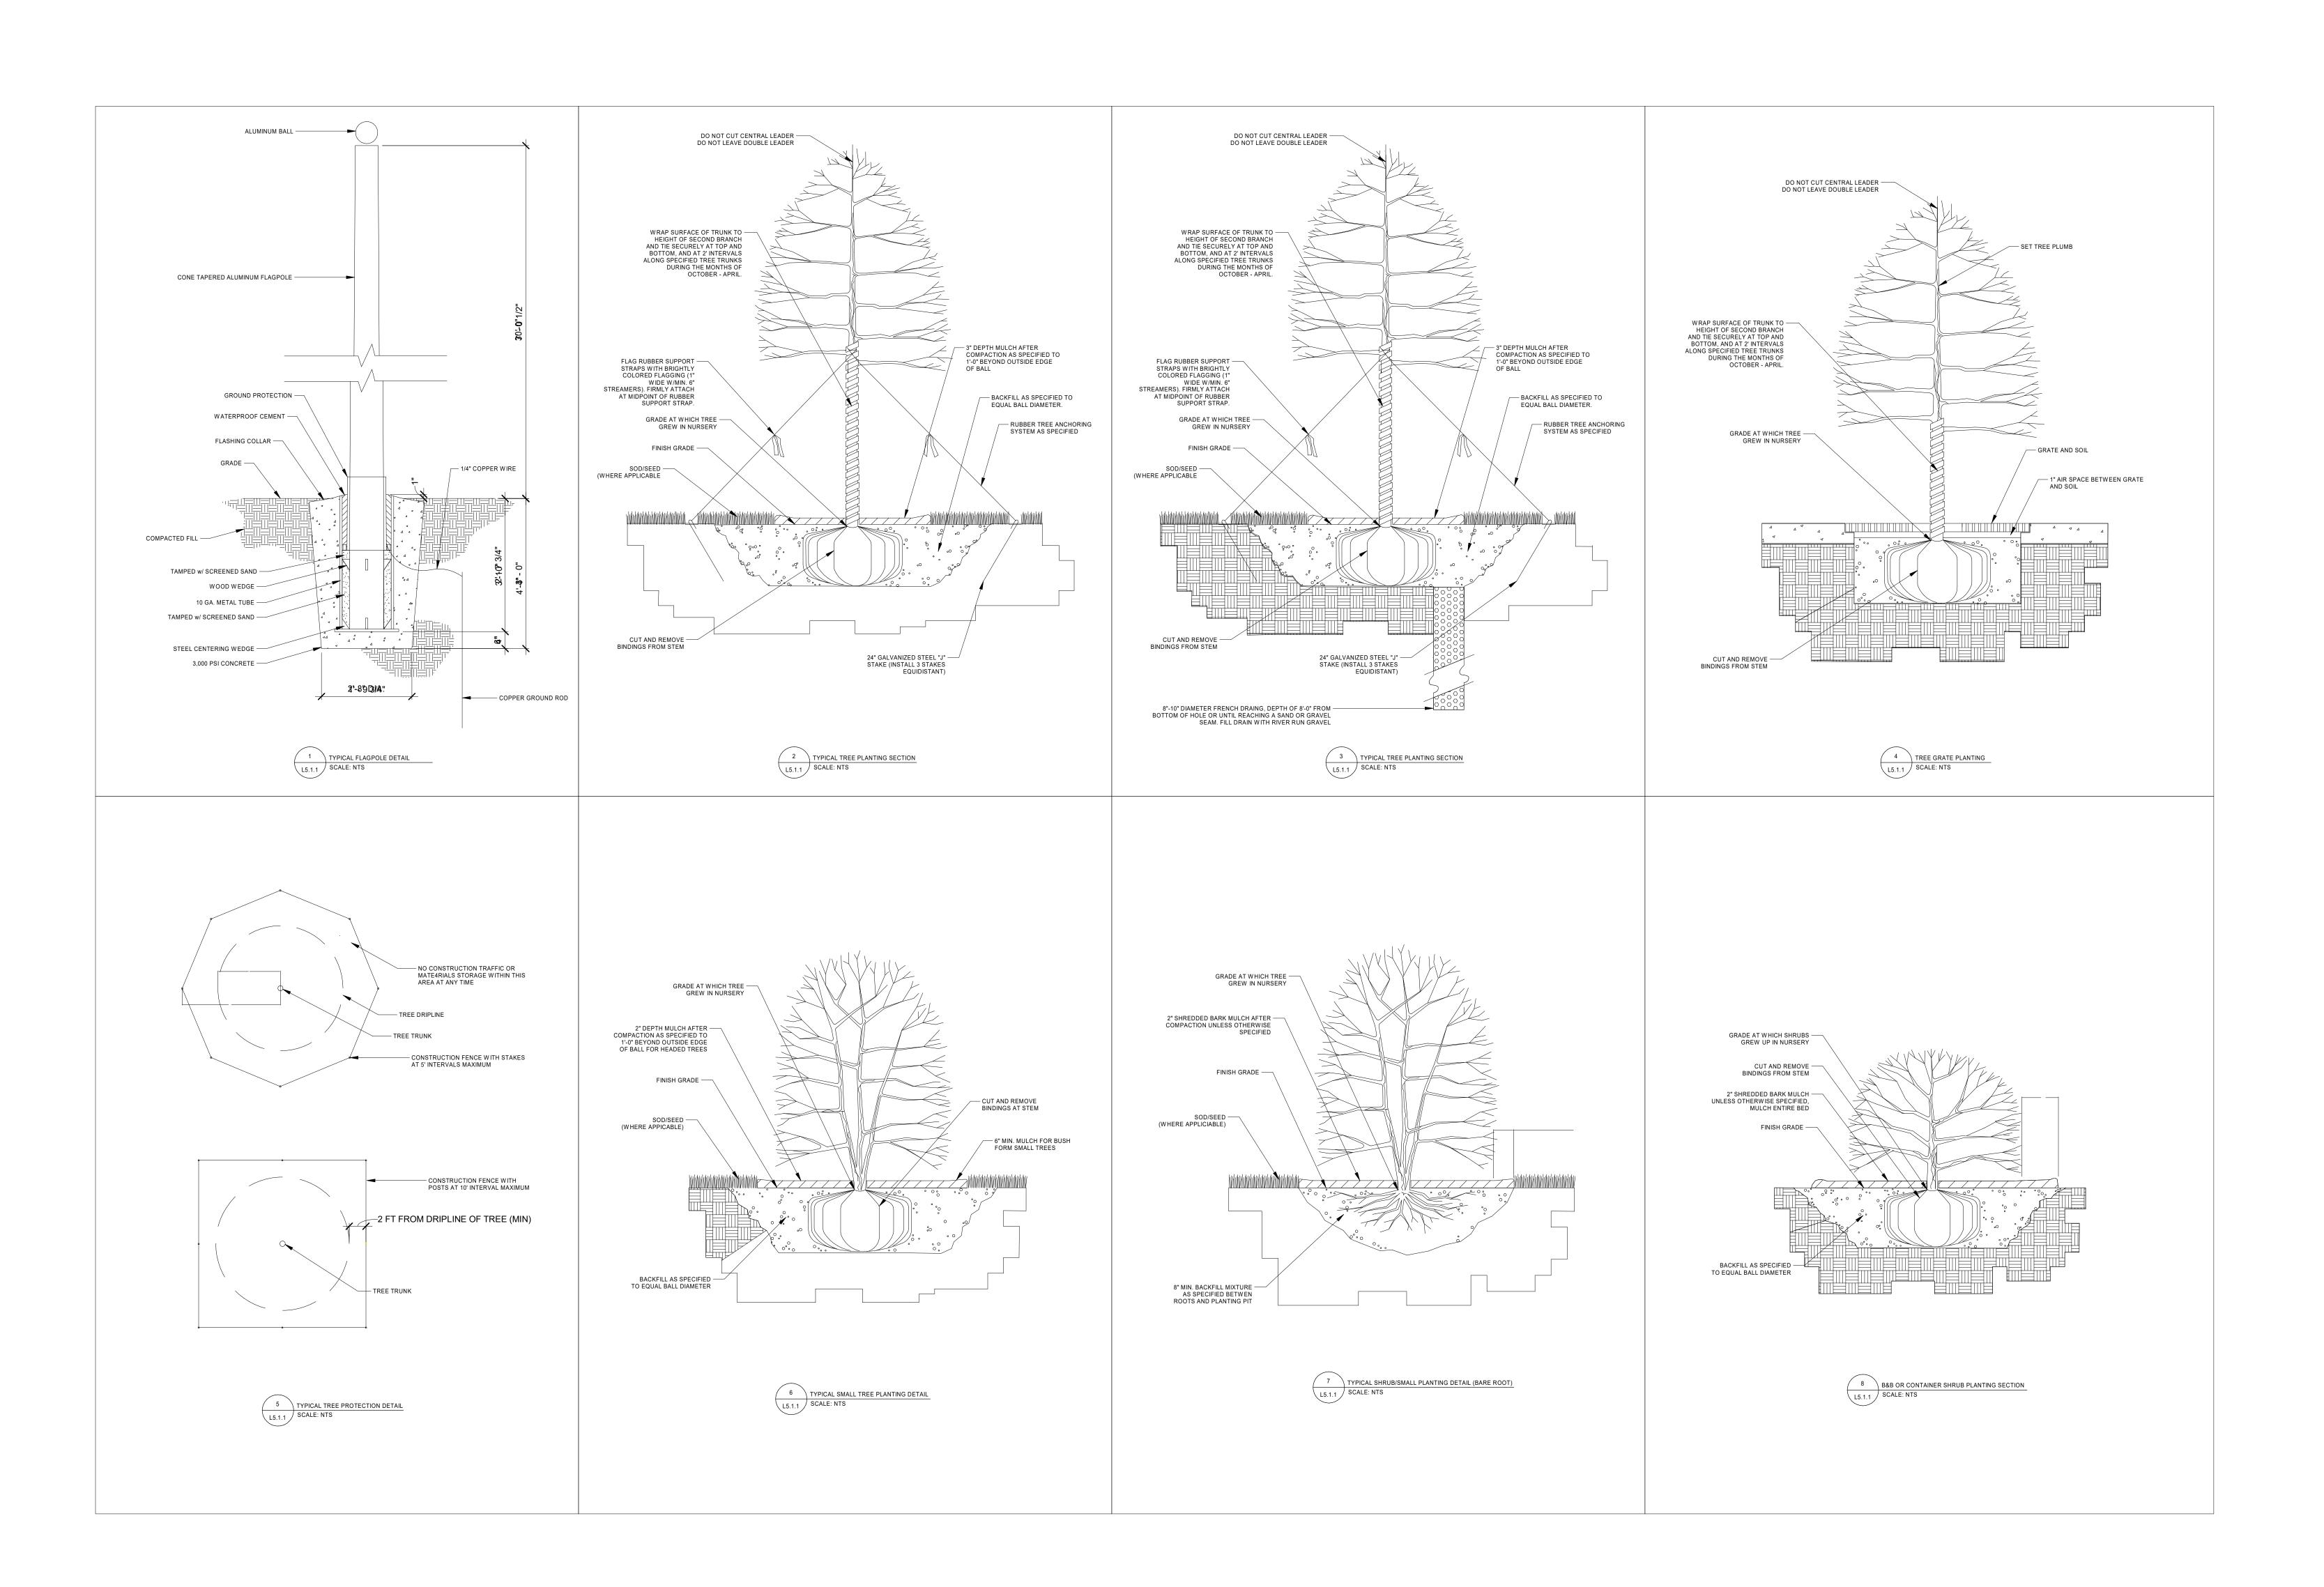

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 ΥM Ċ ST DOUGLASS WE Est, fl \succ KEY KEY ЧO FREDERICK I 111 OLIVIA STREE СІТҮ 300 МНІТЕ PLOTTED: 11/16/2021 12:47:29 PM Drawing Size Project #: 30x42 19095 Drawn By: Checked By: LBB/EHP EG Title: LANDSCAPE/SITE DETAILS Sheet Number: L5.1.1 Date: 08/04/2021 ©2021 by K2M Design, Inc.

- ALL EXCAVATED AREAS TO BE SEEDED OR SODDED AFTER FINAL GRADING UNLESS OTHERWISE NOTED. 1. SEE LANDSCAPE PLAN AND/OR EROSION CONTROL PLAN FOR DIRECTIONA ND VERIFICATION. PROVIDE POSITIVE DRAINAGE IN ALL PAVED AREAS WITHOUT PONDING WATER. THE PAVING 2 CONTRACTOR SHALL TEST ALL PAVED AREAS FOR BIRD BATH CONDTIONS BY FLOODING THE ENTIRE AREA
- WITH WATER AND MARKING THE POND AREA PRIOR TO THE INSTALLATION OF THE TOPPING COURSE. CORRECTION SHALL BE MADE IF NECESSARY. THE CONCTRACTOR SHALL VERIFY ALL DIMENSIONS AND ELEVATIONS IN THE FIELD PRIOR TO THE START 3. OF CONSTRUCTION. THE CONCTRACTOR SHALL BE RESPONSIBLE FOR ALL FIELD DIMENSIONS AND
- ELEVATIONS DURING THE ENTIRE CONSTRUCTION SCHEDULE. IF ANY DISCREPANCIES ARE FOUND IN THESE ENGINEERING PLANS, LANDSCAPE PLANS, OR SURVEY PLANS FROMACTUAL FIELD CONDITIONS, THE CONTRACTOR SHALL CONTACT THE A/E IMMEDIATELY. 4. ALL CONTRACTOR(S) BUT NOT LIMITED TO THE EXCAVATING CONTRACTOR(S) MUST TAKE PARTICULAR CARE WHEN EXCAVATING IN AND AROUND EXISTING UTILITY LINES AND EQUIPMENT. ACTUAL FIELD
- LOCATION OF ALL EXISTING UTILITIES ARE THE CONTRACTORS RESPONSIBILITY AND MUST BE LOCATED EITHER BY THE REPRESENTATIVE OF THE UTILITY COMPAY OR BY A PRIVATE UNDERGROUND UTILITY LOCATION COMPANY PRIOR TO THE START OF EXCAVATING. VERIFY MINIMUM COVERAGE REQUIREMENTS BY THE UTILITY COMPANY OR CONTRACTOR(S) SO AS NOT TO CAUSE DAMAGE.
- IT IS THE CONTRCTORS RESPONSIBILITY TO NOTIFY ALL THE UTILITY COMPANIES AND DEPARTMENTS 72 HOURS BEFORE COMMENCING CONSTRUCTION ACTIVITIES TO VERIFY AND UTILITIES THAT MAY BE PRESENT ON THE SITE. ALL VERIFICATIONS, LOCATIONS, SIZE, AND DEPTHS SHALL BE MADE BY THE UTILITIES, THE CONTRACTOR MUST NOTIFY THE UTILITY COMPANY OR DEPARTENT SO A REPRESENTATIVE OF THE UTILITY CAN BE PRESENT DURING THE EXCAVATING TO INSTRUCT AND OBSERVE THE EXCAVATION.
- TRENCHES FOR ALL UTILITIES SHALL BE BACKFILLED COMPLETELY WITH APPROVED ENGINEERED 6. GRANULAR MATERIAL SUITABLE TO THE A/E. SEE THE APPROPRIATE DETAILS AND SPECIFICATIONS FOR THE APPROVED MATERIALS.
- 7. ALL PROPOSED SPOT ELEVATIONS ARE THE FINAL TOP OF PAVEMENT, TOP OF CURB OR FINAL GRADE ELEVATION. TO DETERMINE THE SUBGRADE ELEVATION REQUIRED BELOW, SEE APPROPRIATE DETAIL.
- HEAVY CONSTRUCTION EQUIPMENT AND TRAFFIC MAY CREATE PUMPING AND GENERAL DETERIORATION 8. OF THE SHALLOWER SOILS IF EXCESS SURFACE WATER IS PRESENT. PROPER PRECAUTIONARY STEPS MUST BE TAKEN DURING THE ENTIRE CONSTRUCTION SCHEDULE TO ALLEVIATE SUCH DAMAGE.
- ALL CONSTRUCTION METHODS AND MATERIALS MUST CONFORM TO CURRENT STANDARDS AND 9. SPECIFICATIONS OF THE FEDERAL, STATE, COUNTY, CITY, OR LOCAL REQUIREMENTS, WHICHEVER HAS JURISDICTION. EXISTING PAVEMENTS, SIDEWALKS, CURBS, DRIVEWAYS, ELECTRICAL TRANSFORMERS AND PADS, 10.
- DITCHES, DRAINAGE PIPES AND STRUCTURES, FENCES, LAWNS, TRESES, BUSHES, MAILBOXES, SIGNS, POWER POLES, ETC. TO REMAIN AND BE PROTECTED FROM DAMAGE BY THE CONTRACTOR. ANY DAMAGE DURING CONSTRUCTION SHALL BE RESTORED, RECONSTRUCTED OR REPLACED BY THE CONTRACTOR AT THIS EXPENSE. ALL DAMAGES SHALL BE RESTORED OR REPLACED TO ATLEAST THEIR ORIGINAL CONDITION OR AS REQUIRED OR DICTATED BY FEDERAL, STATE, COUNTY, CITY, OR LOCAL AGENCIES.
- 11. IT IS THE RESPONSIBILITY OF THE CONTRACTOR TO OBTAIN ALL FEDERAL, STATE, COUNTY, CITY, OR LOCAL PERMITS FOR ANY AND ALL WORK REQUIRED UNLESS OTHERWISE NOTED. THE CONTRACTOR IS RESPONSIBLE TO PAY FOR ALL REQUIRED PERMITS BY ANY OR ALL AGENCIES MENTIONED ABOVE UNLESS OTHERWISE NOTED IN THE CONTRACT OR SPECIFICATION.
- THE CONTRACTRO SHALL BE RESPONSIBLE TO PROVIDE AT HIS EXPENSE ALL AUTOMOBILE AND 12. PEDESTRIAN TRAFFIC CONTROL DEVICES REQUIRED BY FEDERAL, STATE, COUNTY, CITY, OR LOCAL AGENCIES. 13. IT IS THE RESPONSIBILITY OF THE CONTRACTOR TO INSPECT EACH DAY AND REMOVE ALL MUD, DIRT,
- GRAVEL, AND LOOSE MATERIALS TRACTED, DUMPED, SPILLED OR WIND BLOWN FROM THE SITE ONTO OTHER SITES, RIGHT OF WAYS, PBLIC OR PRIATE, STREETS OR ROADS, DRIVEWYS, YARDS, OR SIDEWALKS. THE CONTRACTOR MUST CLEAN OR PICK UP DAILY IF NECESSARY. THE CONTRACTOR SHALL REDUCE THE AIRBORNE DUST DURING THE ENTIRE CONSTRUCTION SCHEDULE. WATER MAY BE USED AS A REDUCER.

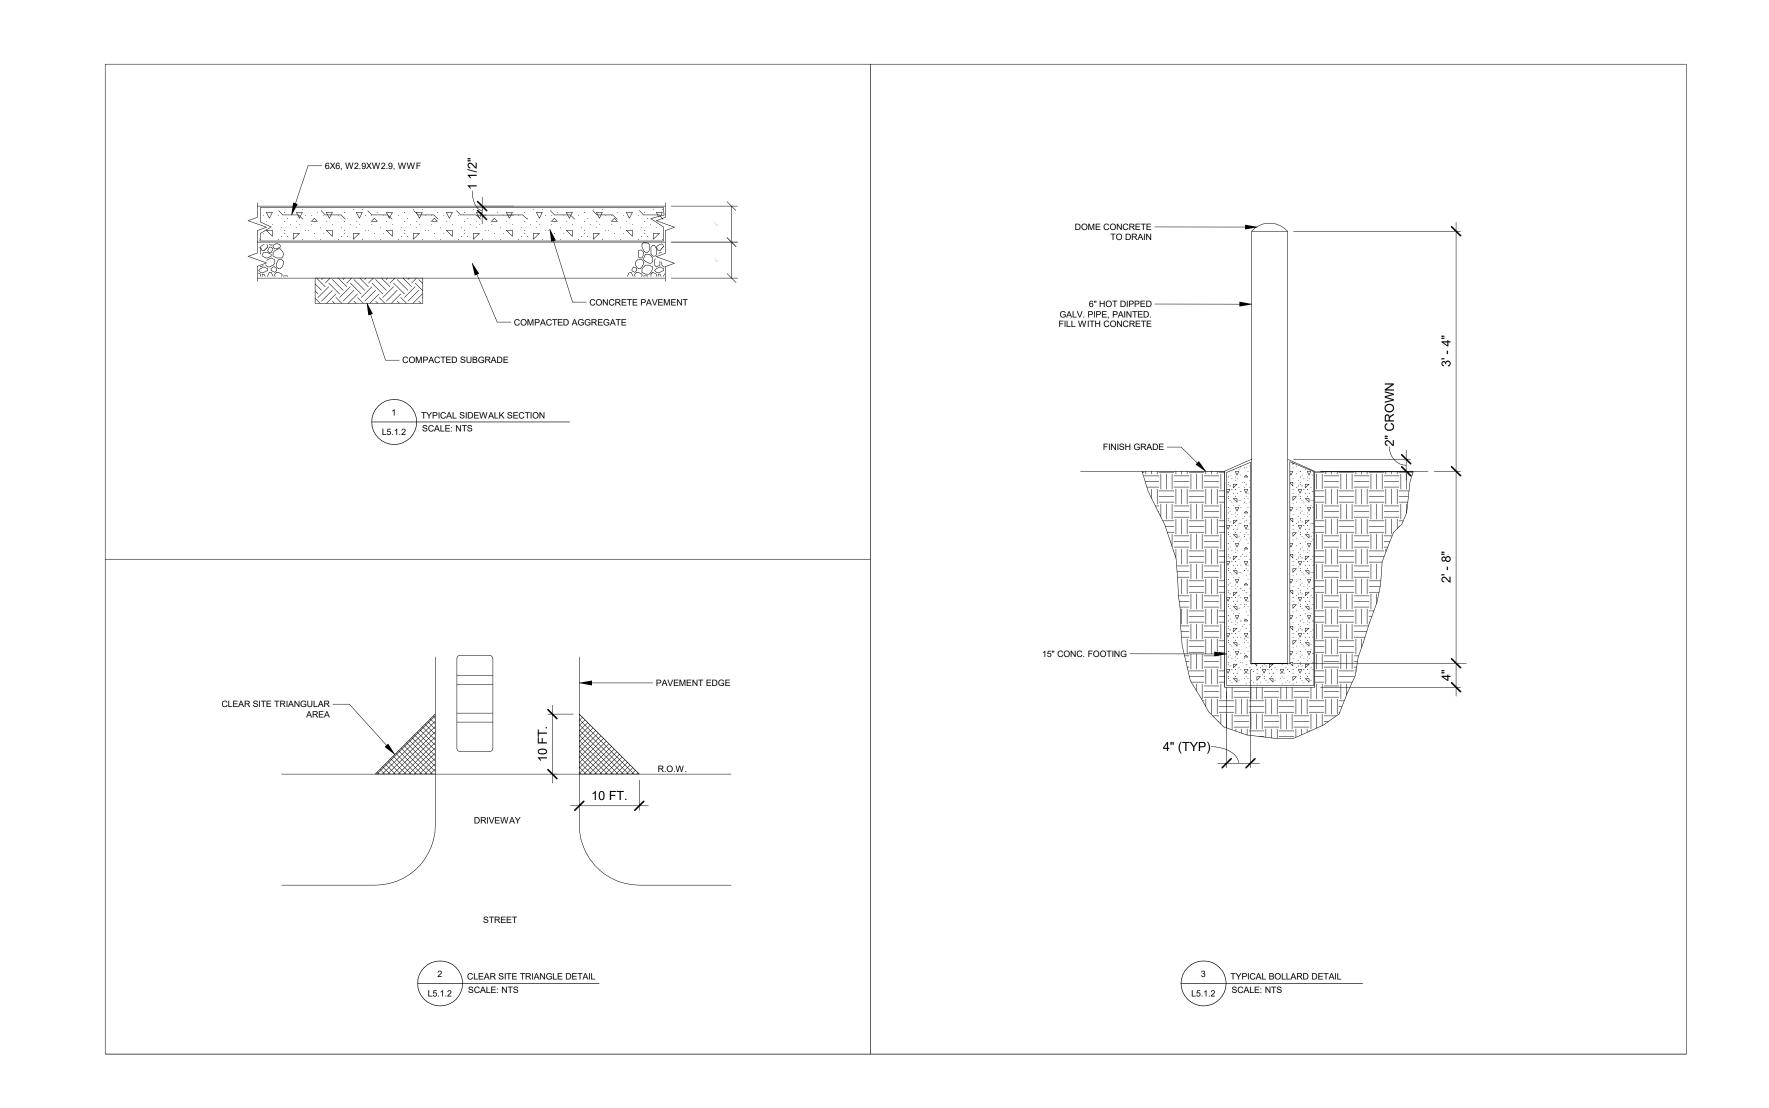

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