PLANNING BOARD RESOLUTION NO. 2022-001

A RESOLUTION OF THE CITY OF KEY WEST PLANNING GRANTING VARIANCES TO THE MAXIMUM BUILDING COVERAGE, MAXIMUM IMPERVIOUS SURFACE, MINIMUM OPEN SPACE, AND REAR SETBACK FOR **PROPERTY** LOCATED WITHIN THE HISTORIC NEIGHBORHOOD COMMERCIAL (HNC-3) ZONING DISTRICT PURSUANT TO SECTION 90-395, SECTION 122-870(4)A, 122-870(4)B, 122-870(6)C, AND SECTION 108-346(B) OF THE LAND DEVELOPMENT REGULATIONS **OF** THE CODE ORDINANCES OF THE CITY OF KEY WEST, FLORIDA.

WHEREAS, the applicant proposes to redevelop the Frederick Douglass Gymnasium "Annex" building on property located at 111 Olivia Street (RE# 00014720-000000); and

WHEREAS, Section 122-870(4)a of the Land Development Regulations (the "LDRs") of the Code of Ordinances (the "Code") of the City of Key West, Florida (the "City") provides the maximum building coverage as 40% or 13,600 square feet; and

WHEREAS, the proposed maximum building coverage would be 71% or 24,193 square feet; and

WHEREAS, Section 122-870(4)b of the Land Development Regulations of the Code of Ordinances of the City of Key West, Florida provides the impervious surface ratio of 60% or 20,400 square feet; and

WHEREAS, the proposed maximum impervious surface ratio would be 85% or 28,812 square feet; and

WHEREAS, Section 122-870(6)c of the Land Development Regulations of the Code of Ordinances of the City of Key West, Florida provides the minimum rear setback as 15 feet; and

WHEREAS, the proposed rear setback would be five (5) feet; and

WHEREAS, Section 108-346(b), of the Land Development Regulations of the Code of Ordinances of the City of Key West, Florida provides the minimum open space requirement is 20% or 6,800 square feet; and

Page 1 of 5 Resolution No. 2022-01

Chairman

KPH Planning Director

WHEREAS, the proposed open space ratio is 15% or 5,189 square feet; and

WHEREAS, this matter came before the Planning Board at a duly noticed public hearing on January 20, 2022; and

WHEREAS, reviewed the variances above pursuant to the criteria set forth in Section 90-395 of the Land Development Regulations of the Code of Ordinance of the City of Key West; and

WHEREAS, the Planning Board finds that special conditions and circumstances exist which are peculiar to the land, structure, or building involved and which are not applicable to other land, structures, or buildings in the same district; and

WHEREAS, the Planning Board finds that the special conditions do not result from the action or negligence of the applicant; and

WHEREAS, the Planning Board finds that granting the variance requested will not confer upon the applicant any special privileges denied by the land development regulations to other lands, buildings, or structures in the same zoning district; and

WHEREAS, the Planning Board finds that literal interpretation of the provisions of the land development regulations would deprive the applicant of rights commonly enjoyed by other properties in this same zoning district under the terms of this ordinance and would work unnecessary and undue hardship on the applicant; and

WHEREAS, the Planning Board finds that the variance granted is the minimum variance that will make possible the reasonable use of the land, building or structure; and

WHEREAS, the Planning Board finds that the granting of the variance will be in harmony with the general intent and purpose of the land development regulations and that such variance will not be injurious to the area involved or otherwise detrimental to the public interest or welfare; and

WHEREAS, the Planning Board finds that no nonconforming use of neighboring lands, structures, or buildings in the same district, and no permitted use of lands, structures or buildings in other districts are

Page 2 of 5 Resolution No. 2022-01

Chairman

Kpt Planning Director

grounds for the issuance of the requested variances; and

WHEREAS, the Planning Board finds that the applicant has demonstrated a "good neighbor

policy" by contacting or attempting to contact all noticed property owners who have objected to the variance

application, and by addressing the objections expressed by these neighbors.

NOW, THEREFORE, BE IT RESOLVED by the Planning Board of the City of Key West,

Florida:

Section 1. That the above recitals are incorporated by reference as if fully set forth herein.

Section 2. An approval by Resolution of the Key West Planning Board for variances to the

maximum building coverage to 71% or 24,193 square feet, maximum impervious surface to 85% or 28,812

square feet, minimum open space to 20% or 6,800 square feet, and rear setback to five (5) feet at 111 Olivia

Street (RE# 00014720-000000) within the Historic Neighborhood Commercial (HNC-3) zoning district

pursuant to Section 90-395, Section 122-870(4)a, Section 122-870(4)b, Section 122-870(6)c, and Section

108-346(b) of the Land Development Regulations of the Code of Ordinances of the City of Key West.

General Conditions:

1. The proposed construction shall be consistent with the site plan signed, sealed, and dated

December 9, 2021 by K2M Design.

2. The City of Key West shall retain off-site parking spaces at the public parking lot at 918 Fort

Street for the duration of the principal use of the Frederick Douglass Gym and Annex building. Signage

indicating that off-site parking is available at the Fort Street parking lots shall be installed on the project

site at 111 Olivia Street. Proposed off-site parking signage shall be reviewed and approved in accordance

with adopted Historic Architectural Review Commission guidelines.

3. The City shall install a crosswalk with ADA sidewalk access from the project site to the Fort

Street parking lot.

4. The Final Landscape Plan and Site Plan shall reflect replacement of the pavement in the patio

Page 3 of 5

Resolution No. 2022-01

Chairman

Planning Director

area ("Paved Seating Area") with semi-pervious turf material or pervious pavers to further reduce the impervious surface variance. The paved seating area shall also be modified to include non-linear perimeter planting beds for shade species (ferns or shrubs, as appropriate) to both improve the onsite open space ratio, aesthetics, and human comfort/functionality of this integral meeting area that links the Gym with the Community Center.

Section 3. It is a condition of this variance that full, complete and final application for all conditions of this approval for any use and occupancy for which this variance is wholly or partly necessary, shall be submitted in its entirety within two years after the date hereof; and further, that no application shall be made after expiration of the two-year period without the applicant obtaining an extension from the Planning Board and demonstrating that no change of circumstances to the property or its underlying zoning

Section 4. The failure to fully and completely apply the conditions of approval for permits for use and occupancy pursuant to these variances in accordance with the terms of the approval as described in Section 3 hereof, shall immediately operate to terminate these variances, which variances shall be of no force or effect.

has occurred.

Section 5. This variance does not constitute a finding as to ownership or right to possession of the property, and assumes, without finding, the correctness of applicant's assertion of legal authority respecting the property.

Section 6. This resolution shall go into effect immediately upon its passage and adoption and authentication by the signatures of the presiding officer and the Clerk of the Commission.

Section 7. This resolution is subject to appeal periods as provided by the City of Key West Code of Ordinances (including the Land Development Regulations). After the City appeal period has expired, this permit or development order will be rendered to the Florida Department of Economic Opportunity. Pursuant to Chapter 73C-44, F.A.C., this permit or development order is not effective for forty Page 4 of 5

Page 4 of 5 Resolution No. 2022-01

Chairman

KP(+ Planning Director

five (45) days after it has been properly rendered to the DEO with all exhibits and applications attached to or incorporated by reference in this approval; that within the forty five (45) day review period, the DEO can appeal the permit or development order to the Florida Land and Water Adjudicatory Commission; and that such an appeal stays the effectiveness of the permit until the appeal is resolved by agreement or order.

Read and passed on first reading at a regularly scheduled meeting held this 20th day of January 2022.

Authenticated by the Chairman of the Planning Board and the Planning Director;

Sam Holland, Planning Board Chair

Attest:

Katie P. Halloran, Planning Director

Filed with the Clerk:

Cheryl Smith, City Clerk

Page 5 of 5 Resolution No. 2022-01

Chairman

Planning Director

CITY OF KEY WEST

KEY WEST, FL

FREDERICK DOUGLASS GYM **NEW CONSTRUCTION**

PLANNING SUBMITTAL

ISSUED - 2021.12.09 UPDATE 2022.01.11 - LANDSCAPE & CIVIL UPDATE





CITY OF KEY WEST

Drawing Size	Project #:
30x42	19095
Drawn By: .BB/EHP	Checked By:

APPROVALS RECIVED

AN I HOVALS RECIVED	DATE
1. PROGRAMMING	APPROVED XXXXXXX
2. SCHEMATIC DESIGN	APPROVED XXXXXXX
3. TREE COMMISSION - CONCEPTUAL	APPROVED XXXXXXX
4. HISTORIC ARCHITECTURAL REVIEW COMMISSION	APPROVED XX/XX/XX
5. DESIGN REVIEW COMMITTEE	APPROVED XXXXXXX
6. PLANNING COMISSION	APPROVED XXXXXXX
7. DESIGN DEVELOPMENT	APPROVED XXXXXXX
8. TREE COMMISSION - FINAL	APPROVED XX/XX/XX
9. CONSTRUCTION DOCUMENTS	APPROVED XXXXXXX
10. BIDDING	APPROVED XXXXXXX
11. PERMITTING	APPROVED XXXXXXX

PROJECT LOCATION

GENERAL NOTES

- The contract documents consist of this set of drawings, addenda, construction change directives, change orders, the contract between the owner and contractor, conditions of the contract and any other information written and mutually agreed upon between the owner and contractor.

 These drawings are complementary and interrelated; work of any individual trade is not a season of the contract documents to be designed in accordance with all its interrelated differences in effect at the time the permit is issued. Notify architect immediately and individual trade is not a season of the contract documents to be designed in accordance with all its discrepancy on discovery of suspected deviation.

 If discrepancy on discovery of suspected deviation.

 Construction techniques are consistent request for information procedure.

 Construction techniques are consistent request for information procedure.

 Construction techniques are consistent request for information procedure.

 Construction techniques are consistent request for information should be a solely the construction techniques are solely than the construction techniques are solely the construction and the construction are solely the construction and the construction are solely the construction and the construction are constructed and the construction are constructed as a solely

- with the work.

 Coordinate locations and/or elevations of floor drains, registers, grilles, louvers, ducts, unit heaters, panels, etc. with the Mechanical, Plumbing, and Electrical Contractors after architectural drawings.

 Blocking at openings, doors, windows, and wall mounted fixtures shall be 2x FRT materials. At wall mounted equipment locations, use 1/2* plywood sheet materials. At locations are contact with contract or concrete masonry units to be pressure that the contact with contract or concrete masonry units to be pressure or conficions, even though not specifically marked on the drawings.

 All abbreviations, materials and symbols in legends may or may not be used. Follow the manufacturer's instruction specifications for preparation, implementation, and construction of all materials and systems.

SYMBOLS NAME 101A

(X) DETAIL TAG 1 Ref SECTION TAG

--(×)

ROOM IDENTIFICATION TAG

ELEVATION TAG

ELEVATION NUMBER SHEET NUMBER

INTERIOR ELEVATION TAG

ELEVATION NUMBER SHEET NUMBER SECTIONNUMBER SHEET NUMBER

DOOR TAG. REFER TO DOOR SCHEDULE WINDOW TAG. REFER TO WINDOW SCHEDULE WALL TAG. REFER TO WALL TYPES.

BREAK LINE GRAPHIC SCALE

NORTH ARROW View Name DRAWING TITLE 01 SCALE: 1/8" = 1'-0"

SCOPE OF WORK

DEMO SCOPE:

DEMOLITION OF EXISTING 6,114 SF MUSIC & TUTORING PROGRAM
BUILDING ATTACHED TO FREDERICK DOUGLASS GYM AND ASSOCIATED
MECHANICAL, ELECTRICAL, PLUMBING, AND STRUCTURE. DEMO OF
EXISTING ASPHALT PARKING LOT, CONCRETE RAMPS, WALKS, AND
PADS, FLEX PAVER PATH AT LEARNING GARDEN, AND FLAG POLE/BASE.
DEMO OF EXISTING DUMPSTER ENCLOSURE AND ASSOCIATED PAD.
REMOVAL OF ALL EXISTING BIKE RACKS AT GYMPARKING LOT.
REMOVAL OR SALVAGE OF TREES PER L-SHEETS. EXISTING GYM TO
REMAIN IN-TACT. NO STRUCTURAL OR UTILITY WORK.

NEW CONSTRUCTION SCOPE.
CONSTRUCTION OF NEW 9,587 SF 1-STORY BUILDING WITH CMU
EXTERIOR WALL CONSTRUCTION, GROUND FLOOR CONCRETE SLAB,
FIRST FILOOR AND ROOF STEEL BEAM STRUCTURE. IMPACT RATED
STORERONT GLAZING/DOOR SYSTEM. EIFS SYSTEM AND STUCCO PER
ELEVATIONS. TPO MEMBRANE ROOF, NEW RAILINGS AND STARRS/RAMP
PER PLANS, NEW PARKING LOT PER PLAN AND BIKE RACKS PER PLAN,
NEW UTILITY CONNECTIONS PER CIVIL. NEW LANDSCAPE PLAN PER LSHEETS.

CODE INFORMATION

BUILDING CODE
MICHANICAL CODE:
PLUMBING CODE
ELECTRICAL CODE:
FUEL GAS CODE
ENERGY CODE:
ADA ACCESSIBILITY CODE:
STANDARD LOAD DESIGN CRITERIA 2020 FLORIDA BUILDING CODE, 6TH EDITION 2020 FLORIDA MECHANICAL CODE 2020 FLORIDA PLUMBING CODE 2020 FLORIDA PLUMBING CODE 2020 NATIONAL ELECTRIC CODE (NEC) NFPA 2020 FLORIDA FUEL GAS CODE 2020 FLORIDA FUEL GAS CODE 2020 FLORIDA ENERGY CONSERVATION CODE 2020 FLORIDA ACCESSIBILITY CODE ASCE 7-10

LOCAL BUILDING REQUIREMENTS: FEMA REQUIREMENTS: PEMA REQUIREMENTS:
DESIGN FLOOD ELEVATION:
CURRENT ZONING
MAX BUILDING HEIGHT:
FLORIDA GREEN BUILDING:
USE GROUP:

CITY OF KEY WEST CODES AND ORDINANCES FLOOD ZONE: AE: 7: NGVD 1929 FLOOD ZONE: 40: FET NGVD 1929 FLOOD ZONE: 40: FET NGVD 1929 FLOOD PLAIN COMPLIANCE: ASCE 24-14" SUBURBAN COMMERCIAL 35' FROM COR MIN REQUIREMENTS TO BE MET ASSEMBLY

ALL ELEVATIONS PROVIDED IN NGVD 1929. NAVD 1988 CONVERSION = -1.34'

DRC STATEMENTS

BUILDING DESIGNED WITH THE FIRST FINISHED FLOOR AT OR ABOVE THE NEW BASE FLOOD ELEVATION SHOWN ON FEMA'S PRELIMINARY FRAIS (MAYD 1986) PRESENTLY UNDER APPEAL.

PARKING VARIANCE WILL BE REQUIRED WITH THIS APPLICATION.

PARKING TO BE MAINTAINED ON SITE.

NO PROPOSED RESIDENTIAL UNITS/DEVELOPMENT WITH THIS APPLICATION.

INTERGOVERNMENTAL COORDINATION TO BE PERFORMED DURING THE REMAINING PHASES OF THE PROJECT AND COMPLETED PRIOR TO CITY COMMISSION APPROVAL. PROPOSED USE = COMMUNITY CENTER

TRASH TO BE COLLECTED ON SITE FOR PICK UP BY WASTE MANAGEMENT.

STORMWATER TO BE MAINTAINED ON SITE

BUILDING INFORMATION

FREDERICK DOUGLASS GYM EXPANSION 111 OLIVIA STREET KEY WEST, FLORIDA 33040

USE GROUP: ASSEMBLY A-3 EDUCATIONAL E

OCCUPANCY CALCULATIONS:

CCUPANCY CALCULATIONS:

E - CLASSROOM 20 SF NET/OCCUPANT
E - COMMERCIAL KITCHEN 300 GROSS SF/OCCUPANT
MECH 300 GROSS SF/OCCUPANT
300 GROSS SF/OCCUPANT

EGRESS WIDTH = .20"/OCCUPANT 44" REQUIRED

TRAVEL DISTANCE: MAX LENGTH OF TRAVEL = 200 FT COMMON PATH OF EGRESS = 75 FT

NUMBER OF EXITS: REQUIRED = 2 PROVIDED = 3

CONSTRUCTION TYPE: TABLE 601 TYPE IIB

BUILDING IS NOT SPRINKLED

FIRE RESISTANCE RATINGS: FIRE STAIR WALLS

SHAFT WALLS

FIRE STAIR WALLS

FIRE STAIR OOORSWINDOWS

FIRE SEPARATION @ LOBBY

FIRE SEPARATION @ MAIN HALL

LOBBY INTERIOR DOORS

NON-LOAD BEARING EXT WALLS

O HR

BUILDING SQUARE FOOTAGE: 1ST FLOOR - 9,587 SF

BUILDING IS IN THE HISTORIC DISTRICT

CONTRACTOR GENERAL NOTES:
-ALL WORK TO BE IN ACCORDANCE WITH APPLICABLE CODES.
- WORKMANSHIP TO MEET OR EXCEED ACCEPTED STANDARDS OF RESPECTIVE TRANSE.

TRADES.

VERIFY ALL DIMENSIONS, ELEVATIONS, AND FIELD CONDITIONS BEFORE START OF CONSTRUCTION. NOTIFY ARCHITECT IF ANY CONFLICTS EXIST PRIOR TO COMMENCEMENT OF WORK.

FOR ANY TYPE I OR TYPE I CONSTRUCTION PROJECTS FIRE RETARDANT TREATED WOOD (EXTERIOR OR INTERIOR GRADE) MUST BE USED IN ALL WOOD CONSTRUCTION MATERIALS.

FOR ALL WALL SYSTEMS WITH EIFS USE EXTERIOR GRADE GLASS MATT SHEATHING OR CEMENTITIOUS BOARD ONLY.

FIRE EXTINGUISHERS WILL BE PROVIDED AS REQUIRED BY AUTHORITY HAVING JURISDICTION OR AS DIRECTED BY THE LOCAL FIRE DEPARTMENT.

WALL R-VALUE (CONTINUOUS) = 6 WALL R-VALUE (CAVITY) = 13 ROOF R-VALUE = 39

CONTRACTOR TO PROVIDE ESR REPORTS FOR CLOSED-CELL SPRAY FOAM SELECTED FOR REVIEW BY DESIGN PROFESSIONAL.

ADA COMPLIANCE STATEMENT

This project has been designed in accordance to the 2010 ADA Code and the 2020 Florida Accessibility Code

DRAWING INDEX

DRAWING INDEX Sheet Number

┸			ABBREVIATIONS
X	X	G0.0.3	3D VIEWS
X	X	G0.0.4	3D VIEWS
L	X	G0.0.5	MATERIALS & COLORS
X	X	V1.1.1	SITE SURVEY
Х	X	G0.1.1	ACCESSIBILITY GUIDLINES ICC A117,1-2009
х	X	G0.1.2	ACCESSIBILITY GUIDLINES ICC A117.1-2009
L		G0.2.1	UL DETAILS
	X	G2.1.1	LIFE SAFETY PLANS

CI	VIL			
	X	X	C 01	EXISTING CONDITIONS
	X	X	C 02	CONCEPT SITE PLAN
		X	C 03	CONCEPT DRAINAGE PLAN
	X	X	C 04	CONCEPT UTILITY PLAN
			AD1.1.1	DEMOLITION SITE PLAN/FLOOD DLAN
_				DEMOLITION SITE PLAN/FLOOR PLAN
_	X		A1.1.0	SITE DATA TABLES
_		X	A1.1.1	ARCHITECTURAL SITE PLAN
X	X	X	A2.1.1	FIRST FLOOR PLAN
_	┺		A2.2.1	FIRST FLOOR REFLECTED CEILING PLAN
	IX	IX I	A231	DOOF OLAN

_		101	A2.3.1	IROOF PLAN
х	X	X	A3.1.1	EXTERIOR ELEVATIONS
X	X	X	A3.1.2	EXTERIOR ELEVATIONS
			A3.2.1	BUILDING SECTIONS
_			A3.2.2	BUILDING SECTIONS
_	L		A3.2.3	BUILDING SECTIONS
_			A3.4.1	ENLARGED SECTION DETAILS
_			A6.1.1	WINDOW/DOOR SCHEDULES
_			A6.2.1	DOOR DETAILS
_	_		A6.2.2	WINDOW DETAILS
_			A7.1.1	STAIR PLANS, SECTIONS, AND DETAILS
	\perp		A7.2.1	ELEVATOR PLANS, SECTIONS, AND DETAILS
_			A8.1.1	ROOFING DETAILS
_			A8.2.1	EXTERIOR DETAILS
_			A8.3.1	INTERIOR DETAILS
_			A9.1.1	WALL TYPES

	14.2.2	INTERIOR ELEVATIONS
	12.1.1	FINISH PLANS
	12.2.1	CEILING PLAN
	12.3.1	FIRST FLOOR FURNITURE PLAN
1	14.2.1	INTERIOR ELEVATIONS
	15.1.1	ENLARGED MILLWORK PLANS
	15.2.1	MILLWORK DETAILS & SECTIONS
	16.1.1	SCHEDULES - FINISH & FINISH LEGEND
	19.1.1	INTERIOR DETAILS

TURAL			
	S0.1	GENERAL NOTES	
	\$0.2	GENERAL NOTES	
	\$0.3	SPECIAL INSPECTIONS	
	\$1.1	FOUNDATION PLAN	
	\$1.3	MAIN HALL ROOF FRAMING PLAN	
	\$1.4	ROOF FRAMING PLAN	
	S2.1	FOUNDATION TYPICAL DETAILS	
	52.2	FOUNDATION SECTIONS	
	\$3.1	FRAMING TYPICAL DETAILS	
	\$3.2	FRAMING SECTIONS	-
	\$4.1	ROOF TYPICAL DETAILS	
	S4.2	ROOF SECTIONS	

MO.1.1	GENERAL NOTES AND SCHEDULES
M1.1.1	MECHANICAL PLANS - LEVEL 1
M2.3.1	ROOF MECHANICAL PLAN
M5.1.1	MECHANICAL BUILDING AUTOMATION PLANS
M5.1.2	MECHANICAL BUILDING AUTOMATION PLANS

PLUMBIN	G	
	P0.1.1	PLUMBING SCHEDULES, NOTES & SYMB
	P1.1.1	DMY PLUMBING PLANS
	P1.2.1	DOMESTIC WATER PLUMBING PLANS
	P3.1.2	SANITARY/VENT RISER DIAGRAM
	P5.1.1	DETAILS
ELECTRIC		

	E2.1.3	MECHANICAL POWER PLAN
	E0.1.1	LEGENDS & SCHEDULES
	E1.1.1	ELECTRICAL SITE PLAN
	E2.1,1	FIRST FLOOR POWER PLAN
	E2.2.1	FIRST FLOOR LIGHTING PLAN
	E2.3.1	TECHNOLOGY PLAN
	E3.1.1	ONE LINE DIAGRAM
	E3.1.2	PANEL SCHEDULES/RISER DIAGRAM
	E5.1.1	ELECTRICAL DETAILS
	E6.0.1	ELECTRICAL ONE-LINE DIAGRAM
	E6.1.1	ELECTRICAL SCHEDULES
DSCAPE		
X	L1.1.1	EXISTING LANDSCAPE PLAN
x	L1.1.2	REQUIRED LANDSCAPE PLAN
v 1	1.5	THE BUILD DUIDSCAPE PLAN

	E6.1.1	ELECTRICAL SCHEDULES
ANDSCAPE		
X	L1.1.1	EXISTING LANDSCAPE PLAN
X	L1.1.2	REQUIRED LANDSCAPE PLAN
X	L5.1.1	LANDSCAPE/SITE DETAILS
X	L5.1.2	LANDSCAPE/SITE DETAILS
RRIGATION		
TIT	IR1.1.1	Indicates
+++	IR1.1.2	IRRIGATION SITE PLAN, NOTES AND DETAILS
-	IR1.1.2	IRRIGATION SITE PLAN

DESIGN TEAM INFORMATION

POINT OF CONTACT: Devon Ayers K2M Design 1150 Virginia Street Key West, FL 33040 tel: 305.307.5840 fax: 216.357.2796

Mark Wutz K2M Design 3121 Bridge Avenue Cleveland, Ohio 44113 tel: 216.588.0715 ext. 1158 fax: 216.357.2796

MEP ENGINEER:

INTERIOR DESIGN: Valene Tabone K2M Design 3121 Bridge Avenue Cleveland, Ohio 44113 tel: 216.357.2794 fax: 216.357.2796

STRUCTURAL ENGINEER:

Steven S. Grasley K2M Design 1150 Virginia Street Key West, FL 33040 tel: 855.866.4526

CIVIL ENGINEER: Jason Panicaro CW3 Engineers 5783 Bayshore Rd. Suite 113 N. Ft. Myers FL 33917 tel. 239.205.6473

ARCHITECT:

Scott Maloney K2M Design 3121 Bridge Avenue Cleveland, Ohio 44113 tel: 855.866.4526 fax: 216.357.2796

IRRIGATION: Blue Island Lighting & Irriga 3255 Flagler Avenue #307 Key West, FL 33040 tel. 305.293.8444

SURVEYOR:

GEOTECHNICAL ENGINEER: Nutting Engineers 2051 NW 112th Avenue #126 Miami, FL 33172 tel. 305.824.0060

Florida Keys Land Surveying 19960 Overseas Highway Sugarloaf Key, FL 33042 tel. 305.394.3690

SHEET NUMBERING SYSTEM

DISCIPLINE: SERIES NUMBER SUB-SERIES NUMBER NUMBER OF DRAWINGS WITH IN SUB-SERIES

KPIT

K₂M

URL: www.k2mdesign.com PROF. REG. AA26001059

Building Relationships Based on Trust and Results d | Columbus | Indianapole | Key Larg Marathon | Charlotte | Baltimore | Bert




1 03-060 SD SI T 08/26/200 2 03-060 DRC 08/17/200

GYM FREDERICK DOUGLASS (OF KEY WEST CITY


12/22/2021 4:23:05 PM Drawn By: Checked B LBB/EHP EG

DRAWING INDEX, COD INFO., SYMBOL LEGEND, & ABBREVIATIONS

G0.0.2

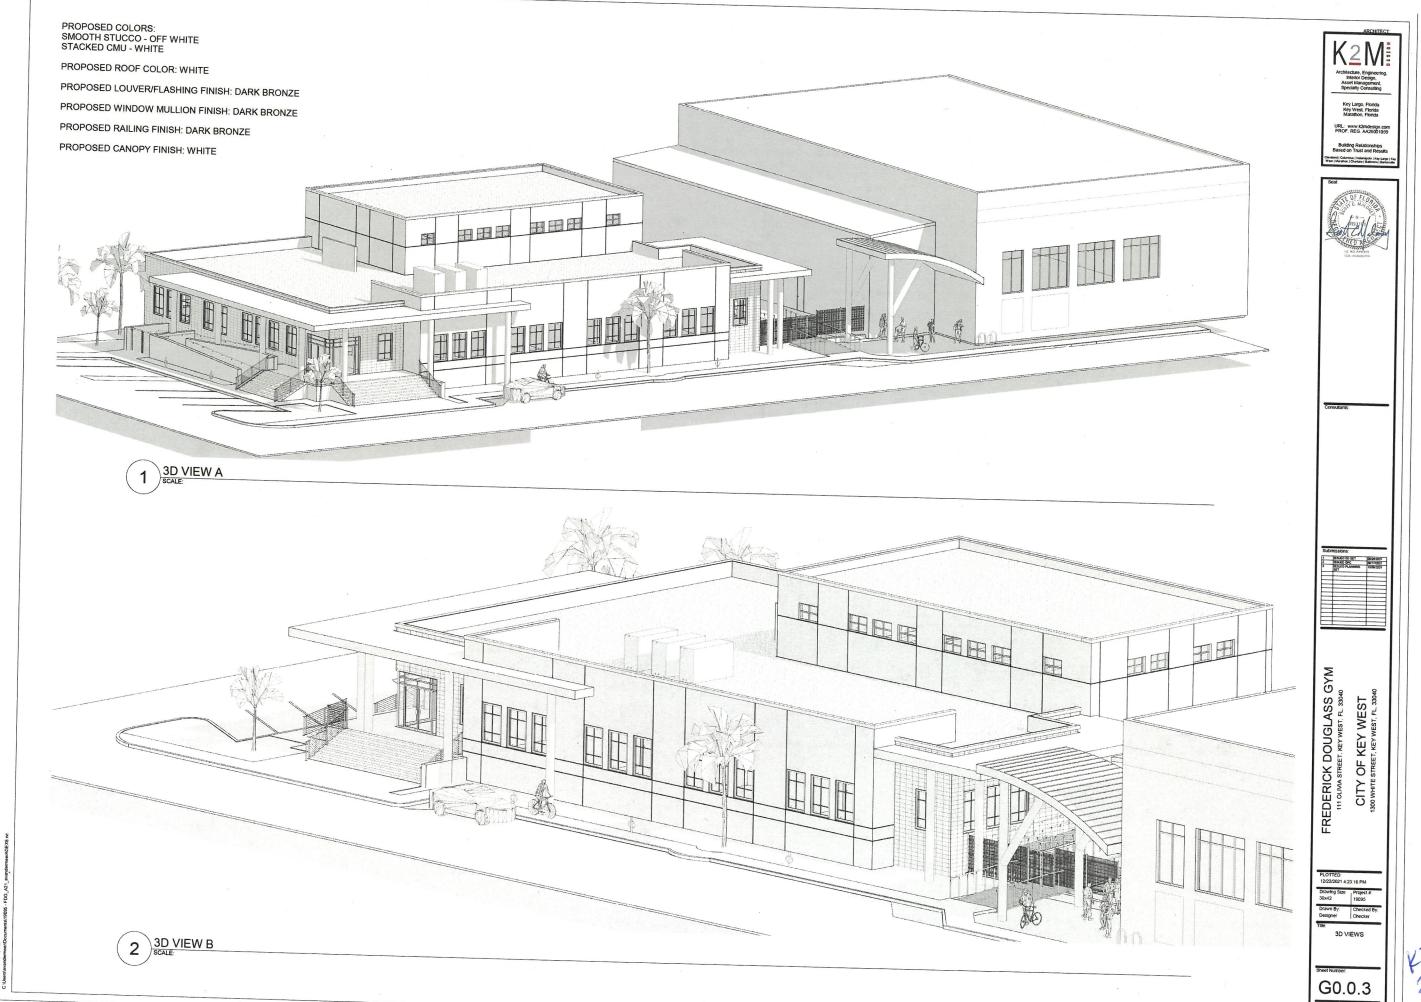


KSH 2022

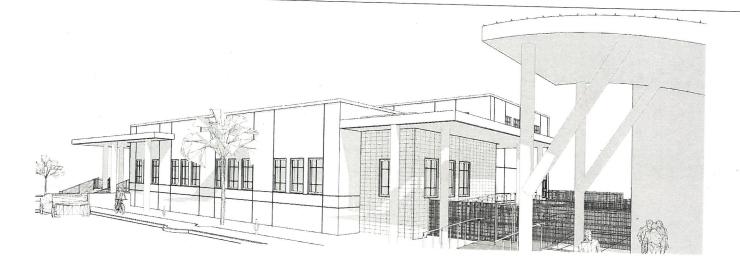

3 COURTYARD ENTRANCE VIEW



FRONT ENTRANCE VIEW

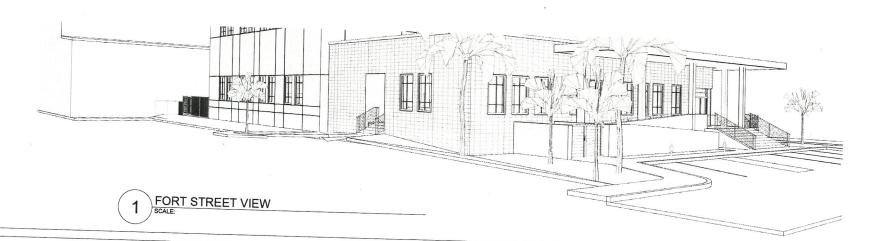

Architecture, Engineering, Inferior Design, Asset Management, Specially Consulting Key Largo, Florida Key West, Florida Marathon, Florida URL: www.k2mdesign.com PROF. REG. AA26001059





FREDERICK DOUGLASS GYM
111 OLIMA STREET, KEYWEST, FL. 33040
CITY OF KEY WEST
1300 WHITE STREET, KEY WEST

PLOTTED: 12/22/2021 4:23:25 PM

Drawing Size 930x42 Project #: 19095

Drawin By: Checked By: VAM DA

3D VIEWS

G0.0.4

EXTERIOR MATERIAL CONCEPT



METAL CANOPY EXAMPLE



METAL CANOPY EXAMPLE



STUCCO FINISH OVER CMU - STACK BOND PATTERN



STUCCO FINISH - WHITE



STUCCO FINISH - OFF WHITE


Key Largo, Florida Key West, Florida Marathon, Florida URL: www.k2mdesign.com PROF. REG. AA26001059



FREDERICK DOUGLASS GYM
111 OLIMA STREET, KEYWEST, FL, 33040
CITY OF KEY WEST
1300 WHITE STREET, KEY WEST

PLOTTED:
12/22/2021 4 23:26 PM
Drawing Size
30x42
Drawn By:
Checked By:
Designer
Title:
MATERIALS & COLORS

G0.0.5

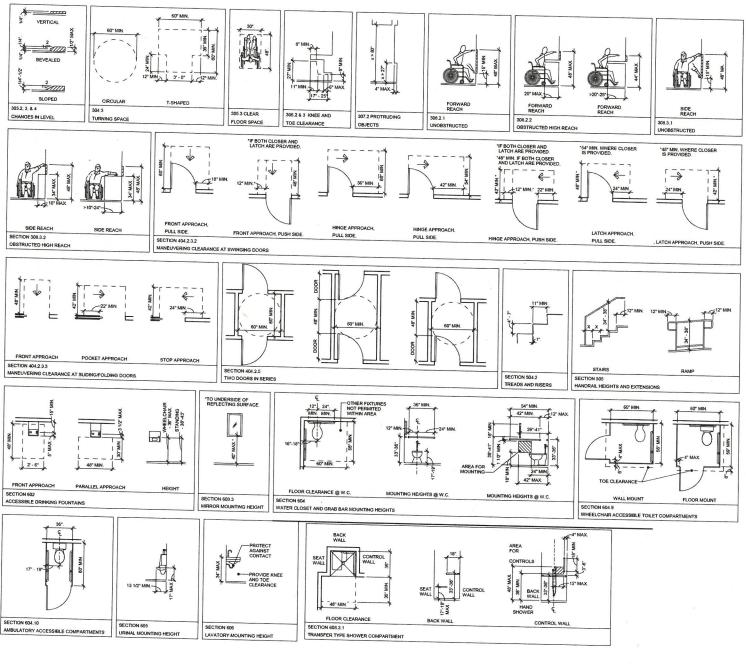



GENERAL NOTIES:

1. THESE DETAILS GOVERN IN THE EVENT OF ANY DISCREPANCIES ELSEWHERE IN THE DRAW
ARCHITECT OF ANY DISCREPANCIES PRIOR TO INSTALLATION. OF ANY ITEMS.

2. INCLUDED DETAILS MAY OR MAY NOT BE USED ON THIS PROJECT.

QUITONAL DC 117.3006 CORE BETERINES.
301.20 VERLY BLUESS ON THEMSES SPECIFIED, CLEAR FLOOR SPACES, CLEARMICS AT PRITURES.
MANELVERING CLEARANCES AT DOORS, AND TURNING SPACES SHALL BE FERRATTED TO ORDING.
302.30 CPRINGS ON FLOOR SURFACES SHALL BE OF A SIZE THE TO DOES NOT FERRAT
302.30 CPRINGS ON FLOOR SURFACES SHALL BE OF AS SIZE THE TO DOES NOT FERRAT
PROPRIESS SHALL BE PLACED SO THAT THE LONG DOMESON IS PERPENDICLAR TO THE PRECIOUS

TOWNING SPACES.

301 TOWNING SPACES

301 TOWNING SPACES

AT AN ELBERT, CLEARANCE AT AN ELBERT, OR A TURNING SPACE, THE SPACE SHALL COMPLY WITH

AT AN ELBERT, CLEARANCE AT AN ELBERT, OR A TURNING SPACE, THE SPACE SHALL COMPLY WITH

307 LANDROCAL CLEARANCE SEPTIOL CLEARANCE SHALL BE 80 NICHES INIMIALM, RALLS OR OTHER

BARRERS SHALL BE PROVIDED WHERE THE PROTICL CLEARANCE SILL BEST THAN 80 NICHES. THE

LEANING EDGE OF SICH BAS OF BRUDEN SEPTIOL CLEARANCE SIL SISS THAN 80 NICHES. THE

OPERABLE PARTIS SHALL BE 6.0 POUNDS MAXIMALINES. I FIRE PACKE HEQUIRED TO ACTIVATE
AUS CLEAR WORTH THE CLEAR WORTH OF AN ACCESSING EQUITE SHALL BE 58 NOHES IMMINIAN
EXCEPTION THE CLEAR WORTH SHALL BE PERINTED TO BE REDUCED TO 20 NOHES IMMINIAN FOR A
EXHIPTION THE CLEAR WORTH SHAVED THE PERIOD RESIDENCES TO 20 NOHES IMMINIAN FOR A
SEGMENTS THAT ARE AN INCESS IMMINIAN BE INCOTTO AND 58 NOHES IMMINIAN IN WORTH
MAY AT THE REMOLDS. IF PROVIDED THE PRESIDENCE AT THE ADDRESS THAT ARE AN INCESS IMMINIAN BE INCOTTO AND 58 NOHES IMMINIAN IN WORTH.

40.2.4 THRESHOLDS IF PROVINCED THRESHOLDS AT DOORWAYS SHALL BE IZE NOT MAXIMUM IN HEIGH RABED THRESHOLDS AND CHANGES IN LEVEL AT DOORWAYS SHALL BE IZE NOT MAXIMUM IN HEIGH SIGN.
 50.3.
 51. EXCEPTION AN EXISTING OR ALTERED THRESHOLD SHALL BE PERMITTED TO BE SIM INCH MAXIMUM IN HEIGHT PROVIDED THAT THE THRESHOLD HAS A BEVIELD EDGE ON EACH SIDE WITH A MAXIMUM ISLOPE OF THE REGIST DOOR AND THE STATE OF THE SHALL BE PERMITTED.

OF 12 FOR THE REGIST EXCEPTION OF MICH.

WHERE SUNING DORS ARE IN THE FULLY OPEN POSITION, OPERATING HARDWARE SHALL BE EMPOSED AND USABLE FROM BOTH SIDES.

4. 40.27.1 DOOR CLOSERS DOOR CLOSERS SHALL BE ADJUSTED SO THAT FROM AN OPEN POSITION OF 90 DEGREES. THE THAT RECURRED TO MOVE THE DOOR TO AN OPEN POSITION OF 12 DEGREES SHALL BE 3 SECONDS IMMANUAL.

 404.25 DOOR-OPENING FORCE: FIRE DOORS SHALL HAVE THE MINIMUM OPENING FORCE ALLOWABLE BY THE APPROPRIATE ADMINISTRATIVE AUTHORITY. THE FORCE FOR PUSHING OR PULLING OPEN DOO OTHER THAN FIRE DOORS SHALL BE AS FOLLOWS.
 INTEROOR HINGED DOORS 40 POUNDS MIXIMUM.

THESE FORCES DO NOT APPLY TO THE FORCE REQUIRED TO RETRACT LATCH BOLTS OR DISENG. OTHER DEVICES THAT HOLD THE DOOR IN A CLOSED POSITION.

12. 405,2 SLOPE, RAMP RUNS SHALL HAVE A RUNNING SLOPE GREATER THAN 1,20 AND NOT STEEPER THAN 1,20 AND NOT STEEPER.

SOLI NOSMOS. THE MODES OF PLOT RAMP RIAKS SHALL NOT BE STEEPER THAN 1 ALL
SOLI ANOSMOS. THE MODES OF PLOT RAMP RIAKS SHALL NOT BE STEEPER THAN 1 ALL
SOLI ANOSMOS. THE MEDICAL PROVIDED THE SUBMOST OF THE MODES OF T

504.51 YISUAL CONTRAST THE LEADING ZI MOJES (51 MM) OF THE TREAD SHALL HAVE YISUAL CONTRAST OF DARKONLUGHT OR LIGHT-CHARAIK FORD THE ERBANDED OF THE TREAD 504.6 FLUSH CONTROLS SHALL BE HAND OPERATED OR AUTOMATIC HAND OPERATED RUGHOCONTROLS SHALL BE HAND OPERATED OR AUTOMATIC HAND OPERATED AUTOMATIC HAND OPERATED AUTOMATIC HAND CONTROLS SHALL BE CONTROLS SHALL SHAL

MINIMALM THE DOOR SHALL BE SELF-CLOSING, A DOOR I FALL COMMINIOR THAT INTO SHALL BE 42 NOH BEF FALED ON BOTH SIZES OF THE DOOR HEAR THE LICHLY TOTALE TO COMPATHENITY THE ECTION AND SONG NOT THE RECURRED IMMINIMA MEAL OF THE COMPATHENITY. SHE FOR THE PROPERTY OF THE PR

GALS GRAB BARS, GRAB BARS, GRAB BARS SHALL COMEY WITH SECTION 605 SIDE WALL GRAB BARS COMEY WITH SECTION 605 \$1 LOCATED ON THE WALL COSEST TO THE WITE CLOSET, AND A REAR WALL GRAB BAR COMEY WIS WITH SECTION 604.52 SHALL BE PROVIDED ON 10.5 DOORS, TO CHEFT COMPARTMENT DOORS, NALUDING DOOR HARDWARE, SHALL COMEY WITH SECTION 404, EXCEPT IF THE APPROACH IS TO THE LATCH SIDE OF THE COMPARTMENT DOOR THE CLEARANCE BETWEEN HE DOOR SIDE OF THE COMPARTMENT DOOR THE

SWING PHTO THE RESIGNER SECTION SHALL COME THE ALTHOLOGOPARTHERN TOORS SHALL COME TO COMPARISHED.

68-10 AG THOLOGOPARTHERN COMPARISHED.

68-10 AG THOLOGOPARTHERN COMPARISHED.

68-10 AG THOLOGOPARTHERN COMPARISHED COMPARISHED COMPARISHED COMPARISHED.

69-10 AG THOLOGOPARTHERN COMPARISHED COMPA

20 507.6 HAND SHOWER A HAND SHOWER WITH A HOSE SO INCHES IMMIUM IN LENGTH. THAT CAME ISBN 36 SONTH A FREE SHOWER HEAD AND 14.4 HAND SHOWER, CHALL BE FROVICED. THE HAND SHOWER SHALL HAVE A CONTROL WITH A HOMPOSTIME. SHAP CAPE THAT WE WHERE PROVICED. A MUST ALLE HEIGHT HAND SHOWER HOUNTED ON A VETTAL DAY SHALL BE ROTALLED SON SHOWER HOUNTED ON A VETTAL DAY SHALL BE ROTALLED SON SHOWER HOUNTED ON A VETTAL DAY SHALL BE ROTALLED SON. 30.7 NATHURS ENCLOSURES SHOUGSMEES FOR BATHTUS SHALL HOT GOSTIFACT CONTROLS 30.7 NATHURS ENCLOSURES SHOUGSMEES FOR BATHTUS SHALL HOT GOSTIFACT CONTROLS 30.7 NATHURS ENCLOSURES SHOUGSMEES FOR BATHTUS SHALL HOT GOSTIFACT CONTROLS 30.7 NATHURS ENCLOSURES SHOUGSMEES FOR BATHTUS SHALL HOT GOSTIFACT CONTROLS 30.7 NATHURS ENCLOSURES SHOUGSMEES FOR BATHTUS SHALL HOT GOSTIFACT CONTROLS 30.7 NATHURS ENCLOSURES SHOUGSMEES FOR BATHTUS SHALL HOT GOSTIFACT CONTROLS 30.7 NATHURS ENCLOSURES SHOUGSMEES FOR BATHTUS SHALL HOT GOSTIFACT CONTROLS 30.7 NATHURS ENCLOSURES SHOUGSMEES FOR BATHTUS SHALL HOT GOSTIFACT CONTROLS 30.7 NATHURS SHALD SHALL SHOUGHT SHOUGHT SHOUGHT SHALL SHOUGHT SHALL SHOUGHT SHALL SHALL SHOUGHT SHALL SHOUGHT SHALL SHOUGHT SHALL SHOUGHT SHALL SHALL SHOUGHT SHALL SHOUGHT SHALL SHOUGHT SHALL SHOUGHT SHALL SHALL SHOUGHT SHALL SHAL

607.7 BATHTUB ENCLOSURES. ENCLOSURES FOR BATHTUBS SHALL NOT OBSTRUCT CONTROLS. FALCETS, SHOWER AND SPRAY WITHS OR OBSTRUCT TRANSFER FROM WHEELCHAIRS ONTO BATHTUB SEATS OR INTO BATHTUBS. ENCLOSURES ON BATHTUBS SHALL O'T HAVE TRACKS INSTALLED ON THE RIM O'T THE BATHTUB.



| MINIBRAN CLEAR DIMENSION | 46" | MAXIMUM | M

BOUNDARY OF CLEAR FLOOR
SPACE OR MANELVERING
CLEARANCE:
LOCATION ZONE OF ELEMENT,
CONTROL, OR FEATURE.

DIMENSION OF EQUAL TO INI

DIRECTION OF APPROACH.

CENTERLINE.

Archifecture, Engineering, Interior Design, Asset Management, Specialty Consulting

Specialty Consultin

Key Largo, Florida

Key West, Florida

Marathon, Florida

Building Relationships Based on Trust and Results Circulard | Columbus | Indepole | Key Largo | Key Wast | Maration | Charlosse | Baltimore | Bertonule

URL: www.k2mdesign.com PROF. REG. AA26001059



Consultants



FREDERICK DOUGLASS GYM
111 OLIVIA STREET, KEY WEST, FL, 33040
CITY OF KEY WEST
1300WHITE STREET, KEY WEST, FL, 33040

PLOTTED: 1272272021 4 23 228 PM

Drawing Size | Project # 15093


Drawn By: Checked By: EBIEHP | EG


ACCESSIBILITY
GUIDLINES ICC
A117.1-2009


Sheet Number: G0.1.1


Isers/avandemeer/Documents/19095 - FDG_A21_avandemeer/0


2/4/2022

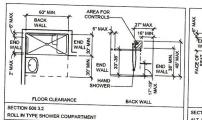

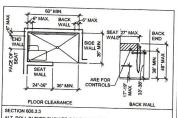

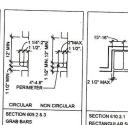

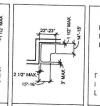

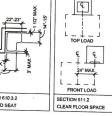

36° MAX TOP LOAD FRONT LOAD SECTION 611.4 HEIGHT OF LAUNDRY EQUIPMENT

NOTES

ADDITIONAL LOCALITATIONS ONCE BEFERENCES (CONTINUED):

JOSÉ SHAN OSEMPER. A HANG SHOWEN WITH A HOSE 99 NOHES MINIMUM IN LEINGTH, THAT CAN BE
USED BOTHA SA FREIZE NOTHEN DAY A HANG SHOWER SHALL BE PROVIDED. THE HANG
SHOWER SHALL HAVE A CONTINUE WORD FORTHE SHAND SHOWER SHALL BE PROVIDED. AN
ADJUSTABLE-HEIGHT HAND SHOWER MALAITED DI A VERTICAL BER SHALL BE NOTALED SO AS TON
OSTRUCT THE USED OF GRAD BASIS.

SYMBOL LEGEND

BOUNDARY OF CLEAR FLOOR
SPACE OR MANEUVERING
CLEARANCE
LOCATION ZONE OF ELEMENT,
CONTROL, OR FEATURE. CENTERLINE

DWELLING UNIT NOTES

SECTION HIGH LIT. 1,300. OUR EPERENCES.

30.5 HAND SOUNDES AND SOUNDES AND SOUNDES MINIMAIN IN LENGTH. THAT CAN BE USED BOTH AS A RODE SHOWER SHALL BE PROVIDED THE HAND SHOWER SHALL BE PROVIDED THE HAND SHOWER SHALL BY PROVIDED THE HAND SHOWER SHALL HAVE A CONTROL WITH A MORNING THE OFF TEXTURE. WHERE PROVIDED, AN ADJUSTABLE-HEIGHT HAND SHOWER MOUNTED ON A VERTICAL BUR SHALL BE SHETCHED SO AS TO NOT OSSITION. THE FORE OFF OR AND BARS.

Architecture, Engineering, Interior Design, Asset Management, Specialty Consulting

Key Largo, Florida Key West, Florida Marathon, Florida

URL: www.k2mdesign.com PROF, REG, AA26001059


Building Relationships Based on Trust and Results nd | Columbus | Indianapolis | Key Largo | K Marathon | Charlote | Baltimore | Bartonid




FREDERICK DOUGLASS GYM CITY OF KEY WEST 1300 WHITE STREET, KEY WEST, FL, 33040

PLOTTED: 12/22/2021 4:23:29 PM ACCESSIBILITY GUIDLINES ICC A117.1-2009

G0.1.2

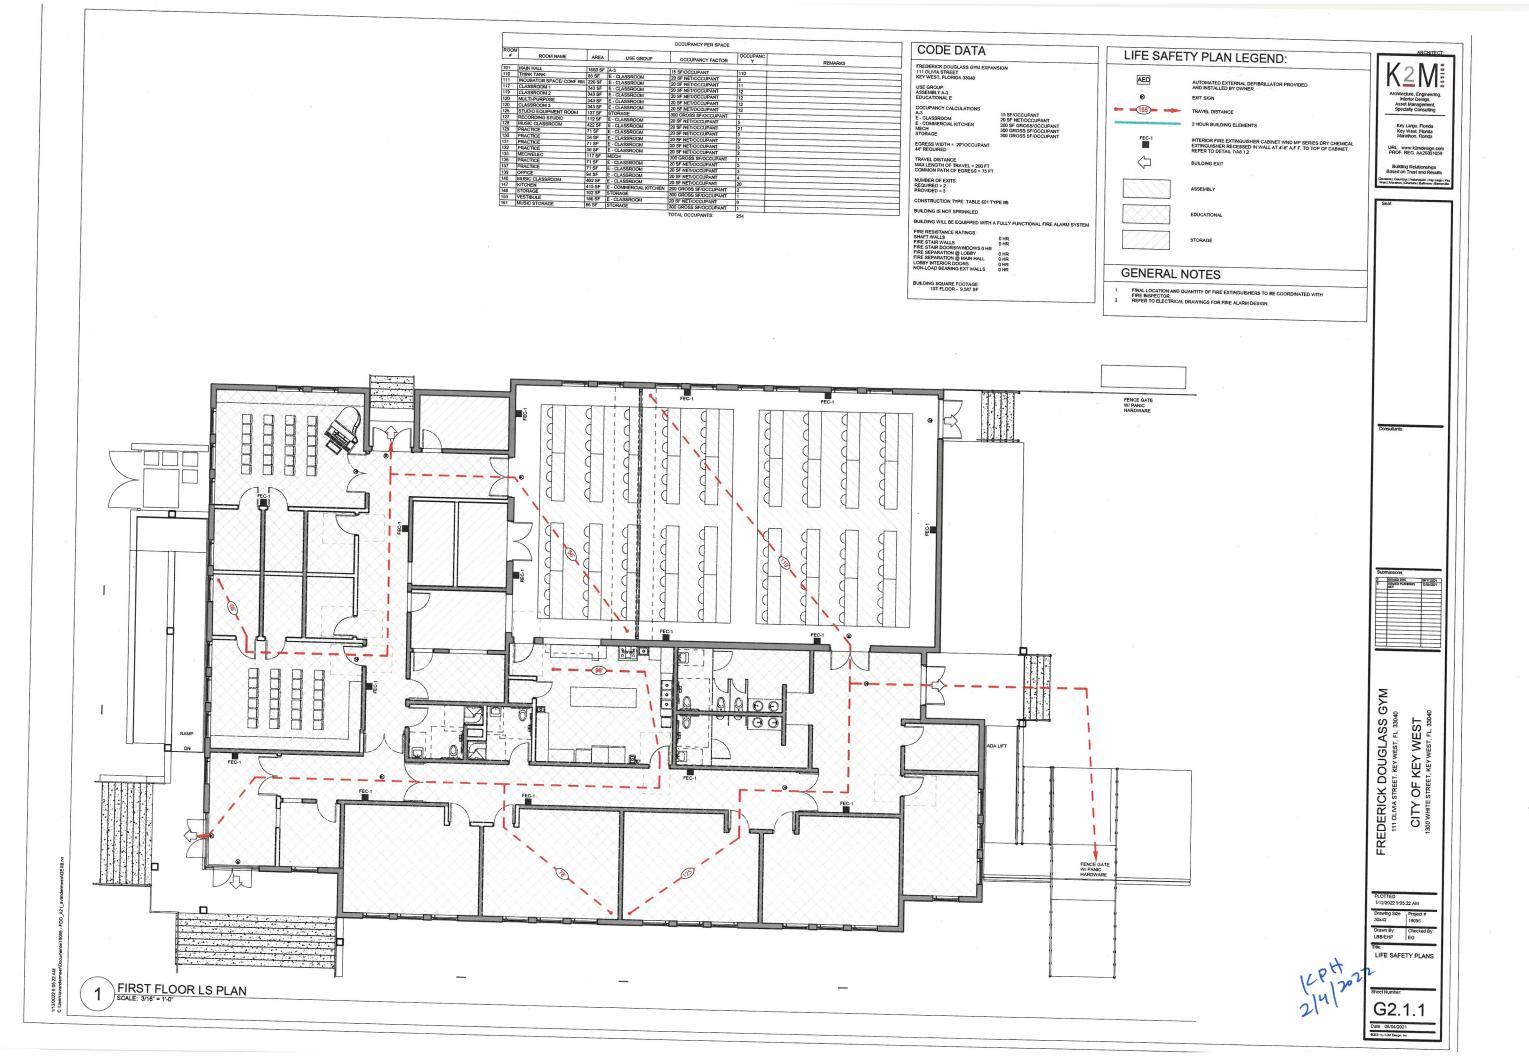

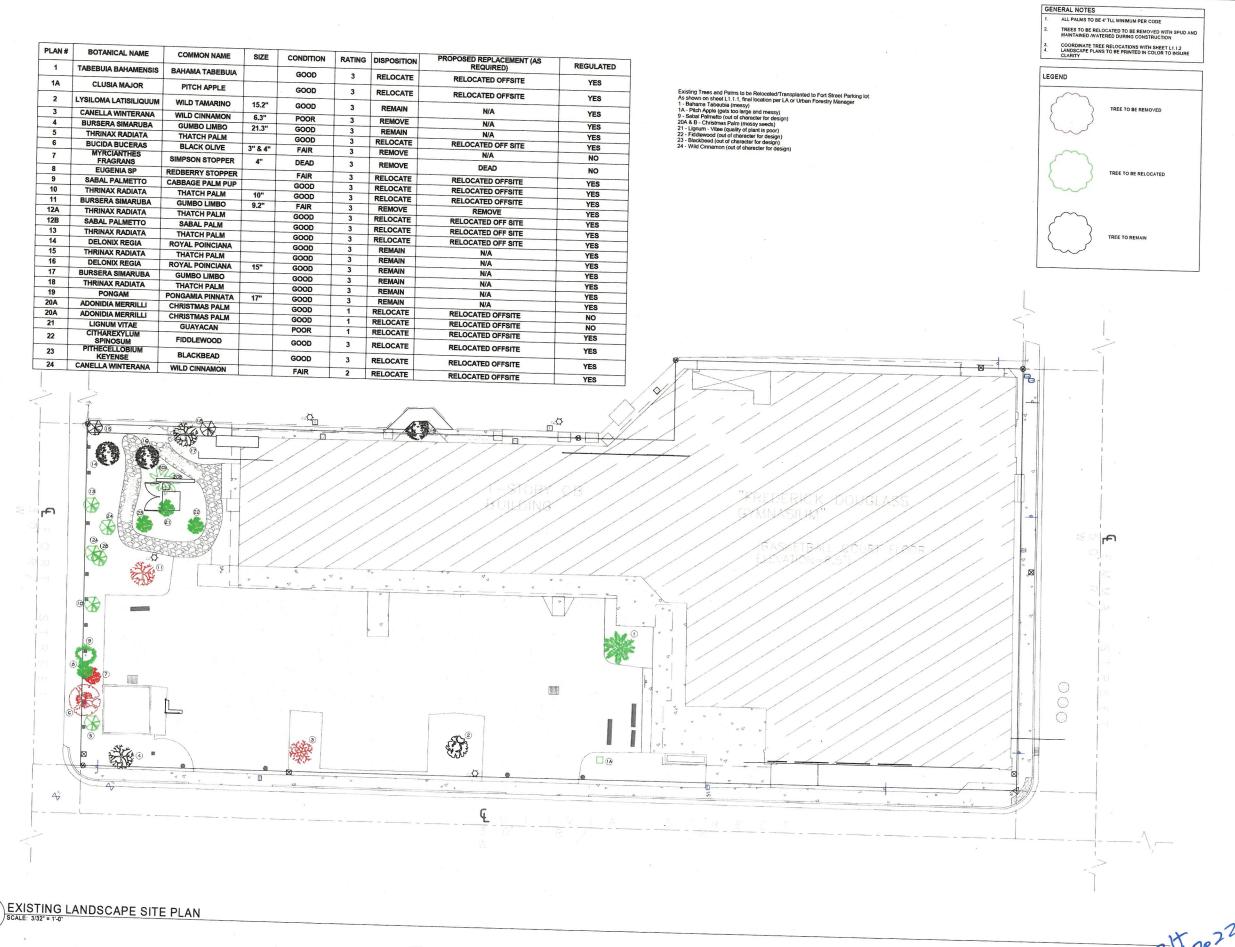

Key Largo, Florida Key West, Florida Marathon, Ftorida

URL: www.k2mdesign.com PROF. REG. AA26001059

Develand | Columbus | Indianapolis | Key Largo | West | Marathon | Chariotte | Battimore | Beston



I ISSUED SO SET IMPROVED SSUED DRC INVESTIGATI

FREDERICK DOUGLASS GYM CITY OF KEY WEST

PLOTTED: 11/16/2021 12:47:25 PM Drawn By: Checked B LBB/EHP EG

EXISTING LANDSCAPE PLAN

Required Landscape Calculations for Frederick Pouglas Gym, City of Key West. 111 Olivia Street, Key West, Florida: Subject properly zoninge (HNC-3) (Sept. 21, 2021) Nev. Jan. 7, 2021

subject, property suring "united to represent the initinally required indiscape per code for planning approval. The interlated transcape may exceed all landscape regularization of the communities character and property of the communities character and the communities of the coveral affect is maken to registate a naturally countring arrangements of native trees an attribute and other non retainer plannings. FOON of proposed planns are native, with resolve and other non retainer plannings are proposed by transcape and the resolution of the communities of all magnitude proposed by transch will be included in the required landscape areas of all resolutions of the communities of the communitie

(15)

D

2

本於於本本

なりな

5- Sea Lavender 15-20" oa., 3g.

15= Existing Thatch Palm #15 (typical)

(7) (B)

Provided: 4 existing Trees,, 1 existing palms = 53 Landecape Units exist 156 new landscape units required. - 244 Units provided

6 - 12" rall min. Krugidardron farram, Black homood s60 uribs 2- 12" pt. 15. Eugens frontoas- Radberry Scopper 20 uribs 30- 24" pt. 15. Eugens frontoas- Radberry Scopper 20 uribs 35- 24", 3 (callior) kg/lby 35" cut pt. 15. Eugens 72- 12", 1,9 (callior) Kg/lby 35" cut pt. 15. Eugens 73- 12", 3 (callior) kg/lby 35" cut pt. 15. Eugens 25" c Total: 232 Units.

Shrubs
Required:
Provided:
30 - 24" native Shrubs will be planted, 1- 6' native Palm
Locuetberry- Byreonima lucida

1- Jamaican Caper, 6' oa.

5- Key Thatch Palm, 6' oa. 1- Black Ironwood Tree, 12' oa.

17- Key Lilly, 3g.

1- Black Ironwood Tree, 12' oa.

Non Vehicular use areas: Carppy Trees Required: Less than 30% and less than 2,000 s.f. Nos. s 4 trees Provided: 1 Existing tree and 3 – 12' tall min. Recherry Scopper

Locustberry- Byrsonima lucida 6' Capparis cynophallophora, 6' oa.

Required Landscape Plant List for Frederick Douglas Gym, City of Key West. 111 Olivia Street, Key West, Florida:

6 - Kruglodendron Ferreum , Black Ironwood, 12-13' oa., 45 gallon.
7 Thrinax moriseli, Key Thatich Palm., 6' oa., bab
8 Eugenia rhombea. Reoberry Skopper, 12-13' oa., 45 gallon
9 Capparis orinopia-opinora. Jan., 45 gallon
9 Capparis orinopia-opinora. Januaris Capper, 6' pa. 45 gallon
10 Capparis orinopia-opinora. Januaris Capper, 6' pa. 45 gallon
10 Capparis orinopia-opinora. Januaris Capper, 6' pa. 45 gallon
10 Capparis orinopia-opinora. Januaris Capper, 10-24", 3-gallon
10 Capparis orinopia-opinora. Januaris Capparis Opinopia-opinopia-

(19)

10- Locustberry, 3g.

Eng.

Existing Trees and Palms to relocated/Transplanted to Fort Street Parking Existing Trees and Palme to relocated/Transplanted to Fort Screet Parking lot:
As shown on elset L.1.1 first location per LA or Urban Forestry Manager
1- Balliama Tibbe.bis (messy)
1- Pritch Apple (gets to large and messy)
1- Pritch Apple (gets to large and messy)
1- Pritch Apple (gets to large and messy)
1- Pathon Path (passing)
1- Recharty Path (phasing)
12- Thatch Path (phasing)
12- Thatch Path (phasing)
12- Thatch Path (phasing)
12- Thatch Path (phasing)
12- Assert Pathon (phasing)
12- Asser

Generator Paved Seating Area 20- Golden 1- Black Ironwood Tree, 12' oa, Creeper, 1g. , 12- Key Thatich Palm , 6' oa. align with windows) 2- Redberry Stopper Trees 12' oa. (align between windows) 23 _3- Key Thatch Palm , 6' oa. 18'

20- Golden Dewarop 3g.

Key Largo, Florida Key West, Florida Marathon, Florida URL: www.k2mdesign.com PROF, REG, AA26001059 Building Relationships Based on Trust and Result



890-00 SD SET 9809-2021 890-00 DRC 981/7-2021 11/5/21 11/16/21 1/3/22 1/7/22

FREDERICK DOUGLASS GYM CITY OF KEY WEST 300 WHITE STREET, KEY WEST. FL, 33040

PLOTTED: 12/15/2021 2:36:25 PM Drawing Size Project #: 30x42 19095 Drawn By: Checked By: Designer Checker REQUIRED LANDSCAPE PLAN

L1.1.2 Date: 12/9/21 02021 by KSM Design, frc.


SITE PLAN - LANDSCAPE PLAN

1- Black Ironwood Tree, 12' oa.



35- Key Lilly, 3g.



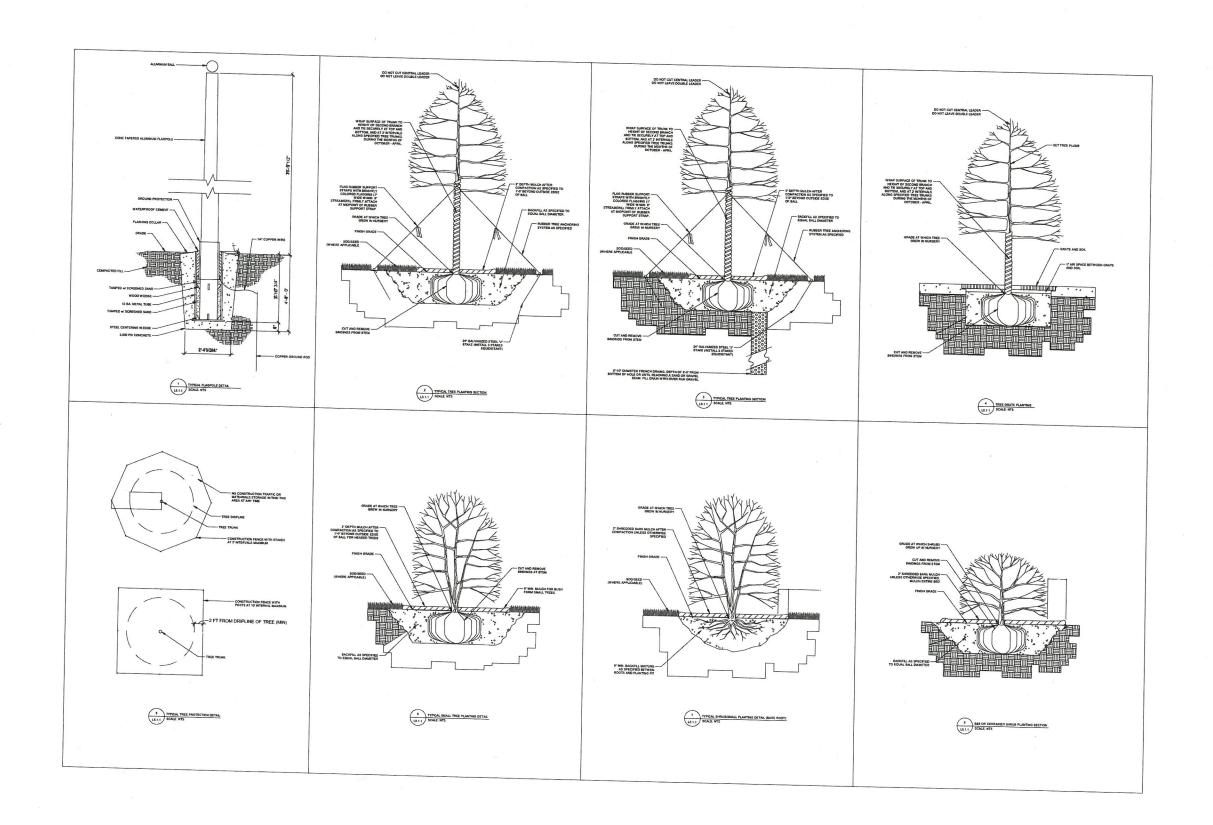


Architecture, Engineering, Interior Design, Asset Management, Specialty Consulting Key Largo, Florida Key West, Florida Marathon, Florida URL: www.k2mdesign.com PROF. REG. AA26001059





FREDERICK DOUGLASS GYM CITY OF KEY WEST

L5.1.1

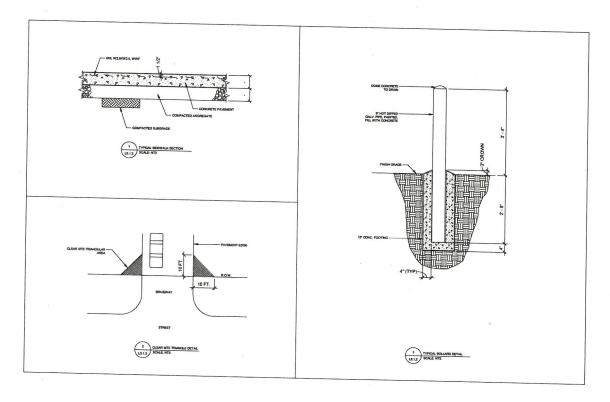






1 ISSUED SD SET 06/26/2021 2 ISSUED DRC 06/17/2021

FREDERICK DOUGLASS GYM
111 OLIMA STREET, REY WEST
CITY OF KEY WEST
1300 WHITE STREET, REY WEST

LANDSCAPE/SITE DETAILS

L5.1.2

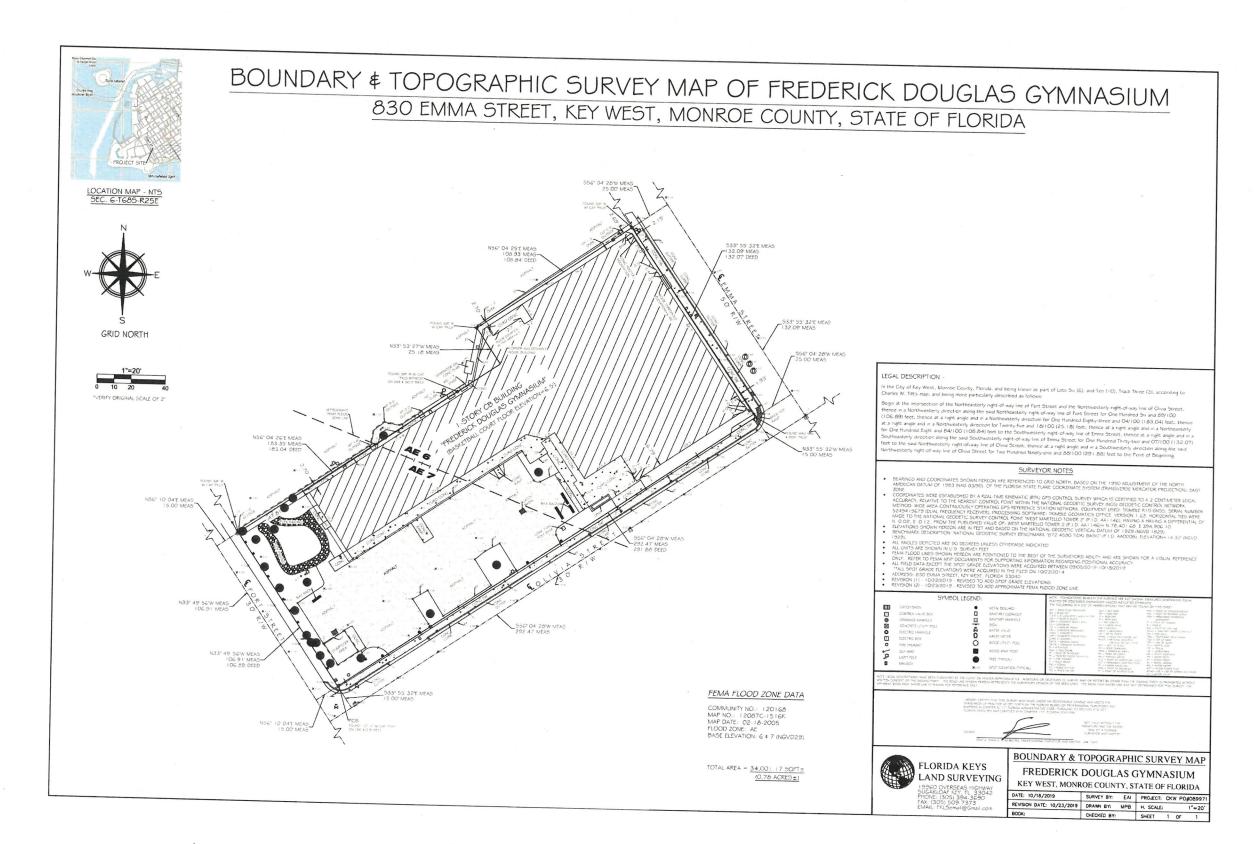

Architecture, Engineering, Interior Deelgyn, Asset Management, Specially Consulting Special Sp



Consultants

Submissions:

J. Bebald pac.

3. SSAIG FLANNING GENT ALL STAIN STA

FREDERICK DOUGLASS GYM
111 OLIVIA STREET, KEY WEST, FL, 33040
CITY OF KEY WEST
1300 WHITE STREET, KEY WEST, FL, 33040

PLOTTED: 12/22/2021 4.23:33 PM Drawing Size Project #: 30x42 19095 Drawn By: Checked By: LBB/EHP EG

SITE SURVEY

V1.1.1

12/22/2021 4:23:33 PM C.Uberstavandemean/Documental10006, EDC 421 av

Engineering, Inc. 5783 BAYSHORE RD., SUITE 113 NORTH FT. MYERS, FL 33917 PH. 239-205-6473 WEBSITE: WWW.CW-3.COM Project Name: FREDERICK **DOUGLASS** GYM FOUND 3/8" IR W/ CAP "FKLS" EXPANSION FOUND 3/8" IR W/ CAP "FKLS" -EXISTING A/C PADS, CONC. SW & MISC. CONC (TYP) FOUND 3/8" IR W/ CAP "FALS" (TO REMAIN) Project Address: 830 EMMA STREET CONC FOOTER / FOUNDATION KEY WEST, FL 33040 Client/Owner: CITY OF KEY WEST 1300 WHITE STREET KEY WEST, FL 33040 EXISTING TREES (TYP) CONC GUTTER (TO BE REMOVED/RELOCATED SEE LANDSCAPE PLANS) EXISTING BUILDING EXISTING BUILDING — DOOR THRESHOLD ELEVATION=6.48 Engineer Contact: (TO BE REMOVED) (TO REMAIN) CLAIR WRIGHT, III, P.E. PROJECT MANAGER PHONE: 239-205-6473 EMAIL: CWRIGHT@CW-3.COM EXISTING LIGHT POLE EXISTING CONC. I-STORY CB BUILDING
"FREDERICK DOUGLAS GYMNASIUM"
(BASKETBALL COURT FLOOR ELEVATIONS) (TO BE REMOVED) (TO BE REMOVED) Project Engineer:
THIS ITEM HAS BEEN DIGITALLY SIGNED AND SEALED BY EXISTING COVERED CONC. EXISTING PAVEMENT EXISTING CONC. SW (TO BE REMOVED) 30['] (TO BE REMOVED) (TO BE REMOVED) 0 16 CVRD CONC AT GRADE CONC. SW EXISTING BIKE RACK (TO BE REMOVED) N THE DATE ADJACENT TO THE SEAL (TO BE REMOVED) EXISTING SIDEWALK EXISTING STORM STRUCTURE -(TO REMAIN) EXISTING STORM STRUCTURE AND STORM PIPE AND STORM PIPE EXISTING WOOD BOLLARDS (TYP) (TO BE REMOVED) (TO BE REMOVED) (TO BE REMOVED) EXISTING ASPHALT egal Disclaimer: (JO BE REMOVED) EXISTING DUMPSTER AREA EXISTING FIRE HYDRANT EXISTING BIKE RACKS (TO REMAIN) EXISTING TREE (TO BE REMOVED) (TO REMAIN) EXISTING CONC. (TO REMAIN) EXISTING LIGHT POLE -EXISTING SIDEWALK -EXISTING FLAG POLE BASE (TO BE REMOVED) OLIVIA STREET (TO BE REMOVED) EXISTING LIGHT POLE (TO BE REMOVED) 30' R/W FOUND MAG NA & DISK "FKLS" (TO BE REMOVED) EXISTING BOLLARDS SITE DATA: EXISTING SIDEWALK & DROP CURB EXISTING BOLLARDS SITE DATA:

RE # 00014720-000000

SECTIVE-RISE 106-68-25

PROJECT # 19-0031

FILE NAME 101-9-0031-DEMO.DWG

ORIGIN DATE 10-22-013-DEMO.DWG

CADO ESIGNER 1/MP

CADO ESIGNER 1/MP

LADO ESIGNER 1/MP


PLOTT DATE 10: 12-9-2021-3-40 PM


PLOTTED BY : JPANICARO


PLOTTED BY : JPANICARO


FLOTTED BY : JP (TO BE REMOVED) (TO BE REMOVED) (TO BE REMOVED) EXISTING SANITARY CLEANOUT EXISTING SIDEWALK & DROP CURB (TO BE RESET) (TO BE REMOVED) SHEET TITLE: EXISTING CONDITIONS SHEET NO. 01 2021.12.09 -

PLANNING SUBMITTAL

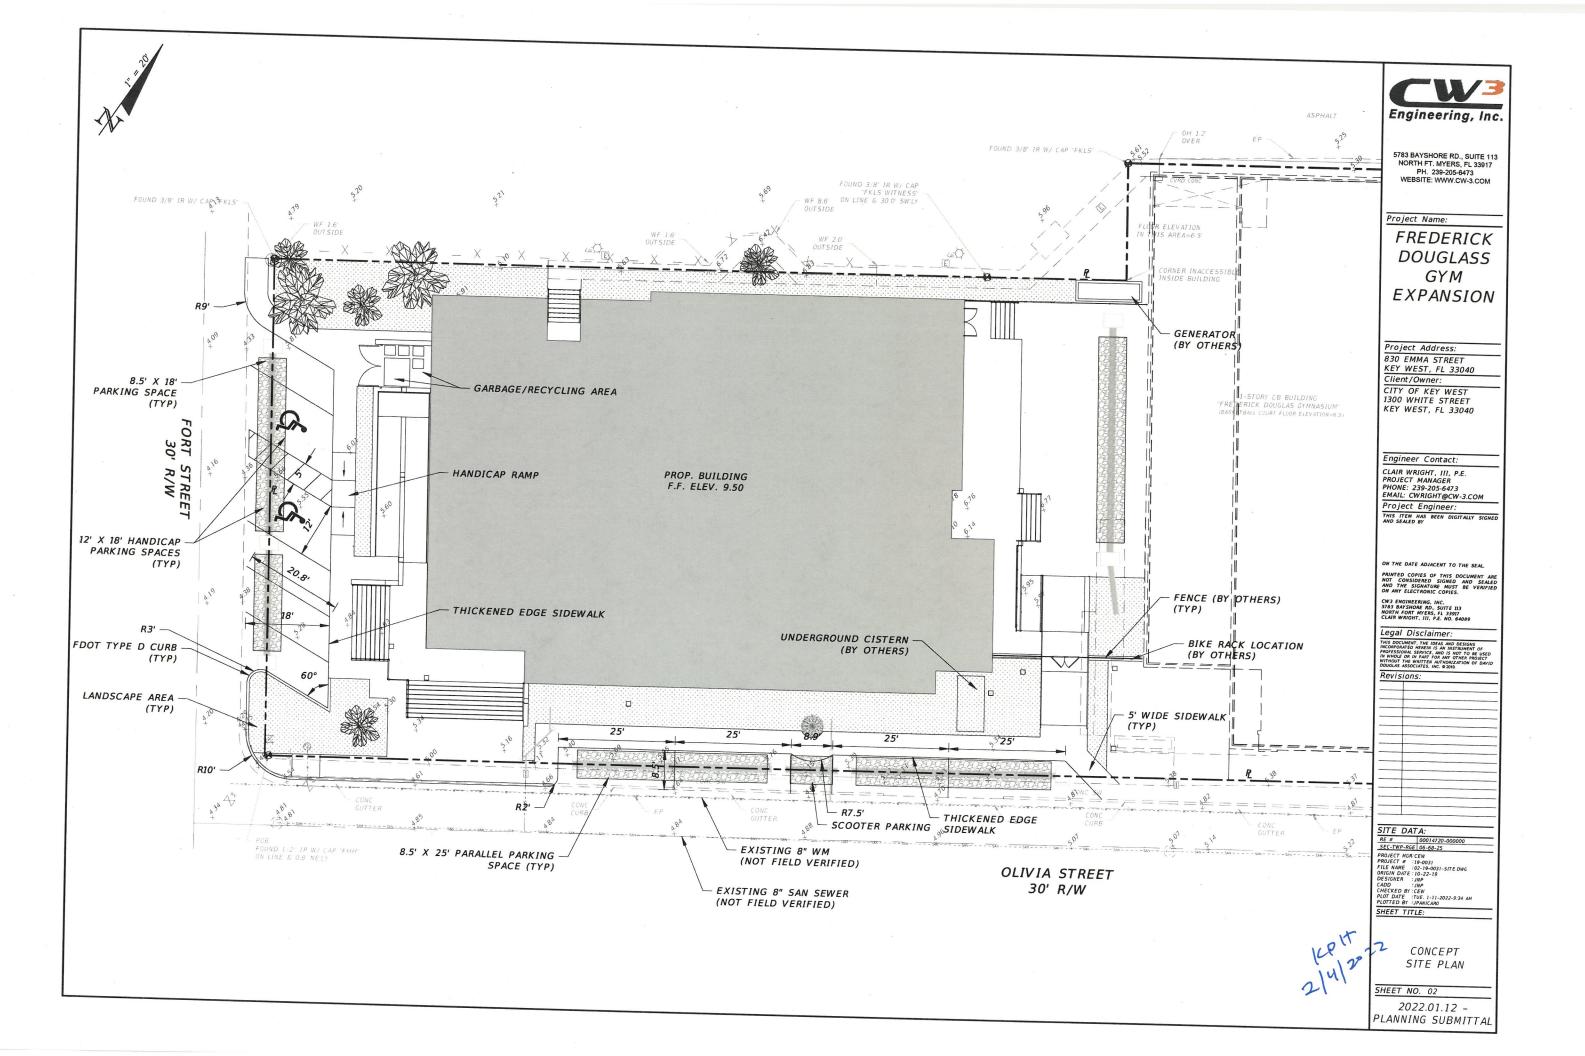

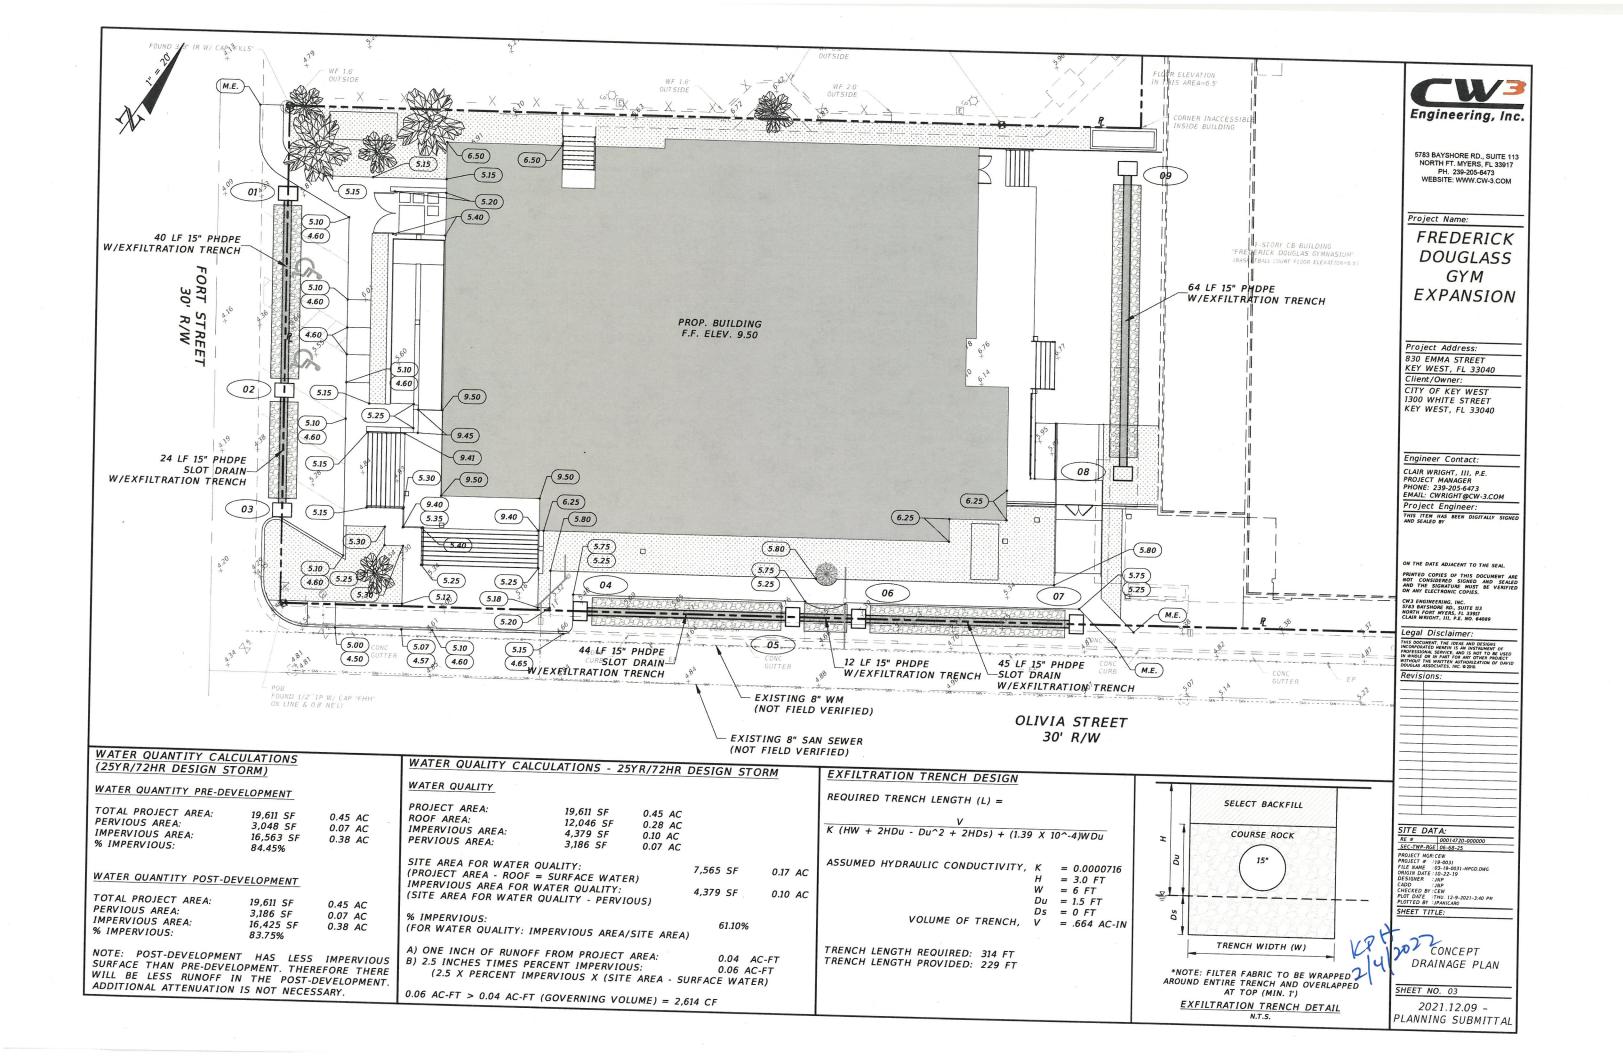

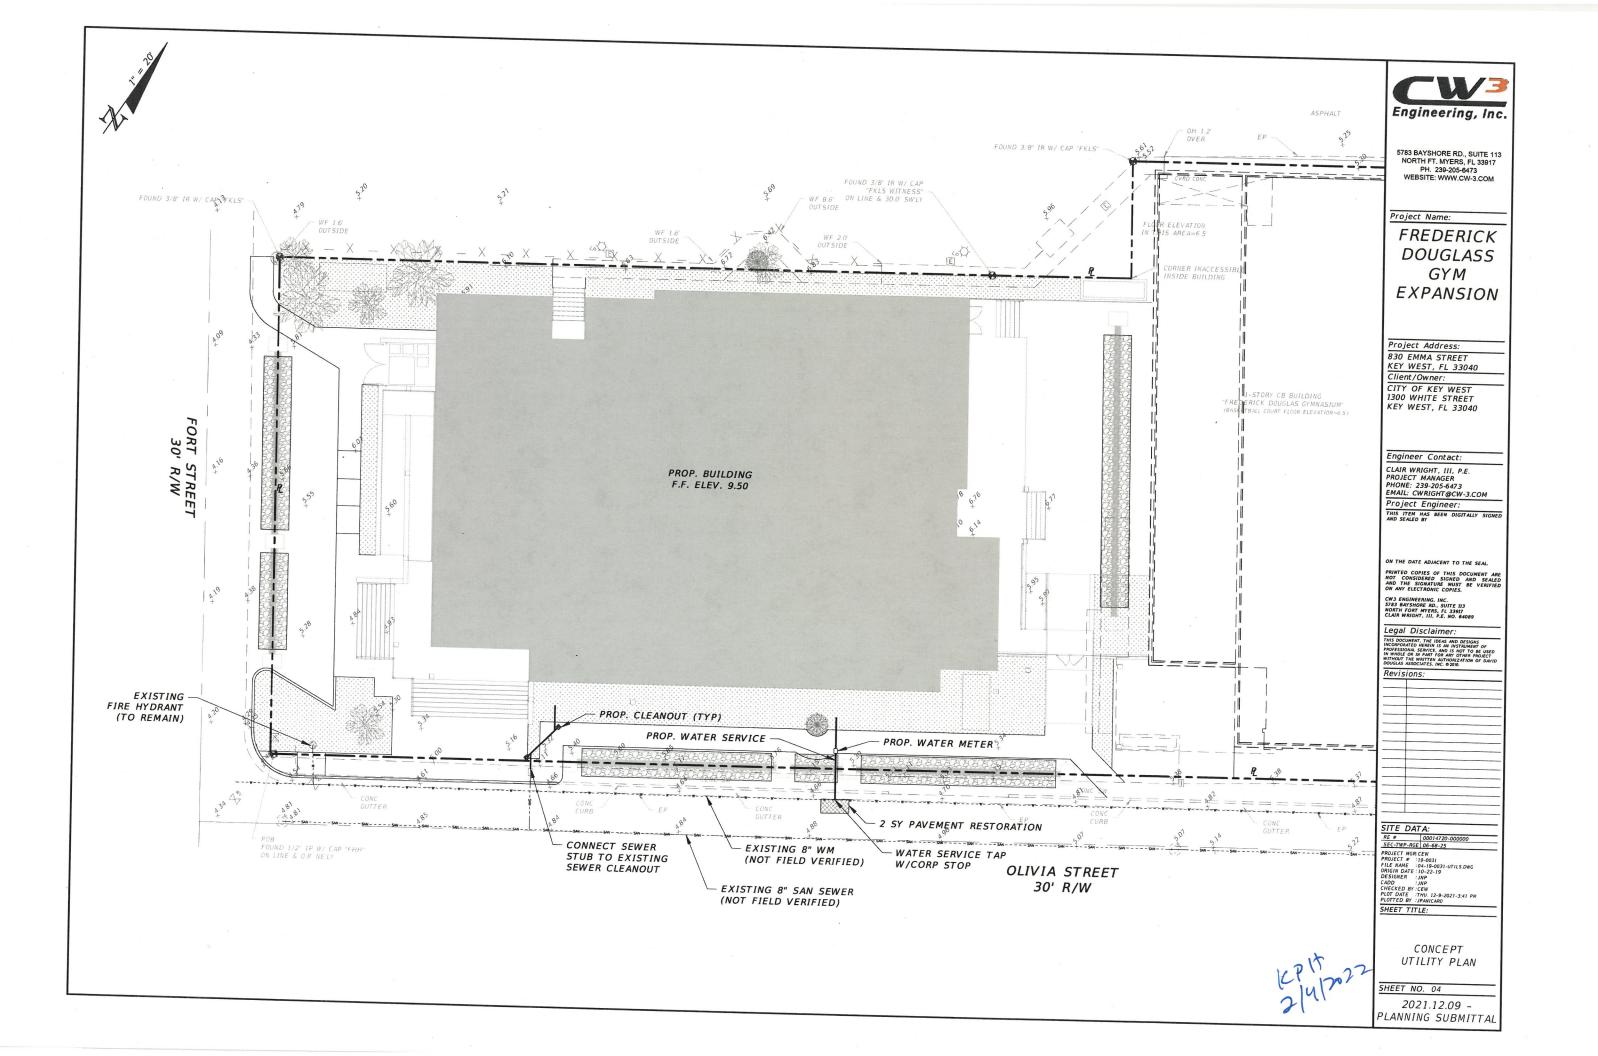

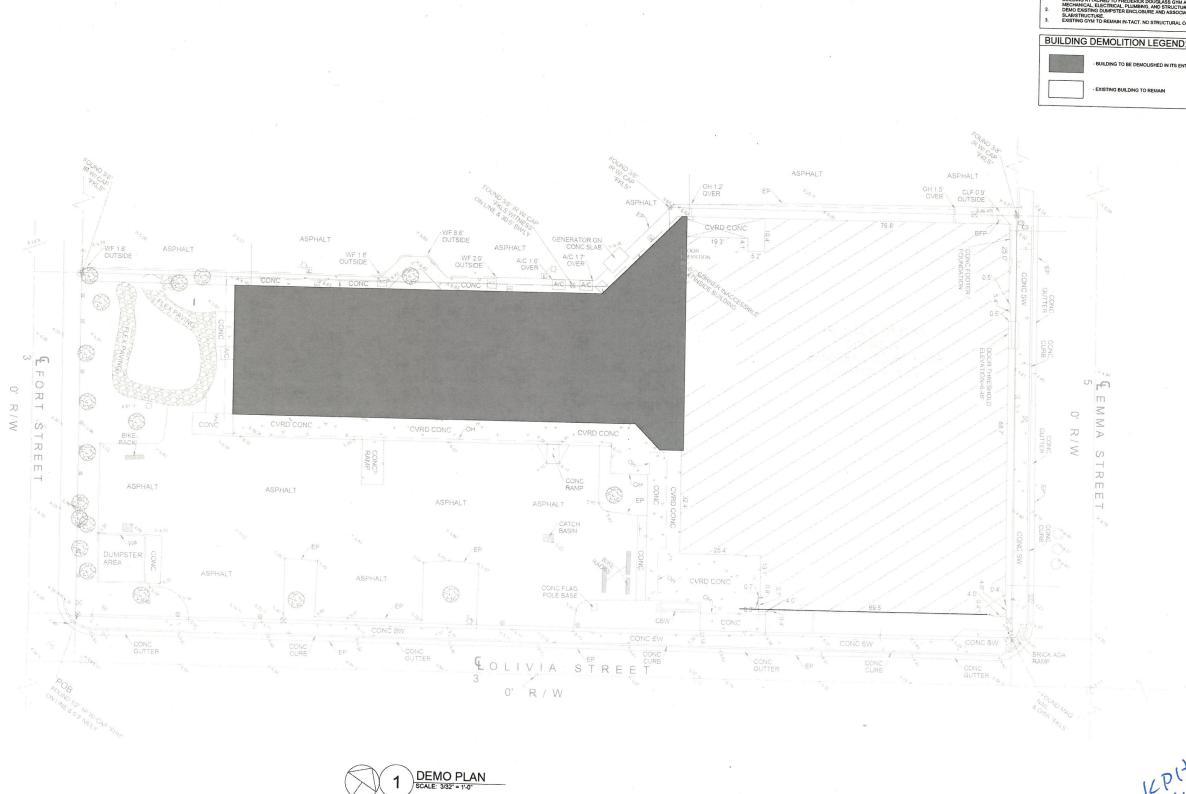


Architecture, Engineering, Interior Design, Asset Management, Specialty Consulting

Key Largo, Florida Key West, Florida Marathon, Florida URL: www.k2mdesign.com PROF. REG. AA26001059 Building Relationships Based on Trust and Results Cleveland [Columbus | Indianapole | Key Largo | K West | Marathon | Charlote | Battonor | Bentond

FREDERICK DOUGLASS GYM CITY OF KEY WEST 1300 WHITE STREET, KEY WEST, FL, 33040

DEMOLITION SITE PLAN/FLOOR PLAN

AD1.1.1

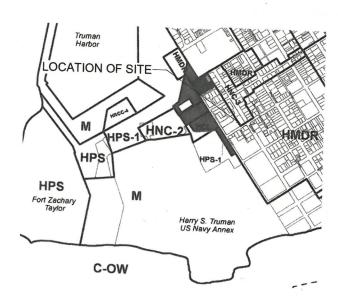

VICINITY MAP W/ LAND USE

	SITE DATA TABLE							
		CODE REQUIREMENT	CODE REQUIRED SQ. FT.	EXISTING SITE	EXISTING SITE SQ. FT.	PROPOSED	PROPOSED SQ.	VARIANC
	Zoning	HNC-3			•			REQUEST
	Flood Zone	AE 7						
	Size of Site	34,000 SF (Min. 4,000 SF)		24 000 05				
	Height	30'-0"		34,000 SF 30'-0"				
	Front Setback	None				30'-0"		N/A
	Side Setback	5'-0"		None 5'-0"		7'-9"		N/A
	Side Setback	5'-0"				0'-0"		N/A
	Street Side Setback	7'-6"		5'-0"		5'-0"		N/A
	Rear Setback	15'-0"		7'-6"		18'-0"		N/A
	Residential Floor Area	N/A	-	0'-0"		5'-0"		YES
	Density	16 du/acre		N/A		N/A		N/A
	F.A.R. (Commercial)	1		0		N/A		N/A
_	Building Coverage	40%	13,600	0		0		N/A
	Impervious Surface	60%	20,400	62%	20,924	71%	24,193	YES
	Parking	27	20,400	89%	30,361	85%	28,812	YES
		0		19		10		N/A
	Handicap Parking**	3				/		1
	Bicycle Parking	35%		2		2		N/A
		0		8		21		N/A
	Open Space/Landscaping	20%	6,800 SF	/		/		1
	Number & Type of Units	N/A	0,800 SF	11%	3,639 SF	15%	5,189	YES
	Consumption Area or Number of			N/A		N/A		N/A
	Seats	N/A		N/A		N/A		N/A
	**up to 25 - 1							
1	7	HNC-3 and HMDR***						

	Breakdowns	(SF)				
Existing Developments						
Lot Area		Our Site	Total Existing			
Existing Coverages		34,001.17	34,001.1			
Asphalt/Concrete	Parking St.		0.,002.1			
- Principle	Parking Side	8,703				
	Side AC/Conc	39				
	Flex Pavers	525				
	Sidewalks on Back	22				
Buildings	Sidewalks on Front/Side	148				
Buildings	Buildings	20,644				
	Dumpster	280	See			
		200	Building/Lot			
			Coverages			
			Below			
Impervious Surface		30,361				
Impervious Surface %			30,361			
Building Coverage		89%	89%			
Building Coverage %		20,924	20,924			
Open Space		62%	62%			
Open Space %		3,640.00	3,640.00			
		11%	11%			
	December 15					
	Proposed Develo	oments				
ot Area						
Coverages		34,001.17				
Asphalt/Parking						
Buildings		1,340				
Pavement		24,193				
		4,619				
mpervious Surface						
mpervious Surface %		28,812				
		85%				
uilding Coverage		24,193				
uilding Coverage %		71%				
pen Space		5,189				
pen Space %		15%				






FREDERICK DOUGLASS GYM
111 OLIMA STREET, KEY WEST
CITY OF KEY WEST
1300 WHITE STREET, KEY WEST

PLOTTED:
1/17/20/21 12/0.41 PM
Drawing Size Project #.
30/42 | 19/95
Drawn By.
LBB/EHP | Checked By.
LBS/ESP | EG

A1.1.0

Date: 08/04/2021

60031 by Kolu Design, Ho.

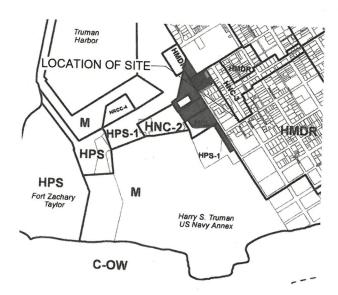

VICINITY MAP	W/ LAND USE
--------------	-------------

		SITE	DATA TABLE				
	CODE REQUIREMENT	CODE REQUIRED SQ. FT.	EXISTING SITE	EXISTING SITE SQ. FT.	PROPOSED	PROPOSED SQ.	VARIANCI
Zoning	HNC-3						REQUEST
Flood Zone	AE 7						
Size of Site	34,000 SF (Min. 4,000 SF)		34,000 SF			and the same of th	
Height	30'-0"		30'-0"			a rate	
Front Setback	None		None		30'-0"	And the second	N/A
Side Setback	5'-0"		5'-0"		7'-9"	a contract of the contract of	N/A
Side Setback	5'-0"				0'-0"		N/A
Street Side Setback	7'-6"		5'-0"		5'-0"		N/A
Rear Setback	15'-0"		7'-6"		18'-0"		N/A
Residential Floor Area	N/A		0'-0"		5'-0"		YES
Density	16 du/acre		N/A		N/A		N/A
A.R. (Commercial)	1		0	and a	N/A		N/A
Building Coverage	40%	13,600 SF	0	- Area	0		N/A
mpervious Surface	60%	20,400 SF	62%	20,924 SF	71%	24,193 SF	YES
Parking	27	20,400 31	89%	30,361 SF	89%	30,361 SF	YES
	0		. 19	•	10		N/A
landicap Parking**	3		1 000		/		1
Bicycle Parking	35%		2		2		N/A
	0		8		21		N/A
Open Space/Landscaping	20%	C 000 07	•		/		/
lumber & Type of Units	N/A	6,800 SF	11%	3,639 SF	11%	3,639 SF	YES
onsumption Area or Number of	-	at see	N/A		N/A		N/A
eats	N/A	Andrew Control of the	N/A		N/A		N/A
		20.00			.,		
*up to 25 - 1	- referen						,
oning of Adjoining Sites	HNC-3 and HMDR***						

	Breakdowns	(SF)	
	Existing Develo	pments	
Lot Area		Our Site	Total Existing
Existing Coverages		34,001.17	34,001.1
Asphalt/Concrete	- Li		- 1,002.12.
- Spridity Concrete	Parking Side	8,703	
	Side AC/Conc	39	
and the same of th	Flex Pavers	525	
are the second	Sidewalks on Back	22	
Buildings	Sidewalks on Front/Side	148	
Duttuliigs	Buildings	20,644	
	Dumpster	280	See
			Building/Lot
			Coverages
Impositore C. I			Below
Impervious Surface		30,361	20.204
Impervious Surface %		89%	30,361
Building Coverage		20,924	
Building Coverage %		62%	20,924
Open Space		3,640.00	62%
Open Space %		11%	3,640.00
		1170	11%
	Proposed Develo	pments	
Lot Area			
Coverages		34,001.17	
Asphalt/Parking			
Buildings		1,340	
Pavement		24.193	
avenient		4,715	
mpervious Surface		30,248	
mpervious Surface %		89%	
Building Coverage			
Building Coverage %		24,193	
pen Space		71%	
pen Space %		3,753	
		11%	

Architecture, Engineering, and Architecture, Engineering, and Asset Management, Specially Consulting

Rey Largo, Florida Management, Specially Consulting

Rey Largo, Florida Marianne, Calenton, Lindau, Harris, Harris



Consultants

FREDERICK DOUGLASS GYM
111 OLIMA STREET. REY WEST
CITY OF KEY WEST
1300 WHITE STREET, REY WEST

PLOTTED: 12/22/2014 22/41 PM

Drawing Size Project #: 300/42 19095

Drawing Size Project #: 19095


Drawing Size Project #: 19095


Title: SITE DATA TABLES


A1.1.0


Date: 08/04/2021


REPLACED-SEE UPDATED SHEET A1.1.0

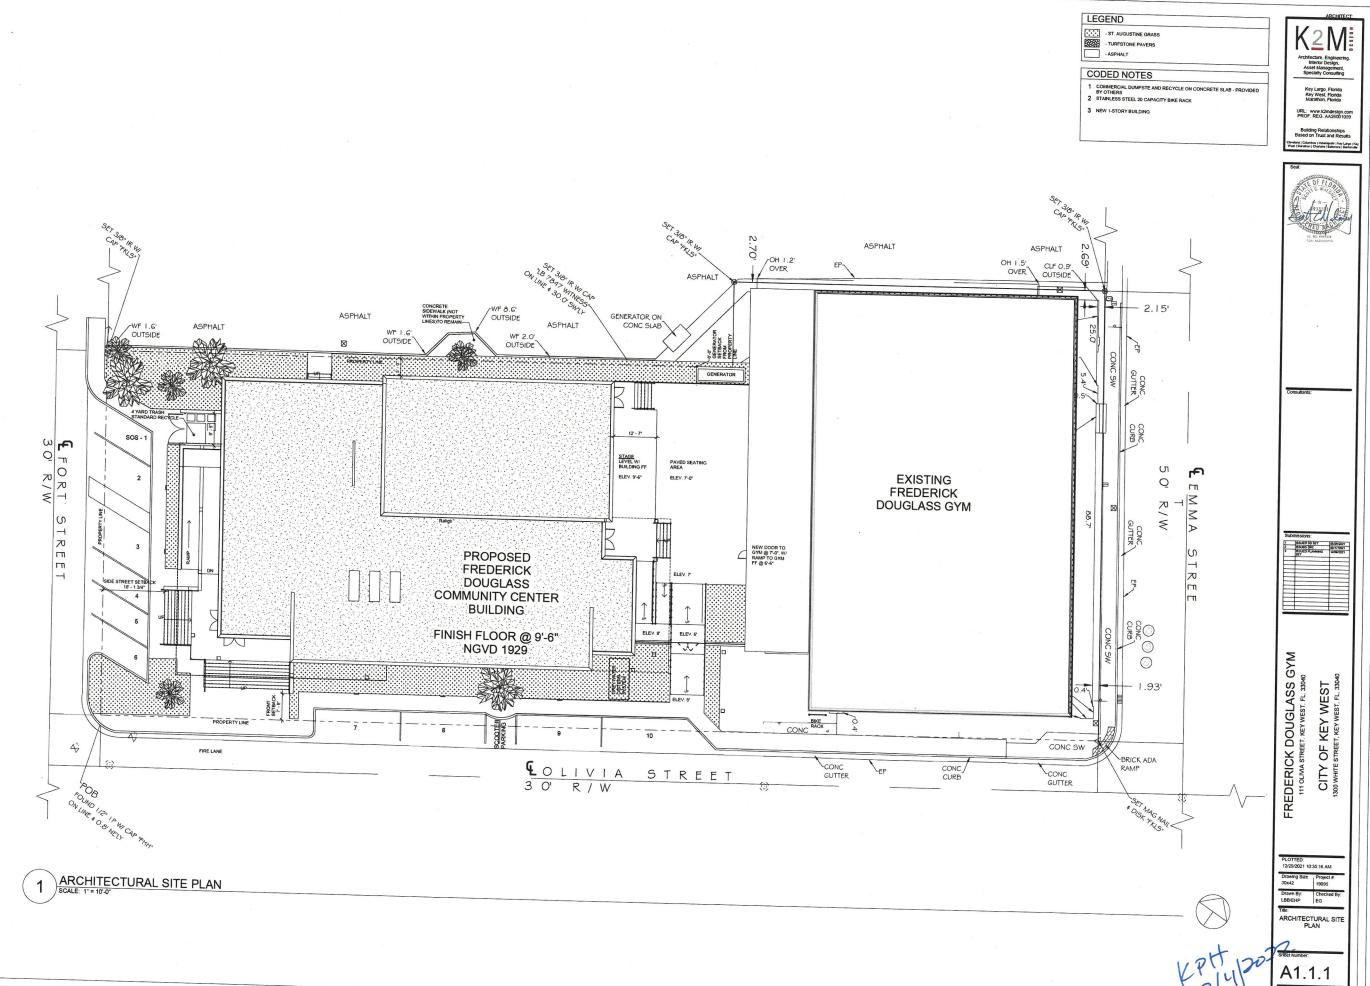


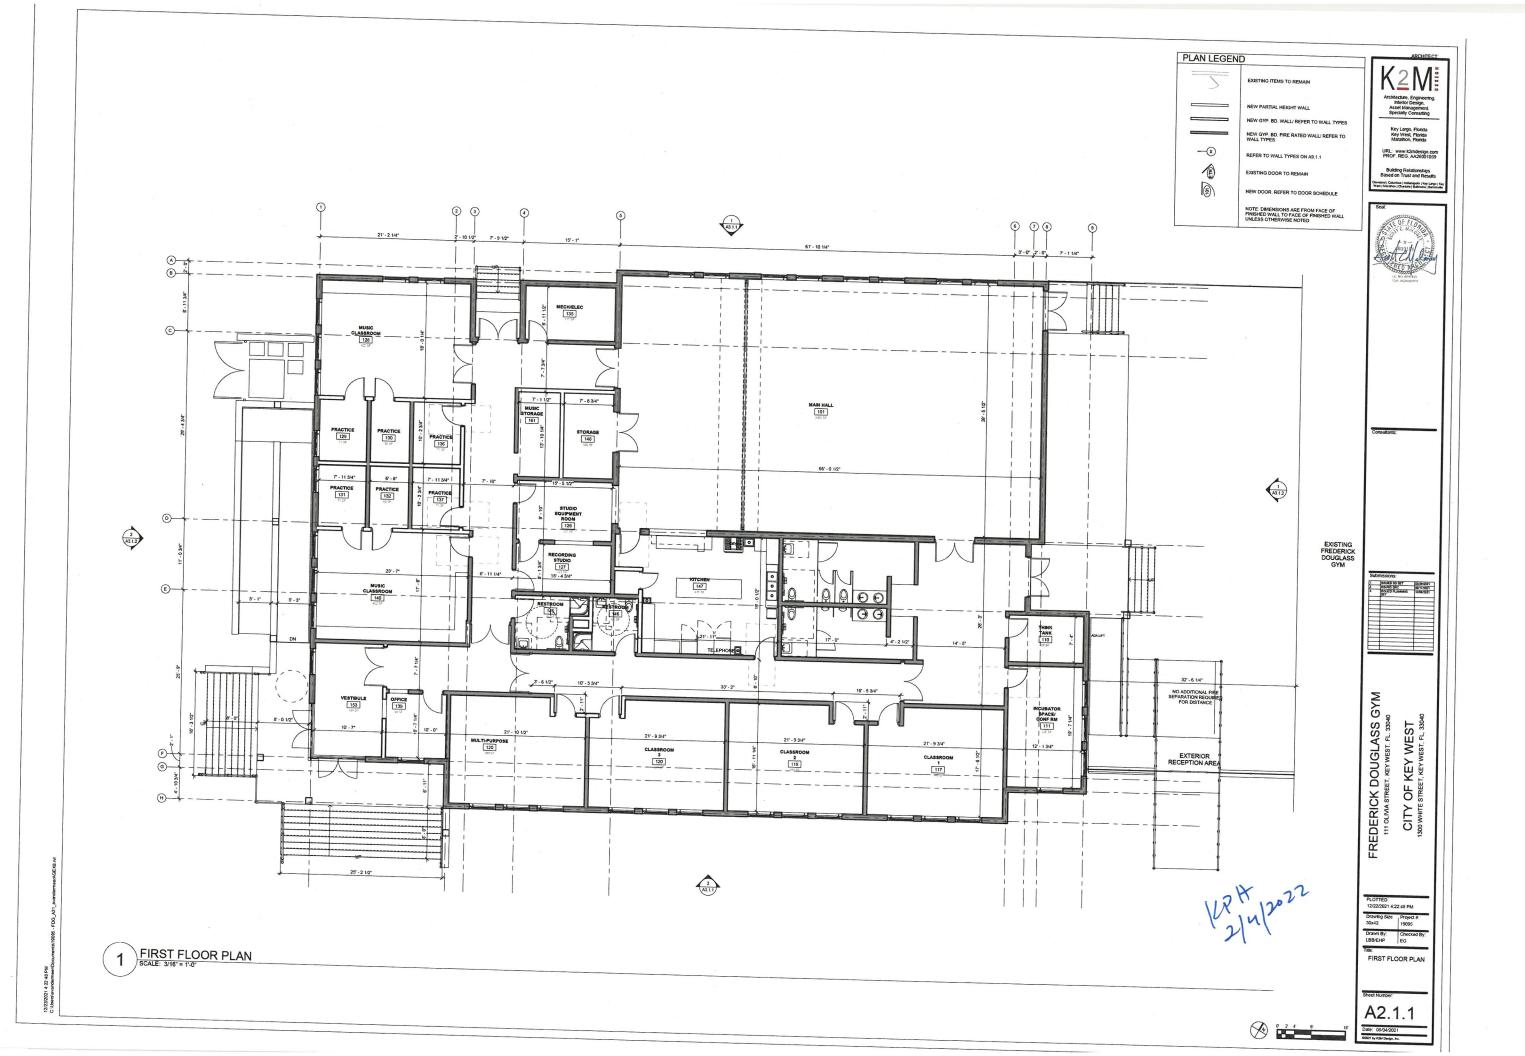

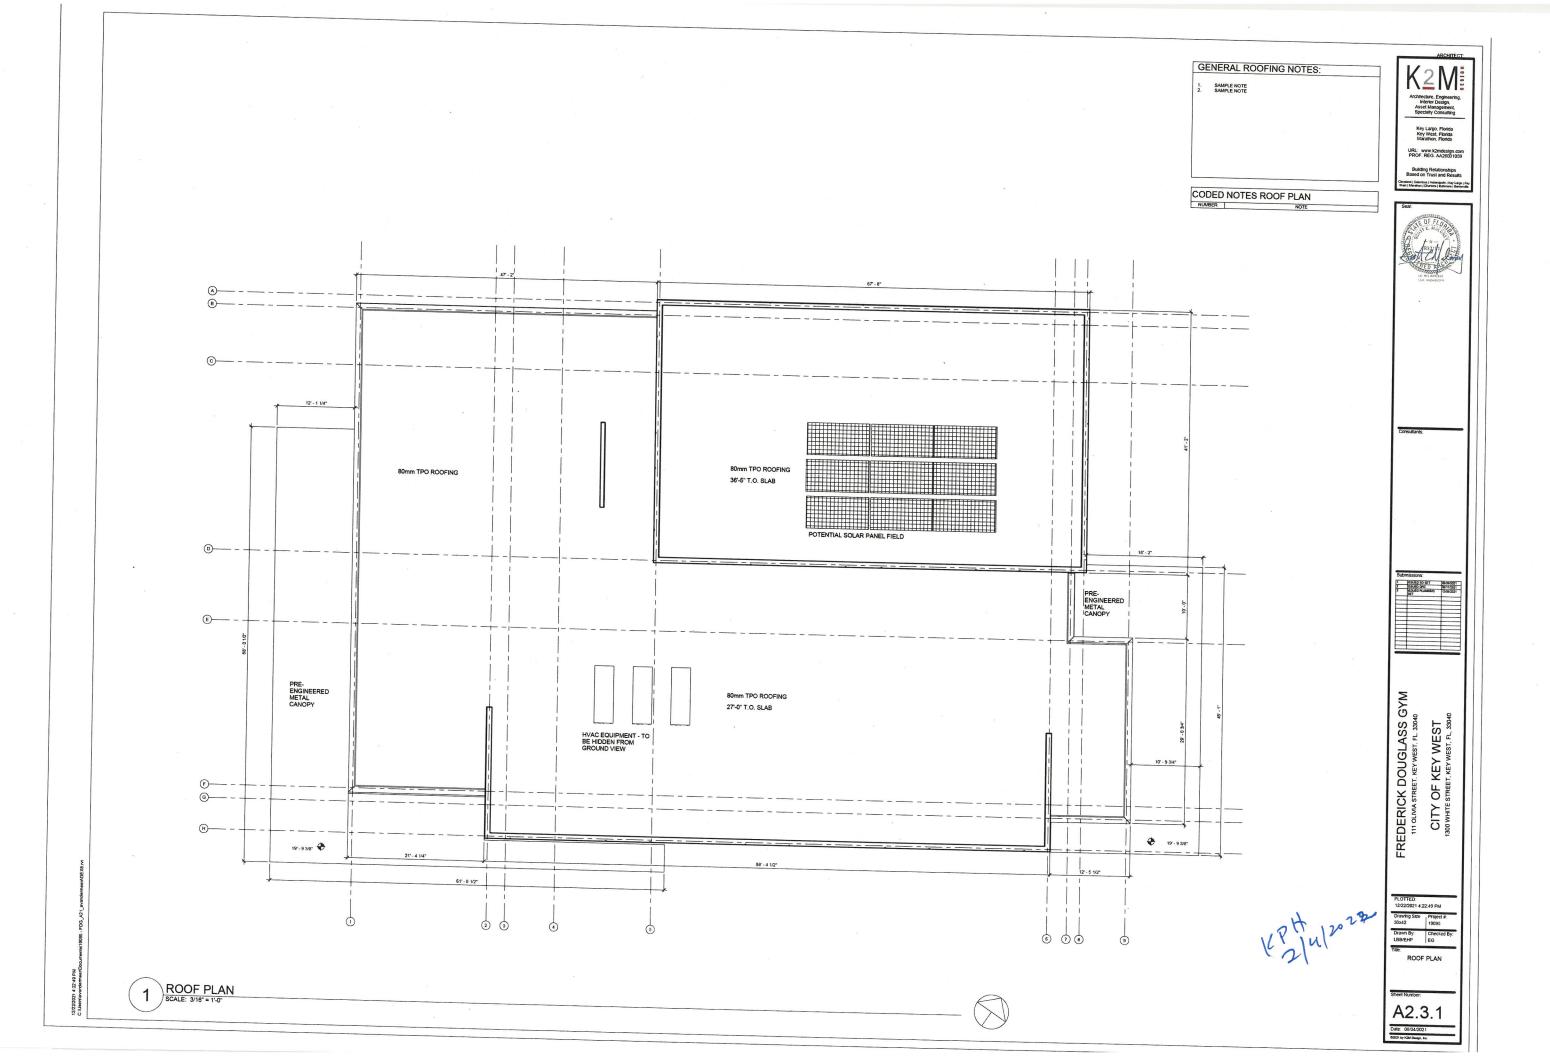

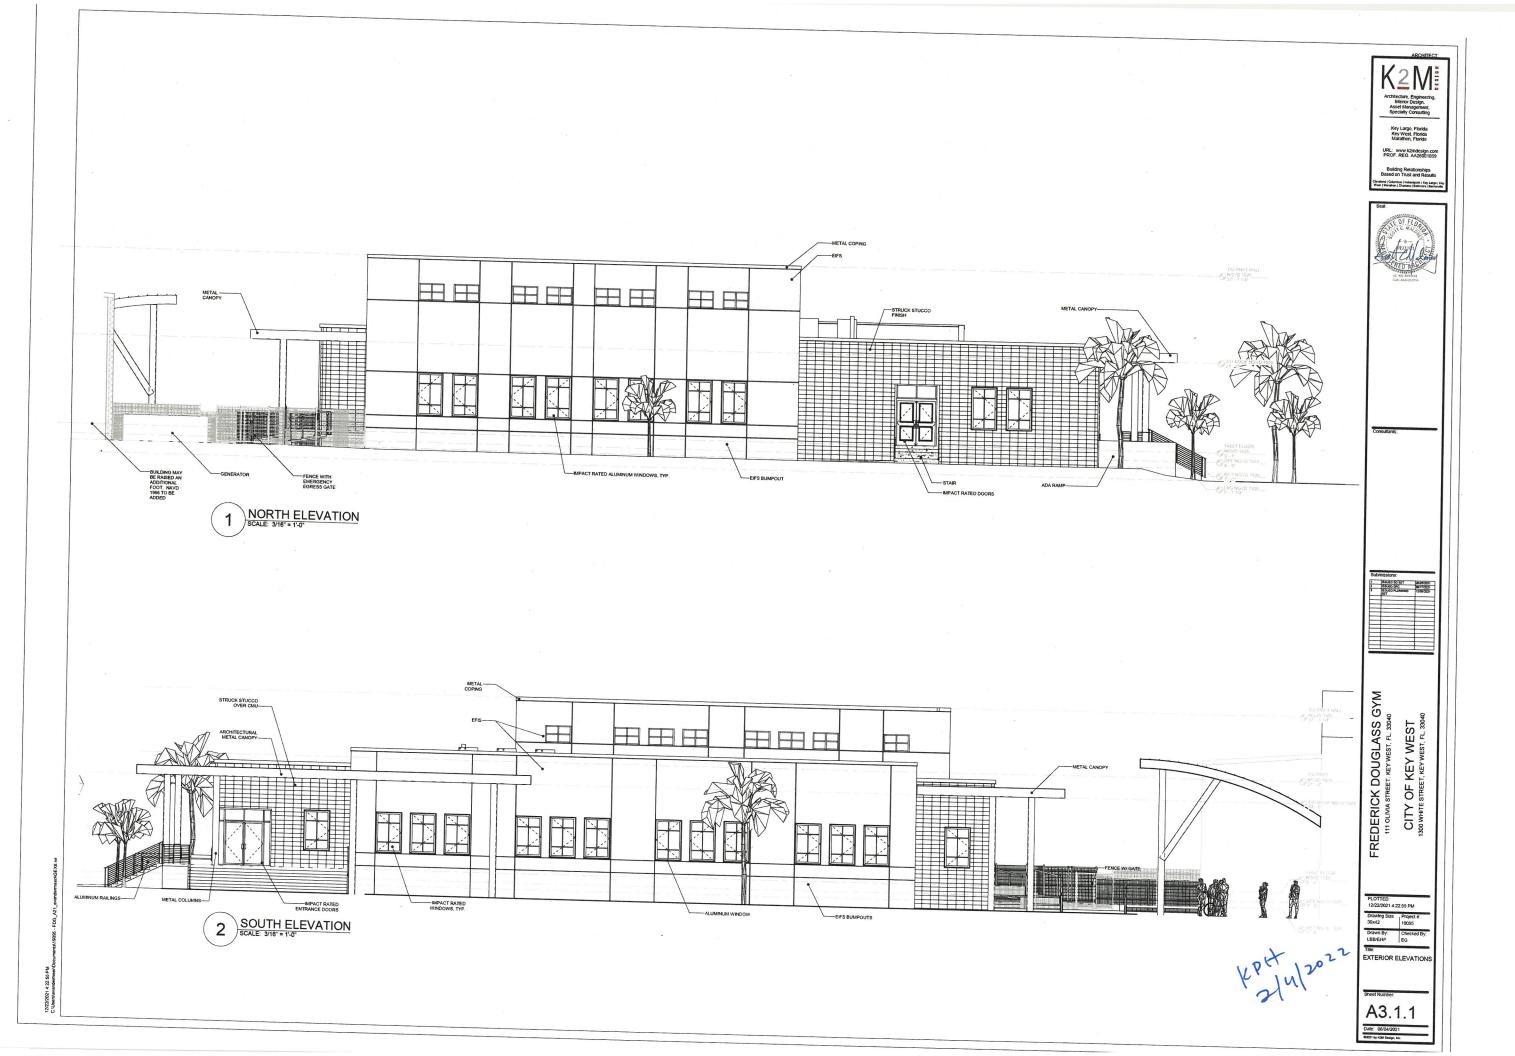

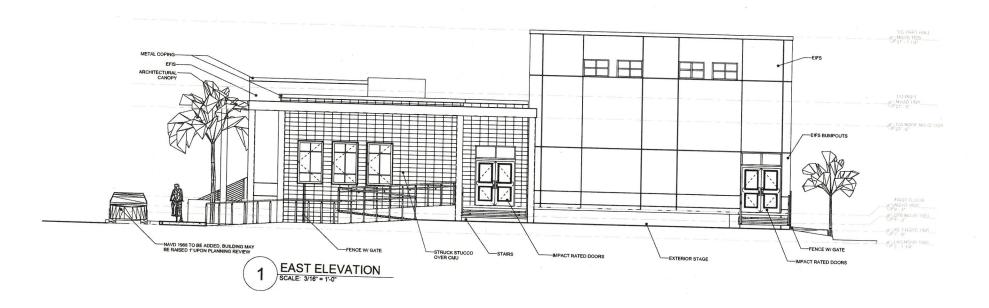

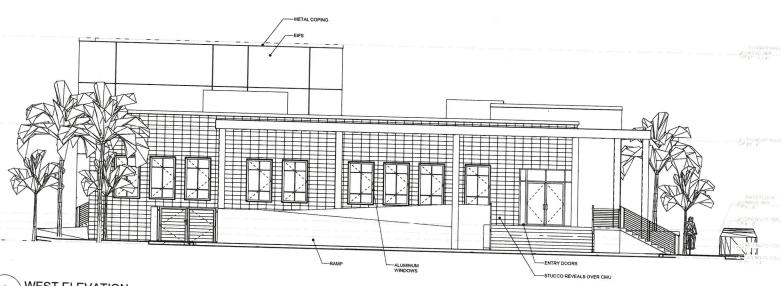

2 WEST ELEVATION
SCALE: 3/16" = 1'-0"

Key Largo, Florida Key West, Florida Marathon, Florida URL: www.k2mdesign.com PROF. REG. AA26001059



FREDERICK DOUGLASS GYM
111 OLIMA STREET, KEYWEST, FL. 33040
CITY OF KEY WEST
1300 WHITE STREET, KEY WEST

A3.1.2

Date: 08/04/2021

60021 by road Design, Inc.