# **LOCATION MAP**

## **BUILDING DATA**

X-ZONE

HMDR - HISTORIC MEDIUM DENSITY RESIDENTIAL

LEGAL DESCRIPTION:

KW ISLAND CITY SUB PB 1-26 LOT 5 SQR 1 TR 14

RE #: 00033940-000000

ADDRESS: 1208 VIRGINIA STREET; KEY WEST, FL 33040

OCCUPANCY: R3
TYPE OF CONSTRUCTION: VB

**SQUARE FOOTAGES PER FLOOR:** 

FIRST FLOOR 1,222 SF SECOND FLOOR 1,238 SF 2,460 SF TOTAL SF

**CONTRACTOR GENERAL NOTES:** 

- ALL WORK TO BE IN ACCORDANCE WITH APPLICABLE CODES.

 WORKMANSHIP TO MEET OR EXCEED ACCEPTED STANDARDS OF RESPECTIVE TRADES.

- VERIFY ALL DIMENSIONS, ELEVATIONS, AND FIELD CONDITIONS BEFORE START OF CONSTRUCTION. NOTIFY ARCHITECT IF ANY CONFLICTS EXIST PRIOR TO COMMENCEMENT OF WORK.

- FOR ANY TYPE I OR TYPE II CONSTRUCTION PROJECTS FIRE RETARDANT TREATED WOOD (EXTERIOR OR INTERIOR GRADE) MUST BE USED IN ALL WOOD

CONSTRUCTION MATERIALS. - FOR ALL WALL SYSTEMS WITH EIFS USE EXTERIOR GRADE GLASS MATT SHEATHING OR CEMENTITIOUS BOARD ONLY.

FIRE EXTINGUISHERS WILL BE PROVIDED AS REQUIRED BY AUTHORITY HAVING JURISDICTION OR AS DIRECTED BY THE LOCAL FIRE DEPARTMENT.

WALL R-VALUE (CONTINUOUS) = 6 WALL R-VALUE (CAVITY) = 13 ROOF R-VALUE = 39

CONTRACTOR TO PROVIDE ESR REPORTS FOR CLOSED-CELL SPRAY FOAM SELECTED FOR REVIEW BY DESIGN PROFESSIONAL

### **SCOPE OF WORK:**

NEW SINGLE FAMILY RESIDENCE W/ 2,460 SF AC SPACE. 2-STORIES ON CONCRETE PILE/FOOTER FOUNDATION PER PLAN. NEW MEP PER PLAN. IMPACT RATED WINDOWS/DOORS. METAL ROOF. 4 BEDROOMS/4.5 BATHROOMS.

## **GENERAL NOTES**

1. THESE PLANS ARE FOR THE CONSTRUCTION OF THE BUILDING AT THE LOCATION SO

2. NO CHANGES IN THE PLANS SHALL BE MADE WITHOUT PRIOR APPROVAL OF THE DESIGN PROFESSIONAL.

3. THE CONTRACTOR SHALL CHECK AND VERIFY ALL DIMENSIONS AND CONDITIONS OF THE JOB SITE AND REPORT ANY DISCREPANCIES OR UNSATISFACTORY CONDITIONS TO THE ARCHITECT BEFORE PROCEEDING WITH THE WORK.

4. THE CONTRACTOR SHALL PROVIDE FOR THE SAFETY, PREVENTION OF INJURY, OR LOSS AT THE JOB SITE TO ALL PERSONS EMPLOYED TO DO WORK, PERSONS VISITING THE SITE AND THE GENERAL PUBLIC. CONTRACTOR SHALL ALSO BE RESPONSIBLE FOR THE PREVENTION OF DAMAGE TO MATERIALS OR EQUIPMENT AND OTHER PROPERTY AT THE SITE OR ADJACENT THERETO.

FLORIDA BUILDING CODE (7TH EDITION), LOCAL CODES AND ORDINANCES, MANUFACTURING'S RECOMMENDATIONS AND ACCEPTABLE TRADE PRACTICES. THE MOST STRINGENT REQUIREMENTS SHALL GOVERN WHEN CONDITIONS CONFLICT, HOWEVER THE ARCHITECT SHALL BE NOTIFIED OF

5. THE CONTRACTOR SHALL DO ALL THE WORK IN STRICT CONFORMANCE TO THE PLAN, 2020

6. SHOP DRAWINGS OF ALL PREFABRICATED STRUCTURAL SYSTEMS SHALL HAVE THE SEAL OF A REGISTERED FLORIDA ENGINEER AS REQUIRED BY BUILDING CODE AND SHALL BE SUBMITTED TO THE ARCHITECT/ENGINEER BY THE CONTRACTOR FOR REVIEW PRIOR TO CONSTRUCTION.

7. CONTRACTOR SHALL NOT SCALE DRAWINGS. ANY INFORMATION THAT HE CANNOT OBTAIN

FROM DIMENSIONS, DETAILS, OR SCHEDULES, HE SHALL NOTIFY THE ARCHITECT.

8. CONTRACTOR SHALL CHECK AND COORDINATE WORK OF VARIOUS TRADES TO PREVENT CONFLICTS.

9. CONTRACTOR SHALL FURNISH SUBCONTRACTORS WITH A COMPLETE SET OF PLANS.

10. PLUMBING AND A/C SHALL CONFORM TO THE STATE OF FLORIDA ENERGY CODE.

11. ALL ELECTRICAL WORK SHALL CONFORM TO THE NATIONAL ELECTRIC CODE AND FLORIDA BUILDING CODE.

12. PORTABLE REST ROOM FACILITIES SHALL BE PROVIDED AT SITE BY CONTRACTOR 13. COMPLETE HOT AND COLD WATER SYSTEMS, VENTS, WASTE AND DRAIN SYSTEMS TO SEPTIC

TO CODE, SHALL BE FURNISHED. 14. PROVIDE PLASTIC SLEEVES IN MASONRY, PARTITIONS, FOUNDATIONS, ETC., AS REQUIRED FOR

15. ALL BOLTS, CLIPS, HANGERS, ETC., SHALL BE GALVANIZED OR STAINLESS.

16. NO PIPES, CONDUITS OR JUNCTION BOXES ARE TO BE PLACED IN SLABS OR COLUMNS, UNLESS SPECIFICALLY SHOWN ON STRUCTURAL DRAWINGS.

17. CONTRACTOR IS RESPONSIBLE FOR THE PROPER REMOVAL OF ALL DEBRIS.

18. ALL ELEVATIONS ARE MEASURED FROM NGVD 1929.

### **CODE INFORMATION**

**BUILDING CODE MECHANICAL CODE:** PLUMBING CODE ELECTRICAL CODE: **FUEL GAS CODE ENERGY CODE:** ADA ACCESSIBILITY CODE: STANDARD LOAD DESIGN CRITERIA

LOCAL BUILDING REQUIREMENTS: FEMA REQUIREMENTS: **DESIGN FLOOD ELEVATION: CURRENT ZONING:** 

MAX BUILDING HEIGHT:

2020 FLORIDA BUILDING CODE, 6TH EDITION 2020 FLORIDA MECHANICAL CODE 2020 FLORIDA PLUMBING CODE 2017 NATIONAL ELECTRIC CODE (NEC) NFPA 2020 FLORIDA FUEL GAS CODE 2020 FLORIDA ENERGY CONSERVATION CODE 2020 FLORIDA ACCESSIBILTY CODE **ASCE 7-16** 

CITY OF KEY WEST CODES AND ORDINANCES FLOOD ZONE: X-ZONE NGVD 1929 FLOOD ZONE: X-ZONE NGVD 1929 HMDR - HISTORIC MEDIUM DENSITY RESIDENTIAL 35' FROM COR/LAG

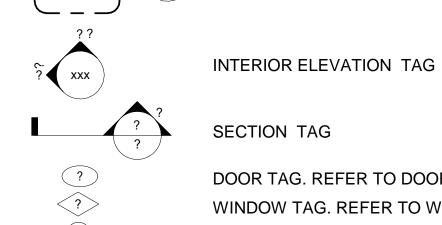
ALL ELEVATIONS PROVIDED IN NGVD 1929.

# **ABBREVIATIONS**

ABOVE FINISHED FLOOR AHU AIR HANDLING UNIT A/V **AUDIO VISUAL** BO **BOTTOM OF** CENTERLINE CLG CMU CEILING **CONCRETE MASONRY UNIT** CO CONC **CLEAN OUT** CONCRETE DRYER DIAMETER DTLS DETAILS DW **DISHWASHER ELECTRICAL METER** FBC FLORIDA BUILDING CODE FEC FIRE EXTINGUISHER CABINET GAUGE GAL GALLON GFI GROUND FLOOR IMPACT GWB GYPSUM WALL BOARD HEATING, VENTILATION, & AIR CONDITIONING HVAC LHM LOWEST HORIZONTAL MEMBER MAX MAXIMUM MECHANICAL, ELECTRICAL, PLUMBING MEP MIN NOT IN CONTRACT NOT TO SCALE NTS ON CENTER O.C. POUNDS PER SQUARE INCH PRESSURE TREATED RCP REFLECTED CEILING PLAN REFERENCE REF REFRIGERATOR REQ'D REQUIRED RO **ROUGH OPENING** STL STEEL THICK TOP OF TOP TOP OF PILE TOW TOP OF WALL TYP TYPICAL UNLESS OTHERWISE NOTES U.N.O. VTR **VENT TO ROOF** WASHER WATER CLOSET WD WOOD W/D WASHER/DRYER WP WATERPROOF WATER HEATER

# **SYMBOLS**

ROOM IDENTIFICATION TAG **ROOM NAME ROOM NUMBER ELEVATION TAG ELEVATION NUMBER** SHEET NUMBER **DETAIL NUMBER** SHEET NUMBER



0' 4' 8' 16'

SCALE: ?

 $\bigcirc$ 

SHEET NUMBER DOOR TAG. REFER TO DOOR SCHEDULE WINDOW TAG. REFER TO WINDOW SCHEDULE WALL TAG. REFER TO WALL TYPES. **BREAK LINE** 

**GRAPHIC SCALE** 

**NORTH ARROW** 

DRAWING TITLE

SIDE SETBACK

**EXISTING FRONT** 

SIGEWOIK

SETBACK

DETAIL NUMBER TITLE SHEET NUMBER SCALE

SIDE SETBACK

 $\bigcirc$ 

 $\bigcirc$ 

2 SITE PLAN 1" = 10'-0"

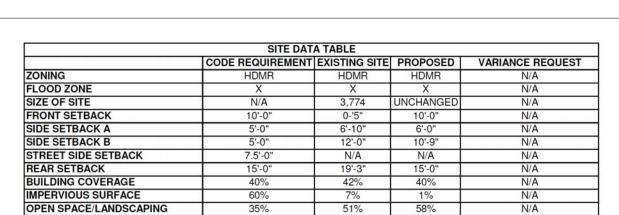
**ELEVATION NUMBER** 

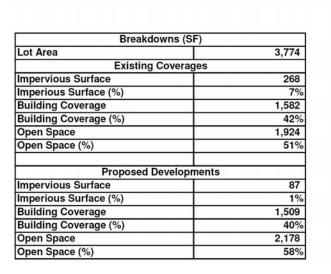
SHEET NUMBER

**SECTIONNUMBER** 

# DRAWING INDEX

A 0	COVER SHEET
A 1	FLOOR PLANS
A 01	SITE PLAN & SURVEY
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A 5	3D VIEWS
A 6	RCPS
E 1	ELECTRICAL NOTES & RISER DIAGRAM
E 2	ELECTRICAL PLAN & PANEL SCHEDULE
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S 2	STRUCTURAL NOTES
S 3	FOUNDATION & FIRST FLOOR FRAMING PLAN
S 4	SECOND FLOOR FRAMING & ROOF PLAN
S 5	WALL SECTIONS
S 6	SECTIONS






STORMWATER CALCULATIONS: PROPOSED COVERAGE = 1,582 SF

1,582 SF X .083 = 131.3 CUFT

SWALE A = 79.5 CUFT 1/4 SLOPE, 6" DEEP, 40'-6" X 4'

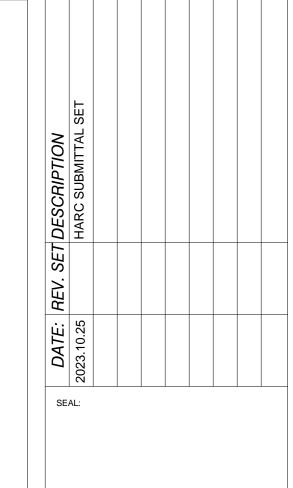SWALE B = 79.5 CUFT 1/4 SLOPE, 6" DEEP, 40'-6" X 4'





ERICA HELEN POOLE - ARCHITECT

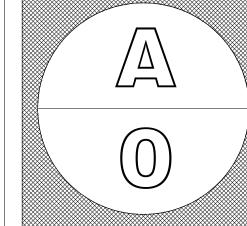
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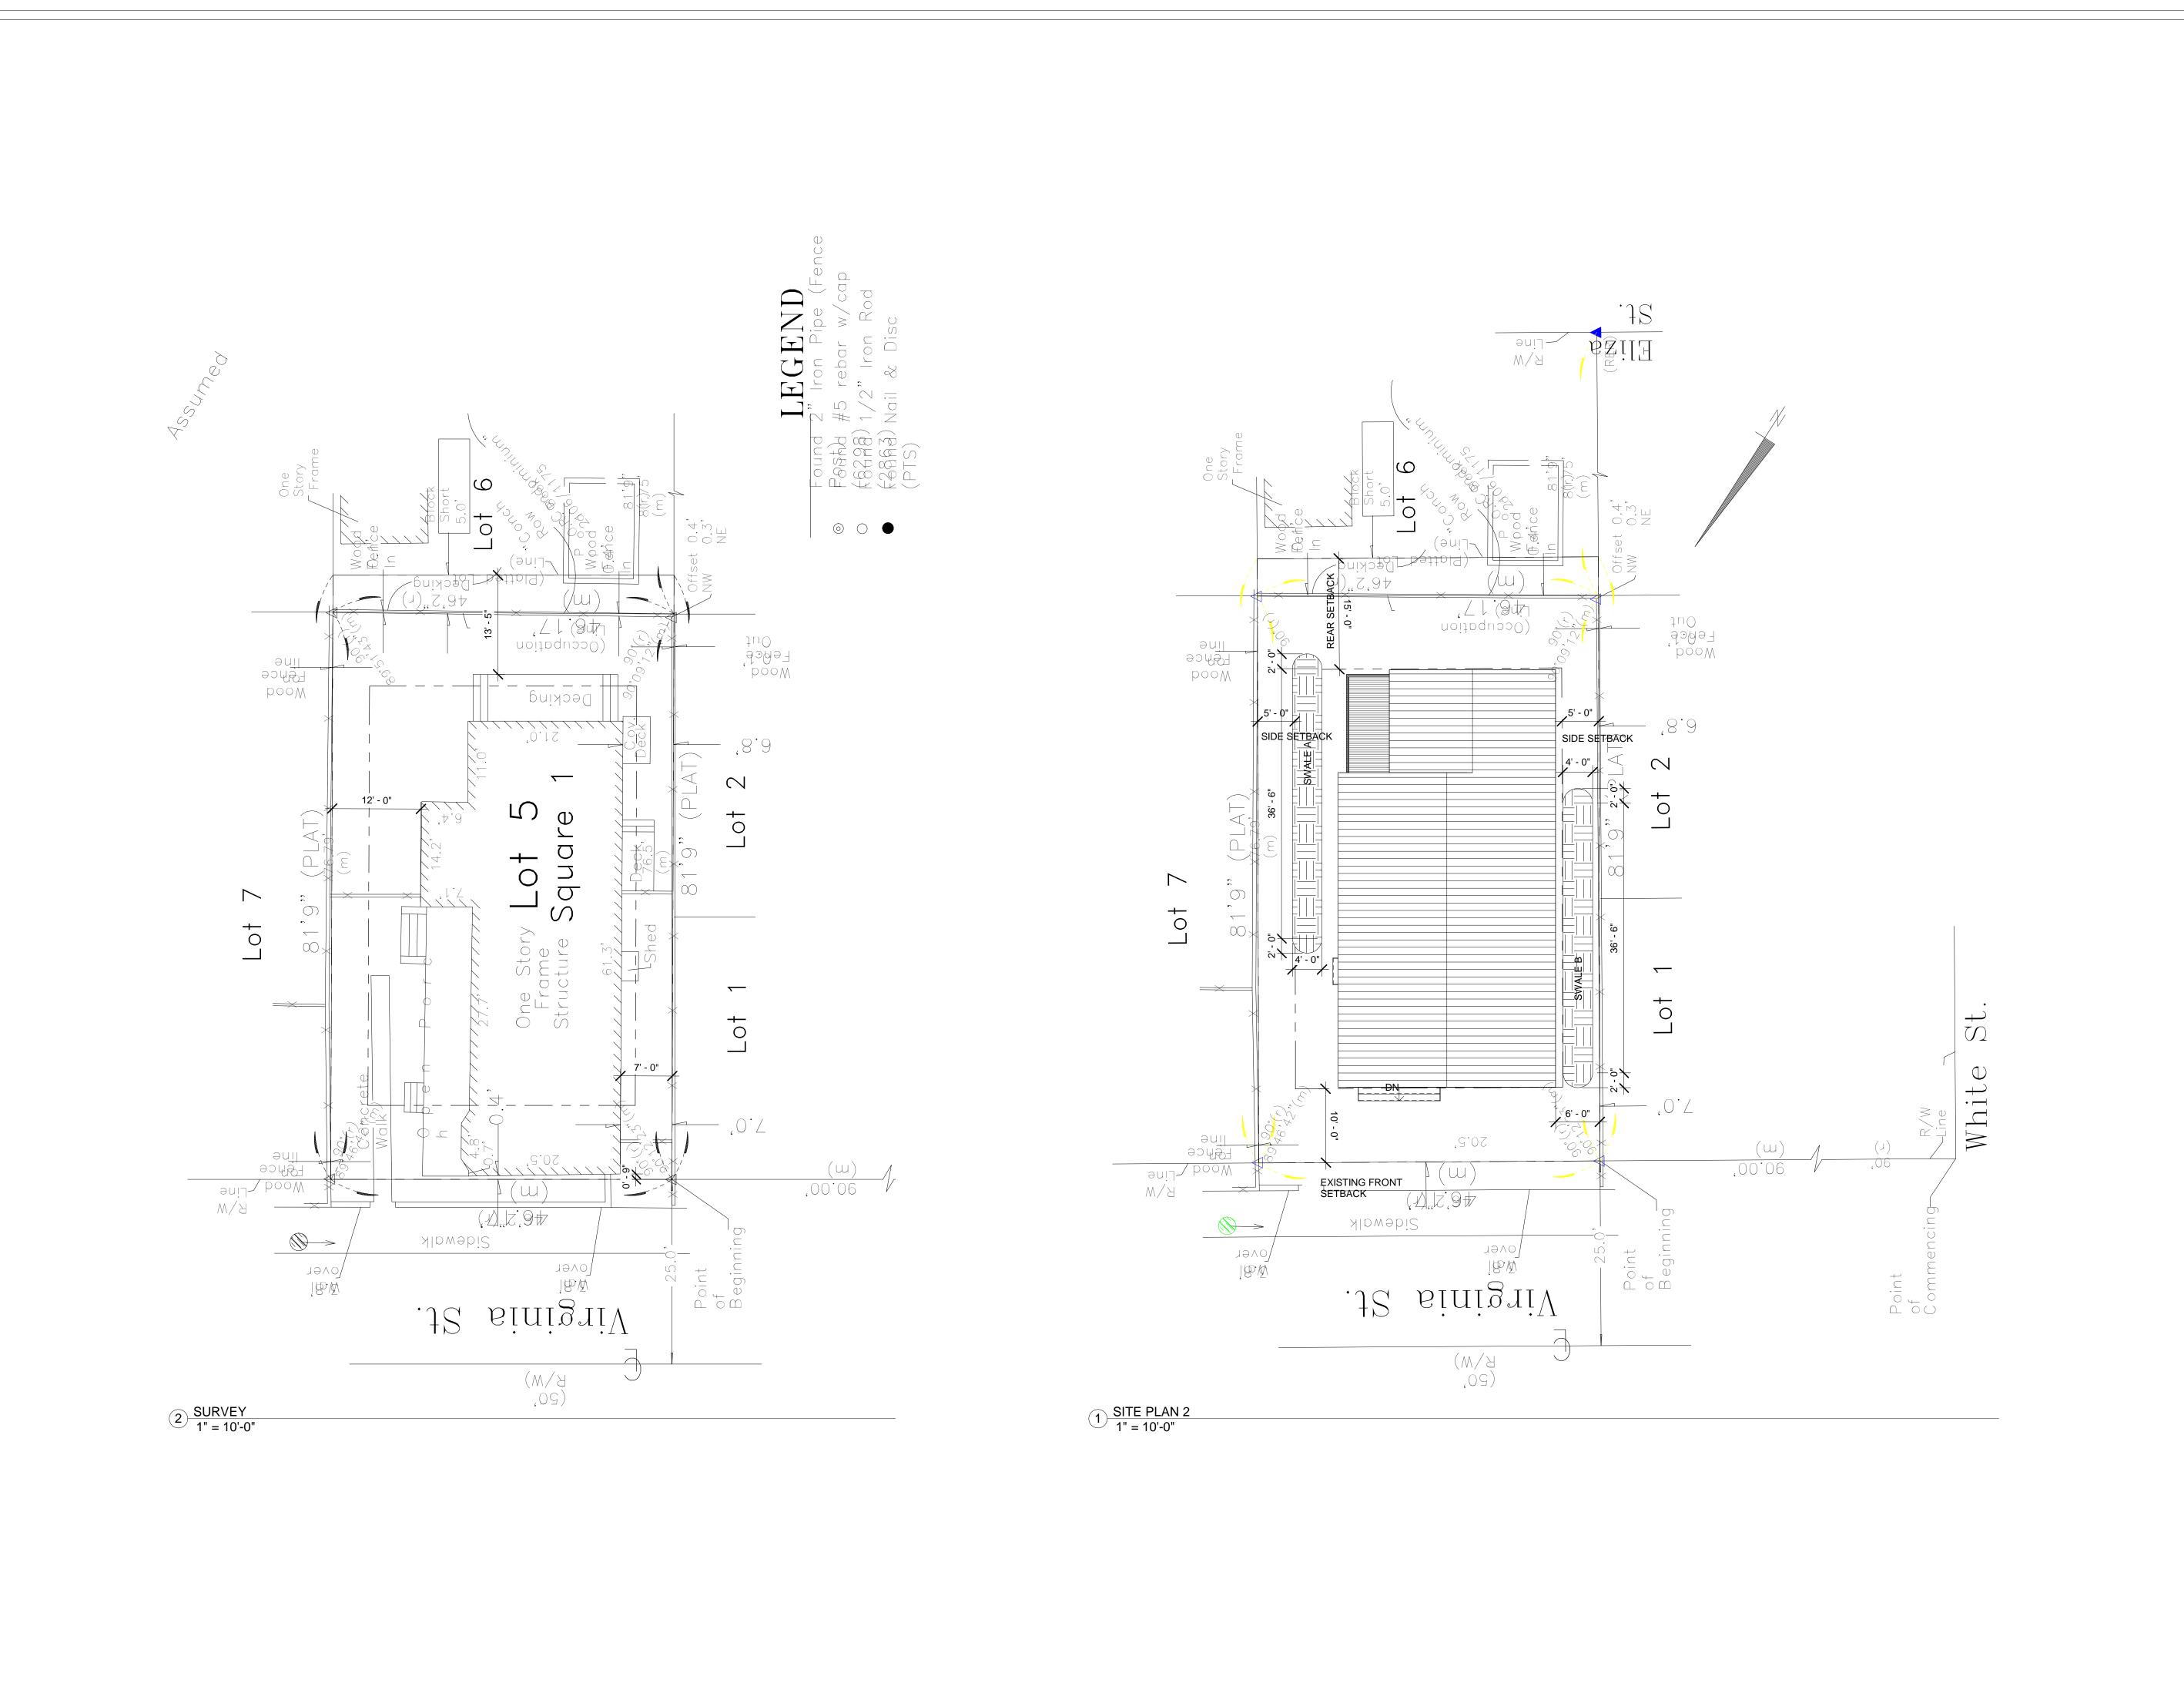
Family Single Fan Residence 8 Virginia Stree West, FL 3304


COVER SHEET



PROJECT NO. DRAWN BY: Author LAK2022B APPROVED BY: Checker

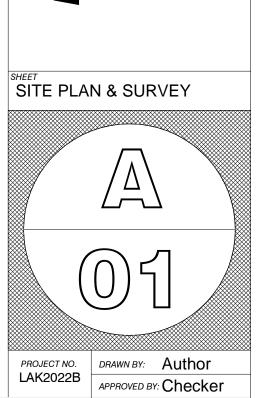New





New Single Family
Residence
1208 Virginia Street
Key West, FL 33040



DATE: REV. SET DESCRIPTION

2023.10.25 HARC SUBMITTAL SET

HARC SUBMITTAL SET





NOT VALID FOR CONSTRUCTION UNLESS SIGNED/SEALED IN THIS BLOCK

THIS ITEM HAS BEEN DIGITALLY SIGNED AND SEALED BY ERICA HELEN POOLE USING A DIGITAL SIGNATURE.

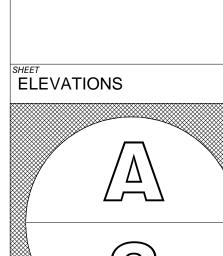
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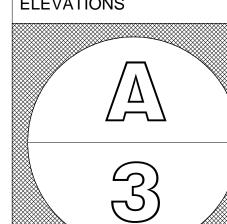
ERICA HELEN POOLE - ARCHITECT

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PROJECT NO.
LAK2022B

DRAWN BY: Author

APPROVED BY: Checker