CITY OF KEY WEST

INDEX OF ROADWAY PLANS

SHEET NO.

SHEET DESCRIPTION

KEY SHEET
SIGNATURE SHEET
SUMMARY OF PAY ITEMS
GENERAL NOTES
TREE PROTECTION NOTES
TREE PROTECTION NOTES
TYPICAL SECTION
SIDENAL NOTES
ROADWAY PLAN
SECTION
SECTION
DETAILS
FOR ADDWAY PLAN/PROFILE
DRAINAGE DETAILS
DRAINAGE PLAN
PROADWAY SOIL SURVEY
ROADWAY SOIL PROFILES
LANDSCAPE TABLE

TASK ORDER 9-22 SOUTH STREET IMPROVEMENTS

MONROE COUNTY

ROADWAY PLANS



PHASE IV (100%) SUBMITTAL DECEMBER 2023

ROADWAY ENGINEER OF RECORD:

KAREN E. FALKENBERRY P.E. P.E. LICENSE NUMBER 54015 JACOBS ENGINEERING GROUP INC. 200 W. FORSYTH ST., STE 1520 JACKSONVILLE, FLORIDA 32202

CITY PROJECT MANAGER:

IAN MCDOWELL, P.E.

CONSTRUCTION	FISCAL	SHEET
CONTRACT NO.	YEAR	NO.
	24	1

PROJECT LOCATION

GOVERNING STANDARD PLANS:


Florida Department of Transportation, FY 2023-24 Standard Plans for Road and Bridge Construction and applicable Interim Revisions (IRs).

Standard Plans for Road Construction and associated IRs are available at the following website: http://www.fdot.gov/design/standardplans

GOVERNING STANDARD SPECIFICATIONS:

Florida Department of Transportation, FY 2023-24 Standard Specifications for Road and Bridge Construction at the following website: http://www.fdot.gov/programmanagement/Implemented/SpecBooks

Karen.Falkenberry@jacobs.com 1/28/2024 5:11:13 PM Untitled-1 [Sheet]

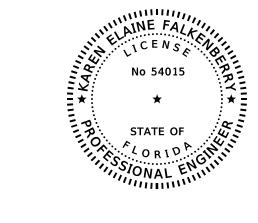

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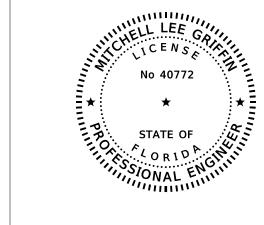
JACOBS ENGINEERING GROUP, INC. 200 W. FORSYTH STREET, SUITE 1520 JACKSONVILLE, FL 32202 KAREN E. FALKENBERRY, P.E. NO. 54015

THE ABOVE NAMED ENGINEER SHALL BE RESPONSIBLE FOR THE FOLLOWING SHEETS IN ACCORDANCE WITH RULE 61G15-23.004, F.A.C.

ROADWAY PLANS

Karen.Falkenberry@jacobs.com

SHEET NO	SHEET DESCRIPTION
1	KEY SHEET
2	SIGNATURE SHEET
3	SUMMARY OF PAY ITEMS
4	<i>GENERAL NOTES</i>
5	TREE PROTECTION NOTES
6 - 7	TYPICAL SECTIONS
8 - 10	DETAILS
11 - 14	ROADWAY PLAN
15	<i>ROADWAY PLAN/PROFILE</i>
24 - 26	<i>LANDSCAPE TABLE</i>



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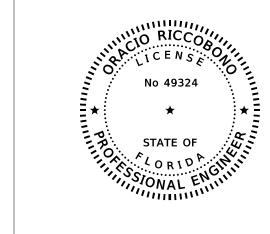
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JACOBS ENGINEERING GROUP, INC. 5401 W KENNEDY BLVD, STE 300 TAMPA, FL 33609 MITCH GRIFFIN, P.E. NO. 40772

THE ABOVE NAMED ENGINEER SHALL BE RESPONSIBLE FOR THE FOLLOWING SHEETS IN ACCORDANCE WITH RULE 61G15-23.004, F.A.C.

ROADWAY PLANS

SHEET NO	SHEET DESCRIPTION
2	SIGNATURE SHEET
16	DRAINAGE DETAILS
17 - 21	DRAINAGE PLAN



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GEOSOL, INC. 5795-A NW 151ST STREET MIAMI LAKES, FL 33014 ORACIO RICCOBONO, P.E. NO. 49324

THE ABOVE NAMED ENGINEER SHALL BE RESPONSIBLE FOR THE FOLLOWING SHEETS IN ACCORDANCE WITH RULE 61G15-23.004, F.A.C.

ROADWAY PLANS

SHEET NO	SHEET DESCRIPTION
2	SIGNATURE SHEET
22	ROADWAY SOILS SURVEY
23	ROADWAY SOIL PROFILES

	REVI.	KAREN E. FALKENBERRY, P.E.		
DATE	DESCRIPTION	DATE	DECCRIPTION	P.E. LICENSE NUMBER 54015
				I .
				JACOBS ENGINEERING GROUP, INC
				200 W. FORSYTH ST, STE 1520
				JACKSONVILLE, FL 32202
				<u>'</u>



TASK ORDER 9-22

PROJECT: SOUTH STREET IMPROVEMENTS SIGNATURE SHEET

SHEET NO.

Bid Item	Pay Item		Estimated	
Number	Number	Description	Quantity	Unit
1	101-1	Mobilization	1	LS
2	102-1	Maintenance of Traffic	1	LS
3	104-18	Inlet Protection System	12	EA
4	107-1	Litter Removal	2.88	AC
5	110-1-1	Clearing and Grubbing	0.08	AC
6	110-4-10	Removal of Existing Concrete Pavement	3,846	SY
7		Type D-3 Geotextile for Trench Restoration	328	SY
8		Tensar Glasgrid CG System Geotextile	8,479	SY
9	121-70	Flowable Fill	94	CY
10	285-704*	Limerock Stabilized Base (LBR 100) - 6" (Stabilization)	2,251	SY
11		Regrading Limerock Base	1,317	SY
12	285-706	Optional Base, Base Group 6	1,226	SY
13	327-70-5	Mill Existing Asphalt Pavement (2.0" Avg Depth)	5,794	SY
14	334-1-12	Superpave Ashaltic Concrete, Traffic B	943.4	TN
15	425-1-201	Inlet, Curb, Type 9, <10 ft with Type P Box Alt B	5	EA
16	425-4	Inlets, Adjust	1	EA
17	425-5-1	Manhole, Adjust	17	EA
18	425-6	Valve Boxes, Adjust	214	EA
19	430-175-124	Pipe Culvert, Optional Material, Round, 24" S/CD	102	LF
20	520-1-10	Concrete Curb & Gutter, Type F	4,571	LF
21	520-2-4	Concrete Curb, Type D	1,868	LF
22	522-1	Concrete Sidewalk and Driveways, 4" thick	2,614	SY
23	522-2	Concrete Sidewalk and Driveways, 6" thick	714	SY
24	527-2	Detectable Warnings	328	SF
25		SOP Technologies Curbed Inlet Filter Screen	4	EA
26		Madrax Bollard Bike Rack	9	EA
27	581-1-1	Relocate Trees & Palms, Palm < 14' of Clear Trunk	4	EA
28		Landscape Trees	35	EA
29		Flexi-pave at Tree Wells	1,257	SF
30	700-1-11	Single Post Sign, F&I Ground Mount, up to 12 SF	46	AS
31	706-1-110	Raised Pavement Marker, Type B, Solar Powered Blue	9	EA
32	710-90	Painted Pavement Markings - Final Surface	1	LS
33	711-11-123	Thermo, Std, White, Solid, 12" (Cross-Walk)	1,450	LF
34	711-11-125	Thermo, Std, White, Solid, 24" (Stop Bar)	223	LF
35	711-11-141	Thermo, Std, White, 2-4' Dotted Guideline, 6"	0.059	GM
36	711-14-160	Thermo, Preformed, White, Message	36	EA
37	711-14-170	Thermo, Preformed, White, Arrow	16	EA
38	711-16-201	Thermo, Std - Other Surfaces, Yellow, Solid, 6" (Centerline)	0.790	GM
39	1000	Utility Coordination	1	LS

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ja√qı					REVI	SIONS			KAREN E. FAL	KENBERR	Y, P.E.	_
c:\users\kfalkeı	DATE		D	ESCRIPTION		DATE	DESCRIPTION		P.E. LICENSE JACOBS ENGII 200 W. FORSY JACKSONVILLE	NEERING TH ST, S	GROUP, IN STE 1520	VC
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PAY ITEM NOTES

AND RAISED PAVEMENT MARKERS.

REQUIRED FOR NEW CONSTRUCTION.

JUNK, AND BRUSH DEBRIS.

AREAS (IF APPLICABLE).

AREAS AS SHOWN IN THE PLAN.

THE WORK.

102-1

104-18

107-1

110-1-1

110-4-10

520-1-10

520-1-10, 520-2-4,

522-1 522-2

522-2

527-2

706-1-110**

711-11-141

711-14-160, 711-14-170.

711-16-201 1000

710-90**

425-6

TASK ORDER 9-22

PROJECT: SOUTH STREET IMPROVEMENTS

SHEET NO.

SUMMARY OF PAY ITEMS

INCLUDES ALL ITEMS FOR MAINTENANCE OF TRAFFIC WHICH ARE NOT INCLUDED FOR PAYMENT UNDER SEPARATE ITEMS. INCLUDES PEDESTRIAN MAINTENANCE OF TRAFFIC IN ACCORDANCE WITH THE SPECIFICATIONS. INCLUDES TEMPORARY PAVEMENT MARKINGS AND TAPE, SIGNAGE,

IS ESTIMATED FOR PREVENTION, CONTROL AND ABATEMENT OF EROSION AND WATER POLLUTION AND ARE TO BE USED AT LOCATIONS DESIGNATED ON THE PLANS, OR AS DIRECTED BY THE

PROVIDE PICKUP, REMOVAL AND DISPOSAL OF LITTER WITHIN THE PROJECT LIMITS FROM THE OUTSIDE EDGE OF TRAVEL WAY TO THE RIGHT-OF-WAY LINE. LITTER INCLUDES, BUT IS NOT

INCLUDES REMOVAL AND DISPOSAL OF ALL VEGETATION, DEBRIS, DRAINAGE STRUCTURES, FLEXIBLE PAVEMENT, BUILDINGS OR ANY OTHER OBSTRUCTIONS IN ALL AREAS WHERE EXCAVATION IS TO BE DONE, OR WHERE EMBANKMENTS OR STRUCTURES WILL BE CONSTRUCTED.

THIS INCLUDES ROADWAY AREA, DITCH AREA, BORROW AND MATERIAL PITS, AND AREAS WHERE

INCLUDES REMOVAL AND DISPOSAL OF EXISTING CURB & GUTTER AND CONCRETE SIDEWALKS AS

ADJUST VALVES, METERS, CLEANOUTS, UTILITY BOXES AS SHOWN IN THE PLANS TO BE ADJUSTED

MODIFIED TYPE F CURB AND MODIFIED DROP CURB CONSTRUCTION AND INSTALLATION IS

ROADWAY FEATURES IS INCIDENTAL AND INCLUDED IN THE COST OF THE CONCRETE.

6" CONCRETE TO BE PLACED WITHIN LIMITS OF CURB RAMPS WITHIN RADIUS RETURNS,

EXCAVATION AND/OR EMBANKMENT, SUBGRADE, OR BASE FOR CONSTRUCTION OF THE LISTED

SIDEWALKS WITHIN DRIVEWAYS, AND DRIVEWAYS. INCLUDES CONCRETE PAVEMENT IN PARKING

SHALL BE CAST IN PLACE, INCLUDES ALL LABOR, SURFACE PREPARATION, MATERIALS AND INCIDENTALS NECESSARY TO COMPLETE THE WORK. CITY OF KEY WEST REQUIRES ENDICOTT

INCLUDES PAYMENT FOR FINAL SURFACE RAISED PAVEMENT MARKERS (RPMs). THIS INCLUDES BLUE SOLAR-POWERED RPMs AT ALL FIRE HYDRANT LOCATIONS PER FDOT STANDARD INDEX 706-001.

INCLUDES PAYMENT FOR PAINTED FINAL SURFACE PAVEMENT MARKINGS (ONE COAT OF FINAL PAINT). THIS INCLUDES RED PAINT AND YELLOW REFLECTIVE PAINTED CURB FOR NO PARKING

INCLUDES ALL CLEANING AND PREPARATION OF SURFACES, FURNISHING OF ALL MATERIALS, APPLICATION, CURING AND PROTECTION OF ALL ITEMS, PROTECTION OF TRAFFIC, FURNISHING

OF ALL TOOLS, MACHINES AND EQUIPMENT, AND ALL INCIDENTALS NECESSARY TO COMPLETE

PAY ITEM 285-704, OPTIONAL BASE GROUP 4, IS SIMILAR TO THE LIMEROCK STABILIZED BASE (LBR 100)

SHALL COMPENSATE THE CONTRACTOR FOR ALL COORDINATION WITH EXISTING UTILITY PROVIDER

CULVERTS OR PIPE LINES WILL BE CONSTRUCTED. TOTAL: 0.08 AC.

INCIDENTAL AND INCLUDED IN THE COST OF THE CONCRETE.

THROUGHOUT THE DURATION OF THE CONSTRUCTION CONTRACT

CLAY PAVERS, (4"x8"x2.25", ROSE BLEND COLOR).

OR REQUIRING ADJUSTMENT FOR THE SATISFACTORY COMPLETION OF THE WORK

LIMITED TO BOTTLES, CANS, PAPER, TIRES, TIRE PIECES, LUMBER, VEHICLE PARTS, METAL

2/9/2024 8:54:49 AM SUMMARY OF QUANTITIES [Sheet]

PAY ITEM IN SIGNING AND PAVEMENT MARKING COMPONENT SET.

- 1. THE CONTRACTOR SHALL FIELD-VERIFY EXISTING CONDITIONS PRIOR TO PERFORMING ANY WORK UNDER THIS CONTRACT AND NOTIFY THE ENGINEER IN WRITING OF ANY DIFFERENCES BEFORE COMMENCING WITH ANY CONSTRUCTION.
- 2. HORIZONTAL COORDINATES ARE BASED ON FLORIDA STATE PLANE COORDINATE SYSTEM. VERTICAL ELEVATIONS ARE BASED ON NGVD 1929 DATUM AS PROVIDED IN THE TOPOGRAPHIC ROUTE SURVEY SHEETS.
- 3. EXISTING DRAINAGE STRUCTURES WITHIN CONSTRUCTION LIMITS SHALL REMAIN, UNLESS OTHERWISE NOTED.
- 4. ALL STORM DRAINAGE INLETS AND PIPES SHALL BE PROTECTED FROM SILT, SAND AND DEBRIS DURING CONSTRUCTION. ANY ACCUMULATION WITHIN THE STORM DRAINAGE SYSTEM SHALL BE REMOVED WITHOUT PUMPING OR FLUSHING INTO SURFACE WATERS. STORM DRAINAGE SYSTEM SHALL BE CLEANED AND FREE OF DEBRIS PRIOR TO FINAL ACCEPTANCE.
- 5. NO CONNECTIONS FOR THE PURPOSE OF OBTAINING WATER SUPPLY DURING CONSTRUCTION SHALL BE MADE TO ANY FIRE HYDRANT OR BLOW-OFF STRUCTURE WITHOUT FIRST OBTAINING A CONSTRUCTION METER FROM THE FLORIDA KEYS AQUEDUCT AUTHORITY.
- 6. ALL SURVEY INFORMATION WAS OBTAINED FROM A LICENSED FLORIDA PROFESSIONAL SURVEYOR AND MAPPER AND UTILIZED AS SUPPORTING DATA IN THE PRODUCTION OF DESIGN PLANS AND FOR CONSTRUCTION ON SUBJECT PROJECT. THE PROFESSIONAL SURVEYOR AND MAPPER OF RECORD IS:

KEITH M. CHEE-A-TOW, P.L.S. Florida Registration No.: 5328 AVIROM & ASSOCIATES, INC. 50 S.W. 2nd AVENUE, SUITE 102 BOCA RATON, FL 33432 L.B. No. 3300

7. THE LOCATION OF UTILITIES SHOWN ON THE PLANS ARE APPROXIMATE ONLY.
THE EXACT LOCATIONS SHALL BE DETERMINED BY THE CONTRACTOR PRIOR TO
CONSTRUCTION. IN ADDITION, THE CONTRACTOR SHALL BE RESPONSIBLE TO
VERIFY IF "OTHER" UTILITIES (NOT SHOWN ON THE PLANS) EXIST WITHIN THE
AREA OF CONSTRUCTION. SHOULD THERE BE UTILITY CONFLICTS, THE CONTRACTOR
SHALL INFORM THE ENGINEER AND NOTIFY THE RESPECTIVE UTILITY OWNER
TO RESOLVE UTILITY CONFLICTS AND UTILITY ADJUSTMENTS AS REQUIRED.

IDENTIFIED UTILITY / AGENCY OWNERS:

COMPANY	CONTACT	TELEPHONE
A.T.T. FLORIDA	CARLOS MORENO	(305) 929-4579
COMCAST	LEONARD MAXWELL-NEWBOLD	(954) 447-8405
F.K.A.A.	MARNIE WALTERSON	(305) 295-2154
KEYS ENERGY SERVICES	MATTHEW ALFONSO	(305) 295-1055
O.M.I. (KEY WEST SEWER DEPT)	KELLY CROWE	(305) 809-3906

- 8. UTILITY ADJUSTMENTS INCLUDE THE COST OF REMOVAL AND REPLACEMENT OF NEW PULL BOXES FOR WATER METERS, WATER VALVES, AND SEWER CLEAN OUTS. CONTRACTOR IS RESPONSIBLE FOR PROCUREMENT AND INVENTORY OF ALL UTILITY PULL BOXES PRIOR TO CONSTRUCTION. COST OF PULL BOXES ARE INCIDENTAL AND INCLUDED IN THE COST OF THE UTILITY ADJUSTMENT, (PAY ITEM #425-6). CONTRACTOR MUST COORDINATE WITH THE CITY OF KEY WEST FOR THE NECESSARY PULL BOX INVENTORY TO BEGIN WATER METER AND WATER VALVE (FKAA) ADJUSTMENTS.
- 9. THE CONTRACTOR SHALL DETERMINE THE EXACT LOCATION AND ELEVATION IN THE FIELD PRIOR TO INSTALLING ANY NEW WORK THAT CROSSES OR CONNECTS TO EXISTING UTILITY SYSTEMS. LOCATIONS OF NEW UTILITIES SHALL BE ADJUSTED IN A MANNER APPROVED BY THE ENGINEER TO AVOID CONFLICTS. DAMAGES TO UTILITIES RESULTING FROM THE CONTRACTOR'S OPERATIONS SHALL BE REPAIRED BY THE CONTRACTOR AT NO COST TO THE CITY.
- 10. ALL CONCRETE SIDEWALK JOINTS SHALL BE TOOLED WITHOUT EXPANSION JOINTS. EXPANSION MATERIAL MUST BE PLACED AT ALL EXISTING CONCRETE INTERFACES AND FORM MATERIAL MUST BE USED TO ACT AS BUFFER WITH ANY OTHER OBSTRUCTIONS, (WOOD FENCES. RAILING, GATES, ETC.) AT BACK OF SIDEWALK. CONTRACTOR IS RESPONSIBLE FOR ANY DAMAGE THAT OCCURS TO ANY EXISTING RIGHT-OF-WAY LINE FEATURES (WALLS, GATES, FENCES, ETC.) WHEN REMOVING THE CONCRETE SIDEWALK OR DRIVEWAYS. RIGHT-OF-WAY LINE FEATURES MUST BE REPLACED OR REPAIRED TO THE EXISTING CONDITION PRIOR TO SIDEWALK REMOVAL.
- 11. CONTRACTOR WILL BE RESPONSIBLE FOR NOTIFYING AND RECEIVING CONSENT FROM PRIVATE RESIDENTS AND/OR BUSINESS OWNERS FOR THE GRADE HARMONIZATION OF THEIR DRIVEWAYS. GRADE HARMONIZATION IS INCIDENTAL AND INCLUDED IN THE COST OF THE CONCRETE, (PAY ITEM #522-2), THIS INCLUDES BUT IS NOT LIMITED TO THE REMOVAL AND REPLACEMENT OF BRICK PAVERS AND/OR CONCRETE NECESSARY TO MAKE FINISH PRODUCT SATISFACTORY AND AS DIRECTED BY THE ENGINEER.

Karen.Falkenberry@jacobs.com

- 12. THE CONTRACTOR SHALL SEQUENCE OPERATIONS SUCH THAT ORANGE MESH SAFETY FENCING IS PROVIDED ALONG ALL AREAS BEING TRENCHED AND NO TRENCH IS LEFT OPEN AT THE END OF THE WORK DAY. THE LOCATIONS IDENTIFIED IN THESE ROADWAY PLANS AS "PAVEMENT RESTORATION AREA" WILL FOLLOW CITY DETAIL NO. 21 FAILED TRENCH RESTORATION. EXACT LOCATIONS OF FAILED TRENCH REPAIR TO BE FIELD DETERMINED.
- 13. CONTRACTOR SHALL REMOVE AND REPLACE ALL EXISTING FEATURES, (GARBAGE CANS, PAY TO PARK CONSOLES, SIGNAGE, AND BENCHES) WITHIN RECONSTRUCTED SIDEWALK OR AS DIRECTED BY THE ENGINEER. CONTRACTOR TO REMOVE AND TEMPORARILY STORE EXISTING PARKING METERS. CONTRACTOR SHALL COORDINATE WITH THE CITY OF KEY WEST PARKING DIRECTOR, JOHN WILKINS (305-809-3855) FOR PICK-UP OF REMOVED PARKING METERS WITHIN 24 HOURS. CONTRACTOR SHALL COORDINATE WITH THE CITY FOR OBTAINING AND INSTALLATION OF PAY TO PARK CONSOLE BASE PLATE IN AREAS WHERE EXISTING PARKING METERS ARE REMOVED. COST OF REMOVAL AND REPLACEMENT OF EXISTING FEATURES AND REMOVAL AND STORAGE OF EXISTING PARKING METERS, AND INSTALLATION OF PAY TO PARK CONSOLE BASE PLATE AND SIGN POST IS INCIDENTAL AND INCLUDED IN THE COST OF THE CONCRETE, (PAY ITEM # 522-1).
- 14. CONTRACTOR TO REMOVE PAY STATION AND STORE FOR REINSTALLATION; FINAL LOCATION TO BE REVIEWED IN FIELD WITH CITY PRIOR TO REINSTALLATION.
- 15. ALL ITEMS INDICATING TO BE REMOVED OR DEMOLISHED SHALL BE REVIEWED WITH THE OWNER TO DETERMINE IF THE ITEM IS TO BE PROPERTY OF THE CONTRACTOR. HISTORIC GRANITE CURBS THAT ARE PROPOSED TO BE REMOVED/REPLACED SHALL BE PROVIDED TO THE CITY FOR PLACEMENT IN CITY STORAGE.
- 16. CONTRACTOR IS RESPONSIBLE FOR THE REMOVAL, NEAT STACKING, AND SECURE STORAGE OF HISTORICAL GRANITE CURB THROUGHOUT PROJECT. CONTRACTOR IS RESPONSIBLE FOR COORDINATING PICK UP OF THE GRANITE CURB BY THE CITY OF KEY WEST AND SHALL NOTIFY CITY OF KEY WEST WITHIN 24 HOURS OF THE REMOVAL OF THE GRANITE CURB, COST FOR REMOVAL, STACKING, AND SECURE STORAGE IS INCIDENTAL AND INCLUDED IN THE COST OF THE CONCRETE REMOVAL, (PAY ITEM# 110-4-10).
- 17. EXISTING ELEVATIONS ARE SHOWN IN THE PLANS AS " EL XX.XX ±" FOR REFERENCE. THESE ELEVATIONS WERE OBTAINED FROM SURVEY DATA AND SHOULD BE FIELD-CONFIRMED. DESIGN INTENT IS TO PROVIDE POSITIVE DRAINAGE FLOW.
- 18. ADDITIONAL GENERAL NOTES ARE PROVIDED ON SIGNING AND PAVEMENT MARKING PLANS (SHEET S-5).
- 9. THE CONTRACTOR IS RESPONSIBLE TO VERIFY AND/OR OTHERWISE SATISFY HIMSELF THAT THE QUANTITIES SHOWN IN THE PLAN SET ARE ACCURATE. ANY DISCREPANCIES SHOULD BE BROUGHT TO THE ATTENTION OF THE CITY OF KEY WEST IMMEDIATELY AND PRIOR TO BEGINNING CONSTRUCTION.
- 20. ALL WORK ASSOCIATED WITH THIS PROJECT IS TO BE PERFORMED WITHIN THE RIGHT-OF-WAY LIMITS AS DEPICTED ON THE PLAN SHEETS, OR AS DIRECTED BY THE CITY OF KEY WEST.
- 21. ANY PUBLIC LAND CORNER WITHIN THE LIMITS OF CONSTRUCTION IS TO BE PROTECTED. IF A CORNER MONUMENT IS IN DANGER OF BEING DESTROYED AND HAS NOT BEEN PROPERLY REFERENCED, THE CONTRACTOR SHOULD NOTIFY THE CITY OF KEY WEST WITHOUT DELAY.
- 22. SIDEWALK AND CURBING TO REMAIN SHALL BE PRESSURE WASHED.

EROSION CONTROL NOTES

- 1. EROSION, SEDIMENT, AND TURBIDITY CONTROL MEASURES SHALL BE PROVIDED THROUGHOUT CONSTRUCTION. THE CONTRACTOR IS RESPONSIBLE FOR MAINTAINING AND REPAIRING ALL SLOPES AND SURFACES THROUGHOUT CONSTRUCTION AND UNTIL A STABLE SURFACE CONDITION EXISTS. THE CONTRACTOR SHALL MINIMIZE THE EXPOSED AREA AT ANY POINT DURING CONSTRUCTION AS MUCH AS PRACTICAL.
- 2. FILTER FABRIC SILT FENCE SHALL BE IN CONFORMANCE WITH SECTION 985, FDOT SPECIFICATION.
- 3. PROVIDE EROSION CONTROL MEASURES AS NECESSARY TO AVOID ADVERSE IMPACTS TO JURISDICTIONAL AREAS (WETLANDS OR WATER BODIES) AND OFF-SITE LANDS AND WATER BODIES. MAINTAIN THESE MEASURES DAILY UNTIL CONSTRUCTION ACCEPTANCE BY THE OWNER AND THEN REMOVE AND LEGALLY DISPOSE OF SAID MEASURES.
- 4. EROSION CONTROL SHALL BE MAINTAINED WITHIN CONSTRUCTION AREA BY QUICKLY STABILIZING DISTURBED AREA TO PREVENT THE RELEASE OF SEDIMENT. THIS SHALL BE ACCOMPLISHED USING GRASS COVER, HAY BALES AND OTHER MEANS ACCEPTABLE TO OWNER, ENGINEER AND REGULATORY AGENCIES.
- 5. ALL SURFACE WATER DISCHARGE FROM SITE, INCLUDING DEWATERING DISCHARGE, SHALL MEET STATE WATER QUALITY STANDARDS (LESS THAN 29 NTU ABOVE BACKGROUND) PRIOR TO REACHING ANY WATER OF THE STATE INCLUDING WETLAND.
- 6. IN THE EVENT THAT THE EROSION PREVENTION AND CONTROL DEVICES SHOWN IN THESE PLANS PROVE NOT TO BE EFFECTIVE, ALTERNATE METHODS FOR MAINTAINING STATE WATER QUALITY STANDARDS FOR DISCHARGE FROM THE CONSTRUCTION SITE WILL BE REQUIRED. ANY ALTERNATE EROSION PREVENTION AND CONTROL DEVICES MUST BE APPROVED BY THE CITY OF KEY WEST.

TRAFFIC CONTROL NOTES

- 1. THE CONTRACTOR SHALL DEVELOP A DETAILED MAINTENANCE OF TRAFFIC PLAN BASED ON THE SITE SPECIFIC MEANS AND METHODS OF CONSTRUCTION. THE DETAILED PLANS SHALL BE SUBMITTED FOR REVIEW AND APPROVAL BY THE CITY PRIOR TO ANY CONSTRUCTION ACTIVITIES. TRAFFIC PLAN SHALL BE IN CONFORMANCE WITH FDOT STANDARD PLANS 102-600 SERIES.
- 2. TEMPORARY TRAVEL LANES SHALL BE 10 FEET MINIMUM WIDTH
- 3. ACCESS TO ALL SIDE STREETS AND DRIVEWAYS MUST BE PROVIDED AND MAINTAINED DURING CONSTRUCTION. ACCESS TO BUSINESS ENTRANCES SHALL BE MAINTAINED DURING SIDEWALK CONSTRUCTION. COORDINATE WITH THE NAVAL AIR STATION KEY WEST TO ENSURE ACCESS IS MAINTAINED AT ALL TIMES TO THE GATE AT THE WEST END OF UNITED STREET AT WHITEHEAD STREET.
- 4. PEDESTRIAN, BICYCLE, BUS AND TROLLEY ACCESS SHALL BE MAINTAINED OR DETOURED.
- 5. EXISTING SIGNALIZATION SHALL REMAIN IN PLACE TO THE EXTENT POSSIBLE. IMPACTS TO SIGNAL LOOPS SHALL BE COORDINATED WITH THE MAINTAINING AGENCY.
- 6. RESURFACING SHALL BE PERFORMED ON THE SAME DAY AS MILLING AND POSITIVE DRAINAGE SHALL BE PROVIDED AT ALL TIMES. IF MILLING OPERATIONS CEASE FOR ANY REASON, THE CONTRACTOR SHALL BE RESPONSIBLE FOR THE PROTECTION OF THE REMAINING ASPHALT AND BASE.
- 7. WORK HOURS ARE FROM 8:00 AM TO 5:00 PM, MONDAY- FRIDAY. WORK WILL NOT BE ALLOWED ON WEEKENDS OR HOLIDAYS OBSERVED BY THE CITY OF KEY WEST UNLESS WRITTEN APPROVAL IS OBTAINED FROM THE CITY.
- 8. ALL TRAFFIC CONTROL SIGNS SHALL BE IN ACCORDANCE WITH FDOT INDEX 102-600 SHEET 6 OF 11. PLYWOOD CONTRACTOR FABRICATED SIGNAGE WILL NOT BE ALLOWED.
- D. MAINTAIN THE EXISTING POSTED SPEED OF 20 MPH DURING CONSTRUCTION.

REVISIONS

DATE DESCRIPTION DATE DESCRIPTION

DATE DESCRIPTION

P.E. LICENSE NUMBER 54015

JACOBS ENGINEERING GROUP, INC.
200 W. FORSYTH ST, STE 1520

JACKSONVILLE, FL 32202



TASK ORDER 9-22


PROJECT: SOUTH STREET IMPROVEMENTS GENERAL NOTES

SHEET NO.


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- 1. TOPOGRAPHIC ROUTE SURVEY (PART 6) INCLUDES A TREE TABULATION WITH TREE SPECIES AND TRUNK DIAMETER.
- 2. TREE PROTECTION AND PRESERVATION INCLUDING TRUNK AND ROOT PRESERVATION SHALL BE IN ACCORDANCE WITH FDOT STANDARD PLANS INDEX 110-100.
- 3. THE GENERAL CONTRACTOR SHALL CONSULT WITH AN ISA CERTIFIED ARBORIST REGARDING THE CONDITION OF THE EXISTING TREES AND PALMS AND SHALL HIRE AN ISA CERTIFIED ARBORIST TO PERFORM TREE CARE THAT MAY BE NEEDED TO MITIGATE RISKS PRIOR TO AND DURING CONSTRUCTION.
- 4. GENERAL CONTRACTOR IS RESPONSIBLE FOR COORDINATING A MEETING WITH ISA CERTIFIED ARBORIST AND CITY OF KEY WEST URBAN FORESTRY MANAGER TO REVIEW TREE PROTECTION MEASURES PRIOR TO CONSTRUCTION COMMENCING.
- 5. FLEXIBLE POROUS PAVEMENT TO BE REPLACED AT TREE SITES AS SHOWN IN PLANS. COLOR TO BE APPROVED BY THE CITY.
- 6. ALL UNDERGROUND UTILITIES AND DRAIN OR IRRIGATION LINES SHALL BE ROUTED OUTSIDE THE TREE PROTECTION ZONE. IF LINES MUST TRAVERSE THE PROTECTION AREA, THEY SHALL BE TUNNELED OR BORED UNDER THE TREE.
- 7. NO CONSTRUCTION MATERIALS, EQUIPMENT, SPOIL, OR WASTE OR WASHOUT WATER MAY BE DEPOSITED, STORED, OR PARKED WITHIN THE TREE PROTECTION ZONE (FENCED AREA).
- 8. IF INJURY SHOULD OCCUR TO ANY TREE DURING CONSTRUCTION, THE GENERAL CONTRACTOR IS RESPONSIBLE FOR NOTIFYING THE CITY OF KEY WEST URBAN FORESTER, ISA CERTIFIED ARBORIST, LANDSCAPE ARCHITECT AND LANDSCAPE CONTRACTOR AS SOON AS POSSIBLE SO THAT APPROPRIATE TREATMENTS CAN BE APPLIED.
- 9. ADDITIONAL TREE PRUNING THAT MAY BE REQUIRED FOR CLEARANCE DURING CONSTRUCTION SHALL BE APPROVED BY CITY OF KEY WEST URBAN FORESTRY MANAGER AND PERFORMED BY AN ISA CERTIFIED ARBORIST AS PER ANSI A-300 STANDARDS.
- 10. EROSION CONTROL DEVICES SUCH AS SILT FENCING, DEBRIS BASINS, AND WATER DIVERSION STRUCTURES SHALL BE INSTALLED TO PREVENT SILTATION AND/OR EROSION WITHIN THE TREE PROTECTION ZONE.
- 11. BEFORE GRADING, PAD PREPARATION, OR EXCAVATION FOR FOUNDATIONS, FOOTINGS, WALLS, SIDEWALKS, CURBS OR TRENCHING NEAR TREES THE TREES SHALL BE ROOT PRUNED 12 INCHES OUTSIDE THE TREE PROTECTION ZONE BY CUTTING ALL ROOTS CLEANLY TO A DEPTH OF 36 INCHES. ROOTS SHALL BE CUT MANUALLY BY DIGGING A TRENCH AND CUTTING EXPOSED ROOTS WITH A SAW, VIBRATING KNIFE, ROCK SAW, NARROW TRENCHER WITH SHARP BLADES, OR OTHER APPROVED ROOT-PRUNING EQUIPMENT.
- 12. ANY ROOTS DAMAGED DURING GRADING OR CONSTRUCTION SHALL BE EXPOSED TO SOUND TISSUE AND CUT CLEANLY WITH A SAW.
- 13. SPOIL FROM TRENCHES, BASEMENTS, OR OTHER EXCAVATIONS SHALL NOT BE PLACED WITHIN THE TREE PROTECTION ZONE, EITHER TEMPORARILY OR PERMANENTLY.
- 14. NO BURN PILES OF DEBRIS PITS SHALL BE PLACED WITHIN THE TREE PROTECTION ZONE. NO ASHES, DEBRIS OR GARBAGE MAY BE DUMPED OR BURIED WITHIN THE TREE PROTECTION ZONE.
- 15. MAINTAIN FIRE-SAFE AREAS AROUND FENCED TREE PROTECTION AREAS, NO HEAT SOURCES, FLAMES, IGNITION SOURCES OR SMOKING ARE ALLOWED NEAR MULCH OR TREES.
- 16. ABBREVIATION ON LANDSCAPE TABLE: o.a. = OVERALL HEIGHT



CITY STD. PALM PLANTING DETAIL

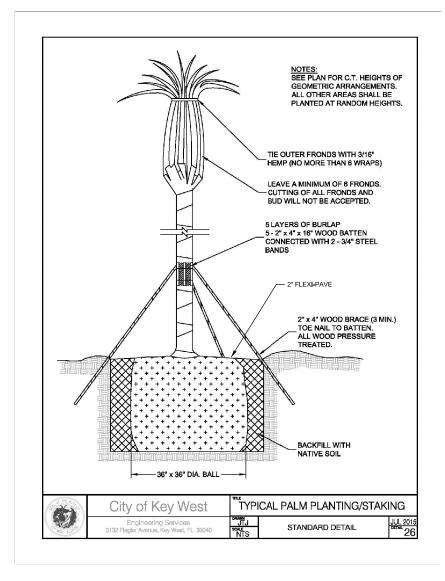

CITY STD. TREE PLANTING DETAIL

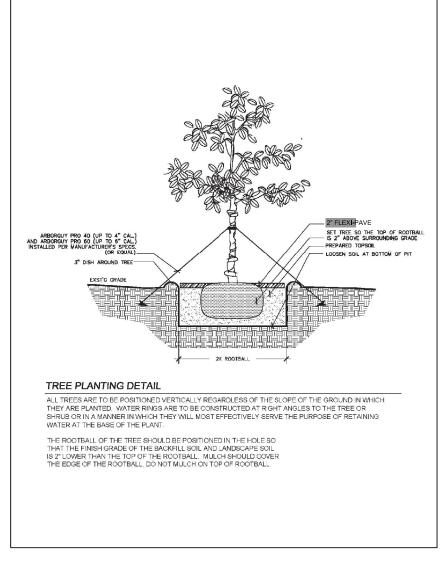REVISIONS

DATE DESCRIPTION DATE DESCRIPTION

DATE DESCRIPTION

P.E. LICENSE NUMBER 54015

JACOBS ENGINEERING GROUP, INC.
200 W. FORSYTH ST, STE 1520

JACKSONVILLE, FL 32202




TASK ORDER 9-22

PROJECT:

SOUTH STREET IMPROVEMENTS


TREE PROTECTION NOTES

SHEET NO. OFFICIAL RECORD OF THIS SHEET IS THE ELECTRONIC FILE DIGITALLY SIGNED

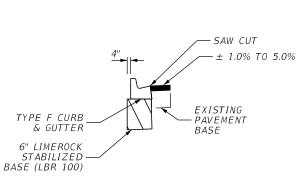

NOTE: SEE PLAN VIEW FOR LOCATIONS.

LT CURB AND **GUTTER DETAIL** (AT BULB OUTS)

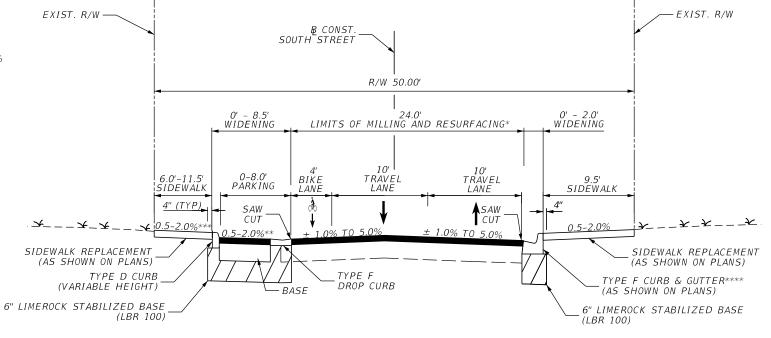

TYPICAL SECTION STATIONING FROM & SURVEY SOUTH STREET STA. 104+27.58 TO STA. 124+44.18

WIDENING (TYPICAL) (AS SHOWN IN PLANS)

LIMEROCK STABILIZED BASE (LBR 100) (6.0") OPTIONAL BASE GROUP 6 (TYPE B-12.5) (5.0") 1 LAYER OF TENSAR GLASGRID CG SYSTEM ON BASE AFTER PRIME/TACK COAT TYPE SP 9.5 STRUCTURAL COURSE (TRAFFIC B) (1.5") TYPE SP 9.5 STRUCTURAL COURSE FOR LEVELING (TRAFFIC B) (1.0")

MILLING

MILL EXISTING ASPHALT PAVEMENT FOR DEPTH (2.0")

RESURFACING

1 LAYER OF TENSAR GLASGRID CG SYSTEM ON MILLED SURFACE AFTER PRIME/TACK COAT TYPE SP 9.5 STRUCTURAL COURSE (TRAFFIC B) (1.0") TYPE SP 9.5 STRUCTURAL COURSE FOR LEVELING (TRAFFIC B) (1.0")

REVISIONS KAREN E. FALKENBERRY, P.E DESCRIPTION DESCRIPTION DATE DATE P.E. LICENSE NUMBER 54015 JACOBS ENGINEERING GROUP, INC. 200 W. FORSYTH ST, STE 1520 JACKSONVILLE, FL 32202



TASK ORDER 9-22

PROJECT: SOUTH STREET IMPROVEMENTS

TYPICAL SECTION NOTES

THE TYPICAL SECTIONS SHOWN MAY NOT BE REPRESENTATIVE OF THE ACTUAL CONDITIONS AT ALL LOCATIONS ON THE PROJECT. VARIABLE

CONDITIONS SHALL BE ADJUSTED AS DIRECTED

THE CONTRACTOR MAY ENCOUNTER ISOLATED AREAS OF ASPHALT LESS THAN THE MILLING DEPTH. IN THESE LOCATIONS THE CONTRACTOR SHALL MILL TO THE SURFACE OF THE BASE AND RESURFACE TO MAINTAIN POSITIVE DRAINAGE.

EXISTING GRANITE CURB TO BE REMOVED AND PRESERVED AS INDICATED ON GENERAL NOTES.

LIMEROCK MAY BE ENCOUNTERED DURING MILLING.

PERFORM CORRECTIVE MILLING ON BOTH LANES OF SOUTH STREET AT 5.0% CROSS-SLOPE WITH THE EXCEPTIONS LISTED ABOVE.

SHEET NO.

TYPICAL SECTION (1)

c:\users\kfalkenb\appdata\local\bentley\projectwise\jacobs-americas-01\dms89931\TYPSRD01.dgn

* EXCEPTIONS FOR 5.0% CORRECTIVE MILLING:

** SLOPE IS 1.0% IN MOST PLACES. STATIONS WHERE WIDENING PAVEMENT SLOPE VARIES

STA 107+71.06: TRANSITION TO 1.0% STA. 124+36.49: TRANSITION TO 4.0%

STA. 109+40.28: TRANSITION TO 2.0% STA. 114+73.07: TRANSITION TO 0.5%

STA. 119+01.99: TRANSITION TO 0.5%

*** SIDEWALK SLOPE IS 1.0% IN MOST PLACES. STATIONS WHERE SLOPE VARIES FROM 1.0%:

STA. 107+71.06: TRANSITION TO 2.0% STA. 108+04.82: TRANSITION TO 2.0% STA. 109+40.28: TRANSITION TO 2.0% STA. 111+10.55: TRANSITION TO 0.5% STA. 114+73.07: TRANSITION TO 0.5%

STA. 119+01.99: TRANSITION TO 0.5%

**** THE TYPE F CURB ON THE RT SIDE WILL VARY BETWEEN DROP CURB AND FULL HEIGHT CURB.

Karen.Falkenberry@jacobs.com

= 2022 AADT = 2.746

ESTIMATED OPENING YEAR = 2024 AADT = 2,773 ESTIMATED DESIGN YEAR = 2044 AADT = 3,313

T = 4.7% (24 HOUR)

CURRENT YEAR

DESIGN SPEED = 25 MPH

* CROSS-SLOPE VARIES AS FOLLOWS:

 STA. 302+33.30:
 2%

 STA. 302+50.00:
 2%

 STA. 303+00.00:
 2%

 STA. 303+50.00:
 2%

 STA. 304+50.00:
 2%

 STA. 305+00.00:
 2%


 STA. 305+50.00:
 2%

 STA. 305+50.00:
 2%

 STA. 305+50.00:
 2%

 STA. 306+25.00:
 5%


 STA. 306+26.22:
 5%

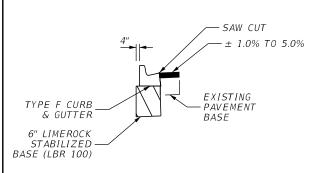

NOTE: SEE PLAN VIEW FOR LOCATIONS.

LT CURB AND GUTTER DETAIL (AT BULB OUTS)

Karen.Falkenberry@jacobs.com

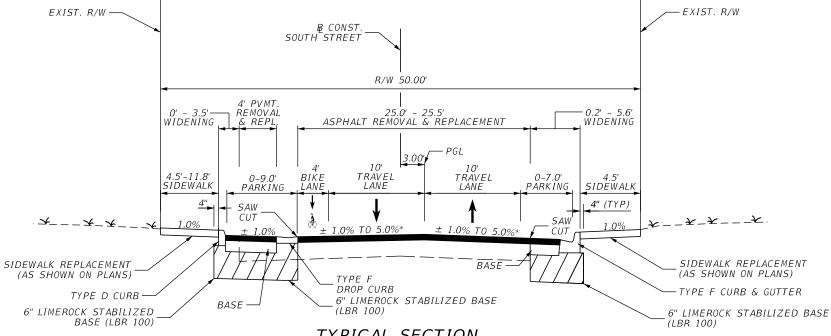

TYPICAL SECTION

STATIONING FROM & SURVEY SOUTH STREET

STA. 124+44.18 TO STA. 125+13.83

STATIONING FROM & SURVEY REYNOLDS STREET

STA. 301+75.19 TO STA. 306+26.22

WIDENING (TYP.) (AS SHOWN IN PLANS)

LIMEROCK STABILIZED BASE (LBR 100) (6.0")

OPTIONAL BASE GROUP 6 (8")

1 LAYER OF TENSAR GLASGRID CG SYSTEM

ON LIMEROCK SURFACE (AFTER PRIME COAT)

TYPE SP 9.5 STRUCTURAL COURSE (TRAFFIC B) (1.0")

TYPE SP 9.5 STRUCTURAL COURSE FOR LEVELING (TRAFFIC B) (1.0")

PAVEMENT REPLACEMENT

OPTIONAL BASE GROUP 6 (8") (AS NEEDED)

1 LAYER OF TENSAR GLASGRID CG SYSTEM ON LIMEROCK SURFACE AFTER PRIME COAT

TYPE SP 9.5 STRUCTURAL COURSE (TRAFFIC B) (1.0")

TYPE SP 9.5 STRUCTURAL COURSE FOR LEVELING (TRAFFIC B) (1.0")

TYPICAL SECTION NOTES

- 1. THE TYPICAL SECTIONS SHOWN MAY NOT BE REPRESENTATIVE OF THE ACTUAL CONDITIONS AT ALL LOCATIONS ON THE PROJECT. VARIABLE CONDITIONS SHALL BE ADJUSTED AS DIRECTED BY THE ENGINEER.
- 2. THE CONTRACTOR MAY ENCOUNTER ISOLATED AREAS OF ASPHALT LESS THAN THE MILLING DEPTH. IN THESE LOCATIONS THE CONTRACTOR SHALL MILL TO THE SURFACE OF THE BASE AND RESURFACE TO MAINTAIN POSITIVE DRAINAGE.
- 3. EXISTING GRANITE CURB TO BE REMOVED AND PRESERVED AS INDICATED ON GENERAL NOTES.
- 4. LIMEROCK MAY BE ENCOUNTERED DURING MILLING.

	REVI	KAREN E. FALKENBERRY, P.E.		
DATE	DESCRIPTION	DATE	DECCRIPTION	P.E. LICENSE NUMBER 54015
				1
				JACOBS ENGINEERING GROUP, INC
				200 W. FORSYTH ST, STE 1520
				JACKSONVILLE, FL 32202
				· '




TYPICAL SECTION (2)

SHEET NO.


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CROSS SLOPE OF PROPOSED SIDEWALK SHALL BE 0.5% MIN. AND 2.0% MAX. THE CONTRACTOR MAY MODIFY THE VERTICAL HEIGHT OF THE CURB AS SHOWN IN "MODIFIED TYPE F C&G" AND "MODIFIED TYPE D CURB" TO ENSURE POSITIVE DRAINAGE TOWARD THE GUTTER.


GENERALLY THE CONTRACTOR SHALL MATCH EXISTING GROUND ELEVATIONS AT THE BACK OF SIDEWALK. WITH APPROVAL OF THE ENGINEER, THE CONTRACTOR MAY COORDINATE WITH THE ADJACENT PROPERTY OWNER TO MAKE ADJUSTMENTS TO HARMONIZE AT OR BEYOND THE R/W LINE.

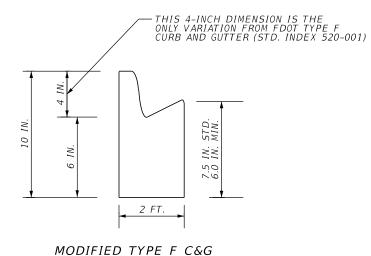

MODIFIED TITE I CQU

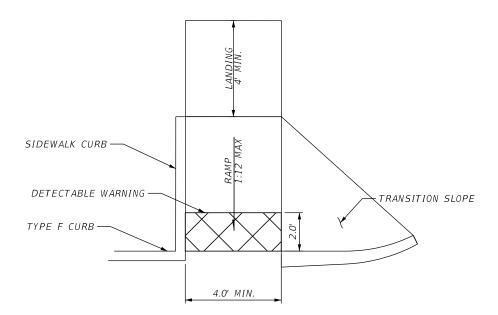

MODIFIED CR-A CURB RAMP

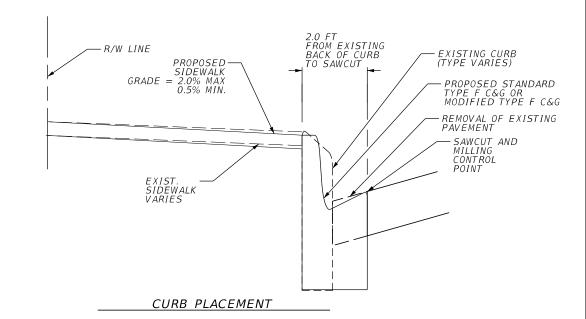

	REV I.	KAREN E. FALKENBERRY, P.E.		
DATE	DESCRIPTION	DATE	DECCRIPTION	P.E. LICENSE NUMBER 54015
				JACOBS ENGINEERING GROUP, INC
				200 W. FORSYTH ST, STE 1520
				JACKSONVILLE, FL 32202




TASK ORDER 9-22

PROJECT: SOUTH STREET IMPROVEMENTS DETAILS (1)

SHEET NO.

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1/28/2024 6:02:03 PM TYPICAL SECTION DETAILS [Sheet]

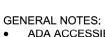

ADA ACCESSIBILITY GUIDELINES APPLY

- USE 3,000 PSI CONCRETE MIN.
- NO DRIVEWAY SHALL BE LOCATED WITHIN 25' OF AN INTERSECTION
- **OBTAIN CITY RIGHT OF WAY PERMIT**
- HAVE CONTRACTOR COORDINATE WITH CITY

- ONSITE PARKING SPACE IS REQUIRED TO BE 18' LONG (MIN.) MEASURED FROM THE PROPERTY LINE
- CONTRACTOR MUST COMPLY WITH TYPICAL CITY DESIGNS
- CITY RETAINS THE RIGHT TO MODIFY **DESIGN BASED ON FIELD CONDITIONS**

CONSTRUCTION REQUIREMENTS (IF APPLICABLE):

4" CONCRETE

- UTILITY ADJUSTMENT OR RELOCATION

OWNER RESPONSIBILITIES:

- WILL VERIFY 18' ONSITE DRIVEWAY DEPTH REQUIREMENT
- COMPLY WITH CITY LOT PERVIOUS REQUIREMENTS
- OBTAIN HARC APPROVAL (IF LOCATED IN OLD TOWN)
- **OBTAIN CITY RIGHT OF WAY PERMIT**
- HAVE CONTRACTOR COORDINATE WITH CITY

DRIVEWAY APRON - RESIDENTIAL

DRIVEWAY APRON - COMMERCIAL

TRANSITION TO EXISTING

SIDEWALK

S/W NOT TO

EXCEED 1:50

SLOPE

VARIES (3.0' MIN.)

TRANSITION -

TO EXISTING

SIDEWALK

4" CONCRETE

6" CONCRETE -

12.0'/24.0' MAX (SINGLE/DOUBLE)

(OR AS INDICATED)

VARIES

(1:20 RUNNING

SLOPE MAX)

VARIES

(1:12 MAX

FOR FLARE)

EXPANSION

JOINT

MATERIAL

THICKENED

EDGE

	REV	KAREN E. FALKENBERRY, P.E.		
DATE	DESCRIPTION	DATE	DESCRIPTION	P.E. LICENSE NUMBER 54015
				JACOBS ENGINEERING GROUP, INC. 200 W. FORSYTH ST, STE 1520 JACKSONVILLE, FL 32202



TASK ORDER 9-22

PROJECT: SOUTH STREET IMPROVEMENTS DETAILS (2)

SHEET NO.

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Karen.Falkenberry@jacobs.com

1/28/2024 6:02:40 PM Unnamed Plan-1 - DRIVEWAY DETAILS-1 [Sheet]

ASPHALT UTILITY TRENCH

- 1. BACKFILL MATERIAL SHALL CONSIST OF #57 STONE, FLOWABLE FILL, OR OTHER APPROVED BACKFILL MATERIAL. IF FLOWABLE FILL IS USED IT SHALL HAVE A MINIMUM RATING OF 500 PSI.
- 2. BACKFILL MATERIAL SHALL BE COMPACTED TO 95% STANDARD PROCTOR AND SHALL GENERALLY BE COMPACTED IN 6" LIFTS WITH A VIBRATORY COMPACTOR.
- 3. ALL TRENCH RESTORATION WORK SHALL COMPLY WITH THE FLORIDA DEPARTMENT OF TRANSPORTATION (FDOT) DESIGN STANDARDS FOR TRENCH CUTS AND RESTORATIONS ACROSS ROADWAYS (INDEX 125-001)
- 4. THE FDOT STANDARD SPECIFICATIONS FOR ROAD AND BRIDGE CONSTRUCTION, LATEST EDITION SHALL APPLY FOR ALL RESTORATION WORK.
- 5. ADJUST ALL EXISTING METER BOXES AND MANHOLE RINGS IMPACTED BY CONSTRUCTION.

TRENCH RECONSTRUCTION

	REV	KAREN E. FALKENBERRY, P.E.		
DATE	DESCRIPTION	DATE	DESCRIPTION	P.E. LICENSE NUMBER 54015
				JACOBS ENGINEERING GROUP, INC.
				200 W. FORSYTH ST, STE 1520
				JACKSONVILLE, FL 32202
				JACKSONVILLE, FL 32202




TASK ORDER 9-22

PROJECT: SOUTH STREET IMPROVEMENTS DETAILS (3)

SHEET NO.


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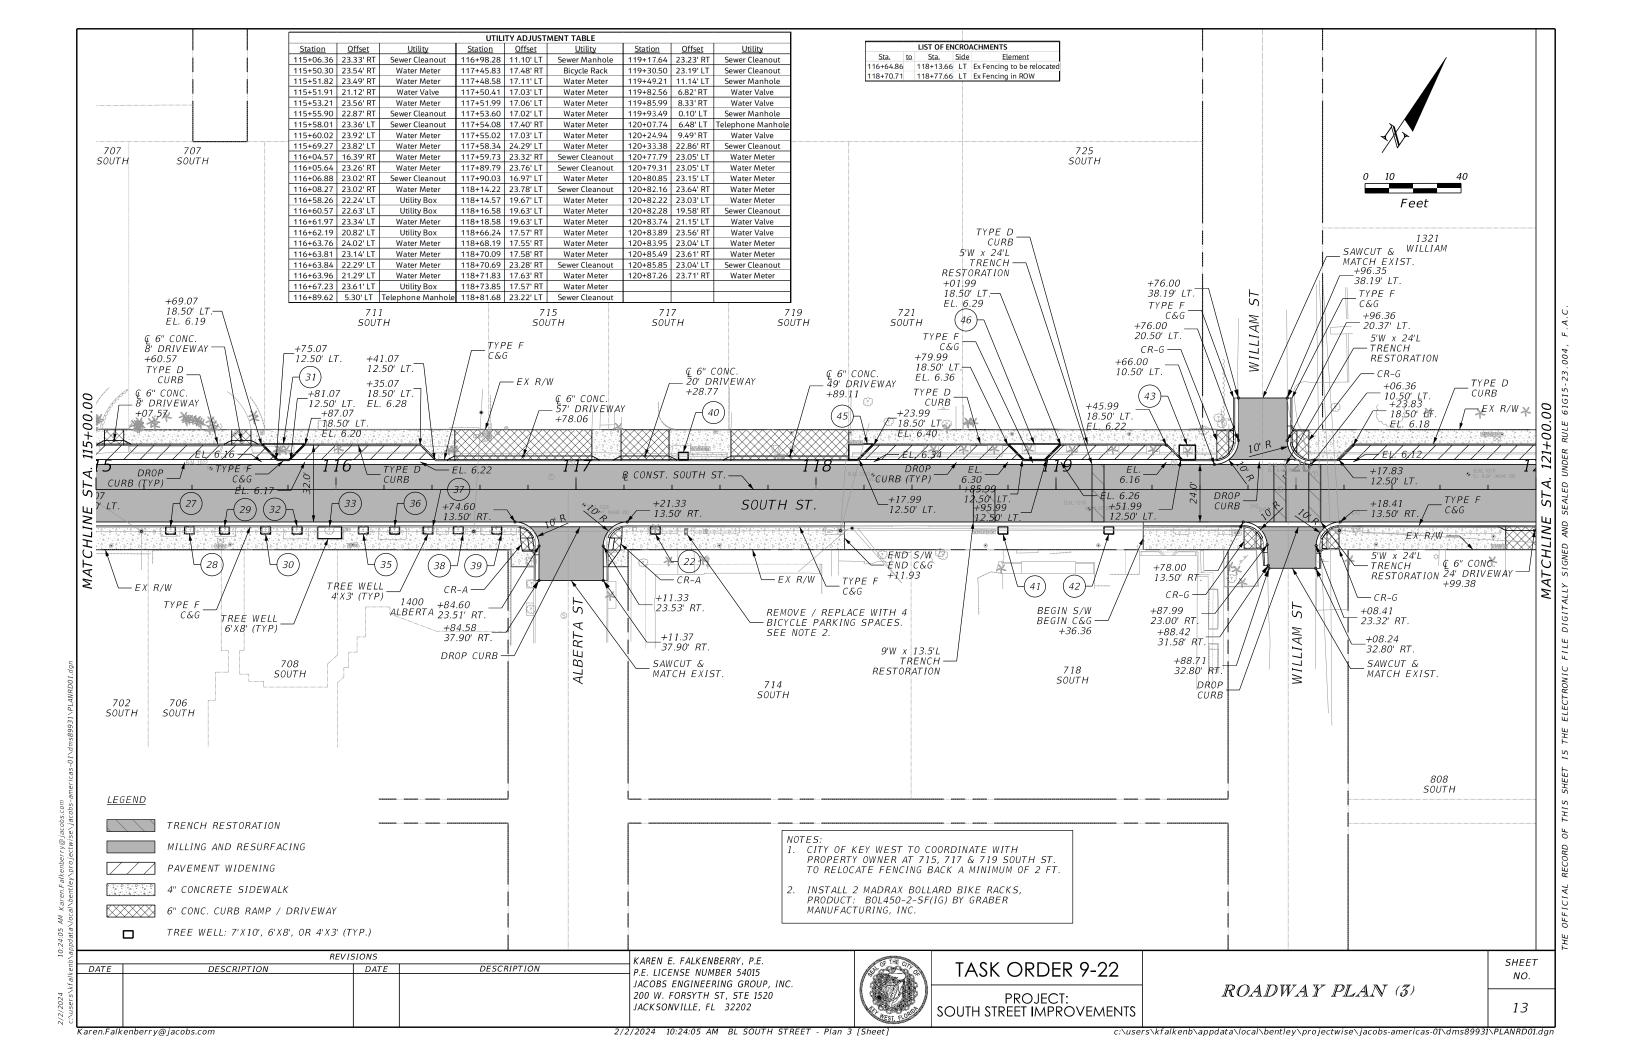
Karen.Falkenberry@jacobs.com

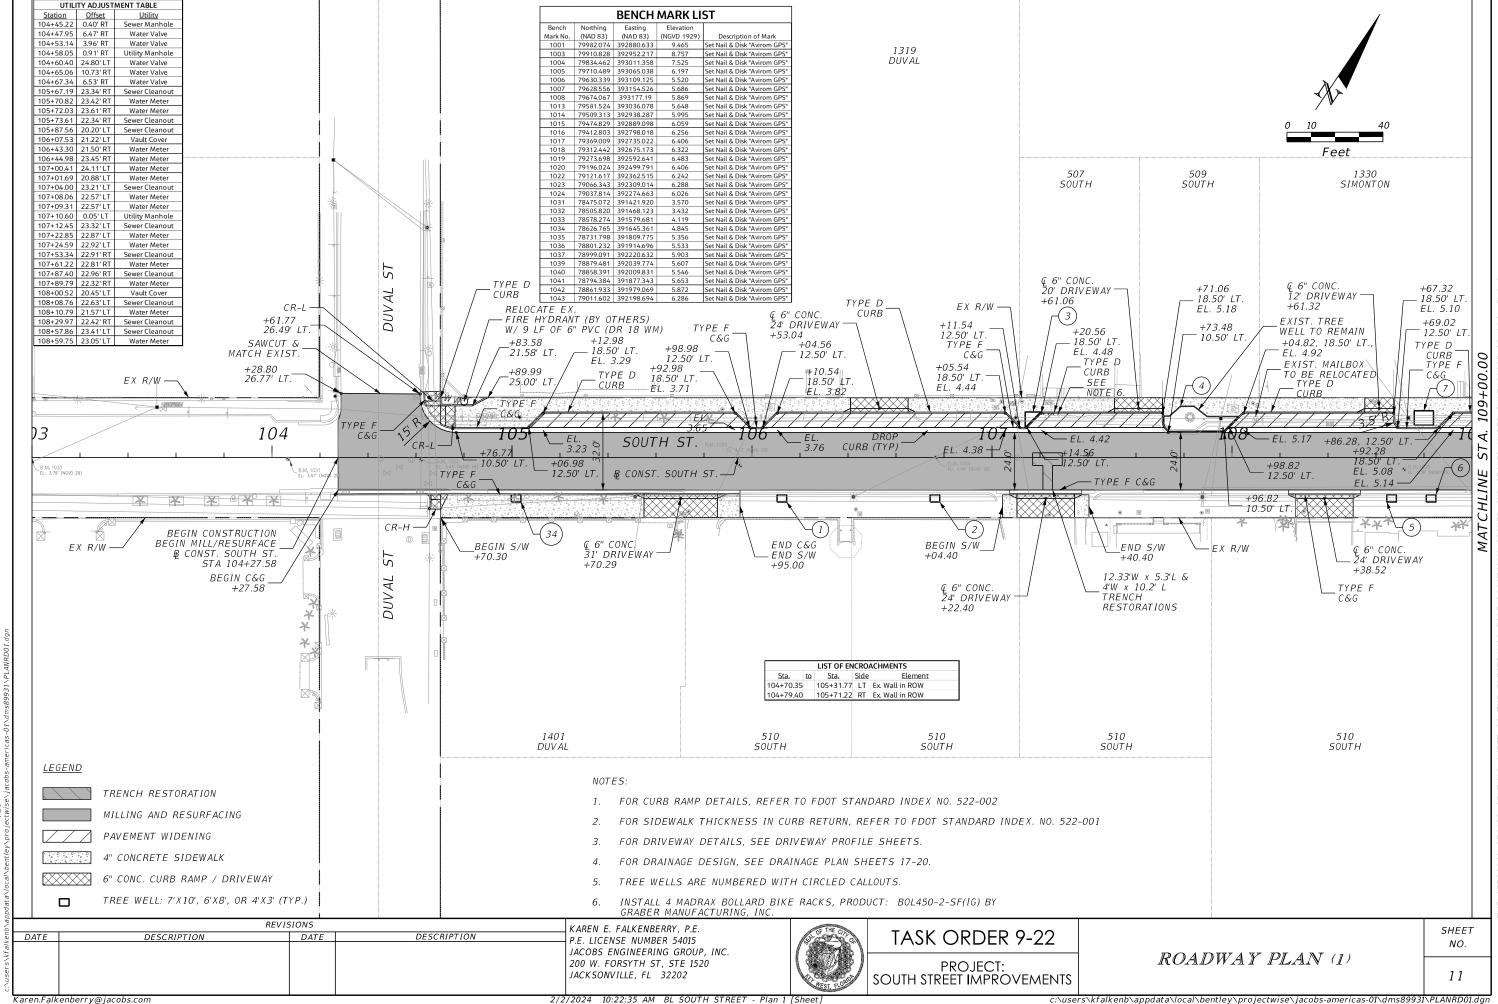



2/2/2024 10:22:35 AM BL SOUTH STREET - Plan 1 [Sheet]

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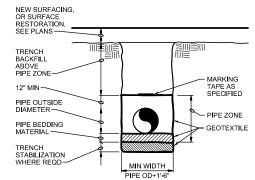




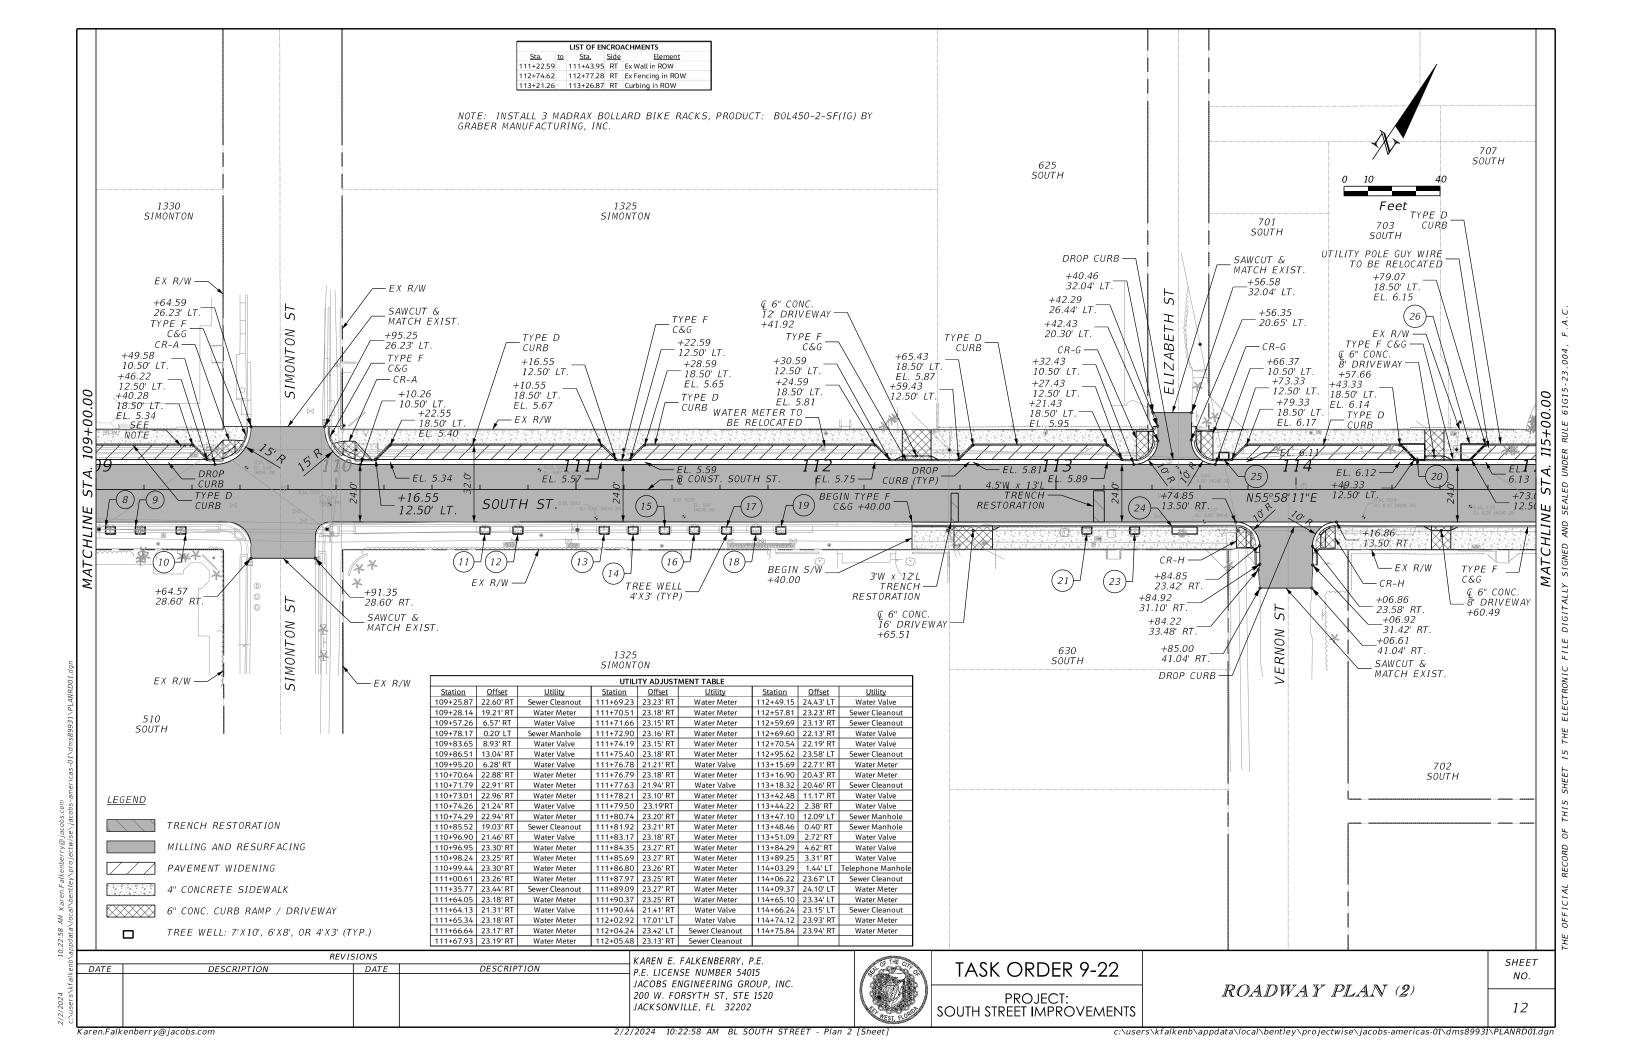


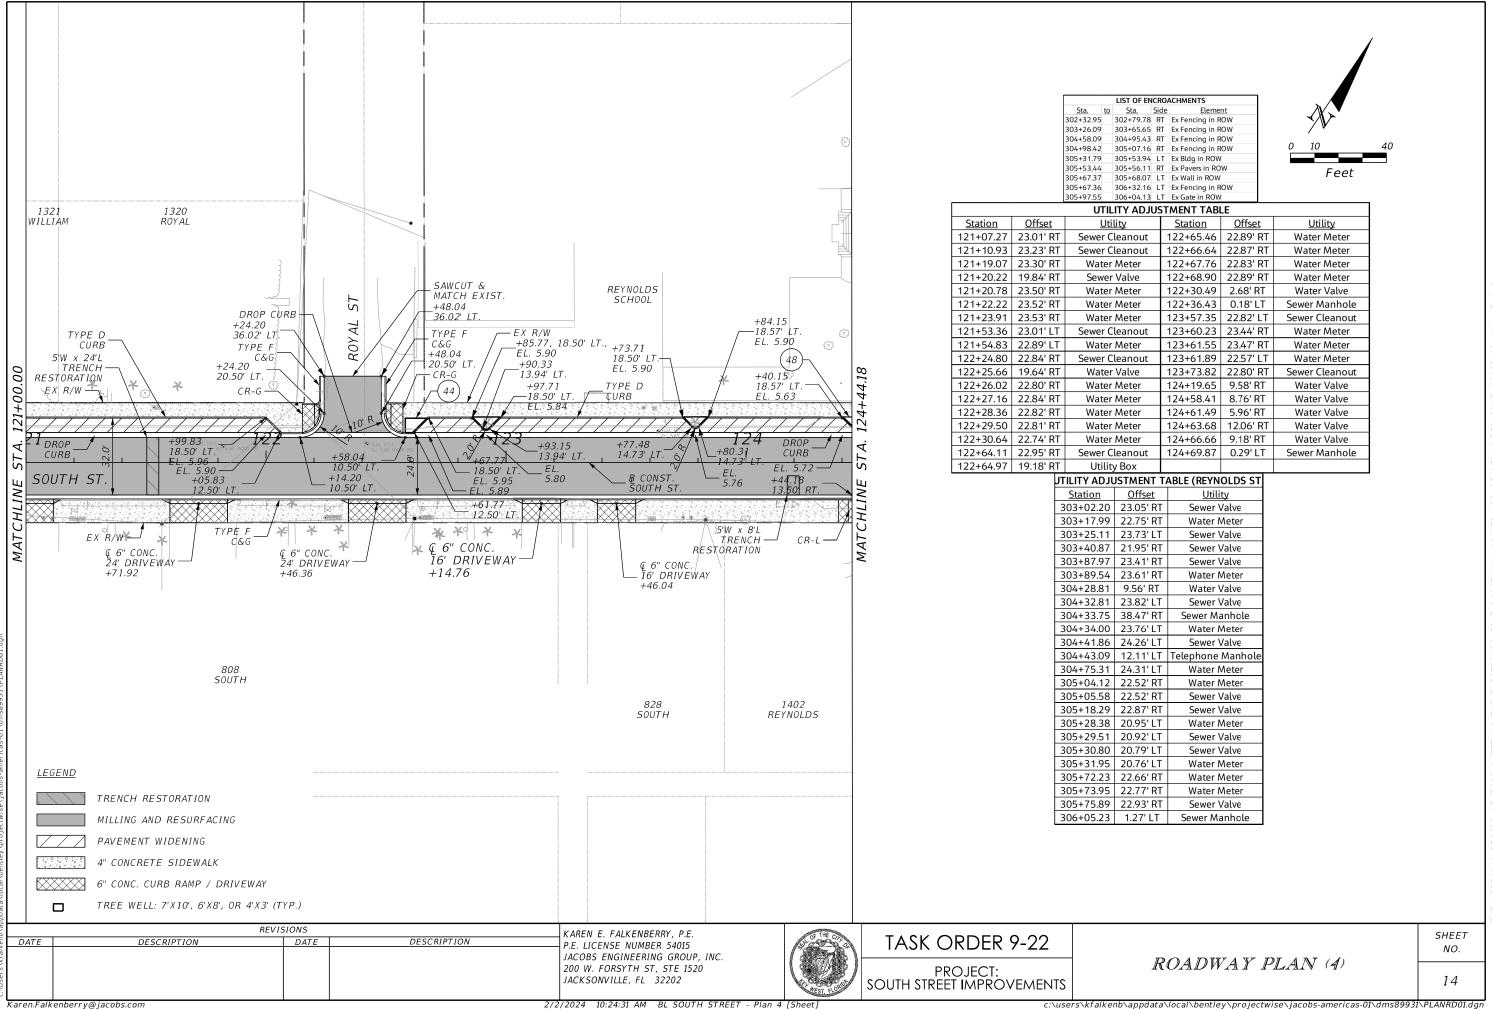- 1. ALTERNATIVE WHEN CORING IS NOT FEASIBLE.
- A-LOK WATER STOP, OR APPROVED ALTERNATIVE.
- 3. ALL GAPS IN BOX ARE TO BE GROUTED PRIOR TO COLLAR INSTALLATION.
- 4. COLLAR IS TO COVER CUTS BY 8" MIN.

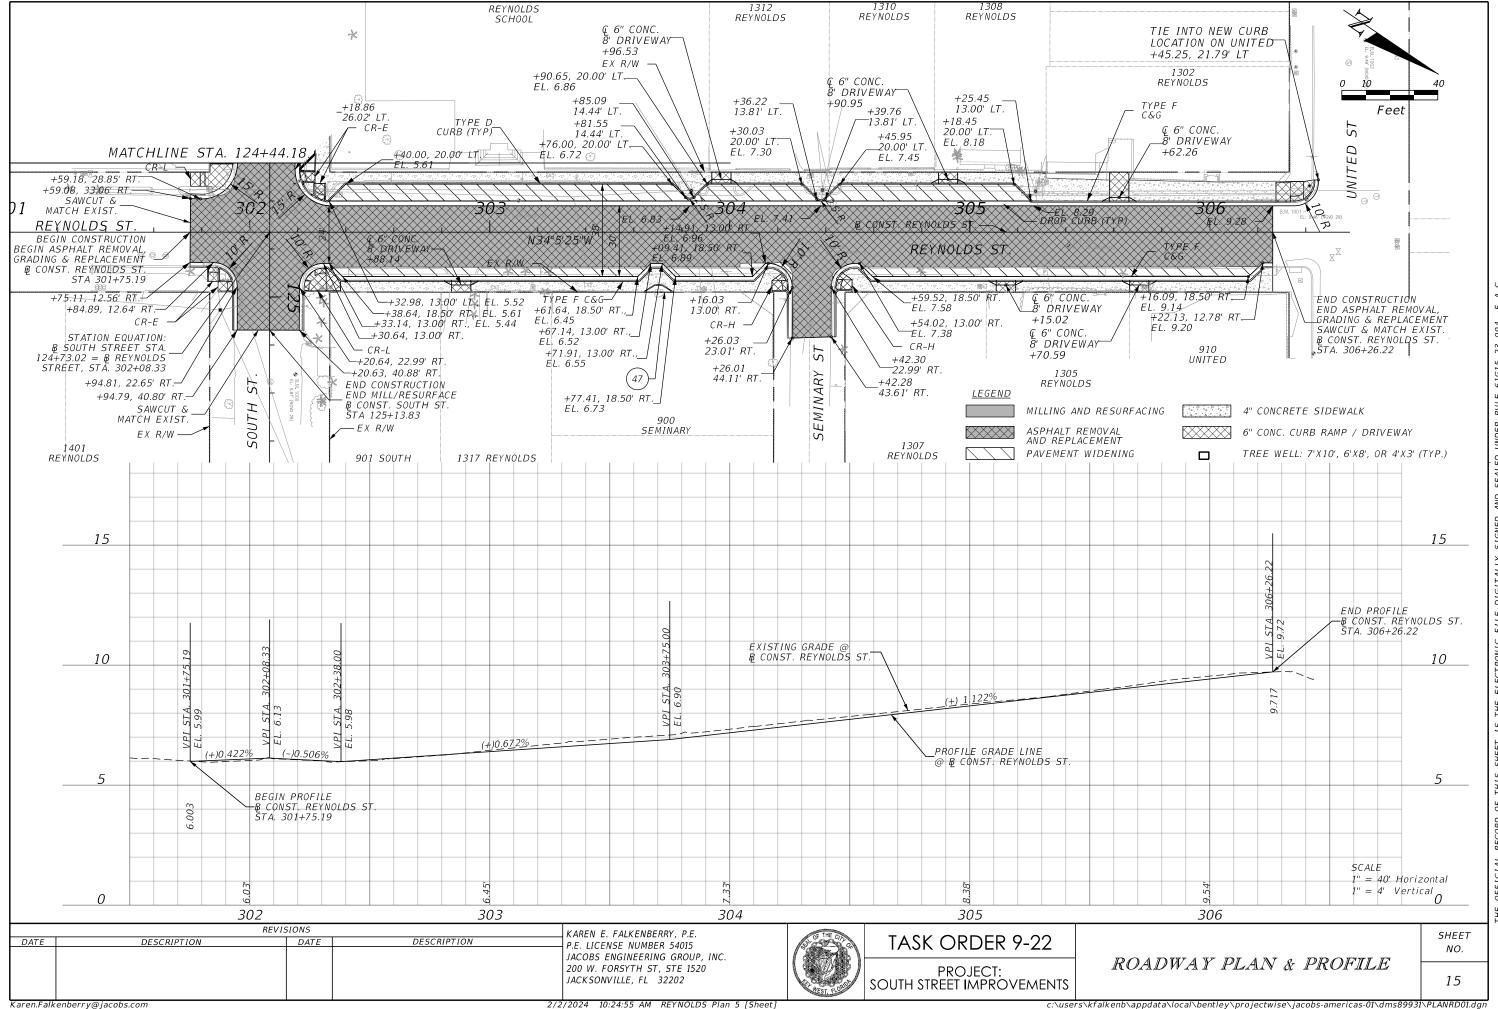
A. ALTERNATIVE BOOT INSTALLATION





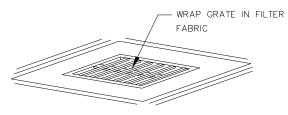


C. TYPE 2 INLET PROTECTION

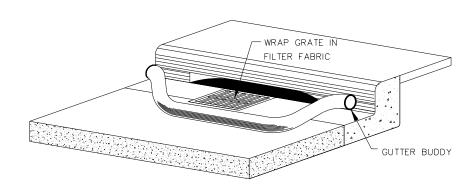

B. TYPICAL TRENCH

D. TYPE 4 INLET PROTECTION
NTS

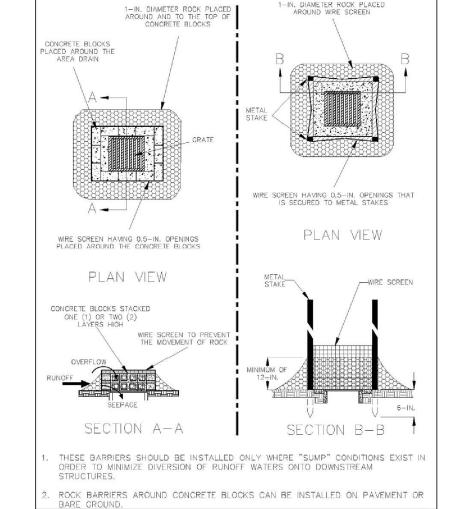

1-IN. DIAMETER ROCK PLACED AROUND WIRE SCREEN

 $\underbrace{ \textbf{F.FDOT STANDARD INLET PROTECTION} }_{\textbf{NTS}}$

REVISIONS MITCHELL LEE GRIFFIN, P.E. DESCRIPTION DESCRIPTION DATE DATE P.E. LICENSE NUMBER 40772 JACOBS ENGINEERING GROUP INC. 643 SW 4TH AVENUE GAINESVILLE, FL 32601




TASK ORDER 9-22


PROJECT: SOUTH STREET IMPROVEMENTS DRAINAGE DETAIL


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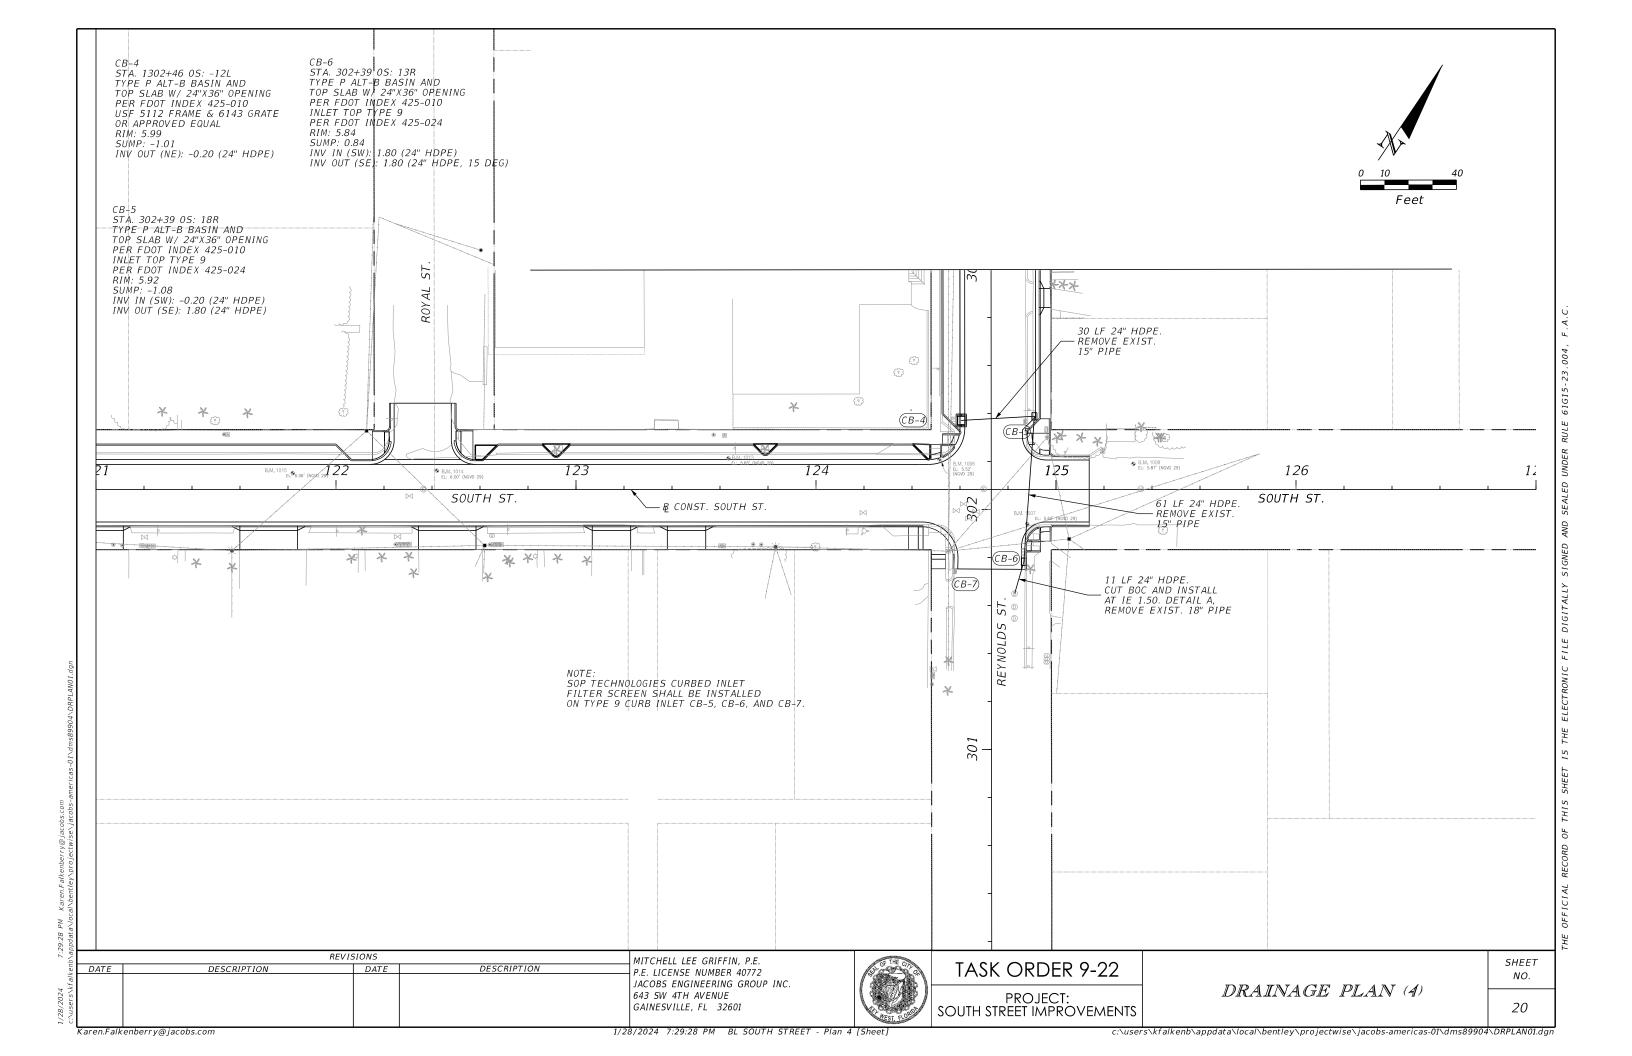
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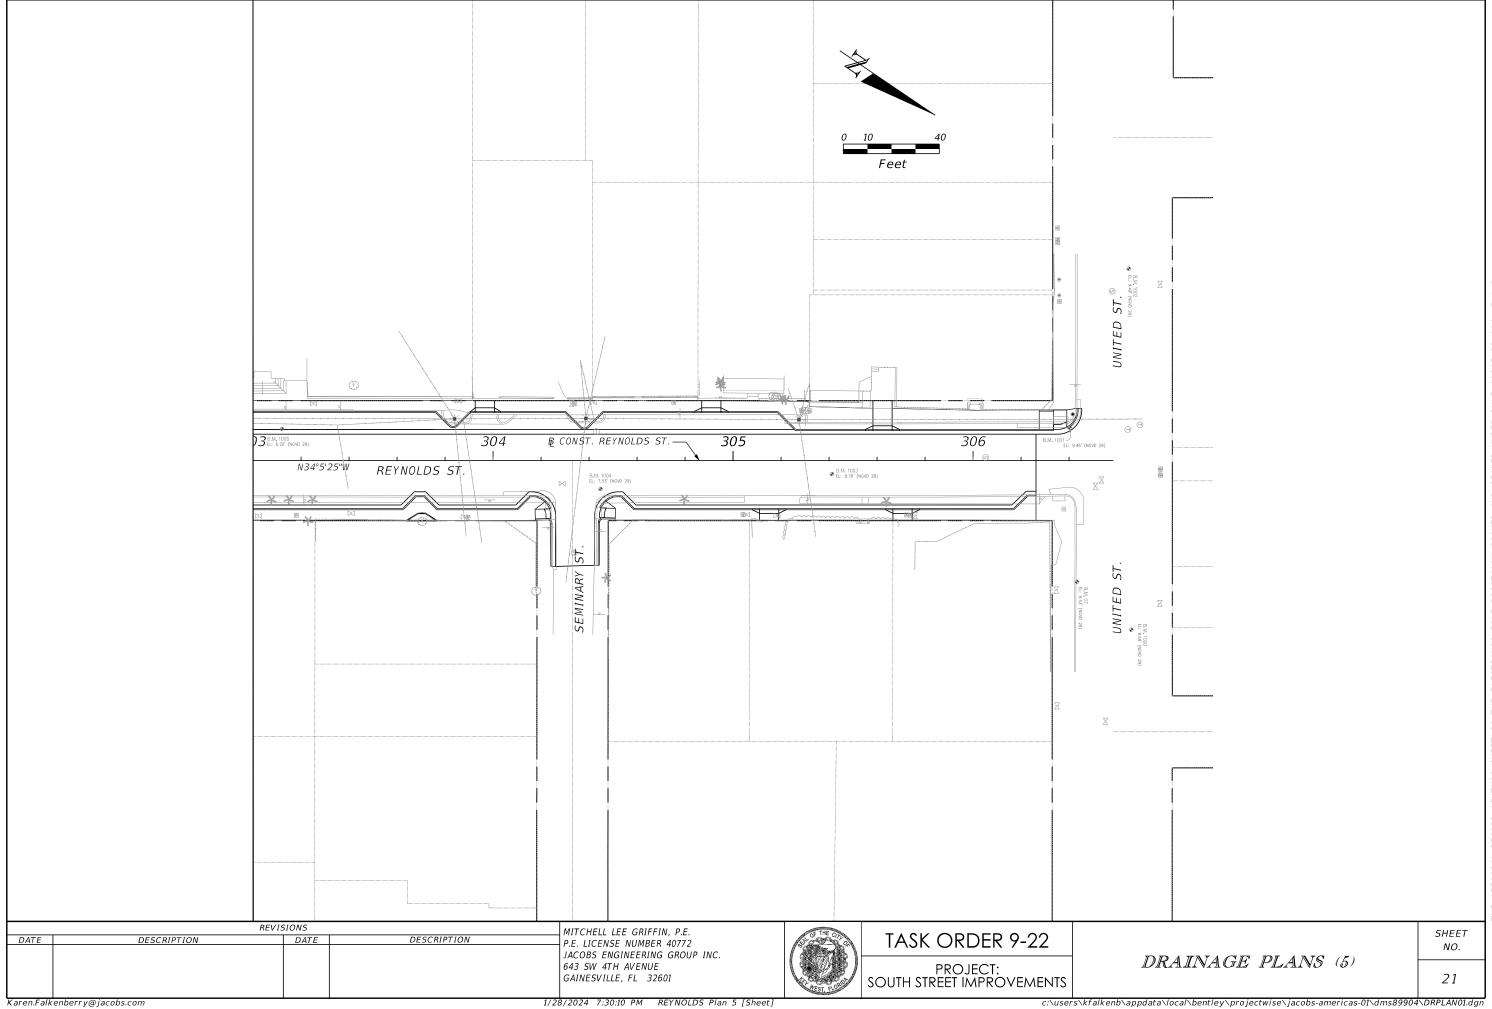
Karen.Falkenberry@jacobs.com





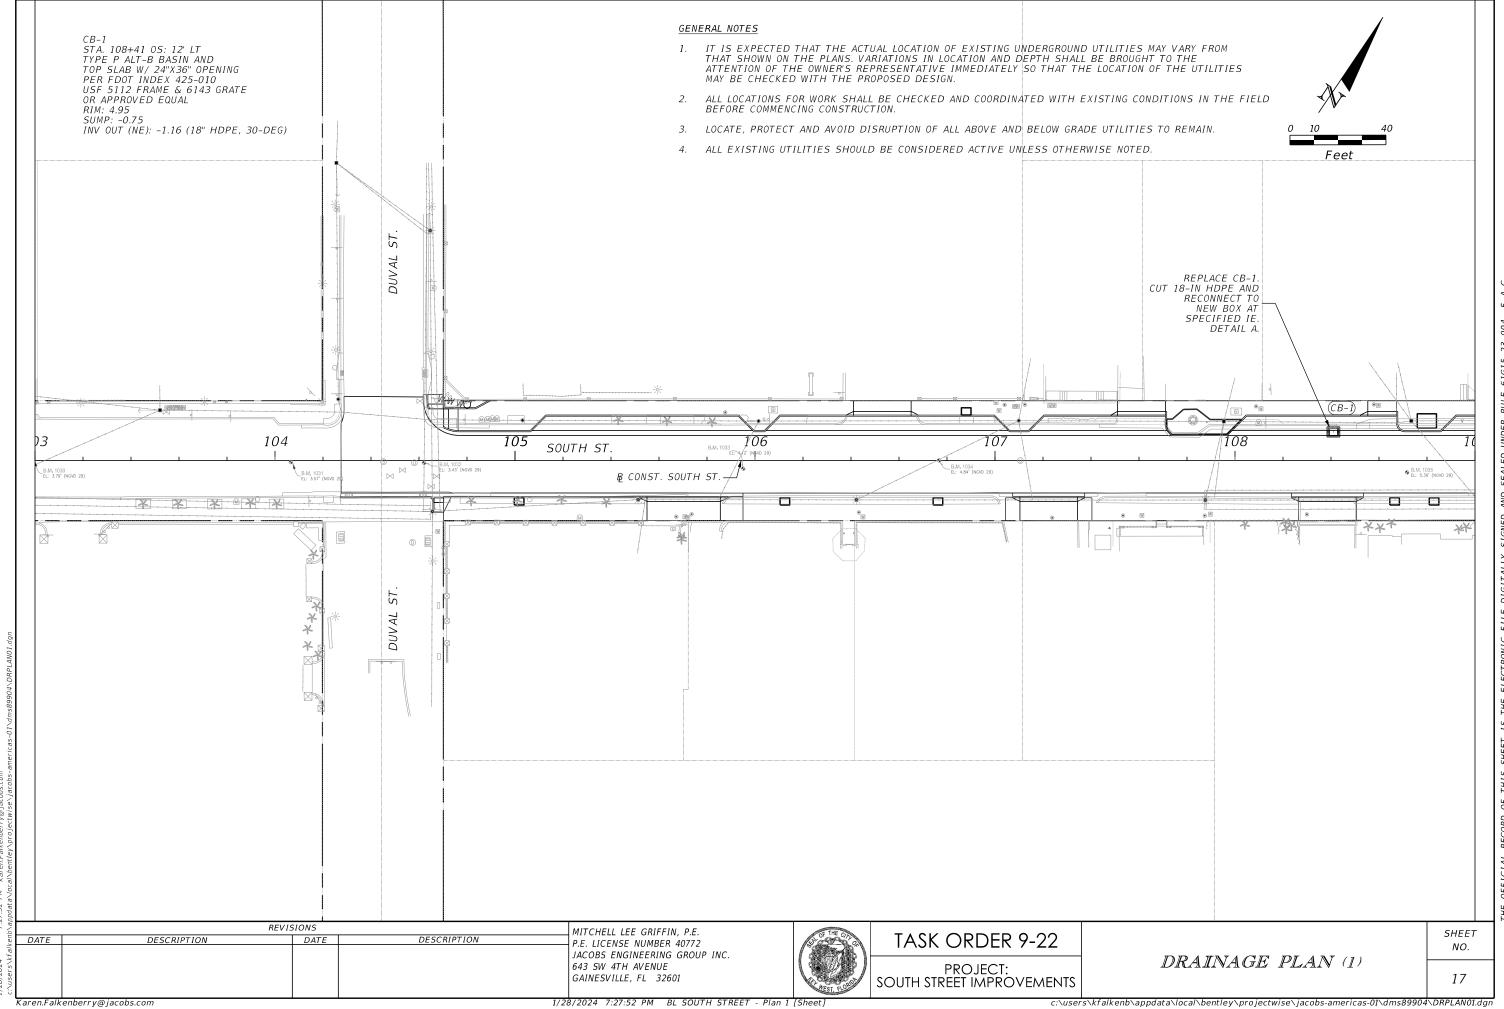

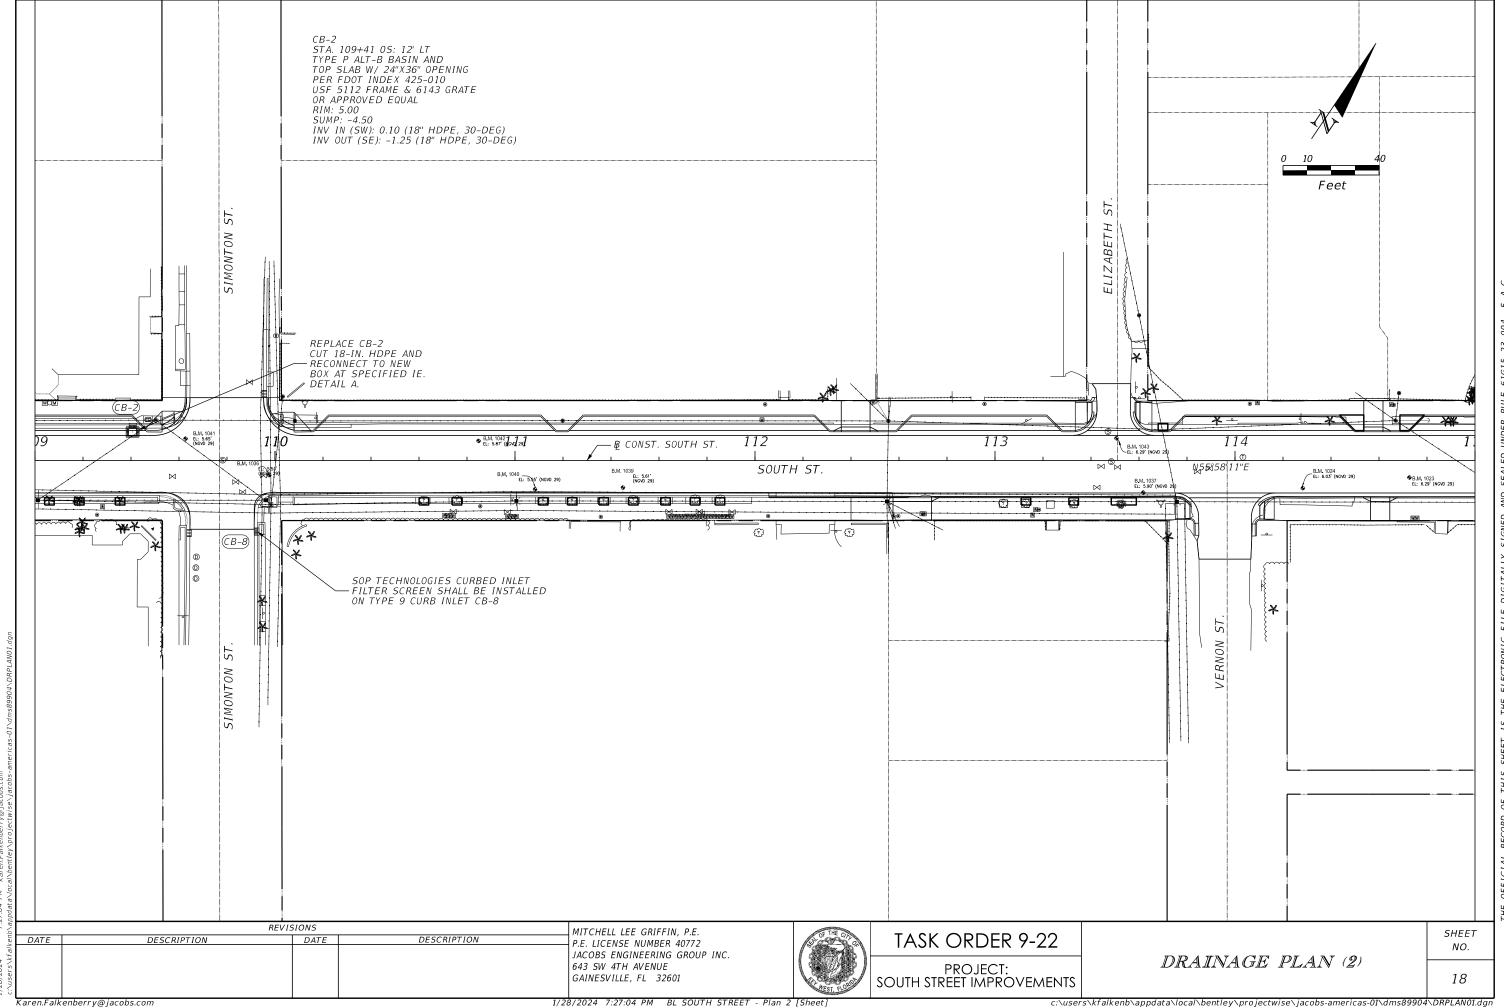

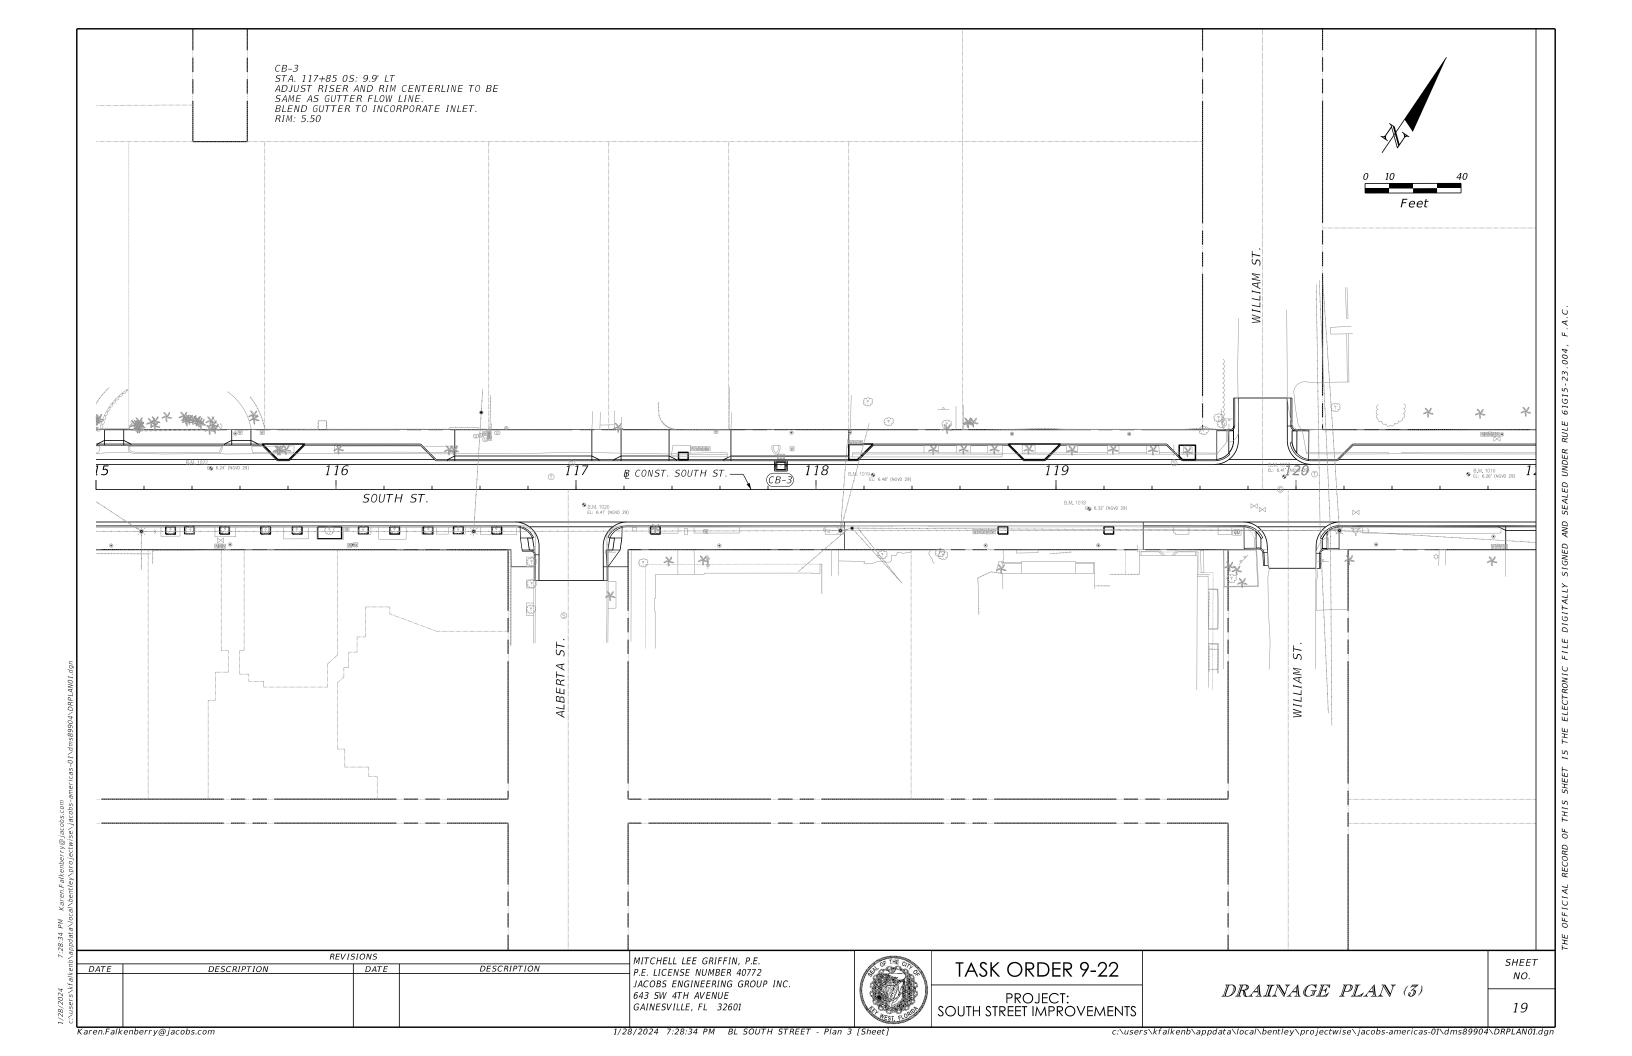

DATE OF SURVEY: 3/2/2023 SURVEY MADE BY: ORACIO RICCOBONO, P.E. SUBMITTED BY: <u>GEOSOL</u>, Inc.

SOUTH STREET ROADWAY IMPROVEMENT PROJECT FROM WHITEHEAD STREET TO REYNOLDS STREET CITY OF KEY WEST, FLORIDA

DISTRICT:	N/A
ROAD NO .:	N/A
COUNTY:	MONROE

CROSS SECTION SOIL SURVEY FOR THE DESIGN OF ROADS

SURVEY BEGINS STA.: 200+00 SURVEY BEGINS STA.: 100+00 SURVEY BEGINS STA.: 302+00

SURVEY ENDS STA .: 201+00 SURVEY ENDS STA.: 125+00 SURVEY ENDS STA.: 304+00

REFERENCE: B/L SURVEY WHITEHEAD STREET REFERENCE: B/L SURVEY SOUTH STREET REFERENCE: B/L SURVEY REYNOLDS STREET

		STURE TENT		ANIC TENT		SIL		YSIS RES VT PASS									CORROS IOI	N TEST RE	ESULTS	
STRATUM NO.	NO. OF TESTS	MOISTURE CONTENT	NO. OF TESTS	%. ORGANIC	NO. OF TESTS	IO MESH	40 MESH	60 MESH	IOO MESH	200 MESH	NO. OF TESTS	LIQUID LIMIT	PLASTIC INDEX	AASHTO GROUP	DESCRIPTION	NO. OF TESTS	RESISTIVITY ohms cm	CHLORIDE ppm	SULFATES ppm	<i>р</i> Н
0														N/A	Asphalt Pavement					
1	4	14-23			4	51-68	27-48	<i>17-38</i>	11-31	7-24					Brown Slightly Slity to Slity Fine to Coarse SAND with Little to Some Limerock Fragments (FILL)					
2	1	13			1	59	40	34	28	23				A-I-b	Brown Slightly Slity to Slity Fine to Coarse SAND with Few to Some Limestone Fragments	1	22	18,500	2,800	7.7

EMBANKMENT AND SUBGRADE MATERIAL

STRATA BOUNDARIES ARE APPROXIMATE. MAKE FINAL CHECK AFTER GRADING.

¬ - WATER TABLE ENCOUNTERED

GNE - GROUNDWATER NOT ENCOUNTERED

Notes:

1) The material from Stratum O is the Asphalt Pavement.

2) The materials from Strata Numbers I and 2 (A-I-b) are considered to be select and should be utilized in accordance with FDOT Roadway and Traffic Design Standard Plan Index Drawing I20-001.

	REVI	SIONS		ENGINEER OF RECORD:
DATE	DESCRIPTION	DATE	DESCRIPTION	GEOSOL, INC.
				ORACIO RICCOBONO, P.E.
				P.E. LICENSE NO. 49324
				5795-A NW 151st STREET
				MIAMI LAKES, FL 33014

SOUTH STREET ROADWAY IMPROVEMENT PROJECT FROM WHITEHEAD STREET TO REYNOLDS STREET CITY OF KEY WEST, FLORIDA

ROADWAY SOILS SURVEY

SHEET NO.

22

Z:\2023\223I08\RDSSGE00I.dgn

2) Brown Slightly Silty to Silty Fine to Coarse SAND

NOTES:

I) SPT BORINGS PERFORMED PER ASTM D-1586 WITH A HAMMER WEIGHT OF 140 LBS FALLING 30 INCHES.

NUMBERS TO THE LEFT OF BORINGS INDICATE SPT VALUE FOR 12" PENETRATION (UNLESS OTHER WISE NOTED).


ENVIRONMENTAL CLASSIFICATION:

SUPERSTRUCTURE: EXTREMELY AGGRESSIVE SUBSTRUCTURE: EXTREMELY AGGRESSIVE (CHLORIDE: 18,500 PPM)

WATER:

pH: 7.7 CHLORIDE: 18,500 PPM SULFATE: 2,800 PPM RESISTIVITY: 22 OHM-CM

GRANULAR MATERIALS- RELATIVE DENSITY	AUTOMATIC SPT HAMMER (BLOWS PER FOOT)
VERY LOOSE LOOSE MEDIUM DENSE DENSE VERY DENSE	LESS THAN 3 3-8 8-24 24-40 GREATER THAN 40
SILTS AND CLAYS CONSISTANCY	AUTOMATIC SPT HAMMER (BLOWS PER FOOT)
VERY SOFT SOFT FIRM STIFF VERY STIFF HARD	LESS THAN I I-3 3-6 6-12 I2-24 GREATER THAN 24

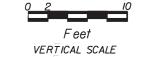

with Little to Some Limerock Fragments (FILL, A-I-b)

with Few to Some Limestone Fragments (A-I-b)

STA. 200+40 B/L Survey Whitehead Street OFF. 13 LT ELEV. N/A DATE 3/2/2023 DRILLER R.Morales HAMMER Auto RIG B-53 LATITUDE 24.546639 LONGITUDE -81.797606 NORTHING 78277 EASTING 391048 28-33-37 Boring Terminated at a Depth of 12ft

BOR # B-I

Casing Length 10ft

0 г

5

10

≷

STA. 105+20 B/L Survey South Street OFF. 8 RT ELEV. N/A DATE 3/2/2023 DRILLER R.Morales HAMMER Auto RIG B-53 LATITUDE 24.547352 LONGITUDE -81.796212 NORTHING 78534 EASTING 391513 22 ∇ *33* · 27 34

Boring Terminated at a Depth of 12ft Casing Length 10ft

BOR # B-2

HORIZONTAL SCALE: N.T.S.

REVISIONS ENGINEER OF RECORDS DATE DESCRIPTION DATE DESCRIPTION GEOSOL. INC. ORACIO RICCOBONO, P.E. P.E. LICENSE NO. 49324 5795-A NW 151st STREET MIAMI LAKES, FL 33014

SOUTH STREET ROADWAY IMPROVEMENT PROJECT FROM WHITEHEAD STREET TO REYNOLDS STREET CITY OF KEY WEST, FLORIDA

ROADWAY SOIL PROFILES

SHEET NO. 23

Juan

3/13/2023

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1 Thomas relation 10440174 RT 57 0 a. 59 0 a							<u>Tr</u>	ee Inven	tory and Disposition					
Annal Anna								Evistina			Tree	Renlacement Tree In	formati	ion
1 7 Forbites registed 1 1 1 1 1 1 1 1 1	Zana	No	Plant	Station	Cido	Dia	Cizo (HvW)		Notos	Disposition		·		Size (HxW)
1 Tentre refull	<u> 2011e</u>	<u>NO.</u>		<u> </u>	<u>310e</u>	<u>DIa.</u>		Conunction	<u>Notes</u>		Well #	<u>Frant</u>	<u>Dia.</u>	312e (HXW)
1 1 1 1 1 1 1 1 1 1	1	1		104.0174	DT			Fair	1401 Duyah sail plantas					
1 2 Profess Profess 105-01 00 87 9-00 15-20 m. 15-	1			104+81.74	R1			Fair						
1 Street Prime				105.01.04				.	, , , , , , , , , , , , , , , , , , , ,	,				
2 1 101-12 10	1			105+01.04	RI			Fair	S/W					
Thicker resides														
1 4 Friedo Pales	1	3		105+19.50	RT			Fair	1401 Duval: soil planter	/ Remove				
Thirds raiside														
- Program 106 12.43 17	1			105+38.11	RT		8'-10'	Poor	1401 Duval: soil planter	Remove				
Provide Faller 106+76.21 RT 10-12 a.d Selected specimen to be FL #1 or better 2			Thrinax radiata											
These Pales			Thatch Palm	106+12.43	RT		10'-12' o.a.		Selected specimen to be FL #1 or better		1			
Primary Pales 169+66.77 10 16-12 o.a Selected Sections to the PL #1 or better			Thrinax radiata											
Prince related 108+66.47 17			Thatch Palm	106+76.21	RT		10'-12' o.a.		Selected specimen to be FL #1 or better		2			
Thatch Palm									,					
Thinks tabled 188-82-94 RT 10-12" 0.8 Selected Agerimen to the FL #3 or better 6 Thinks tabled 19406-02 RL 13-15" 0.8 Fair 510 South years tree lann, under whithy 19406-02 RL 13-15" 0.8 Fair 195-05" 0.9 Fair 19406-02 RL 13-15" 0.9 Fair 13-15" 0.				108+66.47	RT		10'-12' o.a.		Selected specimen to be FL #1 or better		5			
Thatch Palm 108-82794 87 10-17 c.a. Schicted agestions to be file 1 or bettler 6 Thirting radiata 1 1 1 1 1 1 1 1 1				100,00,,,			10 12 0767		Servetted openiment to serve in 1 or server					
				108482 04	DT		10'-12' 0 3		Selected specimen to be EL #1 or better		6			
1 5 Christmas Palm 1994-86-92 Nr				100702.94	I NI				'		U	Thringy radiata		
Adontale mercilii	1	_		100.06.03				F		D !	0			10/ 12/
1 6 Christmas Palin DIL 10941847 8T 2.9 o.a	1			109+06.02	RI.					кертасе	8			10'-12' o.a.
Administrarie 10 1943-87 RT 19 19 19 10 10 10 10 10									,			l .		
1	1	6		109+18.47	RT		2-9' o.a.	2 – Poor		Replace	9			10'-12' o.a.
			Adonidia merrillii						510 South: grass tree lawn, under utility			Thrinax radiata		
1 8 Corona Palm 109+43.09 C	1	7	Christmas Palm	109+35.47	RT		15' o.a.	Poor	lines	Replace	10	Thatch Palm		10'-12' o.a.
1 8			Cocos nucifera				30'-35' o.a.		1319 Duval: soil planter, leaning over					
1 0	1	8		105+43.09	I IT			Fair		Remove				
1 9	-			100770700						7.0				
1 10 Cocon mulfera 105+82.11 U	1	a		105463 34	1 , 7			Eair		Pomovo				
1 10 Coconus Palm 105+82.11 LT 20-25 Fair Oarking area Remove Normal Value Normal Valu	1	9		105705.54	LI			I all		Reliiove				
Thrinax radiate	1	1.0		105.02.11	, _			F	· · · · · · · · · · · · · · · · · · ·					
Thatch Palm	1	10		105+82.11	LI		20'-25'	Fair	parking area	Remove				
Swietenia mahagoni														
Switeria mahagoni			Thatch Palm	107+17.10	LT		10'-12' o.a.				3			
1 11 Mahogany Tree														
Thrina radiata 108+79.95 LT 10'-12' o.a.			Swietenia mahagoni				55'-60' o.a.	RETAIN	through canopy, sidewalk lifted. Replace					
	1	11	Mahogany Tree	107+80.00	LT	42.6"	50'-60'	PROTECT	concrete w/Flexi-pave.	To Remain	4			
Conocarpus erectus var. sericeus 110+62.08 RT 4.9" 10'-11" Fair maintained/hedge, under utility lines To Remain 11 2 2 Silver Buttonwood 110+75.78 RT 4.5" 9x10" Poor maintained/hedge, leaning under utility To Remain 12 2 3 Silver Buttonwood 111+17.78 RT 4.5" 9x10" Poor maintained/hedge, leaning under utility To Remain 12 2 3 Silver Buttonwood 111+17.4 RT 8.5" 15-18" Fair maintained/hedge, leaning under utility To Remain 13 2 4 Silver Buttonwood 111+23.81 RT 3" 6'-7" Poor maintained/hedge, leaning under utility To Remain 14 2 5 Silver Buttonwood 111+36.96 RT 7.3" 16'-18" Poor maintained/hedge, under utility To Remain 15 2 6 Silver Buttonwood 111+42.8 RT 7" 16'-18" Poor maintained/hedge, under utility To Remain 15 2 6 Silver Buttonwood 111+42.8 RT 7" 16'-18" Poor maintained/hedge, under utility To Remain 15 2 6 Silver Buttonwood 111+42.8 RT 7" 16'-18" Poor maintained/hedge, under utility To Remain 16 2 6 Silver Buttonwood 111+42.8 RT 7" 16'-18" Poor maintained/hedge, under utility To Remain 16 2 7 Silver Buttonwood 111+62.74 RT 6.8" 12'-13" Fair maintained/hedge, slight lean under utility To Remain 17 2 8 Silver Buttonwood 111+83.37 RT 4.7" 6'x8" Poor maintained/hedge, slight lean To Remain 17 2 8 Silver Buttonwood 111+85.37 RT 4.7" 6'x8" Poor maintained/hedge, slight lean To Remain 17 2 1 Silver Buttonwood 113+03.56 RT 0.9" 6'x.5" Poor maintained/hedge, slight lean To Remain 18 2 1 Silver Buttonwood 113+03.56 RT 0.9" 6'x.5" Poor maintained/hed			Thrinax radiata											
Conocarpus erectus var. sericeus 110+62.08 RT 4.9" 10'-11" Fair maintained/hedge, under utility lines To Remain 11 2 2 Silver Buttonwood 110+75.78 RT 4.5" 9x10" Poor maintained/hedge, leaning under utility To Remain 12 2 3 Silver Buttonwood 111+17.78 RT 4.5" 9x10" Poor maintained/hedge, leaning under utility To Remain 12 2 3 Silver Buttonwood 111+17.4 RT 8.5" 15-18" Fair maintained/hedge, leaning under utility To Remain 13 2 4 Silver Buttonwood 111+23.81 RT 3" 6'-7" Poor maintained/hedge, leaning under utility To Remain 14 2 5 Silver Buttonwood 111+36.96 RT 7.3" 16'-18" Poor maintained/hedge, under utility To Remain 15 2 6 Silver Buttonwood 111+42.8 RT 7" 16'-18" Poor maintained/hedge, under utility To Remain 15 2 6 Silver Buttonwood 111+42.8 RT 7" 16'-18" Poor maintained/hedge, under utility To Remain 15 2 6 Silver Buttonwood 111+42.8 RT 7" 16'-18" Poor maintained/hedge, under utility To Remain 16 2 6 Silver Buttonwood 111+42.8 RT 7" 16'-18" Poor maintained/hedge, under utility To Remain 16 2 7 Silver Buttonwood 111+62.74 RT 6.8" 12'-13" Fair maintained/hedge, slight lean under utility To Remain 17 2 8 Silver Buttonwood 111+83.37 RT 4.7" 6'x8" Poor maintained/hedge, slight lean To Remain 17 2 8 Silver Buttonwood 111+85.37 RT 4.7" 6'x8" Poor maintained/hedge, slight lean To Remain 17 2 1 Silver Buttonwood 113+03.56 RT 0.9" 6'x.5" Poor maintained/hedge, slight lean To Remain 18 2 1 Silver Buttonwood 113+03.56 RT 0.9" 6'x.5" Poor maintained/hed			Thatch Palm	108+79.95	LT		10'-12' o.a.		Selected specimen to be FL #1 or better		7			
2 1 Silver Buttonwood 110+62.08 RT 4.9° 10°-11′ Fair maintained/hedge, under utility lines To Remain 11														
1401 Simonton: grass/stone,	2	1		110+62.08	RT	⊿ 9"		Fair		To Remain	1 1			
2 2 Silver Buttonwood 110+75.78 RT 4.5" 9x10' Poor maintained/hedge, leaning under utility To Remain 12 Conocarpus erectus var. sericeus Silver Buttonwood 111+11.74 RT 8.5" 15-18" Silver Buttonwood 111+3.81 RT 3" 6-7" Poor maintained/hedge, leaning under utility Incomplete Incomplet		-		110702.00	7.07	1,5		7 477		70 Hemain	- 11			
Conocarpus erectus var. sericeus Silver Buttonwood Silver Bu	2	2	,	110,75.70	DT	A E!!		Door		To Domain	17			
2 3 Silver Buttonwood 111+11.74 RT 8.5" 15'-18' Fair maintained/hedge, leaning under utility To Remain 13				110+/5./8	KI	4.5		POOF		io kemain	12			
Conocarpus erectus var. sericeus 111+23.81 RT 3" 6"-7" Poor maintained/hedge, under utility lines To Remain 14	2	_		111117		0.5"				T - D	1.7			
2 4 Silver Buttonwood 111+23.81 RT 3" 6-7' Poor maintained/hedge, under utility lines To Remain 14		3		111+11./4	KI	8.5"		Fair		io Kemain	13			
Conocarpus erectus var. sericeus Conocarpus ere						_				_				
2 5 Silver Buttonwood 111+36.96 RT 7.3" 16'-18' Poor maintained/hedge, leaning under utility To Remain 15	2	4		111+23.81	RT	3"		Poor		To Remain	14			
Concarpus erectus var. sericeus Silver Buttonwood 111+49.28 RT 7" 18"-20" x 1401 Simonton: grass/stone, maintained/hedge, under utility lines To Remain 16														
Concarpus erectus var. sericeus Silver Buttonwood 111+49.28 RT 7" 18"-20" x 1401 Simonton: grass/stone, maintained/hedge, under utility lines To Remain 16	2	5	Silver Buttonwood	111+36.96	RT	7.3"	16'-18'	Poor		To Remain	15			
2 6 Silver Buttonwood 111+49.28 RT 7" 16'-18' Poor maintained/hedge, under utility lines To Remain 16 Conocarpus erectus var. sericeus 111+62.74 RT 6.8" 12'-13' Fair maintained/hedge, slight lean under utility To Remain 17 Conocarpus erectus var. sericeus 13'-18' x 1401 Simonton: grass/stone, 1401 Simonton: g														
Conocarpus erectus var. sericeus 2 7 Silver Buttonwood 111+62.74 RT 6.8" 12'-13' Fair maintained/hedge, slight lean under utility To Remain 17 Conocarpus erectus var. sericeus 2 8 Silver Buttonwood 111+74.99 RT 5.6" 12'-13' Fair maintained/hedge, slight lean under utility To Remain 18 Conocarpus erectus var. sericeus 2 9 Silver Buttonwood 111+85.37 RT 4.7" 6'x8' Poor maintained/hedge, leaning/under utility To Remain 19 Capparis cynophallophora 2 10 Jamaica Caper 113+03.56 RT 0.9" 6' x 5' Poor 630 South: soil planter Remove Conocarpus erectus var. sericeus 2 11 Silver Buttonwood 113+12.83 RT 4" 8' x 8' Poor 630 South: soil planter, slightly leaning Replace 21 Silver Buttonwood 2"-4" 10'-1 Ficus macrocarpa	2	6		111+49.28	RT	7"		Poor		To Remain	16			
2 7 Silver Buttonwood 111+62.74 RT 6.8" 12'-13' Fair maintained/hedge, slight lean under utility To Remain 17 Conocarpus erectus var. sericeus 111+74.99 RT 5.6" 12'-13' Fair maintained/hedge, slight lean To Remain 18 Conocarpus erectus var. sericeus 10'-12' x 1401 Simonton: grass/stone, 1401 Simonton: grass/stone, 1401 Simonton: grass/stone, 18 Capparis cynophallophora 111+85.37 RT 4.7" 6'x8' Poor 630 South: soil planter Remove Conocarpus erectus var. sericeus 113+03.56 RT 0.9" 6' x 5' Poor 630 South: soil planter Remove Conocarpus erectus var. sericeus 113+12.83 RT 4" 8' x 8' Poor 630 South: soil planter, slightly leaning Replace 21 Silver Buttonwood 2"-4" 10'-1						-								
Conocarpus erectus var. sericeus Silver Buttonwood Silver Buttonwo	2	7		11146274	RT	6.8"		Fair		To Romain	17			
2 8 Silver Buttonwood 111+74.99 RT 5.6" 12'-13' Fair maintained/hedge, slight lean To Remain 18 <		/		111102.74	111	0.0		T GIT		TO Remain	1/		_	
Conocarpus erectus var. sericeus Silver Buttonwood 111+85.37 RT 4.7" 6'x8' Poor maintained/hedge, leaning/under utility Capparis cynophallophora Jamaica Caper 113+03.56 RT 0.9" 6' x 5' Poor 630 South: soil planter Conocarpus erectus var. sericeus Silver Buttonwood 113+12.83 RT 4" 8' x 8' Poor 630 South: soil planter, slightly leaning Ficus macrocarpa 1401 Simonton: grass/stone, maintained/hedge, leaning/under utility To Remain 19 Co Remain 19 Conocarpus erectus var. sericeus Silver Buttonwood 2"-4" 10'-12' x 6'x8' Poor 630 South: soil planter Ficus macrocarpa	2		,	11117400		E C''		F - ! -		To Domair	1.0			
2 9 Silver Buttonwood 111+85.37 RT 4.7" 6'x8' Poor maintained/hedge, leaning/under utility To Remain 19		Ö		111+/4.99	KI	٥.٠٠		rair		io kemain	18			
Capparis cynophallophora 113+03.56 RT 0.9" 6' x 5' Poor 630 South: soil planter Conocarpus erectus var. sericeus 113+12.83 RT 4" 8' x 8' Poor 630 South: soil planter, slightly leaning Replace Conocarpus erectus var. sericeus Ficus macrocarpa Capparis cynophallophora 113+03.56 RT 0.9" 6' x 5' Poor 630 South: soil planter Conocarpus erectus var. sericeus Ficus macrocarpa	_	_						_						
2 10 Jamaica Caper 113+03.56 RT 0.9" 6' x 5' Poor 630 South: soil planter Remove Conocarpus erectus var. sericeus 2 11 Silver Buttonwood 113+12.83 RT 4" 8' x 8' Poor 630 South: soil planter, slightly leaning Replace 21 Silver Buttonwood 2"-4" 10'-1 Ficus macrocarpa	2	9		111+85.37	RT	4.7"	6'x8'	Poor	maintained/hedge, leaning/under utility	To Remain	19			
Conocarpus erectus var. sericeus 2 11 Silver Buttonwood 113+12.83 RT 4" 8' x 8' Poor 630 South: soil planter, slightly leaning Replace 21 Silver Buttonwood 2"-4" 10'-1 Ficus macrocarpa														
Conocarpus erectus var. sericeus 2 11 Silver Buttonwood 113+12.83 RT 4" 8' x 8' Poor 630 South: soil planter, slightly leaning Replace 21 Silver Buttonwood 2"-4" 10'-1 Ficus macrocarpa	2	10	Jamaica Caper	113+03.56	RT	0.9"	6' x 5'	Poor	630 South: soil planter	Remove				
2 11 Silver Buttonwood 113+12.83 RT 4" 8 x 8' Poor 630 South: soil planter, slightly leaning Replace 21 Silver Buttonwood 2"-4" 10'-1 Ficus macrocarpa												Conocarpus erectus var. sericeus		
Ficus macrocarpa	2	11		113+12.83	RT	4"	8' x 8'	Poor	630 South: soil planter, slightly leaning	Replace	21	· · · · · · · · · · · · · · · · · · ·	2"-4"	10'-15' o.a.
	_					-			present y and great y accounting				·	
1 2 12 Green Island Figus 113+2299 RT 2' x 3' Fair 1630 South: soil planter ground cover Remove	2	12	Green Island Ficus	113+22.99	RT		2' x 3'	Fair	630 South: soil planter, ground cover	Remove				

REVISIONS

DATE DESCRIPTION DATE DESCRIPTION

AND DESCRIPTION DATE DESCRIPTION

P.E. LICENSE NUMBER 54015

JACOBS ENGINEERING GROUP, INC.
200 W. FORSYTH ST, STE 1520

JACKSONVILLE, FL 32202

Karen.Falkenberry@jacobs.com



TASK ORDER 9-22

PROJECT: SOUTH STREET IMPROVEMENTS LANDSCAPE TABLE (1)

SHEET NO.

						<u>Tree In</u>	ventory (and Disposition Continued					
<u>Zone</u>	<u>No.</u>	<u>Plant</u>	<u>Station</u>	<u>Side</u>	<u>Dia.</u>	Size (HxW)	Existing Condition	<u>Notes</u>	<u>Disposition</u>	Tree Well #	Replacement Tree In <u>Plant</u>		ion Size (HxW)
2		Genipa clusiifolia Seven-Year Apple	113+32.75	RT	0.6"	7' x 6'	Fair	630 South: soil planter	Replace	23	Conocarpus erectus var. sericeus Silver Buttonwood		10'-15' o.a.
2		Delonix regia Poinciana Tree	113+53.65	RT	4.5"	18'-20' x 28'-30'	Very Poor	630 South: soil planter, leaning, mechanical damage	Replace	24	Conocarpus erectus var. sericeus Silver Buttonwood	2"-4"	10'-15' o.a.
3	1	Syagrus romanzoffiana Queen Palm	113+92.50	LT		19'-20' o.a. 10'-12'	Poor	701 South: grass tree lawn	Remove				
		Cassia javanica Apple Blossom Tree	113+70.00	LT	3"	14'-16'		Selected specimen to be FL #1 or better		25			
		Cocos nucifera				W: 30'-35' o.a. x 18'-20' E: 35'-40' o.a.	W: Fair						
3	2	Coconut Palm DBL	114+39.46	LT		x 20'-25'	E: Fair	703 South: grass tree lawn	Remove				
		Cassia bakeriana Pink Shower Tree	114+50.00	LT	3"-4"	12'-14' o.a.		Selected specimen to be FL #1 or better		20			
		Cassia javanica Apple Blossom Tree	114+72.37	LT	3"	14'-16' W: 19'-20' o.a.		Selected specimen to be FL #1 or better		26			
2		Adonidia merrillii	114.07.72			x 14'-16' E: 20'-25' o.a.	W: Poor	707 6 - 11	0				
3		Christmas Palm DBL Adonidia merrillii	114+87.73	LT		x 15'-18' 19'-20' o.a.	E: Poor	707 South: grass tree lawn	Remove				
3	4	Christmas Palm	114+90.01	LT		14'-16' W: 21'-23' o.a.	Poor	707 South: grass tree lawn	Remove				
		Adonidia merrillii				x 19'-20' E: 21'-23' o.a.	W: Poor						
3		Christmas Palm DBL Adonidia merrillii	115+75.83	LT		x 19'-20' 21'-23' o.a.	E: Poor	711 South: grass tree lawn	To Remain	31			
3	6	Christmas Palm	115+76.70	LT		19'-20'	Poor	711 South: grass tree lawn	To Remain	31			
3	7	Cocos nucifera Coconut Palm	115+79.18	LT		65'-70' o.a. 45'-50'	Fair	711 South: grass tree lawn	To Remain	31			
3	8	Carissa macrocarpa Natal Plum (15)	116+01.12	LT		5.5' x 20'	Fair	711 South: thorns, hedged grass tree lawn	Remove				
		Thrinax radiata Thatch Palm Adonidia merrillii	105+01.73	RT		10'-12' o.a. 20'-25' o.a.		Selected specimen to be FL #1 or better		34			
3	9	Christmas Palm	116+47.13	LT		12'-15'	Fair/Poor	711 South: grass tree lawn	Remove				
3	10	Adonidia merrillii Christmas Palm	116+49.16	LT		20'-25' o.a. 12'-15'	Fair/Poor	711 South: grass tree lawn	Remove				
3	11	Bucida buceras Black Olive Tree	115+31.07	RT	15.8"	45'-50' x 25'-30'	Fair	706 South: utility lines thru canopy, flexipave planter	Replace	27	Tabebuia aurea Yellow Trumpet Tree	4"-6"	10'-15' o.a.
3	12	Bucida buceras Black Olive Tree	115+38.94	RT	10.9"	45'-50' x 25'-30'	Poor	706 South: utility lines thru canopy, rock planter	Replace	28	Tabebuia aurea Yellow Trumpet Tree	4"-6"	10'-15' o.a.
3	13	Bucida buceras Black Olive Tree	115+53.56	RT	10.1"	35'-40' x 15'-20'	Fair	706 South: utility lines thru canopy, flexipave planter	Replace	29	Tabebuia aurea Yellow Trumpet Tree Tabebuia aurea	4"-6"	10'-15' o.a.
3	14	Bucida buceras Black Olive Tree	115+70.66	RT	5.4"	15'-18' x 15'	Poor	708 South: utility lines thru canopy, rock planter	Replace	30	Yellow Trumpet Tree	4"-6"	10'-15' o.a.
3	15	Bucida buceras Black Olive Tree	115+83.85	RT	12.8"	35'-40' x 25'-30'	Fair	708 South: utility lines thru canopy, flexipave planter	Replace	32	Tabebuia aurea Yellow Trumpet Tree	4"-6"	10'-15' o.a.
3	16	Bucida buceras Black Olive Tree	115+97.31	RT	12"	35'-40' x 25'-30'	Poor	708 South: utility lines thru canopy, flexi- pave planter 1400 Alberta: utility lines thru canopy,	Replace	33	Tabebuia aurea Yellow Trumpet Tree	4"-6"	10'-15' o.a.
3	17	Bucida buceras Black Olive Tree Bucida buceras	116+11.42	RT	6.6"	18'-20' x 15'-18' 45'-50' x	Fair	rock planter 1400 Alberta: utility lines thru canopy, rock planter 1400 Alberta: utility lines thru canopy,	Replace	35	Tabebuia aurea Yellow Trumpet Tree Tabebuia aurea	4"-6"	10'-15' o.a.
3	18	Black Olive Tree	116+24.43	RT	15.6"	30'-35'	Poor	flexi-pave planter	Replace	36	Yellow Trumpet Tree	4"-6"	10'-15' o.a.
3	19	Bucida buceras Black Olive Tree	116+38.33	RT	13.5"	45'-50' x 25'-30'	Fair	1400 Alberta: utility lines thru canopy, rock planter	Replace	37	Tabebuia aurea Yellow Trumpet Tree	4"-6"	10'-15' o.a.
3		Bucida buceras Black Olive Tree	116+50.97	RT	9.2"	35'-40' x 15'-20'	Poor	1400 Alberta: utility lines thru canopy, rock planter	Replace	38	Tabebuia aurea Yellow Trumpet Tree	4"-6"	10'-15' o.a.

REVISIONS KAREN F	EN E. FALKENBERRY, P.E.
DATE DECORPTION DECORPTION	LICENSE NUMBER 54015
JACOBS 200 W. I	OBS ENGINEERING GROUP, INC. W. FORSYTH ST, STE 1520 KSONVILLE, FL 32202



TASK ORDER 9-22 PROJECT: SOUTH STREET IMPROVEMENTS

LANDS CAPE TABLE (2)

SHEET NO.

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IF 61615-23 00
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					<u>Tree Ir</u>	ventory	and Disposition Continued					
						Existina			Tree	Replacement Tree II	nformati	ion
No.	<u>Plant</u>	<u>Station</u>	Side	<u>Dia.</u>	Size (HxW)	Condition	<u>Notes</u>	<u>Disposition</u>	Well #	<u>Plant</u>		Size (HxW)
	Bucida buceras				35'-40' x		1400 Alberta: utility lines thru canopy,			Tabebuia aurea		
21	Black Olive Tree	116+66.98	RT	1 1"	25'-30'	Poor	rock planter	Replace	39	Yellow Trumpet Tree	4"-6"	10'-15' o.a.
	Cocos nucifera				35'-40' o.a.							
22	Coconut Palm	117+33.11	RT		18'-20'	Fair	714 South: leaning into street	To Remain	22			
		117+44.71	LT	3"	14'-16'		Selected specimen to be FL #1 or better		40			
		118+16.66	LT	3"-4"			Selected specimen to be FL #1 or better		45			
2.2		110:40.07	,,			False	721 Courtly Jacobian into atmost					
23		118+48.87	LI			Fair	721 South: Teaning Into Street	Remove				
21		110,6151	1.7			Poor	721 South: loaning into street	Pomovo				
24		110+01.51	LI			F 001		Kelliove				
25		118+74 35	1 1 7			Poor	_	Remove				
		110174.55	Li		20-23	7 007	yenowing	Kemove				
	1 ′	118+77.90	RT	5" min.	12'-14' o.a.		Selected specimen to be FL #1 or better		41			
		110177130		3			Serected Specimen to serie in 1 or sector					
26		118+88.64	LT			Poor	725 South: leaning into street	Remove				
	Pink Shower Tree	118+90.99	LT	3"-4"	12'-14' o.a.		Selected specimen to be FL #1 or better		46			
	Lysiloma sabicu											
	Sabicu	119+21.99	RT	5" min.	12'-14' o.a.		Selected specimen to be FL #1 or better		42			
	Cocos nucifera				40'-45' o.a.		725 South: leaning into street, lethal					
27	Coconut Palm	119+06.71	LT		30'-35'	Poor	yellowing	Remove				
	Cocos nucifera				45'-50' o.a.		725 South: Leaning into street, lethal					
28	Coconut Palm	119+23.80	LT		30'-35'	Poor	yellowing	Remove				
29		119+40.46	LT			Fair	9	Remove				
							_			1 '		
30		119+54.71	LT			Poor		Replace	43	Sabicu	5" min.	12'-14' o.a.
							_	_				
	,	119+61.52	LT	10" + 8"		Poor	into trunk	Remove				
								_				
1		122+10.86	RI		12'-16'	Fair	810 South: Grass lawn	Remove				
	,	122,62.55	, ,	F	121 141		Colortad annimos to be 51 #1 on bottom		4.4			
		122+62.55	LI	5" min.					44			
2		122/01/07	1.7			Boor		To Romain	40			
		122+91.97	LI			P001	yenowing	TO Remain	49			
3		12347871	1.7			Fair	Paynolds School soil planter	To Remain	5.0			
		123170.71	L1		13-20	T dii	Reynold's Sensor Son prancer	10 Nemam	30			
	1 '	124+40.00	1 7	5" min	12'-18' o a		Selected specimen to be FL #1 or better		48			
	Sasied	124140.00	L'	J 111111.	12 -10 U.a.				70			
1	Ground covers - various	303+02.00	RT		1' x 1'	Fair/Poor		Remove				
-	Thrinax radiata		1		3' o.a.	,	. J					
2	FL Thatch Palm	303+02.00	RT		3'	Good	901 South: soil planter	/ Remove				
	Ficus benjamina				6'-8" x		· ·	-				
3	Ficus	303+02.00	RT	1.5"	4'-5'	Fair	901 South: soil planter	Remove				
	Aloe	303+02.00	RT	1'	1' x 1'	Fair	901 South: soil planter	Remove				
	Adonidia merrillii				18'-20' o.a.		1317 Reynolds: leaning into street, soil					
5	Christmas Palm	303+07.65	RT		10'-12'	Fair	planter	Remove				
	Adonidia merrillii				20'-25' o.a.		1317 Reynolds: leaning into street, soil					
6	Christmas Palm	303+14.94	RT		12'-15'	Fair	planter	Remove				
	Cocos nucifera				35'-40' o.a.							
		303+24.80	RT					Remove				
							The state of the s					
8	· · · · · · · · · · · · · · · · · · ·	303+70.38	RT	28"		PROTECT	7 1 1 1 1	To Remain	47			
_	l .							_				
9		304+79.68	RT			Fair	planter	Remove				
		20										
10	Coconut Palm	305+63.84	RT		15'-20'	Fair	planter	Remove				
			1			1	1		1	T. Control of the Con	1	I
	Randia aculeata White Indigo Berry Tree	306+00.00	RT	0.5"	3' x 3'	Fair	910 United: seedling, soil planter	Remove				
	22 23 24 25 26 27 28 29 30 31 1 2 3 1 2 3 4 5 6 7 8	Bucida buceras 21 Black Olive Tree Cocos nucifera 22 Coconut Palm Cassia javanica Apple Blossom Tree Cassia bakeriana Pink Shower Tree Cocos nucifera 23 Coconut Palm Cocos nucifera 24 Coconut Palm Cocos nucifera 25 Coconut Palm Lysiloma sabicu Sabicu Cocos nucifera 26 Coconut Palm Cassia bakeriana Pink Shower Tree Lysiloma sabicu Sabicu Cocos nucifera 27 Coconut Palm Cocos nucifera 28 Coconut Palm Cocos nucifera 29 Coconut Palm Cocos nucifera 29 Coconut Palm Cocos nucifera 30 Coconut Palm Cocos nucifera 30 Coconut Palm Tabebuia heterophylla 31 Pink Trumpet Tree Syagrus romanzoffiana 1 Queen Palm Lysiloma sabicu Sabicu Cocos nucifera 2 Coconut Palm Cocos nucifera 2 Coconut Palm Lysiloma sabicu Sabicu Cocos nucifera 2 Coconut Palm Cocos nucifera 2 Coconut Palm Lysiloma sabicu Sabicu Cocos nucifera 2 Coconut Palm Cocos nucifera 3 Coconut Palm Cocos nucifera 4 Coconut Palm Cocos nucifera 5 Coconut Palm Cocos nucifera 7 Coconut Palm Cocos nucifera 8 FL Thatch Palm Ficus benjamina 8 Ficus 4 Aloe Adonidia merrillii 5 Christmas Palm Cocos nucifera 7 Coconut Palm Cocos nucifera	Bucida buceras 116+66.98	Bucida buceras 21 Black Olive Tree 116+66.98 RT	Bucida buceras 116+66.98 RT 11" Cocos nucifera 117+33.11 RT Cacos nucifera 117+33.11 RT Cassia javanica 117+44.71 LT 3" Cassia bakeriana 118+16.66 LT 3"-4" Cocos nucifera 118+16.66 LT 3"-4" Cocos nucifera 118+48.87 LT Cocos nucifera 118+48.87 LT Cocos nucifera 118+7.35 LT Cocos nucifera 118+7.35 LT Cocos nucifera 118+7.90 RT 5" min. Cocos nucifera Cocos nucifera	Bucida buceras 118	1	Bodica Duceres	Black Station Statio	Description State State Disc. State Hawl Constitute More More Discounting More State Order Free 1766-656 Nr. 17 25-20 Peor Feet African Utility Interest or Comps. Replace 39	March Marc	Process

REVISIONS

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P.E. LICENSE NUMBER 54015

JACOBS ENGINEERING GROUP, INC.
200 W. FORSYTH ST, STE 1520

JACKSONVILLE, FL 32202

Karen.Falkenberry@jacobs.com



TASK ORDER 9-22

PROJECT: SOUTH STREET IMPROVEMENTS LANDS CAPE TABLE (3)

SHEET NO. 26