727 Fort Street

Band Room and School Workshop of Douglass School Campus


Key West Historic District Period of Significance:

1971 First Nomination to the National Register of Historic Places (NRHP) - 1822- 1920

1983 Expansion of District Boundaries in the NRHP – 1822 to 1948


Band Room Building:

The Band Room building is located on the north corner of Fort and Petronia Streets. The structure was part of the Frederick Douglass School Campus which was a segregated High School and served also as the Monroe Junior College. According to the Historic Architectural Survey of the City of Key West the building located at 727 Fort Street is listed as a Contributing Resource to the Historic District with a construction date of 1948. By observing the Sanborn Map from 1948 the site was vacant.

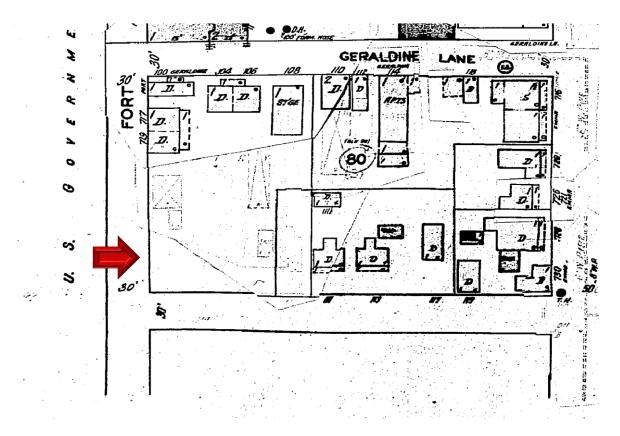

1948 Sanborn Map

The following and last Sanborn Map done for Key West dates from 1962. A similar footprint like the current building is depicted on the site. As the Sanborn Maps were drafted and used for fire insurance purposes, construction materials and precision on combustible elements, cisterns, number of stories, building use, entrances and building configuration were of significance.

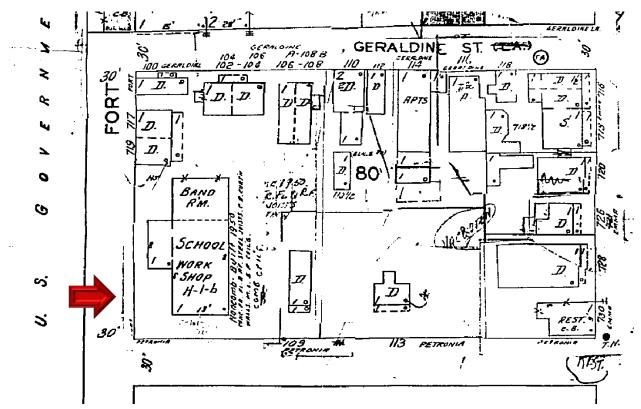

1962 Sanborn Map

The 1962 Sanborn Map includes several notes, in the building's footprint and in the side, some of them ineligible, but they give a precise description of the building:

Use – School Workshop and Band Room and the letters H- 1- b. Those letters are related to structural components;


Framing – H= Unprotected Steel Joists, Columns, Beams, Trusses, Arches.

Floors – 1= Reinforced Concrete

Roof – b= Concrete or Gypsum on Metal Lath, Incombustible Form Boards, Paperbacked Wire Fabric, Steel Deck, and Cellular, Ribbed or Corrugated Steel Units.

Side Notes - Noncomb. [non-combusting] Built 1950

C B Curtain Walls meaning Concrete block construction walls with large window openings.

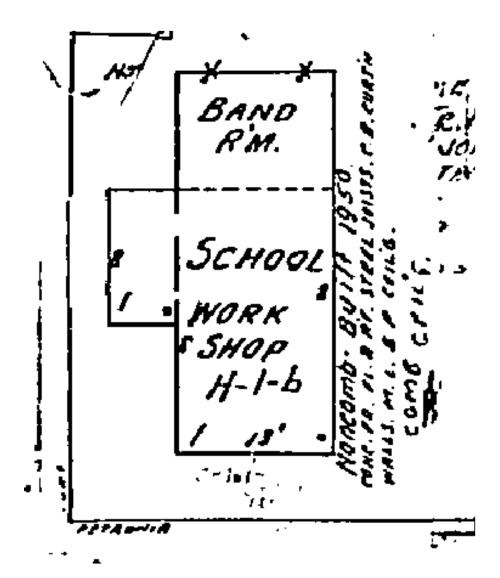

Enlarged view of the 1962 Sanborn Map with notes



727 Fort Street circa 1965. Photograph taken from Petronia Street.

Monroe County Library.

Staff Review and Approval of Proposed New Plans for a Clinic:

On June 15, 2020 the Building Department received plans for improvements to the building located at 727 Fort Street under building permit number 2020-1808. At the time of this report building permit status is still under review. For the exterior renovations the plans include new windows and openings on blocked walls, new doors, canopy at entry facing Fort Street, textures in some areas over the stucco, and an 18" parapet addition to resolve roof drainage problems and serve as an element to conceal solar panels and mechanical equipment. Staff reviewed the project and on July 27, 2020 approved the plans with the following conditions:

7/27/2020 9:40:33 AM (Enid Torregrosa)

**** Exterior windows and doors sample glass to be submitted to staff prior to installation of any window and door. Glass to be clear.ET***

Proposed windows and doors frames will be dark bronze anodized. Windows will have metal frames and will be single panel.

Staff Opinion:

It has always been staff's opinion that the current building has lost architectural integrity nor should have been listed as a contributing resource to the historic district. First most, the building was built two years after the period of significance of the Key West Historic District, as noted above in the 1962 Sanborn map notes. Most likely the 1948 date was taken from the Property Appraiser's record, which regularly includes inaccurate construction dates for buildings, particularly those built before 1960. This building cannot be contributing to a historic district that has a period of significance ending prior to the year it was constructed.

When a building is designated contributing it means that the structure *contributes* to the reasons a historic district is nominated and that the building, structure, or site must preserve its historical integrity. By studying historic photographs and comparing them with the current state of the building it is evident that the structure has lost its integrity. The character defining features of the building were its form, projecting eyebrow eaves, void and solid rhythm (ratio of exterior wall vs. windows), and awning windows with metal frames. Through time, fenestrations were completely blocked or resized with cement blocks, awning windows were removed, and the eyebrow eaves were removed from all elevations. These changes have unequivocally destroyed the building's architectural historic integrity, as only its form has been retained.


Staff approved with conditions the project as the design does not propose any alterations to the building form; its design includes new openings with new windows facing Fort Street, its principal façade. It also includes a canopy that relates to the eyebrow eaves that were removed at some point from the building. Lastly the parapet wall is crucial in the design as it will help the roof with current drainage problems and will serve to conceal mechanical equipment and solar panels.

The Band Room building as well as the Douglass Gym building are the only remaining structures that were part of the Frederick Douglass Campus that narrates the story about segregated learning places for Key West residents and their descendants. The exterior concrete walls of the Band Room building are echo that past. New sensible adaptive uses that bring a new life to the building are necessary to its continuous use. Staff opines that the proposed design will bring back several architectural elements that were lost in time. This building has a history in our community but it is not a contributing building to the historic district.



Current Front Street Façade.

MAP OF BOUNDARY SURVEY

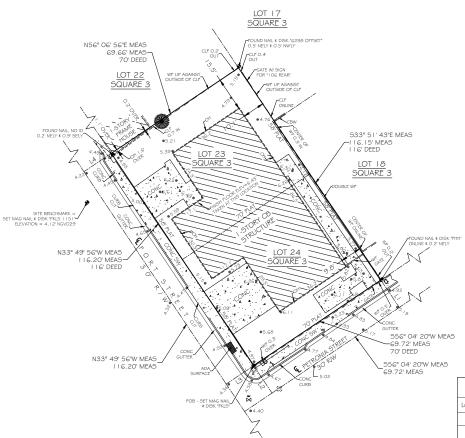





Parcel Line Table									
Line #	Length	Direction							
LI	15.00' MEAS	N33° 55' 40"W MEAS							
L2	15.00' MEAS	N33° 55' 40"W MEAS							
L3	15.00' MEAS	N56° 10' 04"E MEAS							
L4	15.00' MEAS	N56° 10' 04"E MEAS							

SURVEYORS NOTES

- DURVEYORS NOTES

 HORIZONTAL COORDINATES AND BEARINGS SHOWN ARE REFERENCED TO GRID NORTH, BASED ON THE 2011 ADJUSTMENT OF THE NORTH AMERICAN DATUM OF 1983 (NAD 83/2011), OF THE FLORIDA STATE PLANE COORDINATE SYSTEM (TRANSVERSE MERCATOR PROJECTION), EAST ZONE (0901).

 COORDINATES WERE ESTRABLISHED BY A REAL-TIME KINEMATIC (RTK), GNSS CONTROL SURVEY WHICH IS CERTIFIED TO A 2 CENTIMETER LOCAL ACCURACY, RELATIVE TO THE NEAREST CONTROL POINT WITHIN THE NATIONAL GEODETIC SURVEY (NGS) GEODETIC CONTROL NETWORK.

 METHOD: WIDE AREA CONTROL NETWORK.

 METHOD: WIDE AREA CONTROLINOUSLY) OFFERSTING GPS REFERENCE STATION NETWORK (TRIMBLE VRS).

 ELEVATIONS SHOWN HEREON ARE IN FEET AND BASED ON THE NATIONAL GEODETIC VERTICAL DATUM OF 1929 (NGVD 1929).

 EDENCHMARK DESCRIPTION: NATIONAL GEODETIC SURVEY BENCHMARK '872 4580 TIDAL ABSIC' (P. 1). AAOOOS), ELEVATION—14.32' (NGVD 1929).

 ADDITIONS OR DELETIONS TO SURVEY MAY DOR REPORT BY OTHERS THAN THE SIGNING PARTY IS PROHIBITED WITHOUT THE WRITTEN CONSENT OF THE SIGNING PARTY.

 THE UNDERGROUND UTILITIES SHOWN HEREON HAVE BEEN LOCATED FROM HEILE DEVIDENCE. THE SURVEY MAKES NOS QUARANITES THAT THE UNDERGROUND UTILITIES SHOWN HEREON ENCOMPASS ALL SUCH UTILITIES IN THE AREA, ETHER IN SERVICE OR ABASDONED. FURTHERMORE THE SURVEYOR DOES NOT WARRANT THAT THE UNDERGROUND UTILITIES SHOWN HEREON ENCOMPASS ALL SUCH UTILITIES IN THE EXACT LOCATION INDICATED ALTHOUGH HE DOES CERTIFY THAT THEY ARE LOCATED AS ACCURATED FROM THE EVIDENCE AVAILABLE. THE SURVEYOR HAS NOT PHYSICALLY LOCATED THE UNDERGROUND UTILITIES.

 STREET ADDRESS: 727 FORT STREET, KEY WEST, FL 33040.

 ALL UNITS ARE SHOWN IN U. S. JURVEY FET.

 ALL FIELD DATA WAS ACQUIRED BETWEEN OGIO 1/2016 07/07/2016.

 COMMUNITY NO.: 12016 GB

 MAP NO.: 12087C-1516 KB

 MAP DATE: 02-18-05

 FIRM REVISION DATE: 06-05-15

 FLOOD ZONE: AE

 BASE ELEVATION: 6

 REVISION (1) 05/21/2020 REVISED CERTIFICATIONS

LEGAL DESCRIPTION -

LEGAL DESCRIPTION - In the City of Key West, Lot #23 and Lot #24 Square 3 Tract 3, according to T.A. Ashe's diagram recorded in Deed Book I, Page 77. Commencing at the corner of Fort and Petronia Streets, running thence along the said Fort Street in a northwesterly direction I of Feet; thence at night angles in a northeasterly direction I of feet; thence at night angles in a southeasterly direction To feet; thence at night angles in a southeasterly direction TO feet to Petronia Street; thence in a southwesterly direction 70 feet to Fetronia Street; thence in a southwesterly direction 70 feet to Fetronia Street; thence as no southwesterly direction 70 feet to Fetronia Street; thence as no southwesterly direction 70 feet to Fetronia Street the Street I fetronia Street to Street to the point of beginning.

CERTIFIED TO The City of Key West;
Architectura Group Miami;
Community Health of South Flonda, Inc.;

MEAGURED DIMENSIONE GOLD ON THE STREET OF TH

TOTAL AREA = $8,096.13 \text{ SQFT} \pm$





O - WATER METER

- SANITARY SEWER CLEAN OUT

O:- WOOD POWER POLE - CONCRETE POWER POLE

W - WATER VALVE

- GLY WIRE

(3) - SANITARY SEWER MANHOLE

+ P- SPOT GRADE ELEVATION (TYPICAL)







EXISTING BUILDING RENOVATION

CHI - COMMUNITY HEALTH OF SOUTH FLORIDA INC. 727 FORT STREET, Key WEST, FL 33040

SCOPE OF Permit Application: EXISTING BUILDING TOTAL RECONSTRUCTION FOR MEDICAL CENTER



ZONING DATA

PRIMARY ZONING:

LAND USE: COMMERCIAL EXEMPT (100E) AREA CALCULATIONS

TOTAL AREA = 3,500 Sq.Ft

LEGAL DESCRIPTION

IN THE CITY OF KEY WEST, LOT #23 AND LOT #24 SQUARE 3 TRACT 3, ACCORDING TO T.A. ASHE'S DIAGRAM RECORDED IN DEED BOOK 1, PG 77. COMMENCING AT THE CORNER OF FORT AND PETRONIA STREETS. DIRECTION 70 FT; THENCE AT RIGHT ANGLES IN A SE DIRECTION 116 FT TO PETRONIA STREET; THENCE IN A SW DIRECTION 70 FT TO FORT STREET TO THE POINT OF BEGINNING

FOLIO NUMBERS - 00013990-000000

SCOPE OF WORK DESCRIPTION

CONSTRUCTION OF NEW MEDICAL CENTER BASED ON THE PRE APPROVED PLANS UNDER PLANNING PZ 18-606. APPROVED PLANNING AND ZONING PLANS UPDATED FOR REFERENCE

PROJECT DATA

BUILDING GROUP: EXISTING "B"

BUILDING TYPE:

ALTERATION LEVEL: LEVEL III

DRAWING LIST

A0.00 - COVER SHEET

A0.01 - GENERAL NOTES

- SURVEY

- CIVIL PLAN

- CIVIL DETAILS - CIVIL NOTES

A1.01 - SITE PLAN

A1.02 - DEMO PLAN

A1.03 - PROPOSED PLANS

A1.04 - LIGHTING PLAN

A1.05 - LIFE SAFETY PLAN

A1.06 - FLOORING PLAN

A1.07 - REST ROOM PLANS AND ELEV.

A1.08 - TYP ADA DETAILS

A1.09 - ROOM FINISH SCHED.

A1.10 - DOOR & WINDOW SCHED

A2.01 - ELEVATIONS

A3.01 - BUILDING SECTIONS

A3.02 - SOLAR PANEL SECTION DETAILS

A3.03 - PARAPET SECTION DETAILS

A3.04 - ROOF CURB SECTION DETAILS

A3.05 - SOLAR CONNECTION DETAILS A3.06 - INTERIOR ARCH DETAILS

A4.01 - WATER PROOFING DETAILS A4.02 - SOLAR WATER HEATER MSDS S-0 - STRUC NOTES SCHDLS

S-1 - FOUNDATION PLAN

S-2 - ROOF PLAN

S-3 - INTERIOR COLUMN DETAILS

S-4 - CMU WALL FILL DETAILS

E1.00 - INDEX SYMB NOTES

E1.01 - POWER PLAN

E1.02 - LIGHTING PLAN

E1.03 - ROOF ELECTRICAL PLAN

E1.04 - PANEL SCHED RISER DIAGRAM

M1.00 - INDEX SYMB NOTES M1.01 - MECHANICAL PLAN

M1.02 - ROOF MECH PLAN

M2.00 - DETAILS AND CONTROLS

M2.01 - MECH SCHED

P1.00 - INDEX SYM NOTES

P1.01 - DOMESTIC WATER PLAN

P1.02 - SANITARY PLAN

P1.03 - ROOF PLUMBING PLAN

P2.00 - DOMESTIC WATER ISO

P2.01 - SANITARY ISO

CODE CONFORMANCE

- ALL WORK IS DESIGNED TO CONFORM TO

- FLORIDA BUILDING CODE (FBC) 2017 EDITION

- NFPA 1, 101 LIFE SAFETY CODE AND F.F.P.C.- 6th ED

PLUMBING FIXTURE COUNTS

PER 2017 FBC-B SECTION 2902.1.1 AND 2902.2 **AND TABLE 2902.1**

OCCUPANCY B MAX OCCUPANCY 35

MALE OCCUPANTS 18 **FEMALE OCCUPANTS 18**

REQUIRED PER TABLE 2902.1

- 1 MALE + 1 FEMALE LAVATORIES - 1 MALE + 1 FEMALE DRINKING FOUNTAIN - 1

SERVICE SINK

PROVIDED PER TABLE 2902.1

- 2 UNISEX ADA + 1 - 2 UNISEX ADA + 1 LAVATORIES

DRINKING FOUNTAIN - 1

SERVICE SINK

architectura mıamı **ARCHITECTURA**

GROUP MIAMI

INTERIOR DESIGN

E-MAIL: argroupinc@aol.com AGMiami.Inc@Gmail.com

AA26001885 1920 E HALLANDALE BLVD., PH-HALLANDALE, FLORIDA 33009 PH: 954-558-3024

CHI - COMMUNITY HEALTH of SOUTH **FLORIDA**

RENOVATION

COVER SHEET

269.20 PERMIT sue date

A0.00

1. DESIGN CRITERIA: 2017 FLORIDA BUILDING CODE.

2. SOIL:

a) GEOTECHNICAL EVALUATION AND RECOMMENDATION OF SOIL IS REQ'D.

DESIGN SOIL BEARING PRESSURE = 2500 PSF

b) TOP SOIL AND ALL ORGANIC AND DELETERIOUS MATERIAL SHALL BE COMPLETELY REMOVED AT LEAST FIVE FEET BEYOND THE EXTERIOR OF EACH BUILDING. CLEAN WELL GRADED SAND SHALL BE USED FOR BACK FILL, INSTALLED IN MAXIMUM OF 9" LIFTS. EACH LIFT OF FILL SHALL BE COMPACTED TO 98% OF MODIFIED

PROCTOR DENSITY DETERMINED IN ACCORDANCE WITH ASTM D-1557.

STRUCTURAL STEEL:

a) SHALL CONFORM TO ASTM DESIGNATIONS A-36, A-325, A-500 AS APPLICABLE AND AISC SPECIFICATIONS FOR THE DESIGN, FABRICATION AND ERECTION OF STRUCTURAL STEEL FOR BUILDINGS DATED 1989. BOLTS AND WELDING MATERIALS SHALL CONFORM TO APPLICABLE PROVISIONS OF AISC SPECIFICATIONS, AND AWS RECOMMENDATIONS.

b) FIELD CONNECTIONS SHALL BE WELDED OR BOLTED AS SPECIFIED. SHOP WELDING OR WHERE FIELD WELDING IS REQUIRED SHALL BE CERTIFIED WELDERS ONLY. ALL STRUCTURAL STEEL SHALL RECEIVE ONE SHOP COAT OF RUST INHIBITIVE PRIMER PAINT UNLESS NOTED OTHERWISE.

c) THE FABRICATOR SHALL SUBMIT SHOP DRAWINGS FOR REVIEW AND ACCEPTANCE PRIOR TO FABRICATION.

4. CONCRETE:

a) ALL CONCRETE UNLESS OTHERWISE NOTED: fc = 3000 PSI

FOOTING AND SLAB: fc = 2500 PSI - OR AS PER STRUCTURAL ENGINEER NOTES b) SUBMIT MIX DESIGN FOR ACCEPTANCE PRIOR TO CONCRETE PLACEMENT.

5. CONCRETE CONSTRUCTION:

ALL CONCRETE CONSTRUCTION SHALL BE IN ACCORDANCE WITH AMERICAN CONCRETE INSTITUTE STANDARD: "BUILDING CODE REQUIREMENTS FOR REINFORCED CONCRETE" (ACI 318-89). STRENGTH

DESIGN METHOD. 6. CONCRETE COVER:

a) FOOTINGS AND FOUNDATION PADS PLACED AGAINST THE GROUND 3".

b) CONCRETE SURFACE AFTER REMOVAL OF FORMS EXPOSED TO WEATHER OR GROUND

No. 5 OR SMALLER 1-1/2"

No. 6 OR LARGER 2"

c) CONCRETE NOT EXPOSED TO WEATHER OR GROUND:

SLABS AND WALLS 3/4"

BEAMS AND GIRDER TIES 1-1/2" COLUMN TIES 1-1/2"

7. REINFORCING STEEL:

a) REINFORCING STEEL SHALL BE NEW BILLET BARS CONFORMING TO: ASTM A-615 GRADE 60 (#3 THRU #11) fy=60000 PSI

b) ALL TERMINATING TOP REINFORCING BARS SHALL END WITH A HOOK.

8. DETAILING AND FABRICATION OF REINFORCING: a) UNLESS OTHERWISE NOTED, SHALL FOLLOW ACI-315.

b) SUBMIT SHOP DRAWINGS FOR REVIEW AND ACCEPTANCE PRIOR TO FABRICATION.

9. PLACING AND SUPPORTS OF REINFORCING BARS:

SHALL FOLLOW CRSI "RECOMMENDED PRACTICE FOR PLACING REINFORCING BARS, INCLUDING 1983

SUPPLEMENT" AND ACI-315.

10. CORNER BARS:

PROVIDE #5 X 3'-0" X 3'-0" CORNER BARS AT EXTERIOR CORNERS OF BEAMS AND WALLS. ONE FOR EACH HORIZONTAL LAYER OF REINFORCING

11. WELDED WIRE FABRIC:

WELDED WIRE FABRIC SHALL CONFORM TO ASTM A-185 OR A-497 AS APPLICABLE.

12. CONCRETE MASONRY UNITS:

a) THE LOAD BEARING MASONRY WALLS ARE DESIGNED IN ACCORDANCE WITH THE SPECIFICATIONS FOR THE DESIGN AND CONSTRUCTION OF LOAD BEARING CONCRETE MASONRY BY THE NATIONAL CONCRETE MASONRY ASSOCIATION AND BUILDING CODE REQUIREMENTS FOR CONCRETE MASONRY STRUCTURES - ACI

b) MINIMUM COMPRESSIVE STRENGTH OF LOAD BEARING MASONRY UNITS SHALL BE 1900 PSI (ASTM C90-90, GRADE N) MASONRY CEMENT (MORTAR) SHALL COMPLY WITH ASTM C91 AND SHALL ACHIEVE A MINIMUM COMPRESSIVE STRENGTH OF 2500 PSI (ASTM C270, TYPE M)

c) MASONRY SHALL BE PLACED PRIOR TO PLACING CONCRETE COLUMNS.

d) ALTERNATE HORIZONTAL JOISTS SHALL BE REINFORCED WITH #9 GAUGE GALVANIZED LADDER TYPE REINFORCING CONFORMING TO ASTM A82 CONTINUOUS IN ALL 8" CONCRETE MASONRY WALLS. THESE SHALL LAP INTO THE CONCRETE COLUMNS.

e) AT ALL WALL ENDS, INTERSECTIONS, CORNERS AND ON EACH SIDE OF WALL OPENINGS, IF A COLUMN IS NOT SHOWN PROVIDE (1) #5 VERTICAL AND GROUT THE REINFORCED CELL OF THE BLOCK. USE DOWELS AND MAINTAIN CONTINUITY WITH THE STRUCTURE ABOVE. TERMINATE BAR WITH A STANDARD HOOK

INSIDE THE CONCRETE BEAM AT TOP OF THE WALL. f) PROVIDE CLEAN OUT OPENINGS FOR EACH GROUTED CELL.

q) SUBMIT CERTIFICATION OF COMPLIANCE WITH ASTM SPECIFICATIONS FOR THE CMU, MASONRY CEMENT, AND REINFORCING PRIOR TO DELIVERY TO THE SITE. H. ALL LAP SPLICES 48 BAR DIAMETER.

i) PROVIDE COURSE GROUT IN ACCORDANCE w/ ASTM C476 f'c = 2500 PSI SLUMP; 8"

13. OPENINGS IN STRUCTURAL MEMBERS:

a) HOLES AND OPENINGS REQUIRED ARE SHOWN ON THESE DRAWINGS.

b) NO OTHER OPENINGS OR HOLES IN ANY STRUCTURAL MEMBER ARE PERMITTED WITHOUT WRITTEN AUTHORIZATION OF THE ARCHITECT OR ENGINEER.

c) ALL ROUGH OPENINGS AROUND OR AFFECTED BY MECHANICAL, ELECTRICAL, OR PLUMBING EQUIPMENT; OR WINDOWS, DOORS OR OTHER ARCHITECTURAL FEATURES SHALL BE VERIFIED WITH THE ACTUAL PURCHASED ITEM PRIOR TO PROCEEDING WITH THE STRUCTURAL WORK AFFECTED. NOTIFY THE ARCHITECT IF DIMENSIONAL REQUIREMENTS VARY FROM THOSE INDICATED.

GENERAL NOTES:

THE SEQUENCE OF OPERATIONS AND PLACES OF COMMENCEMENT OF THE WORK SHALL BE THE RESPONSIBILITY OF THE GENERAL CONTRACTOR IN ORDER TO MEET THE REQUIREMENTS OF CONSTRUCTION.

THE GENERAL CONTRACTOR SHALL OBTAIN ALL PERMITS FOR WORK UNDER THIS CONTRACT.

THE REMOVAL OF ALL TEMPORARY INSTALLATIONS SHALL BE THE RESPONSIBILITY OF THE GENERAL CONTRACTOR AND BRING THE DISTURBED AREA BACK TO ORIGINAL CONDITION.

CONTRACTOR IS RESPONSIBLE FOR COORDINATING ALL PLANS, DETAILS, AND NOTES AND REPORTING ANY DISCREPANCIES IN WRITING TO ARCHITECT PRIOR TO CONSTRUCTION. ANY ERRORS CAUSED BY DISCREPANCIES SHALL BE RECTIFIED AT THE CONTRACTOR'S SOLE EXPENSE.

THE CONTRACTOR SHALL PREVENT UNAUTHORIZED PERSONNEL FROM ACCESS TO CONSTRUCTION AREAS.

ANY WORK NOT SHOWN ON THE DRAWING BUT CONSIDERED NECESSARY FOR THE COMPLETION OF THE WORK IN PROPER MANNER SHALL BE PROVIDED BY THIS CONTRACTOR WITHOUT ADDITIONAL CHARGE.

ALL WORK SHALL BE DONE IN ACCORDANCE W/ ALL APPLICABLE NATIONAL, STATE & LOCAL CODES AND ORDINANCES. WORK SHALL BE DONE IN A WORKMAN LIKE MANNER AS PER STANDARD BUILDING TECHNIQUES AND PRACTICES.

G.C. IS RESPONSIBLE FOR ALL SAFETY CONDITIONS RELATING TO JOB CONSTRUCTION.

G.C. IS TO VISIT THE SITE AND CAREFULLY INSPECT THE EXISTING CONDITIONS AFFECTING THE WORK. ANY DISCREPANCIES BETWEEN THE DRAWINGS AND EXISTING CONDITIONS MUST BE REPORTED TO ARCHITECT IN WRITING.

10. ALL SUBCONTRACTORS SHALL MAKE A SITE VISIT TO VERIFY CONDITIONS PRIOR TO BIDDING. VERIFY EXISTING STRUCTURAL AND UTILITIES PRIOR TO COMMENCEMENT OF WORK

11.G.C. IS TO CONTROL JOB CLEANING TO PREVENT DIRT, DEBRIS AND DUST FROM THE PREMISES BEING

12.NO SUBSTITUTIONS ARE TO BE MADE WITHOUT APPROVAL BY ARCHITECT. G.C. IS TO SUBMIT SUBSTITUTE MATERIAL SPECIFICATIONS AND SAMPLE FOR APPROVAL, IN WRITTING TO ACHITECT, PRIOR TO COMMENCEMENT OF WORK.

13. ALL NEW FLOOR FINISHES NOT TO EXCEED 1/2" MAX, VERTICAL OFFSET,

14.NO TOXIC OR COMBUSTIBLE MATERIALS TO BE USED ABOVE FINISH CEILING LINE.

15.G.C. TO COORDINATE DISCONECTION AND RECONNECTION OF ALL UTILITIES AS REQUIRED FOR COMMENCEMENT AND COMPLETION OF WORK.

16.G.C. TO VERIFY ALL ITEMS AND/ OR SERVICES TO BE PROVIDED.

17, G.C. TO INSTALL CEILING GRID TIE WIRES AS PER CODE. GRID TIE WIRES TO ATTACH TO STRUCTURE ABOVE. DO NOT ATTACH TO HVAC DUCT.

18. CONTRACTOR SHALL VERIFY ALL EXISTING UNDERGROUND UTILITIES IN THE AREA OF NEW CONSTRUCTION AND TAKE THE APPROPRIATE MEASURES THAT THESE REMAIN UNDAMAGED.

19. CONTRACTOR SHALL COORDINATE THE INSTALLATION OF NEW UTILITIES WITH THE EXISTING ADJACENT UTILITIES. IF THE CONSTRACTOR FINDS A CONFLICT WITH THE EXISTING AND THE NEW, HE SHALL CONTACT THE ARCHITECT IN WRITING.

20. WHERE PRESENT WORK IS DAMAGED IN THE EXECUTION OF THIS CONTRACT, OR WHERE OPENINGS ARE LEFT DUE TO THE REMOVAL OF PIPES, EQUIPMENT OR APPARATUS, THE SAME SHALL BE REPAIRED OR CLOSED UP TO CORRESPOND IN MATERIAL, QUALITY, SHAPE, AND FINISH WITH THAT OF SIMILAR AND ADJOINING WORK, UNLESS OTHERWISE CALLED FOR. WHERE DAMAGE IS NOT REPAIRABLE, NEW ITEMS OR EQUIPMENT SHALL BE PROVIDED.

21. THE CONSTRUCTION SHALL INCLUDE THE FURNISHING OF ALL MATERIALS, EXTENSIONS, CONNECTIONS, CUTTING, PATCHING, PAINTING, REPAIRING, ADAPTING AND OTHER WORK, INCIDENTAL TO, AND TOGETHER WITH SUCH TEMPORARY CONNECTIONS AS MAY BE REQUIRED. THE CONSTRUCTION SHALL ALSO INCLUDE THE REMOVAL OF MATERIALS AS DIRECTED.

22. ALL MEASUREMENTS MUST BE VERIFIED AND CHECKED PRIOR TO COMMENCEMENT OF WORK. REPORT ANY DISCREPANCIES TO ARCHITECT/ENGINEER BEFORE PROCEEDING WITH WORK AND REQUEST CLARIFICATION.

23. STORE MATERIALS IN A SAFE AND APPROVED LOCATION.

24. CLEAN UP ALL RUBBISH, REFUSE, SCRAP MATERIALS, AND DEBRIS CAUSED BY THIS PROJECT AT THE END OF EACH DAY, AND INSURE THAT THE SITE OF WORK SHALL PRESENT A NEAT, ORDERLY, AND WORKMANLIKE

25. ALL MATERIALS AND EQUIPMENT SPECIFIED SHALL BE NEW AND ALL WORKMANSHIP SHALL BE FIRST CLASS.

26. THE GENERAL CONTRACTOR SHALL BE RESPONSIBLE FOR OVERALL COORDINATION WITH ALL SUBCONTRACTORS WHETHER UNDER CONTRACT TO HIM OR TO THE OWNER.

27. ALL WOOD IN CONTACT WITH MASONRY SHALL BE PRESSURE TREATED.

28. THE GENERAL CONTRACTOR SHALL FURNISH ALL LABOR, MATERIALS, AND EQUIPMENT (UNLESS OTHERWISE NOTED) REQUIRED FOR THE COMPLETION OF THE JOB IN ACCORDANCE WITH THESE DRAWINGS.

29. THE GENERAL CONTRACTOR SHALL PRESENT THE JOB TO THE OWNER FOR ACCEPTANCE CLEAN AND READY FOR OCCUPANCY. ALL GLASS SHALL BE CLEANED AND POLISHED, FLOORS SWEPT BROOM CLEAN, CARPETS VACUUMED, FIXTURES WASHED AND U.L. LABELS REMOVED.

30. GENERAL CONTRACTOR SHALL SUBMIT PRODUCT APPROVALS PER SECTION 2410,4 OF THE FLORIDA BUILDING CODE FOR THE NECCESSARY ITEMS FOR ARCHITECTS APPROVAL AS WELL AS SHOP DRAWINGS BEFORE ORDERING AND NSTALLATION.

31. GENERAL CONTRACTOR TO COORDINATE WITH MECHANICAL, PLUMBING, ELECTRICAL, AND STRUCTURAL DRAWINGS FOR COMPLETE SCOPE OF WORK, DRAWING SHOWN FOR REFERENCE ONLY

31. ALL TRADES SHALL BE RESPONSIBLE TO READ ALL DETAILS AND SPECIFICATION, AND PLANS. IF ANY CONFLICTS EXIST, THAT TRADE SHALL NOTIFY THE CONTRACTOR PRIOR TO CONSTRUCTION

32. CONTRACTOR SHALL DIRECT ANY DISCREPANCIES, IN WRITING, TO THE ARCHITECT OF RECORD PRIOR TO CONSTRUCTION. CONTRACTOR SHALL BE RESPONSIBLE FOR WORK WHICH PROCEEDS WITHOUT DUE COURSE AND COORDINATION,

33. ALL GLASS IN DOORS AND ALL SLIDING GLASS DOORS TO BE SAFETY GLASS

34. ALL BATHROOM FLOORS AND BASES SHALL BE OF IMPERVIOUS MATERIAL, SLIP PROOF TO MEET ADA.

35. ALL FIXED GLASS TO BE 1/4" THICK UNLESS OTHERWISE NOTED.

36. SOIL COMPACTION TEST REPORT SHALL BE SUBMITTED TO THE BUILDING DEPARTMENT PRIOR TO COMMENCING CONSTRUCTION.

37. TERMITE TREATMENT CERTIFICATE SHALL BE SUBMITTED TO THE BUILDING DEPARTMENT PRIOR TO CONSTRUCTION, AFTER SOIL COMPACTION.

THE BUILDING CONTRACTOR WHO HAS ENTERED INTO A CONSTRUCTION CONTRACT WITH THE OWNER IS RESPONSIBLE FOR ALL WORK DEFINED BY THAT CONTRACT. IF THE PROJECT IS LET UNDER SEPARATE CONTRACTS TO MORE THAN ONE CONTRACTOR, THE RESPONSIBILITIES LISTED BELOW APPLY TO EACH CONTRACTOR

THE CONTRACTOR IS RESPONSIBLE FOR THE COMPLETION OF THE PROJECT IN THE TRUE INTENT OF THE DRAWINGS AND SPECIFICATIONS. THE CONTRACTOR IS TO FURNISH ALL MATERIALS AND LABOR REQUIRED TO COMPLETE THE PROJECT.

THE CONTRACTOR SHALL ADVISE THE OWNER OF ANY CONFLICT BETWEEN THESE DRAWINGS AND THE FIELD CONDITIONS BEFORE PROCEEDING WITH THE JOB. THE CONTRACTOR SHALL ASSUME ALL RESPONSIBILITY FOR THE ACCURACY OF FIELD MEASUREMENTS AND CONDITIONS AND SHALL BE RESPONSIBLE FOR THE PROPER TRADES. WRITTEN APPROVAL MUST BE OBTAINED FROM THE ARCHITECT BEFORE ANY CHANGES AND/OR DEVIATIONS FROM THE DRAWINGS / SPECS ARE MADE THE CONTRACTOR SHALL

ASSUME FULL RESPONSIBILITY FOR THE EXECUTION OF HIS/HER WORK AND FOR ANY MODIFICATIONS TO ANY EXISTING WORK, PREVIOUSLY INSTALLED WORK, AND/OR OTHER CHANGES AND/OR DEVIATIONS FROM THE DRAWINGS OR SPECIFICATIONS MADE WITHOUT PRIOR WRITTEN APPROVAL FROM THE OWNER AND/OR THE ARCHITECT ANY COSTS RESULTING FROM CHANGES AND/OR DEVIATIONS FROM ARCHITECT PLANS SHALL BE THE RESPONSIBILITY OF THE CONTRACTOR.

A COMPLETE SET OF DRAWINGS MUST BE KEPT AT THE JOB SITE AT ALL TIMES AND ANY CHANGES MUST BE NOTED THEREON AND INITIALED AT THE TIME THE CHANGE OR DEVIATION IS PERFORMED

THE GENERAL CONTRACTOR SHALL DO ALL PATCHING TO CONFORM TO MATERIAL, TEXTURE AND SURFACE ALIGNMENT WITH THE ADJOINING SURFACE AND FINAL TOUCH UP/APPEARANCE OF ALL FINISHED SURFACES. THE CONTRACTOR SHALL ENSURE THE PROTECTION OF ALL EQUIPMENT FURNISHED UNDER HIS/HER CONTRACT AND BY OTHERS PRESENT AT THE JOB SITE.

THE CONTRACTOR SHALL REMOVE DEBRIS AND MAINTAIN THE PREMISES BROOM CLEAN AT ALL TIMES. DEBRIS IS TO INCLUDE, BUT NOT LIMITED TO SHIPPING CARTONS, BOXES, ETC., RESULTING FROM THE INSTALLATION OF DENTAL AND OTHER EQUIPMENT AND MATERIALS, BY CONTRACTORS CONCURRENTLY ENGAGED.

44. THE CONTRACTOR SHALL PARTICIPATE AT ALL JOB COORDINATION MEETINGS WITH ARCHITECT AND ENSURE THE ATTENDANCE OF APPLICABLE TRADES.

45. THE CONTRACTOR IS REQUIRED TO INFORM ARCHITECT REPRESENTATIVES OF KEY EVENTS IN THE CONSTRUCTION PROCESS WITH REASONABLE ADVANCE NOTICE, TO FACILITATE THE INSPECTION OF SAID EVENTS, I.E. BACKFILLING TRENCHES, CLOSING WALLS, POURING CONCRETE TO BURY PLUMBING AND ELECTRICAL WORK IN FLOORS AND INSTALLING CELLING TILES.

46. THE CONTRACTOR SHALL AFFORD THE OWNER AND SEPARATE CONTRACTORS REASONABLE OPPORTUNITY FOR THE INTRODUCTION AND/OR STORAGE OF THEIR MATERIALS AND EQUIPMENT AND EXECUTION OF THEIR WORK.

CONTRACTOR IS RESPONSIBLE FOR COORDINATING ALL PLANS, DETAILS, AND NOTES AND REPORTING ANY DISCREPANCIES IN WRITING TO ARCHITECT PRIOR TO CONSTRUCTION, ANY ERRORS CAUSED BY DISCREPANCIES SHALL BE RECTIFIED AT THE CONTRACTOR'S SOLE EXPENSE.

FLAME SPREAD - INTERIOR FINSHES

AS PER F.B.C. 2-17 - TABLE 803.1.1 AND 803.11 MINIMUM INTERIOR FINISH CLASSIFICATION 'C', FLAMESPREAD 76-200, SMOKE DEVELOPED 0-450.

INTERIOR FLOORING materials shall comply with Sections 804.4.1 and 804.4.2 and interior floor finish materials shall comply with Section 804.4.2., AND MEET MINIMUM A.D.A. RECOMMENDED SPECIFICATIONS FOR SUSTAINABLE SLIP RESISTANCE OF NEW FLOORING IS THAT THE "WET" P.T.V. (Pendulum Test Value) AFTER 500 CYCLES OF ABRASION SHOULD BE 35 OR HIGHER.

PRODUCT APPROVALS:

PRIOR TO INSTALLATION, CONTRACTOR TO SUBMIT TO ARCHITECT FOR APPROVAL PRODUCT APPROVALS FOR

1. ALL EXTERIOR WALL CLADDING, SURFACING, DOORS, AND WINDOWS

2. ROOFING COMPONENTS AND ASSEMBLIES



ARCHITECTURA GROUP MIAMI

ARCHITECTURE INTERIOR DESIGN PLANNING AA26001885 ID 00003873

1920 E HALLANDALE BLVD., PH-11 HALLANDALE, FLORIDA 33009 PH: 954-558-3024 E-MAIL: argroupinc@aol.com AGMiami.Inc@Gmail.com

S LAW COPYRIGHTS AND OTHER PROPER ORM OR MATTER: WHATSOEVER, NOR ARE TH ERMISSION, CONSENT, AND APPROPRIAT DMPENSATION TO ARCHITECTURA GROU RECEDENCE OVER SCALE DIMENSION CONTRACTOR SHALL VERIFY AND ESPONSIBLE FOR DIMENSIONS AI GROUP MIAMI TO BE NOTIFIED IN WRITING CONDITIONS AND SPECIFICATIONS APPEARING NOTHERS PLANS (c) 2020.

Description

CHI - COMMUNITY HEALTH of SOUTH

FLORIDA

WEST N


SIGN & SEAL

Registered Architect # AR 94560

GENERAL NOTES

Drawn by	N.P.
Checked by	E.P.
Project Number	269.20
Issued for	PERMIT

A0.01

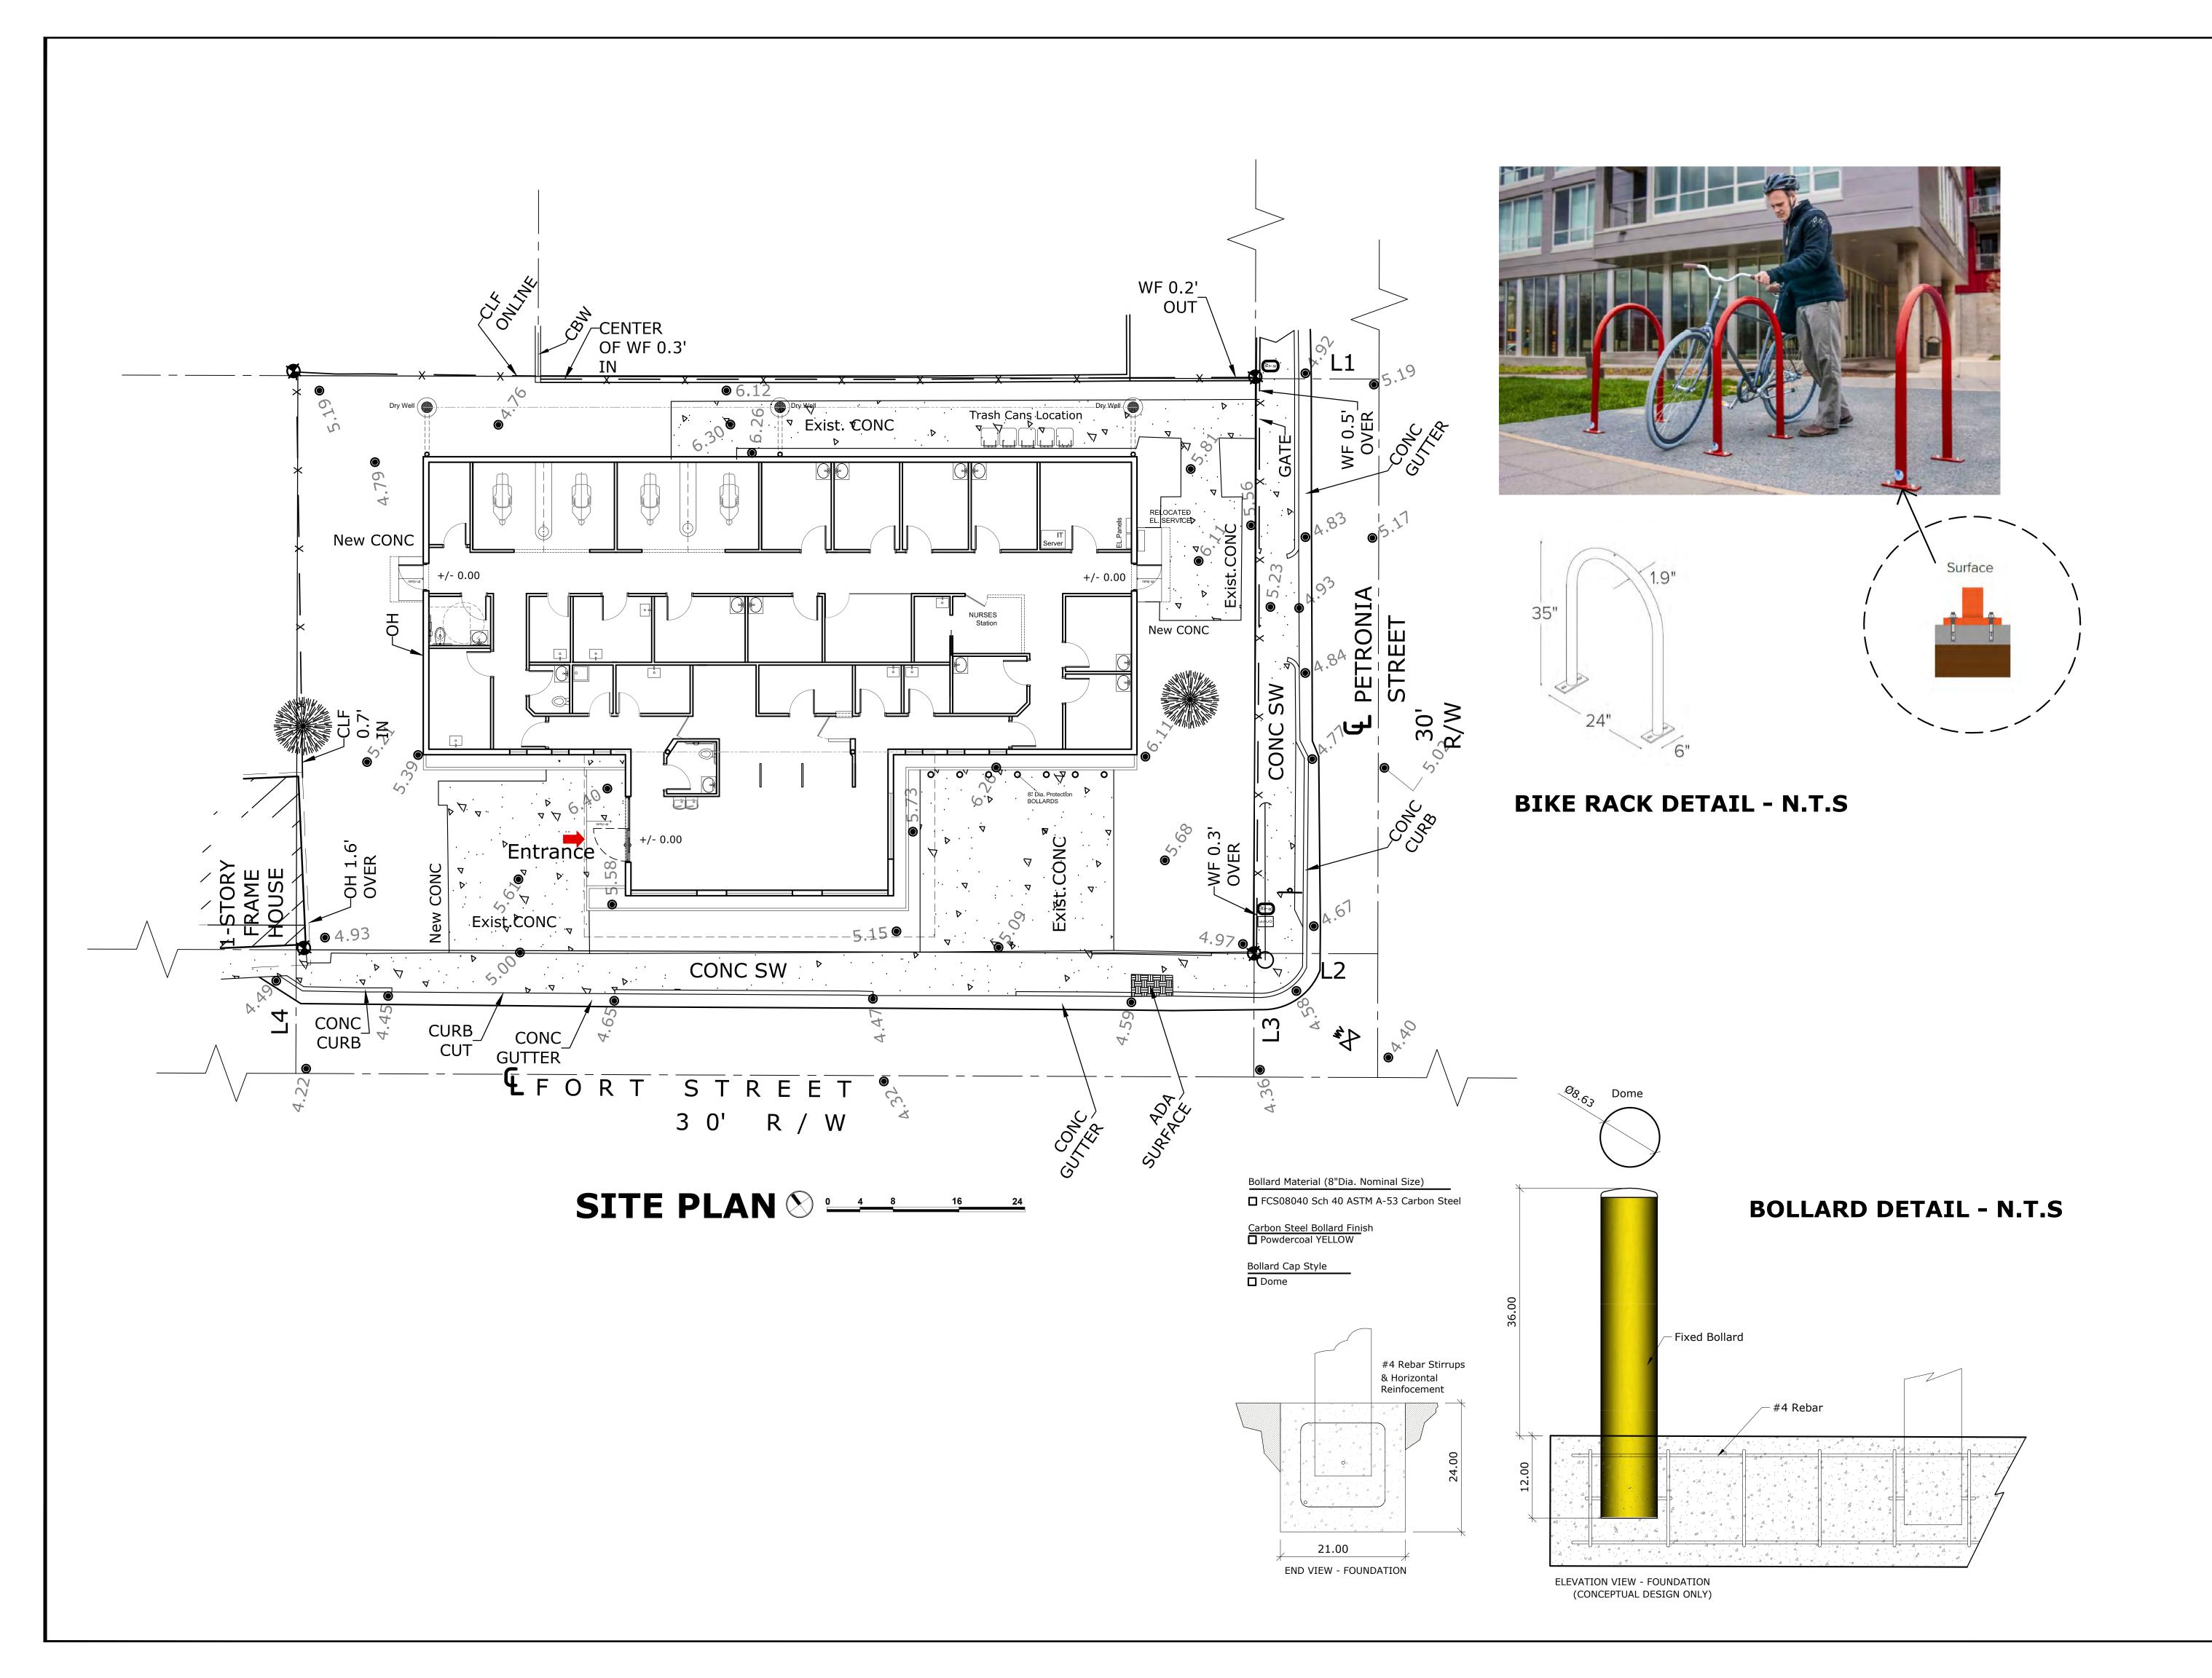



ARCHITECTURA GROUP MIAMI

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No.	Date	Description

CHI - COMMUNITY HEALTH of SOUTH FLORIDA

SITE PLAN

- 1	Drawn by	N.P.
	Checked by	E.P.
	Project Number	269.20
	Issued for	PERMIT
	Issue date	Sheet #
	06.01.20	A1 O1
	Scale	A1.01

DEMOLITION GENERAL NOTES

- 1. DEMOLITION CONTRACTOR SHALL BE FULLY LICENSED AND INSURED AND SHALL MAINTAIN COMPLIANCE WITH ALL O.S.H.A. AND OTHER APPLICABLE SAFETY STANDARDS.
- 2. DEMOLITION CONTRACTOR SHALL MAINTAIN STRICT COMPLIANCE WITH ALL RULES AND REGULATIONS GOVERNING THE DISPOSAL OF CONSTRUCTION DEBRIS.
- 3. DEMOLITION CONTRACTOR SHALL MAINTAIN STRICT ADHERENCE WITH THE LOCAL JURISDICTION'S RULES FOR CONSTRUCTION TIMES AND PROCEDURES FOR PICK UP AND REMOVAL OF CONSTRUCTION DEBRIS.
- 4. DEMOLITION CONTRACTOR SHALL MAINTAIN STRICT COMPLIANCE WITH ALL PUBLIC SAFETY PROTOCOLS APPLICABLE TO DEMOLITION WORK WITHIN THE LOCAL JURISDICTION AND SPECIFICALLY AT THE SITE.
- 5. DEMOLITION CONTRACTOR SHALL MAINTAIN STRICT ADHERENCE WITH THE LANDLORD'S RULES FOR CONSTRUCTION TIMES AND PROCEDURES AND FOR PICK UP AND REMOVAL OF CONSTRUCTION DEBRIS.
- 6. IMPORTANT: IF THERE IS ANY DOUBT AS TO WHETHER A COMPONENT IS STRUCTURAL OR NON-STRUCTURAL, DEMOLITION WORK SHALL STOP AND THE CONTRACTOR SHALL FILE AN RFI (REQUEST FOR INFORMATION) WITH THE ARCHITECT. DEMOLITION WORK SHALL RESUME PURSUANT TO THE ARCHITECT'S WRITTEN INSTRUCTIONS TO PROCEED.
- 7. THE SCOPE OF DEMOLITION WORK UNDER THIS PERMIT IS LIMITED TO THE REMOVAL OF NON-STRUCTURAL BUILDING ELEMENTS WITHIN THE EXISTING SPACE, AS DEPICTED BY DASHED LINES. ELEMENTS TO BE REMOVED AND DISCARDED ARE DESCRIBED BELOW.
- REMOVE ALL FINISHES IN ALL AREAS. STRIP AWAY ALL BACKING AND SUPPORT FOR FINISHES, EXPOSING STRUCTURE BENEATH IN ALL AREAS, ALL CONDITIONS THROUGHOUT.

IMPORTANT: IF THE DEMOLITION OF ANY NON-STRUCTURAL COMPONENT THREATENS THE INTEGRITY OF ANY STRUCTURAL COMPONENT, DEMOLITION WORK SHALL STOP AND THE CONTRACTOR SHALL FILE AN RFI (REQUEST FOR INFORMATION) WITH THE ARCHITECT. DEMOLITION WORK SHALL NOT RESUME UNTIL WRITTEN INSTRUCTIONS ARE PROVIDED.


EXPLORATORY DEMOLITION KEY NOTES


- 1. EXISTING FOOTPRINT TO REMAIN AS IS NO ADDITIONAL AREAS OR STRUCTURES ADDED TO FOOTPRINT FOR THIS
- 2. ALL EXISTING WINDOWS AND EXTERIOR DOORS TO REMAIN.
- NO CHANGE PROPOSED IN USE.
- 4. NO CHANGE PROPOSED TO PARKING.
- 5. NO CHANGE PROPOSED TO LANSCAPING.
- 6. ALL EXISTING PLUMBING FIXTURES UNLESS OUTLINED IN PLAN TO REMAIN AS IS.
- 7. ALL EXISTING FLOOR DRAINS TO REMAIN.
- 8. ALL NON STRUCTURAL INTERIOR DRYWALL WALLS, AND FRAMING, PERIMETER WALLS DRYWALL AND FURRING AS OUTLINED IN PLAN TO BE REMOVED.
- 9. ALL EXISTING STRUCTURAL COMPONENTS TO REMAIN.
- 10. ALL INTERIOR CEILINGS AND FLUORESCENT LIGHTING FIXTURES TO BE REMOVED.
- 11. NEW BUILD OUT PLAN TO BE SUBMITTED UNDER A SEPARATE PERMIT UPON COMPLETION OF EXPLORATORY DEMOLITION.

LEGEND

=====

ITEMS TO BE REMOVED

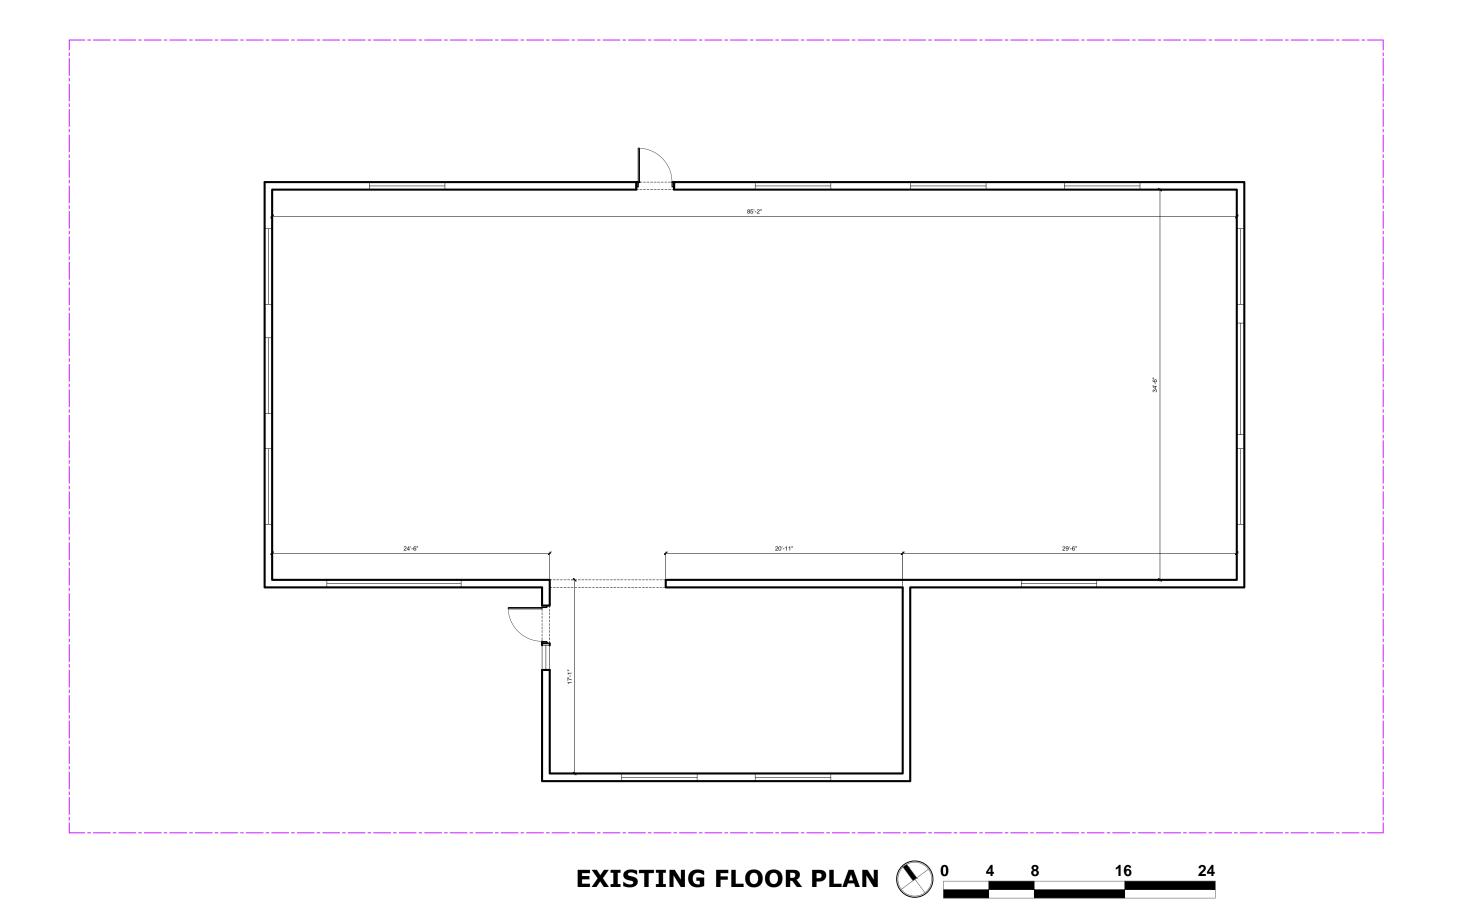

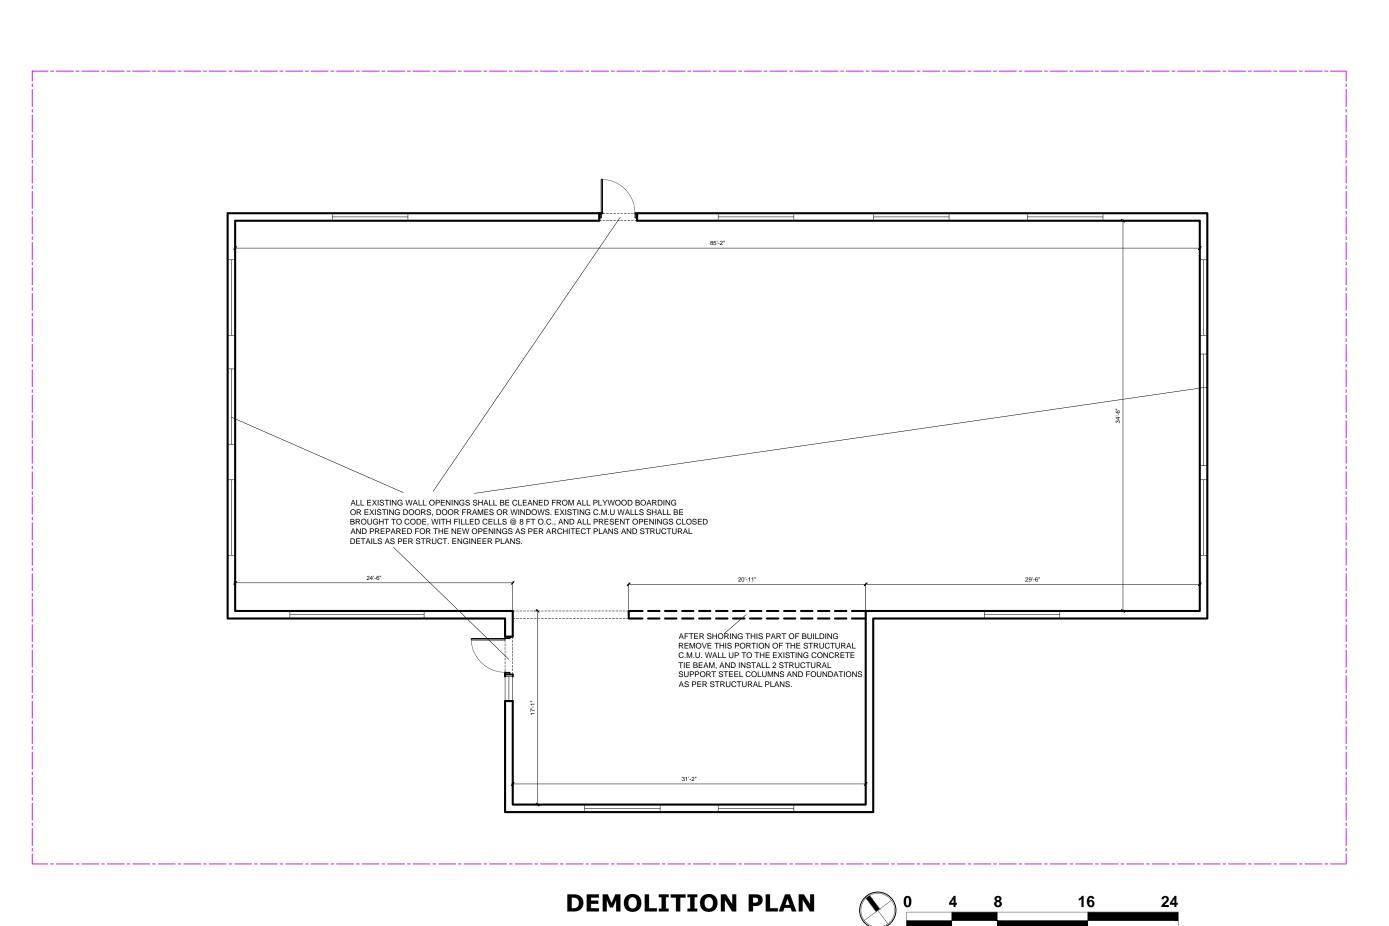



ARCHITECTURA **GROUP MIAMI**

ARCHITECTURE INTERIOR DESIGN PLANNING AA26001885 ID 00003873

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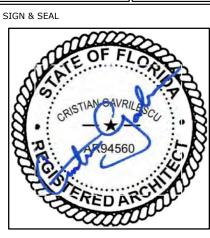
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ARCHITECTURA GROUP MIAMI, HEREBY RESERVES

No.	Date	Description

CHI - COMMUNITY HEALTH of SOUTH FLORIDA


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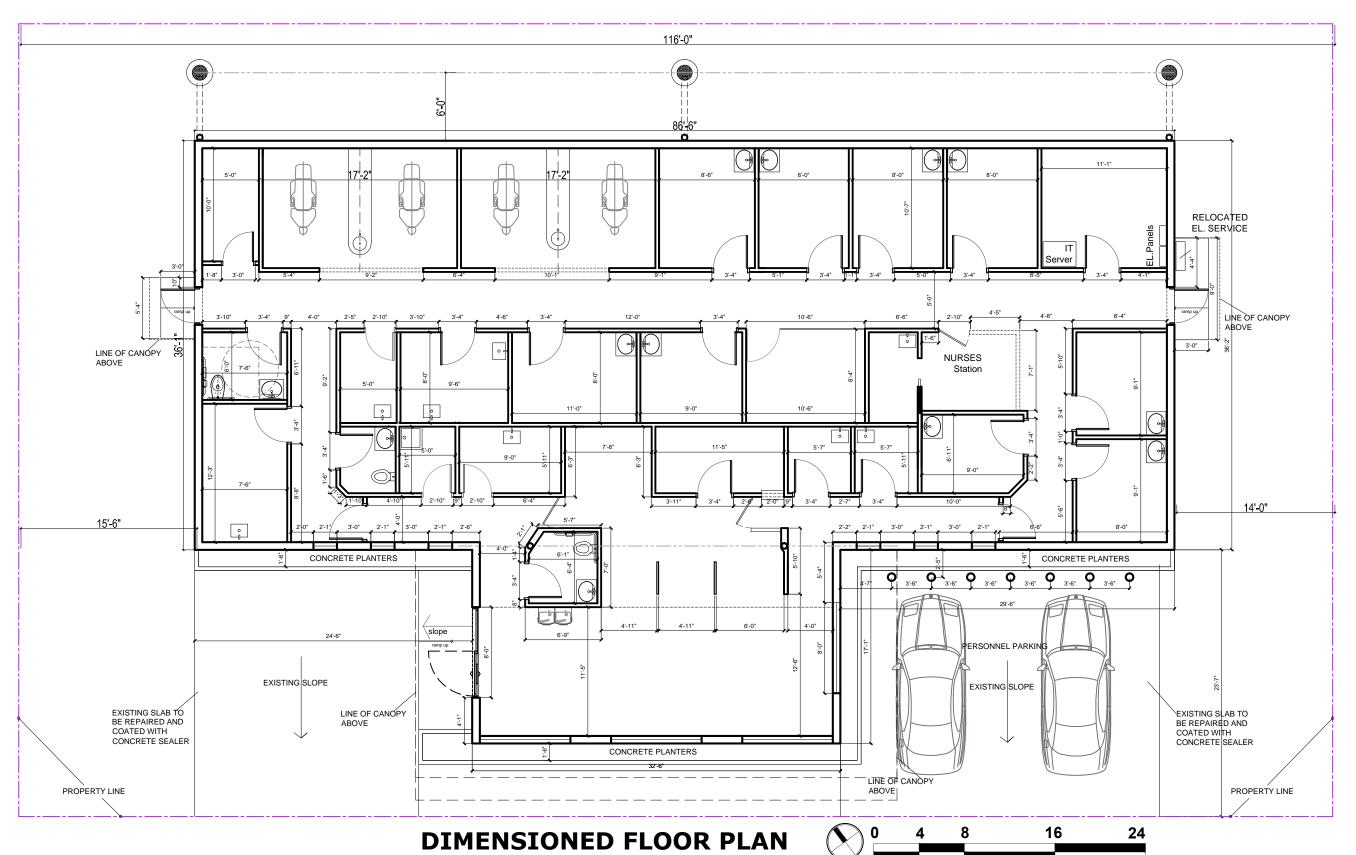



Registered Architect # AR 94560

EXISTING / DEMO PLAN

Drawn by			N.P	
Checked by			E.P	
Project Nun	nber		269.	20
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ARCHITECTURA GROUP MIAMI


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CHI - COMMUNITY **HEALTH of SOUTH** FLORIDA

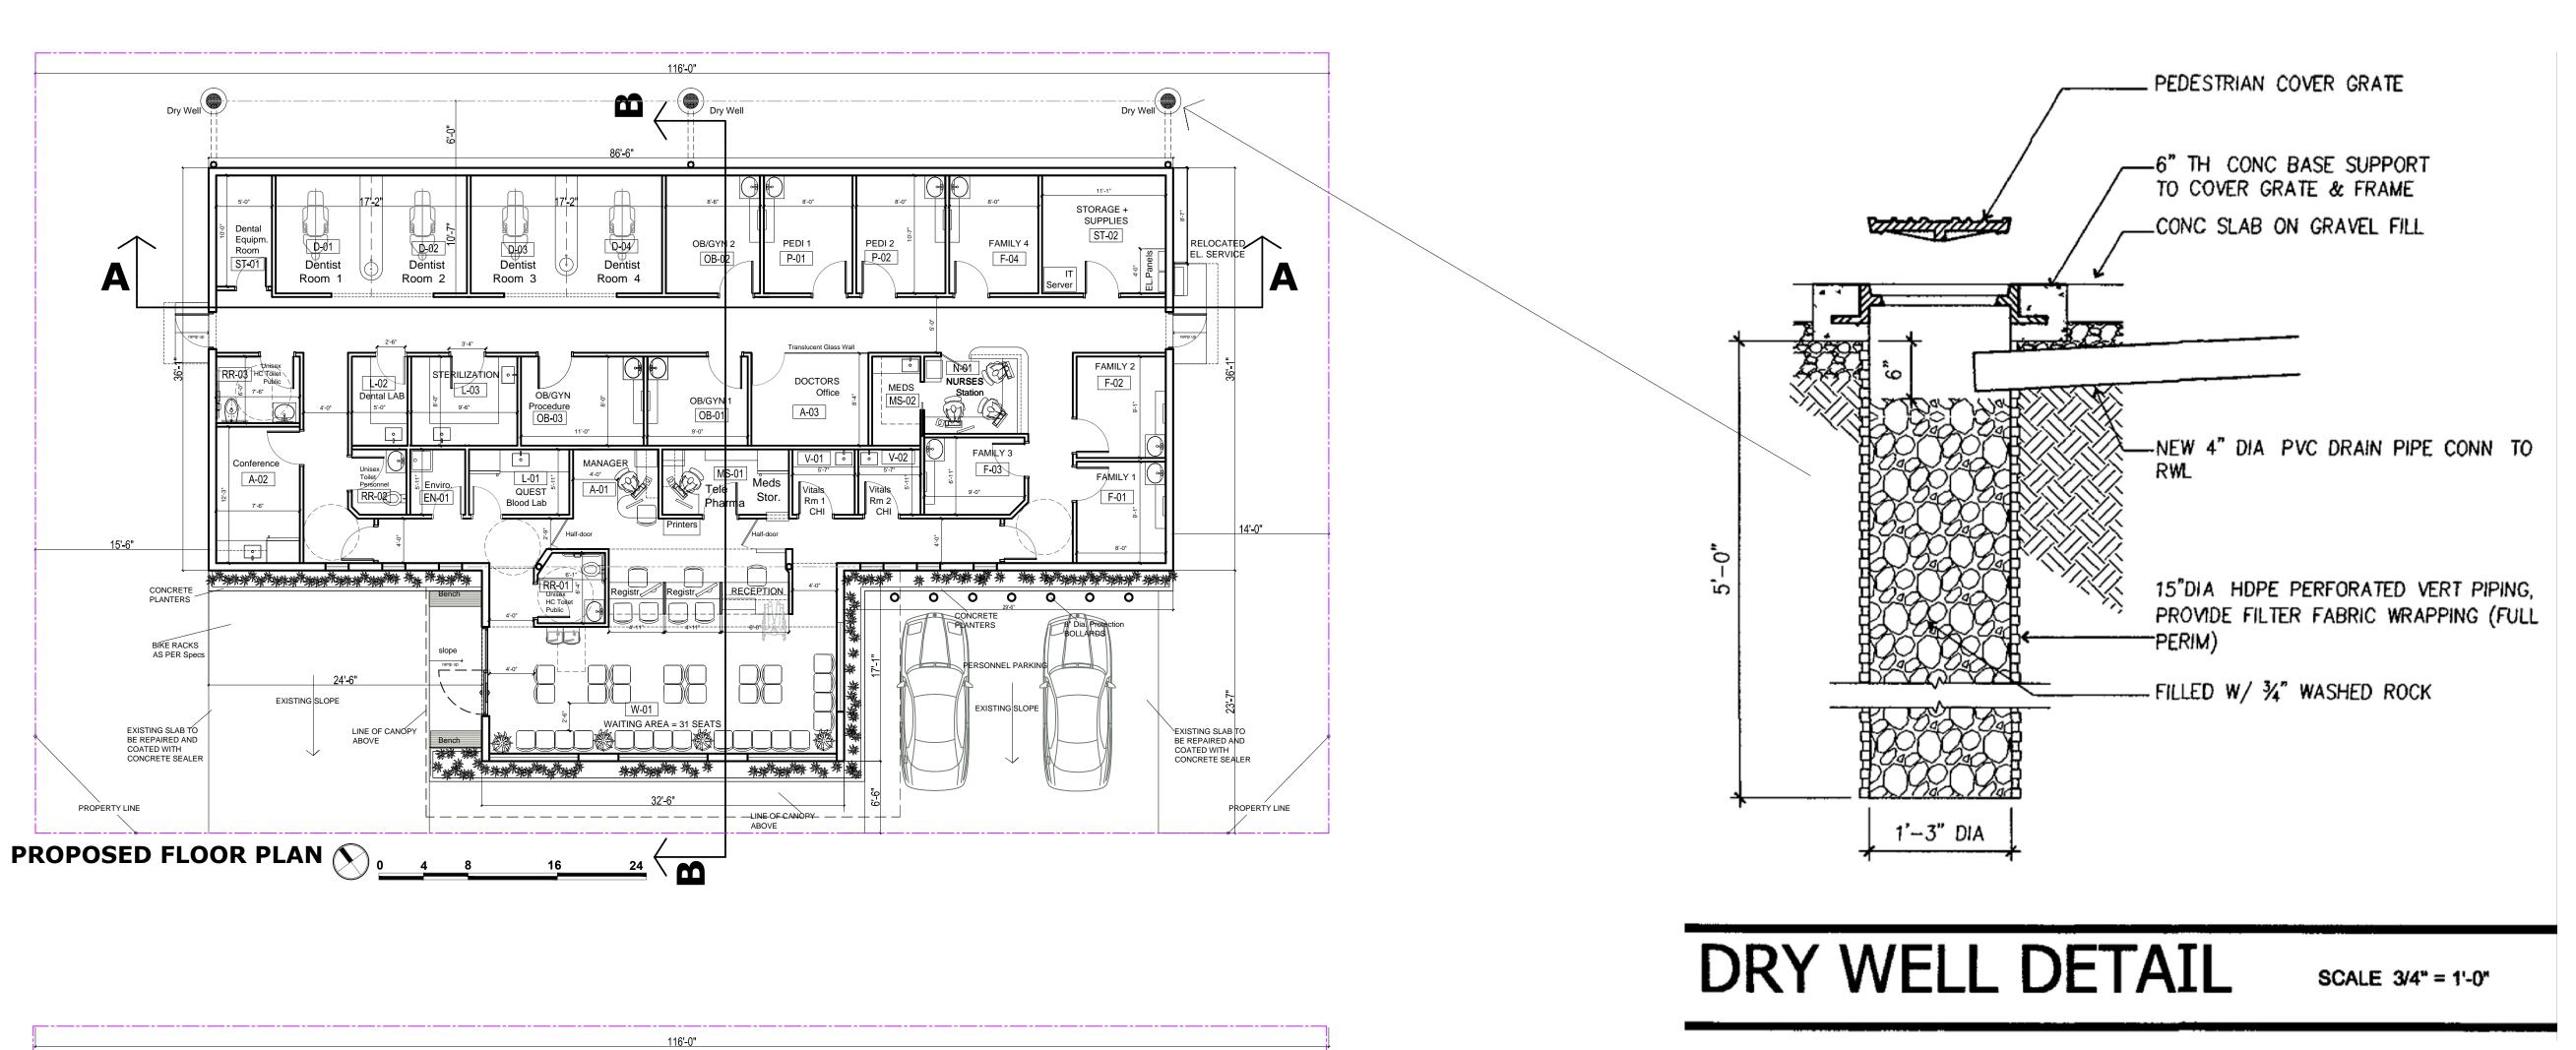WEST

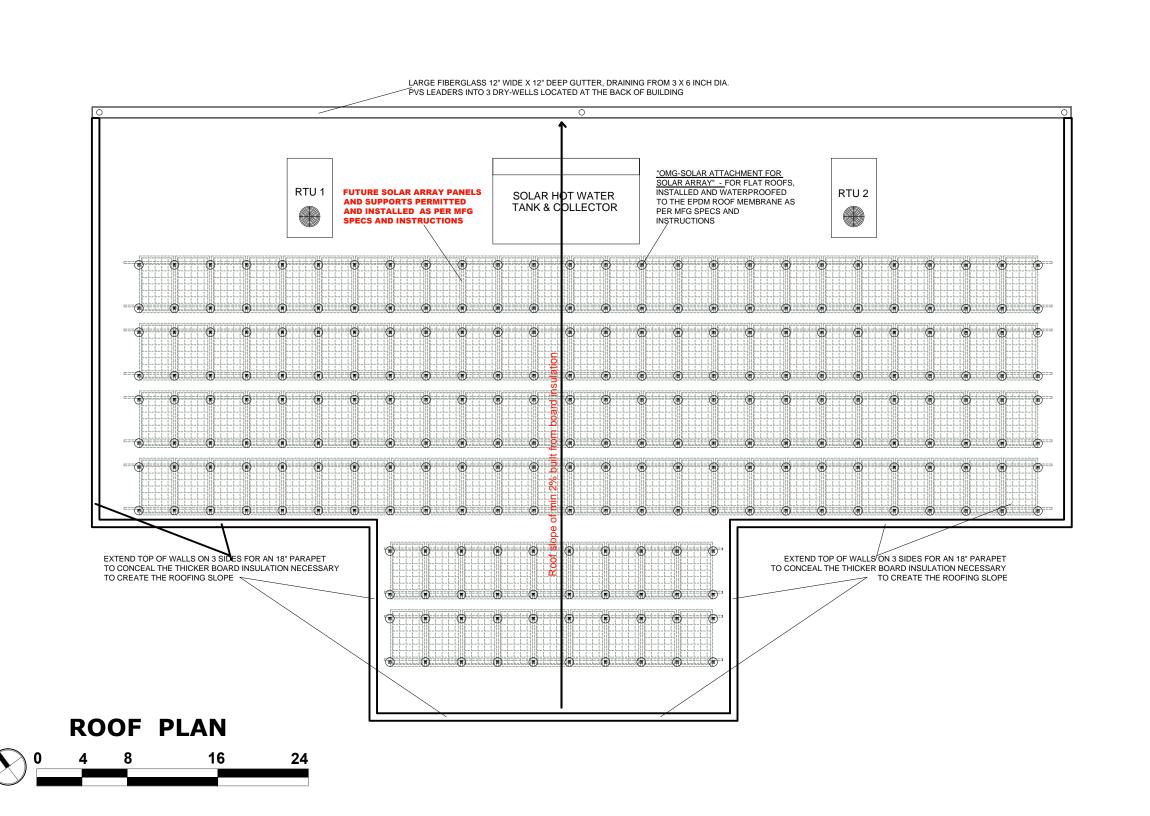

PROPOSED

FLOOR PLAN

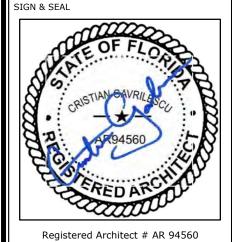rawn by Checked by E.P. Project Number 269.20 PERMIT

Issue date 06.01.20

		T			_			,					INIO	
			FLOOR			BASE		WALL			CEILING		ING	REMARKS
ROOM	ROOM	SEALED/PAINT CONC.	PORCELAIN TILE	- LUXURY VINYL TILE		RUBBER / VINYL	PORCELAIN TILE	PAINTED GYPSUM BOARD	FULL HEIGHT. TILE	EPOXY PAINT	MEDICAL GRADE ACOUSTICAL TILE CEILING	DECORATIVE - ACOUSTIC / ACCENT PANELS		
NO.	NAME		ORCEL	Д-ГО		JBBEF	ORCEL	VINTE	出出) AXO	EDICA	ECOR/		
		S	PC	LVT			PC	PA	고	出	W			
W-01	LOBBY / WAITING / CORRIDOR 1ST FLOOR	-		0										
A-01	MANAGER OFFICE	_												
A-02	CONFERENCE ROOM													
A-03	DOCTORS OFFICE	+												
D-01	DENTAL ROOM 2													
D-02	DENTAL ROOM 2 DENTAL ROOM 3	-				0					0			
D-03	DENTAL ROOM 3 DENTAL ROOM 4													
F-01	FAMILY ROOM 1													
F-02	FAMILY ROOM 2	+									0			
F-03	FAMILY ROOM 3	1												
F-04	FAMILY ROOM 4										0			
P-01	PEDS 01	1		0				0			0			
P-02	PEDS 02													
OB-01	OBGYN 01			0		0		0			0			
OB-02	OBGYN 02			0		0		0			0			
OB-03	OBGYN 03	1				0					0			
L-01	QUEST BLOOD LAB			0		0				0	0			
L-02	DENTAL LAB			0		0				0	0			
L-03	STERILIZATION ROOM			0		0				0	0			
MS-01	MED STORAGE / TELE PHARMA			0		0		0			0			
MS-02	MED STORAGE / TELE PHARMA			0		0		0			0			
N-01	NURSES STATION			0		0		0			0			
V-01	VITALS ROOM 1			0		0		0			0			
V-02	VITALS ROOM 2			0		0				0	0			
ST-01	DENTAL EQUIPMENT ROOM					0				0				
ST-02	STORAGE & SUPPLIES									0				
RR-01	RESTROOM 01		0				0		0	0	0			
RR-02	RESTROOM 02		0				0		0	0	0			
RR-03	RESTROOM 03		0				0		0	0	0			
EN-01	ENVIRO STORAGE													

LVT Flooring SPECIFICATION FOR PURCHASE

MANUFACTURER: AMTICO

Material: LVT Planks 9" X 36"; Collection: AMTICO Signature; Color: WASHED TEAK (AROW5990); Wear Layer: 40 MIL;

QUANTITY TO INSTALL: 3,400 Sq. F.

LVT Floors + KOSTER Moisture Mitigation Membrane

SPECIFICATION FOR INSTALLATION:

- 1. DUST OFF AND WET MOP CLEAN AREA 3500 SQF
- 2. Installation of KOSTER PRIMER in (VAP I 06)2 coats TOTAL 7,000 Sq. F.
- 3. iNSTALLATION of KOSTER WATERPROOFING Liquid Membrane (VAP 2000 UFS) 3500 Sq.F
- 4. INSTALLATION OF SELF LEVELING CEMENTITIOUS COMPOUND TO LEVEL AREAS OF THE SLAB CUTS AND REPAIRED: +/- 1,500 Sq.F.
- 5. INSTALLATION OF LVT PLANKS 3,400 Sq.F.
- 6. INSTALLATION OF of VINYL WALL BASE (4 ")



ARCHITECTURA GROUP MIAMI

INTERIOR DESIGN
PLANNING
AA26001885

1920 E HALLANDALE BLVD., PH HALLANDALE, FLORIDA 33009 PH: 954-558-3024 E-MAIL: argroupinc@aol.com AGMiami.Inc@Gmail.com

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Date

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HEALTH of SOUTH
FLORIDA

/EST Medical Center

IGN & SEAL



Registered Architect # AR 9450

FINISHING SCHEDULES


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Checked by	E.P.
Project Number	269.20
Issued for	PERMIT
Issue date	Sheet #
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Scale NTS	A1.09

NOTE

1. ALL INTERIOR CEILINGS AND WALL FINISHES SHALL BE CLASS 'A' THROUGHOUT.

2. ALL INTERIOR FLOOR FINSIHED SHALL BE TYPE '2' THROUGHOUT.

3. ALL TOILET ROOM FLOORS AND WALLS (to 8'-0" A.F.F.) to be of IMPERVIOUS MATERIAL.

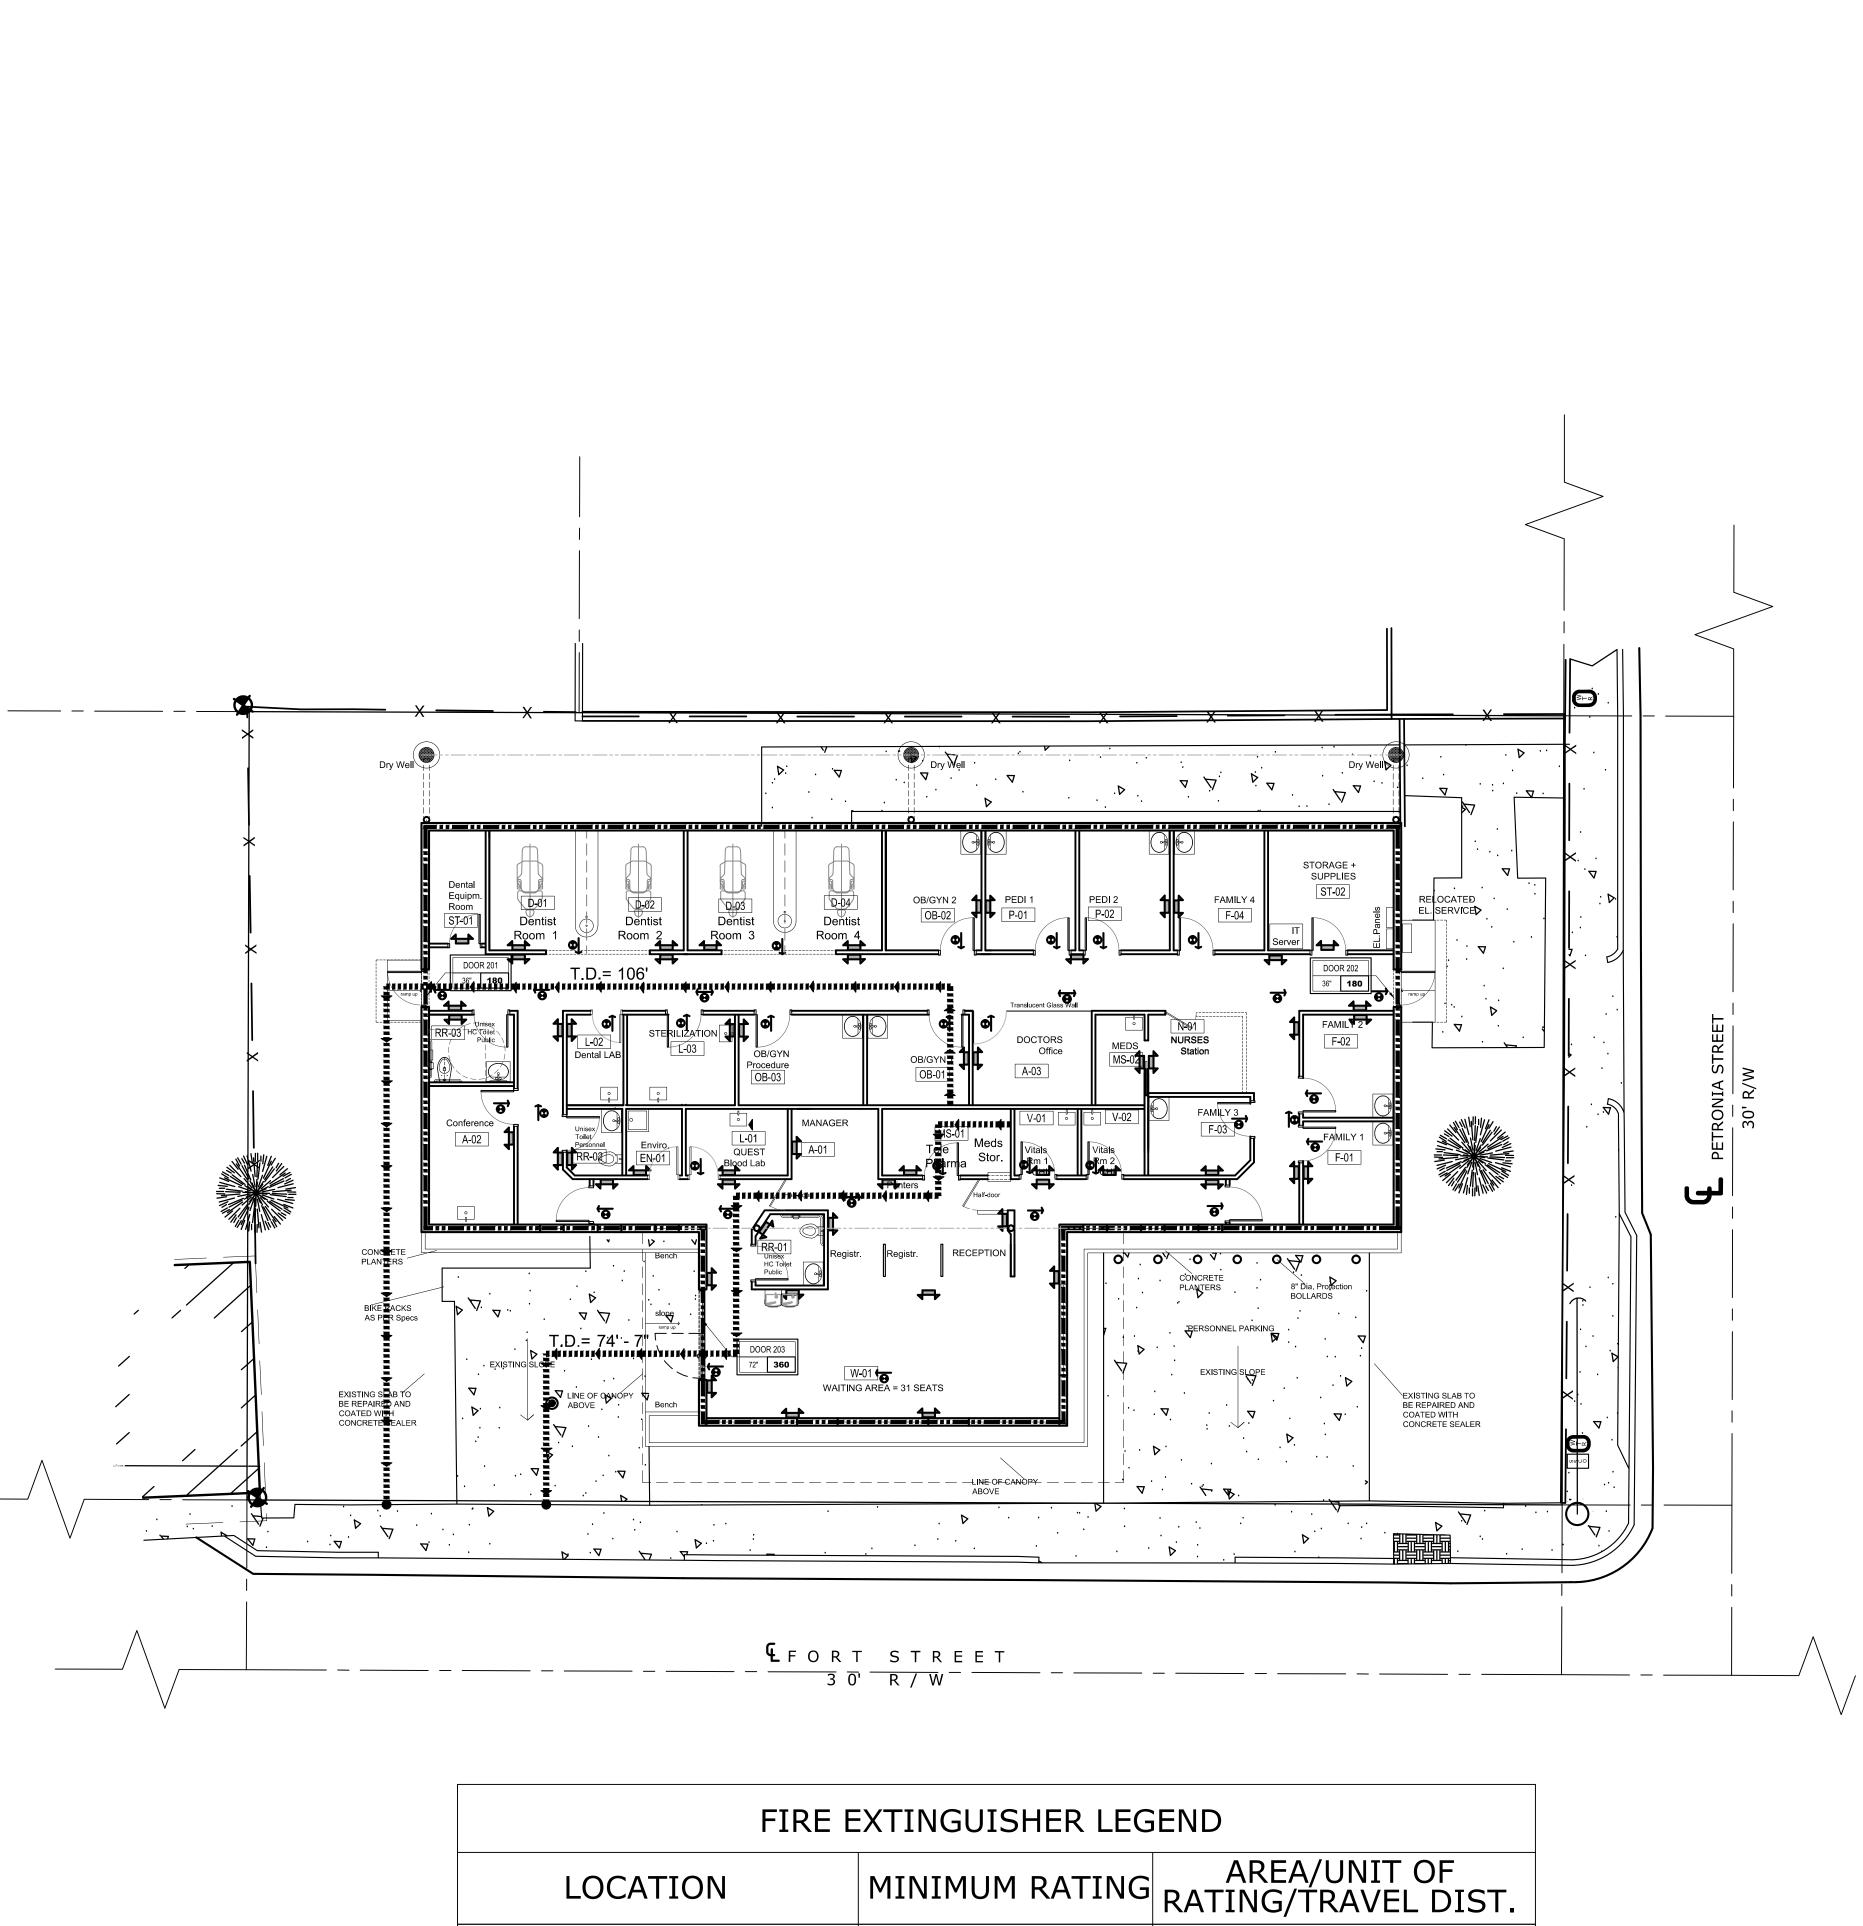

2A

2A

OFFICE AREAS

PUBLIC AREAS


3000 S.F./ 75 FT.

1500 S.F./ 75 FT.

DESIGN DA	TA
CODES:	
FLORIDA BUILDING CODE 2017 6 TH EDITION NFPA 101 2015 EDITION	
2017 6 TH EDITION OF FLORIDA ACCESSIBILITY CODE	
FLORIDA FIRE PREVENTION CODE (FFPC) 6TH EDITION	
ALTERATION LEVEL III — MODIFICATION PER NFPA 01 CHAPTER	43
DESIGN CRITERIA	PROPOSED
OCCUPANCY GROUP	В
AUTOMATIC SPRINKLER SYSTEM	NO
TYPE OF CONSTRUCTION	TYPE II UNPROTECTED
L.S.C. OCCUP. CLASSIF. (NFPA 101)	В
L.S.C. HAZARD CLASSIF. (NFPA 101)	ORDINARY
OWNER OPERATED	
NUMBER OF STORIES	EXISTG 1 PROPSED 1
MEANS OF EGRESS	3

TOTAL GROSS AREA ALL FLOORS			DDE REQ. .F /Person	OCCUF LOA		OCCUPANCY		
	3,495	10	0 GROSS	35	ı	В		
GROUP	EXIT ENCLOSURES	S AND		NKLERED	ROOM	ROOM AND ENCLOSED SPACES ⁶		
	EXIT PASSAGEW	AYS	COORIE	OORS				
В	А		А			В		
		- FL -SMOK NG FINISH -FLA	ES PROVIDED PEF AME SPREAD INDE (E DEVELOPED INDE ES PROVIDED PEF AME SPREAD INDE: (E DEVELOPED INDE	EX: 0-25 DEX: 0-450 R 803.1 CLASS 'E X: 26-75				

EGRESS EXIT CAPACITY CALCULATIONS (AS PER SEC1005 F.B.C. 2017 EDITION)									
WIDTH FACTOR CAPACITY									
DOOR 201		36"	'	.2		180			
DOOR 202	36"	'	.2		180				
DOOR 203		72"	'	.2		360			
TOTAL CAPACITY	OF EXITS	; ;	•			720			
TOTAL MAX OCCU	PANCY					35			
E	XIT ACCE	SS TF	RAVE	EL DISTA	NC	E			
OCCUPANCY	TRAVEL	. DIST.	ANC	E LIMIT		DEMARKS			
CLASSIFICATION	CODE R	EQ.	PR	OVIDED		REMARKS			
BUSINESS B	200 F1	Г.	7	4' - 7"	* T.	D MS-01 TO SIDEWALK			
			10	06' - 0"	* T.	D OB-01 TO SIDEWALK			

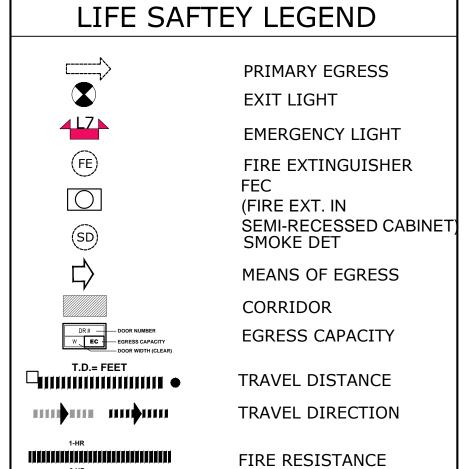

SEPARATION

DOOR HARDWARE NOTES
ALL HARDWARE OF DOORS LEADING TO
EXITS FROM OCCUPIED SPACES TO
COMPLY WITH THE FOLLOWING:

DOOR OPERATIONS.
EGRESS DOORS SHALL BE READILY
OPENABLE FROM THE EGRESS SIDE
WITHOUT THE USE OF A KEY OR SPECIAL
KNOWLEDGE OR EFFORT.

1008.1.8.1 HARDWARE.
EGRESS DOORS AND H.C. BATH HANDLES,
PULLS, LATCHES, LOCKS AND OTHER
OPERATING DEVICES ON DOORS SHALL
NOT REQUIRE TIGHT GRASPING, TIGHT
PINCHING OR TWISTING OF THE WRIST TO
OPERATE.

1008.1.8.2 HARDWARE HEIGHT.
A LATCH OR OTHER FASTENING DEVICE
ON A DOOR SHALL BE PROVIDED WITH A
RELEASING DEVICE HAVING AN OBVIOUS
METHOD OF OPERATION UNDER ALL
LIGHTING CONDITIONS. THE RELEASING
MECHANISM FOR ANY LATCH SHALL BE
LOCATED AT LEAST 34 INCHES (864 MM)
AND NOT MORE THAN 48 INCHES (1219
MM) ABOVE THE FINISHED FLOOR. DOORS
SHALL BE OPENABLE WITH NOT MORE
THAN ONE RELEASING OPERATION.

LIFE SAFETY NOTES - NFPA 101 - 2016
PROJECT DESCRIPTION
-BLDG. HAS NO FIRE SPRINKLER SYSTEM
-BLDG. HAS FIRE ALARM SYSTEM
-THERE IS NO EXTG. OR PROP. BACK-UP
GENERATOR

MATERIAL STORAGE RESTRICTION
LOW / ORDINARY HAZARD PER NFPA 101:

MEANS OF EGRESS (GEN IND. SPRINKLERED)

TRAVEL DISTANCE (TABLE 1017.2 FBC 2017)
 MAX ALLOWED 200.0' - 106' MAX PROVIDED
 PROP. MAIN ENTRANCE/EGRESS
 DOORS CLEAR WIDTH = 1 x 72" & 2 X 36"

DOORS HARDWARE NOTES:

3. (3) EXTG EXITS PROVIDED

-ALL DOORS (EXCEPT STOREFRONTS) TO BE LEVER TYPE. -BATHROOM TO HAVE PRIVACY LOCKS (THUMB RELEASE FROM INTERIOR).

DOOR ELEVATION NOTE:

-MAXIMUM ALLOWABLE ELEVATION
CHANGE AT ALL DOOR THRESHOLDS TO BE

FURNISHINGS & DECORATIONS
COMPLIANCE
PER 15.7.4, 10.3.1

INTERIOR FINISH COMPLIANCE
PER 15.3.3, 10.2 WALLS & CEIL. CLASS A, B & C.

SIGNAGE REQ'D POSTAGE NO-SMOKING POSTED PER 12.7.8 OCCUPANT LOAD PER 12.7.9.3

ILLUMINATION OF MEANS OF EGRESS

EMERGENCY LIGHTING

<u>DOORS</u> PER 7.2.1

MARKING OF MEANS OF EGRESS PER 7.10

CODE COMPLIANCE
ALL WORK TO BE DONE IN ACCORDANCE
WITH FFPC 6TH EDITION AND NFPA1 NFPA
101 BUSINESS OCCUPANCY 2015 EDITION



GROUP MIAMI

ARCHITECTURE

INTERIOR DESIGN
PLANNING
AA26001885
ID 00003873

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920 E HALLANDALE BLVD., PH-1:
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No.	Date	Description

CHI - COMMUNITY
HEALTH of SOUTH

FLORIDA

Y WEST Medical Center RENOVATION




Registered Architect # AR 94560

Sheet title

LIFE SAFETY
PLANS

Drawn by	N.P.
Checked by	E.P.
Project Number	269.20
Issued for	PERMIT
Issue date	Sheet #
06.01.20	A1.05
Scale	AT.03

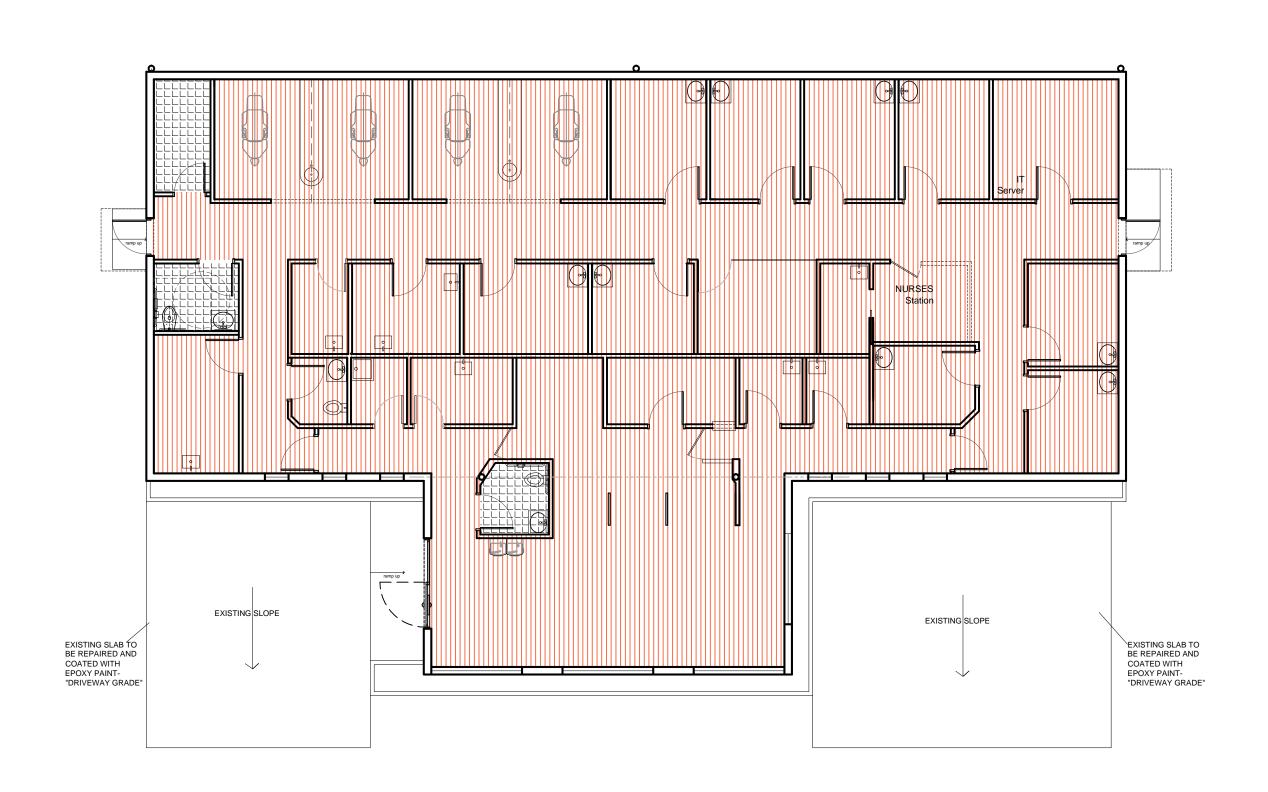

LVT Flooring SPECIFICATION FOR PURCHASE

MANUFACTURER: AMTICO


Material: LVT Planks 9" X 36"; Collection: AMTICO Signature; Color: WASHED TEAK (AROW5990); Wear Layer: 40 MIL;

QUANTITY TO INSTALL: 3,400 Sq. F.

LVT Floors + KOSTER Moisture Mitigation Membrane

SPECIFICATION FOR INSTALLATION:


- 1. DUST OFF AND WET MOP CLEAN AREA 3500 SQF
- 2. Installation of KOSTER PRIMER (VAP I 06) in 2 coats TOTAL 7,000 Sq. F.
- 3. iNSTALLATION of KOSTER WATERPROOFING Liquid Membrane (VAP 2000 UFS) 3500 Sq.F
- 4. INSTALLATION OF SELF LEVELING CEMENTITIOUS COMPOUND TO LEVEL AREAS OF THE SLAB CUTS AND REPAIRED: +/- 1,500 Sq.F.
- 5. INSTALLATION OF LVT PLANKS 3,400 Sq.F.
- 6. INSTALLATION OF of VINYL WALL BASE (4 ")

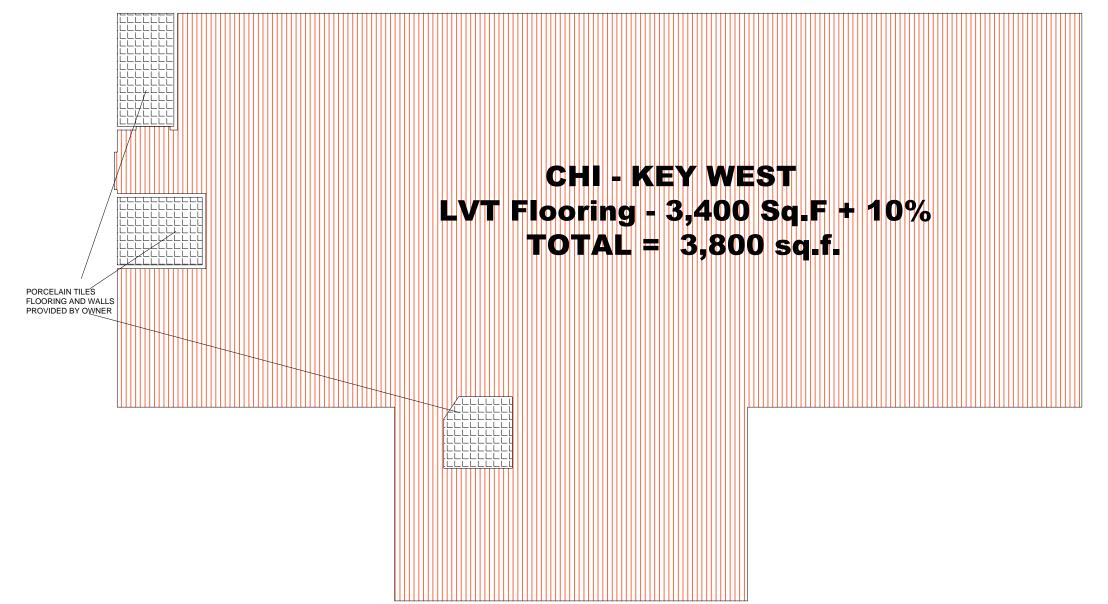

corners



Use pre-made interior / exterior corner profiles throughout

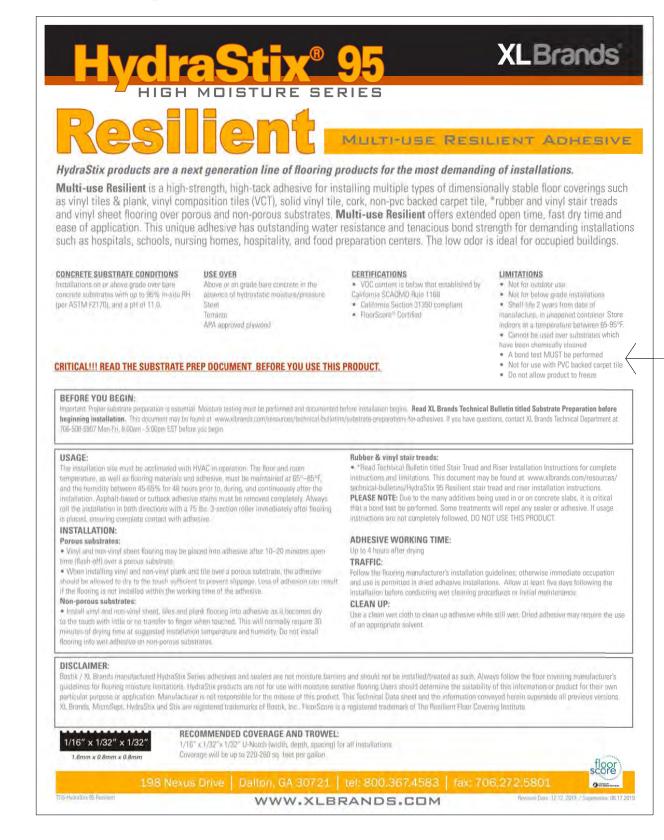

LVT Adhesive for all LVT Finished areas. For the Ground Slab area, first coat slab with "KOSTER" Liquid Moisture Slab Barrier Primer "VAP I 06" and Concrete Waterproofing Membrane "VAP I 2000 UFS" as per Mfg INSTRUCTIONS of Application.



ARCHITECTURA GROUP MIAMI

ARCHITECTURE
INTERIOR DESIGN
PLANNING
AA26001885
ID 00003873

1920 E HALLANDALE BLVD., PH-11
HALLANDALE, FLORIDA 33009
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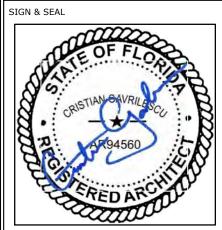
	No.	Date	Description
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CHI - COMMUNITY

HEALTH of SOUTH
FLORIDA

Y WEST Medical Center RENOVATION


IGN & SEAL



Registered Architect # AR 945

FLOORING DETAILS

Drawn by	N.P.
Checked by	E.P.
Project Number	269.20
Issued for	PERMIT
Issue date	Sheet #
06.01.20	A1.06
Scale NTS	A1.00

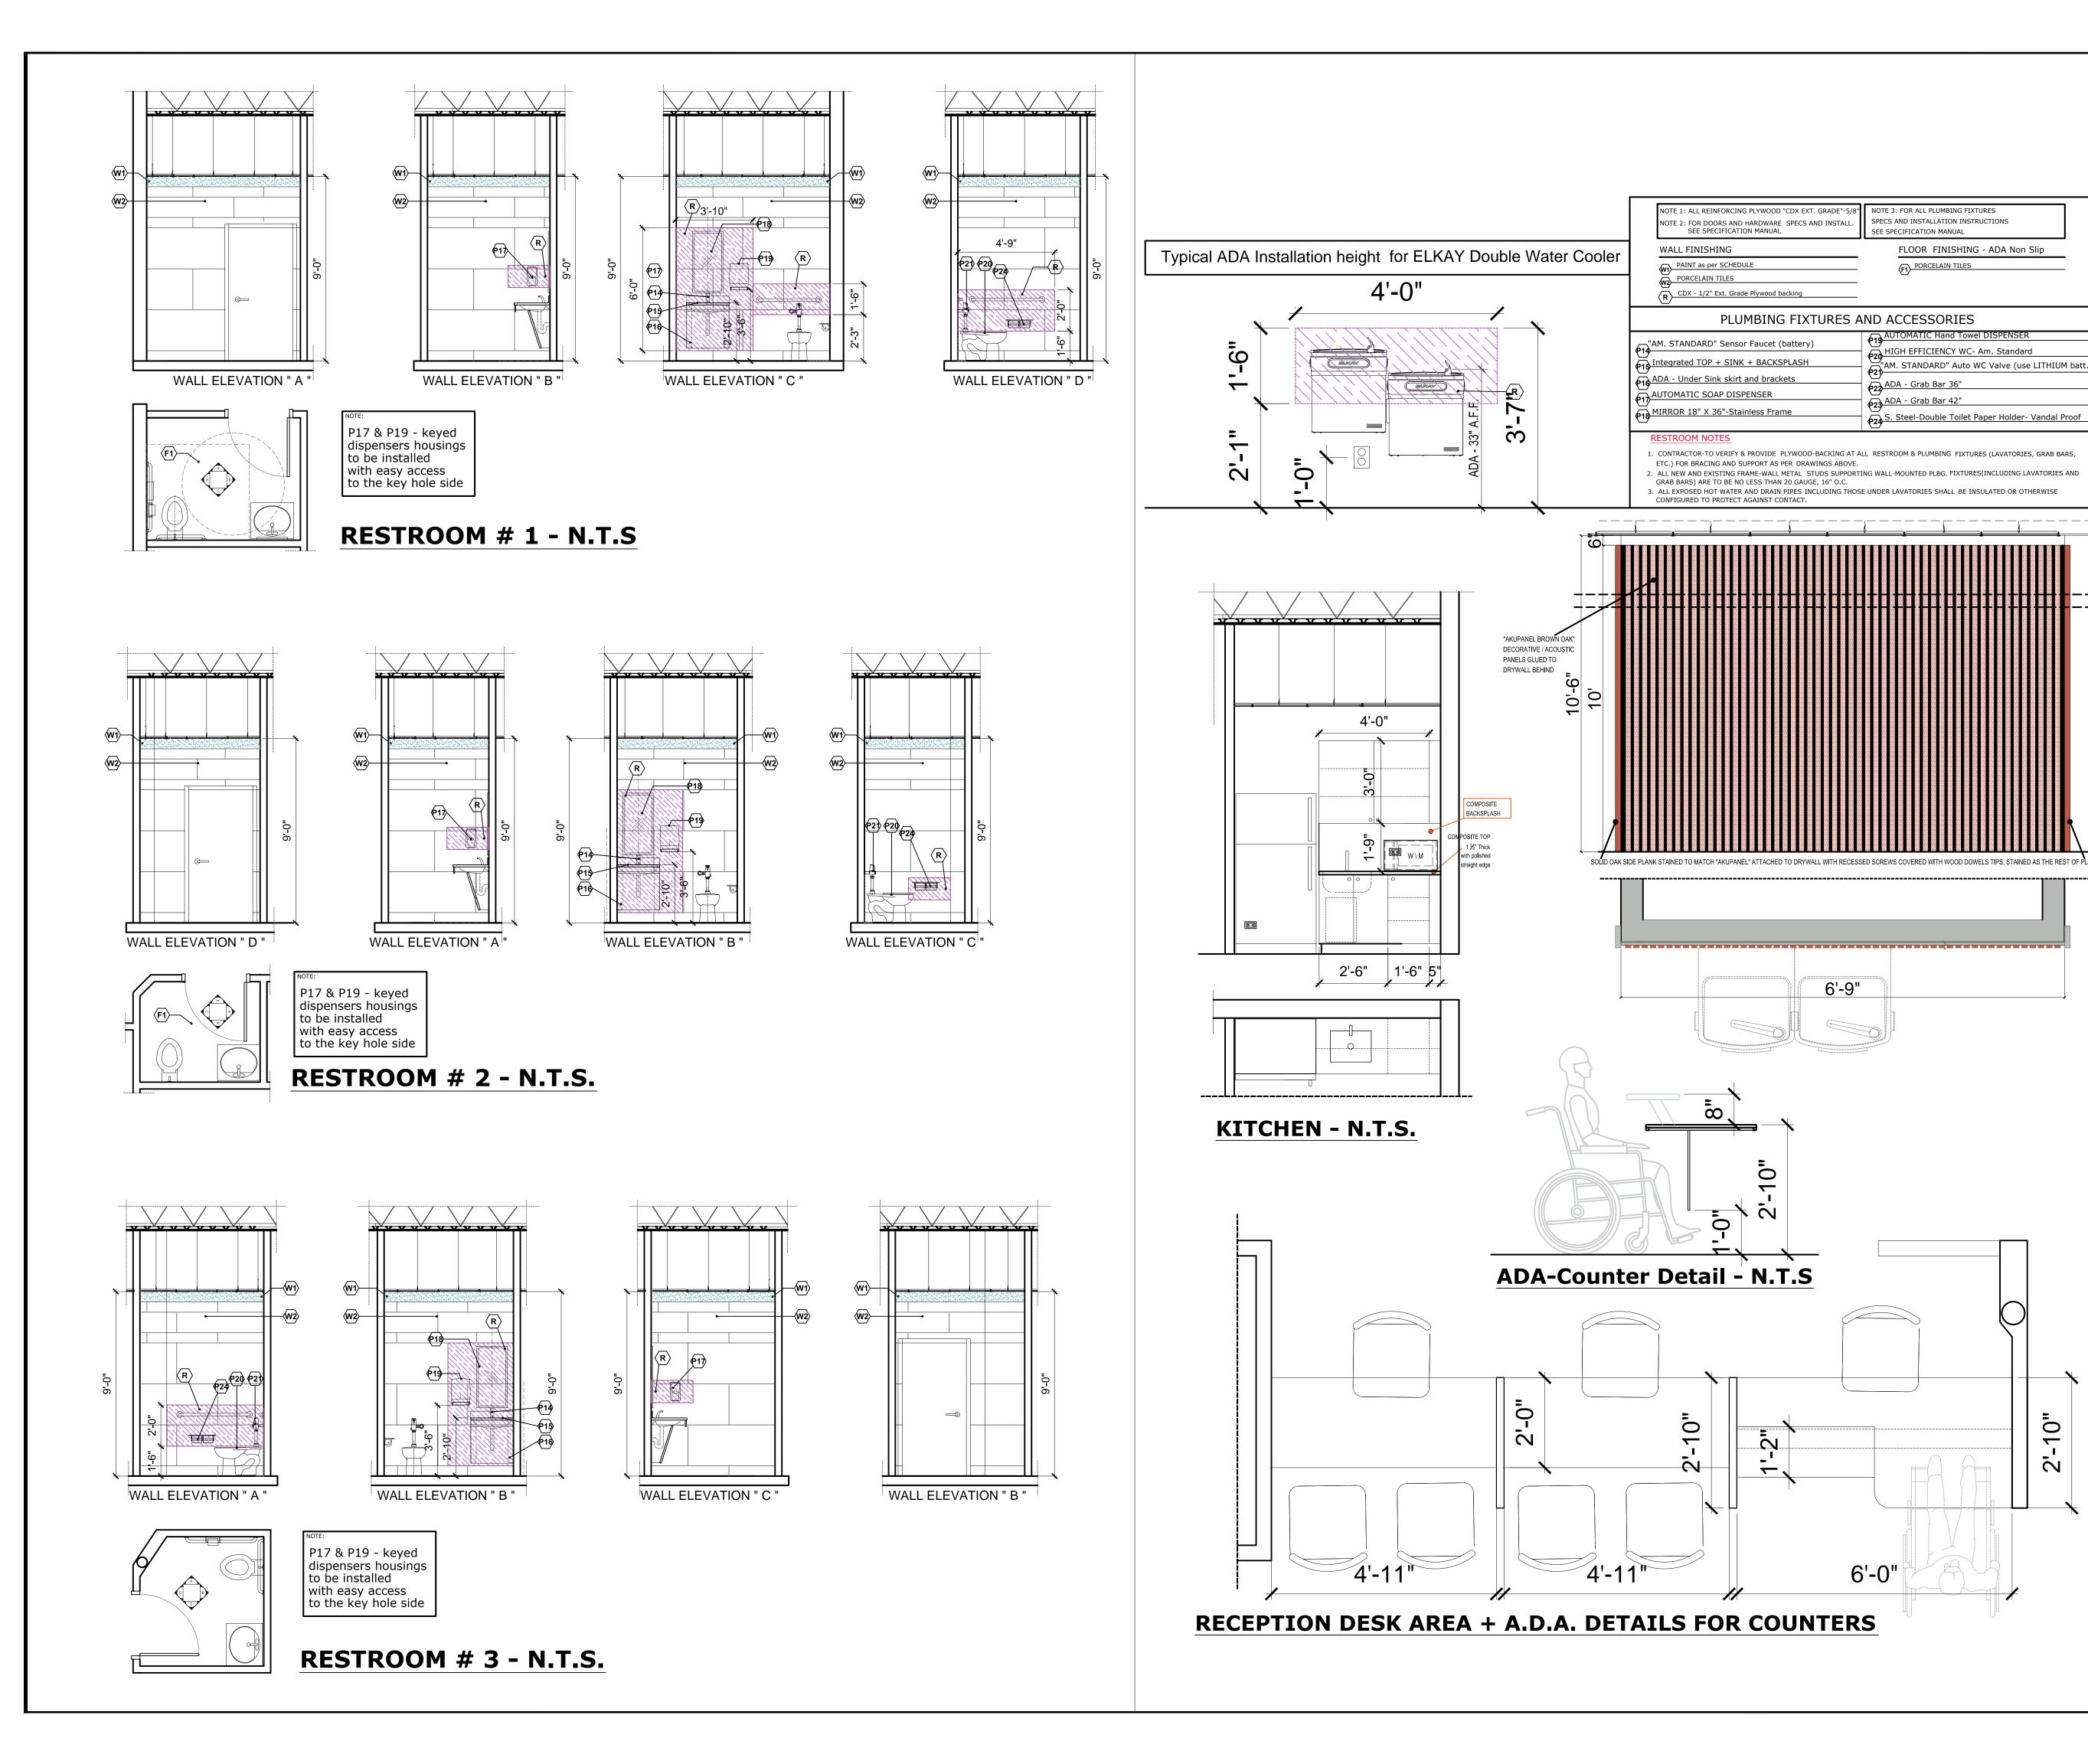



ARCHITECTURA GROUP MIAMI

ARCHITECTURE
INTERIOR DESIGN
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1D 00003873

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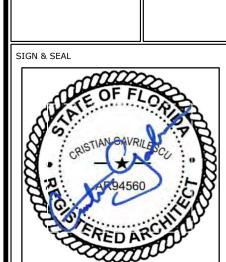
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No.	Date	Description
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HEALTH of SOUTH
FLORIDA

Project Name

II KEY WEST Medical Center RENOVATION



Registered Architect # AR 94560
et title

RESTROOMS


PLAN +


ELEVATIONS


awn by N.P.
ecked by E.P.

Checked by E.P.
Project Number 269.20
Issued for PERMIT
Issue date Sheet #


A1.07

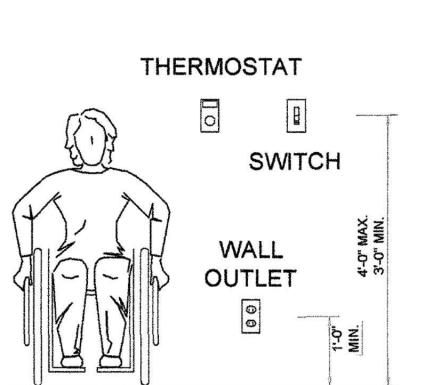

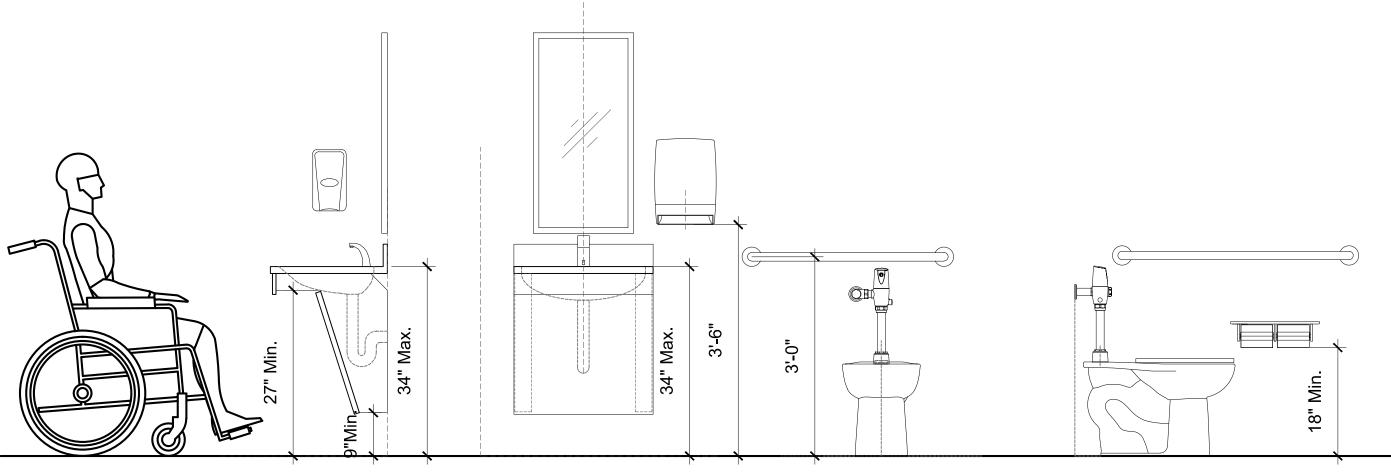

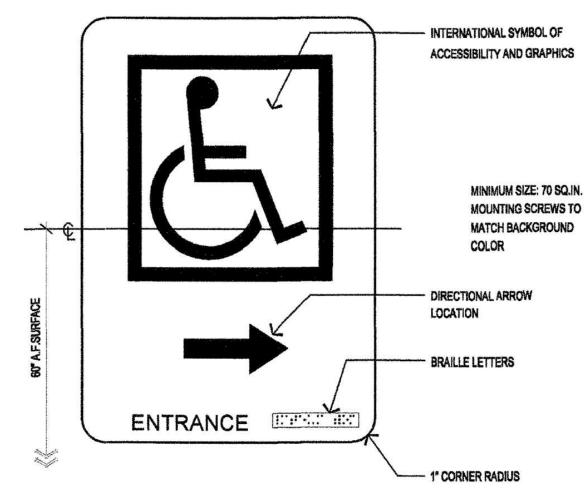

ADA DIRECTIONAL SIGNS

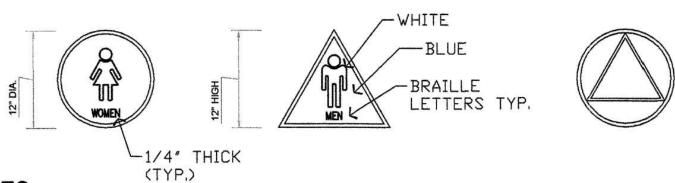

NOTES:


- 1. H.C. signs per ADA
- 2. All letters and symbols shall be raised 1/32" 3. 12" diameter circle, 1/4" thick with the color and contrast being

ADA OUTLETS HEIGHT

- distinctly different from the color of the door.
- 4. International sign of accessibility, white figure on blue (#15090 federal standard 595a) background
- 5. Sign shall be displayed at 60" A.F.F., centered on the door, color and contrast shall be distinctly different from color and contrast of the door typ. for men's and women's signs
- 6. 12" equilateral triangle, 1/4" thick with the vertex pointing upward and the color and contrast being distinctly different from
- 7. Letters and numerals on signs are raised 1/32", sans serif
- uppercase characters to be accompanied by grade 2 braille. between cells
- 9. Braille dots are raised a minimum of 1/40" above the background
- 10. Mounting height is 60" from finish floor to the centerline of the


- 1. Seal around all recessed restroom equipment
- 2. Provide 16 ga. backing at all accessories and lav. tops at grab bars provide 16 ga. backing secured to at least 3 studs.
- Caulk around joint at bottom of toilet and floor.
- 4. All toilet paper dispensers installed at 7" min. to 9" max in front of water closet
- 5. Bottom of mirror to be installed 38" above floor

Controls and operating mechanisms shall be operable with one hand and shall not require tight grasping, pinching or twisting of the wrist. The force required to activate controls shall be no greater than 5 lbf (22.2 n) faucets lever-operated, push-type and electronically shall comply with 4.27.4 controlled mechanisms are examples of acceptable designs. If self-closing valves are used the faucet shall remain open for at least 10 seconds

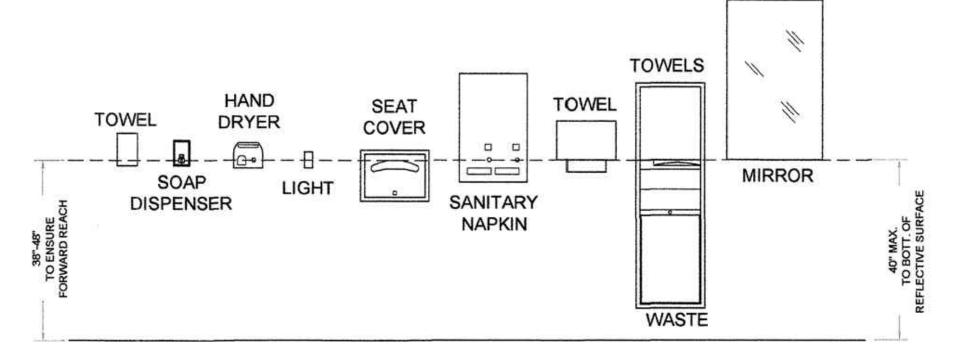


RESTROOM TYPICAL SIGNAGE

RESTROOM ACCESSORIES INSTALLATION HEIGHT

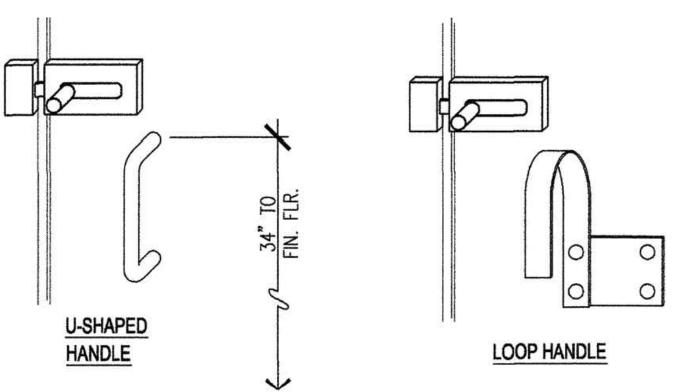


The inside and outside of the compartment doors to disabled accessible stalls must be equipped with a loop or u-shaped handle immediately below the latch. The latch must be flip-over style, sliding or other hardware not requiring tight grasping or twisting

ADA STALL DOOR HARWARE

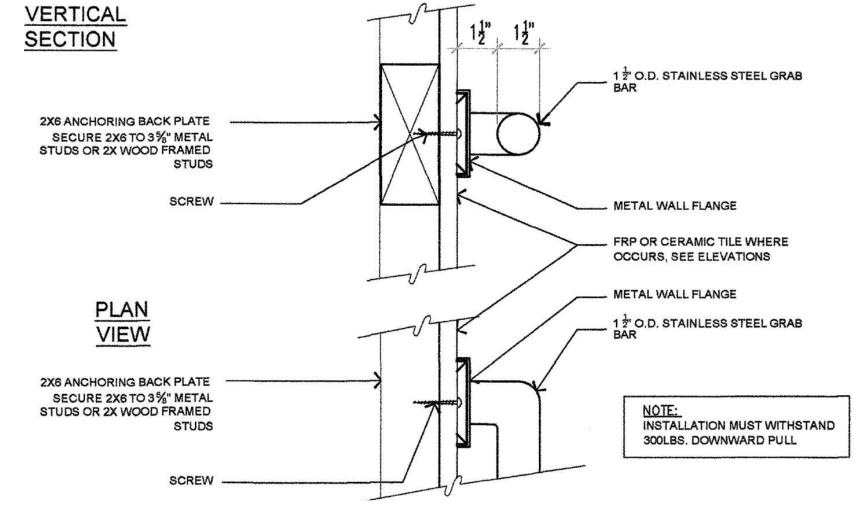

GRAB BARS DETAILS

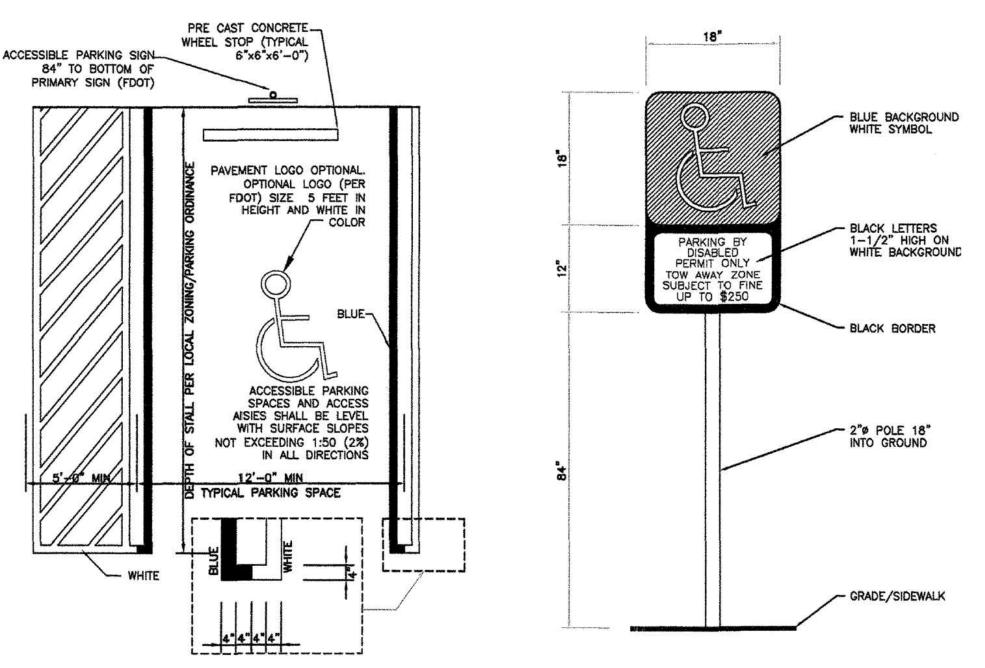

ADA TYPICAL PARKING SIGNAGE



ARCHITECTURA GROUP MIAMI

ARCHITECTURE INTERIOR DESIGN PLANNING AA26001885 ID 00003873

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Issue		
No.	Date	Description

CHI - COMMUNITY HEALTH of SOUTH FLORIDA



Registered Architect # AR 94560

TYPICAL <u>A.D.A.</u> **DETAILS**

Drawn by	N.P.
Checked by	E.P.
Project Number	269.20
Issued for	PERMIT
Issue date	Sheet #
06.01.20	A1.08
Scale	41.00

		T			D.4.0.E			1			0511110			
			LOC	R	BASE			WALL			CEILING			REMARKS
ROOM	ROOM	SEALED/PAINT CONC.	PORCELAIN TILE	- LUXURY VINYL TILE		RUBBER / VINYL	PORCELAIN TILE	PAINTED GYPSUM BOARD	FULL HEIGHT. TILE	EPOXY PAINT	MEDICAL GRADE ACOUSTICAL TILE CEILING	DECORATIVE - ACOUSTIC / ACCENT PANELS		
NO.	NAME		ORCEL	Д-ГО		JBBEF	ORCEL	VINTE	出出) AXO	EDICA	ECOR/		
		S	PC	LVT			PC	PA	고	出	W			
W-01	LOBBY / WAITING / CORRIDOR 1ST FLOOR	-		0										
A-01	MANAGER OFFICE	_												
A-02	CONFERENCE ROOM													
A-03	DOCTORS OFFICE	+												
D-01	DENTAL ROOM 2													
D-02	DENTAL ROOM 2 DENTAL ROOM 3	-				0					0			
D-03	DENTAL ROOM 3 DENTAL ROOM 4													
F-01	FAMILY ROOM 1													
F-02	FAMILY ROOM 2	+									0			
F-03	FAMILY ROOM 3	1												
F-04	FAMILY ROOM 4										0			
P-01	PEDS 01	1		0				0			0			
P-02	PEDS 02													
OB-01	OBGYN 01			0		0		0			0			
OB-02	OBGYN 02			0		0		0			0			
OB-03	OBGYN 03	1				0					0			
L-01	QUEST BLOOD LAB			0		0				0	0			
L-02	DENTAL LAB			0		0				0	0			
L-03	STERILIZATION ROOM			0		0				0	0			
MS-01	MED STORAGE / TELE PHARMA			0		0		0			0			
MS-02	MED STORAGE / TELE PHARMA			0		0		0			0			
N-01	NURSES STATION			0		0		0			0			
V-01	VITALS ROOM 1			0		0		0			0			
V-02	VITALS ROOM 2			0		0				0	0			
ST-01	DENTAL EQUIPMENT ROOM					0				0				
ST-02	STORAGE & SUPPLIES									0				
RR-01	RESTROOM 01		0				0		0	0	0			
RR-02	RESTROOM 02		0				0		0	0	0			
RR-03	RESTROOM 03		0				0		0	0	0			
EN-01	ENVIRO STORAGE													

LVT Flooring SPECIFICATION FOR PURCHASE

MANUFACTURER: AMTICO

Material: LVT Planks 9" X 36"; Collection: AMTICO Signature; Color: WASHED TEAK (AROW5990); Wear Layer: 40 MIL;

QUANTITY TO INSTALL: 3,400 Sq. F.

LVT Floors + KOSTER Moisture Mitigation Membrane

SPECIFICATION FOR INSTALLATION:

- 1. DUST OFF AND WET MOP CLEAN AREA 3500 SQF
- 2. Installation of KOSTER PRIMER in (VAP I 06)2 coats TOTAL 7,000 Sq. F.
- 3. iNSTALLATION of KOSTER WATERPROOFING Liquid Membrane (VAP 2000 UFS) 3500 Sq.F
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- 5. INSTALLATION OF LVT PLANKS 3,400 Sq.F.
- 6. INSTALLATION OF of VINYL WALL BASE (4 ")



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INTERIOR DESIGN
PLANNING
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Date

CHI - COMMUNITY

HEALTH of SOUTH
FLORIDA

/EST Medical Center

IGN & SEAL



Registered Architect # AR 9450

FINISHING SCHEDULES

Drawn by	N.P.
Checked by	E.P.
Project Number	269.20
Issued for	PERMIT
Issue date	Sheet #
06.01.20	A1 00
Scale NTS	A1.09

NOTE

1. ALL INTERIOR CEILINGS AND WALL FINISHES SHALL BE CLASS 'A' THROUGHOUT.

2. ALL INTERIOR FLOOR FINSIHED SHALL BE TYPE '2' THROUGHOUT.

3. ALL TOILET ROOM FLOORS AND WALLS (to 8'-0" A.F.F.) to be of IMPERVIOUS MATERIAL.

MADE			ΓY.				— FGI	RESS PRO	OTECTIO	11/1 1 -	DUC					NO	OTES	1000.1.6 DOOR OPERATIONS, EXCE
MARK	ELEVATI	.ON 3		WIDTH	Н	HEIGHT				APPI	ROVA	۱L						WITHOUT THE USE OF A KEY OR SI 1008.1.8.1 HARDWARE, DOOR HAND
Α	FF	6	;	24"		60"	1	NO IMPA	CT GLA	SS NOA b	у Со	ntracto	or E	Bronze	e Alur	n.Frai	mes, Dark gray Tinted Glass	SHALL NOT REQUIRE TIGHT GRASE
В	LL	4	1	98"		60"	N	NO IMPA	CT GLA	SS NOA b	у Со	ntracto	or E	Bronze	e Alur	n.Frai	nes, Dark gray Tinted Glass	1008.1.8.2 HARDWARE HEIGHT. A LA
С	KK	1		126" W		96"		NO SAFE	TY GLAS	SS	N.A.		F	FRAME	LESS	S, INS	TALLED WITH SILICONE IN	OF OPERATION UNDER ALL LIGHTI
				DOOF	₹												M ALUMINUM TRACKS	MORE THAN 48 INCHES (1219 MM) A
$\overline{}$	OOPS	SCH	E	ПП	E _	GC	to	vorif	N Ei	ald N	103	2611	ro	s n	ric	\r +	o Order	11-4.13.9 DOOR HARDWARE, HAND
<u>_</u>	OUKS	<u> ЭСП</u>	_			G.C	<u> </u>	AGIII	у ги		SWING					_		TO GRASP WITH ONE HAND AND DO
MARK	FROM	ТО	No I OPN	G WIDTH		THICK	TYPE	MATERIAL	FINISH	LOCK / HANDLE	TYPE			THRES	CLOSE	PANIC BAR	REMARKS	MECHANISMS, PUSH-TYPE MECHAN SHALL BE EXPOSED AND USABLE
(101)	CORRIDOR	RR	1	3'-0"	6'-8"	1 3/4"	STEEL	STEEL	PAINTED	PRIVACY/ADA	С	STEEL	ВВ	-	Y	N	1 HR FIRE RATED	(1219 MM) ABOVE FINISH FLOOR.
102	ADMIN	CORRIDOR	₹ 1	3'-0"	0'-42'	" 1 3/4"	WOOD	WOOD	LAMINATE	LATCH	С	STEEL	DD	-	N	N	HALF DOOR	(1219 MINI) ABOVE I INISTITEOUX:
103	ADMIN	CORRIDOR	٦ 1	3'-0"	0'-42'	" 1 3/4"	WOOD	WOOD	PAINTED	LATCH	С	STEEL	DD	-	N	N	HALF DOOR	DOORS SWING TYPES
104	CORRIDOR	CORRIDOR	٦ 1	3'-0"	6'-8"	1 3/4"	STEEL	STEEL	PAINTED	MAG LOCK	D	STEEL	ВВ	-	Y	N	1 HR FIRE RATED	
105	CORRIDOR	CORRIDOR	٦ 1	3'-0"	6'-8"	1 3/4"	STEEL	STEEL	PAINTED	MAG LOCK	С	STEEL	ВВ	-	Y	N	1 HR FIRE RATED	RIGHT LEFT HAND
106	CORRIDOR	ENVIRO	1	3'-0"	6'-8"	1 3/4"	STEEL	STEEL	PAINTED	KEY PAD	С	STEEL	ВВ	-	Υ	N	1 HR FIRE RATED	REVERSE Exterior REVERSE
107	CORRIDOR	LAB	1	3'-0"	6'-8"	1 3/4"	STEEL	STEEL	PAINTED	KEY PAD	D	STEEL	ВВ	-	Υ	N	1 HR FIRE RATED	(RHR)
108	ADMINISTRATION	PHARMACY	Y 1	3'-0"	6'-8"	1 3/4"	STEEL	STEEL	PAINTED	KEY PAD	С	STEEL	ВВ	-	Y	N	1 HR FIRE RATED	
109	LAB	CORRIDOR	٦ 1	3'-0"	6'-8"	1 3/4"	STEEL	STEEL	PAINTED	KEY PAD	D	STEEL	ВВ	-	Y	N	1 HR FIRE RATED	Interior
110	LAB	CORRIDOR	R 1	3'-0"	6'-8"	1 3/4"	STEEL	STEEL	PAINTED	KEY PAD	D	STEEL	ВВ	-	Y	N	1 HR FIRE RATED	A Exterior Door B Exteri
111	TECH ROOM	CORRIDOR	٦ 1	3'-0"	6'-8"	1 3/4"	STEEL	STEEL	PAINTED	KEY PAD	С	STEEL	ВВ	-	Y	N	1 HR FIRE RATED	Right Hand Outswing Left Hanc
112	CORRIDOR	BREAK ROOM	ч 1	3'-0"	6'-8"	1 3/4"	STEEL	STEEL	PAINTED	KEY PAD	С	STEEL	ВВ	-	Y	N	1 HR FIRE RATED	Tight hand satesming
113	REST ROOM	CORRIDOR	R 1	3'-0"	6'-8"	1 3/4"	STEEL	STEEL	PAINTED	PRIVACY	D	STEEL	ВВ	-	Υ	N	1 HR FIRE RATED	Interior
114	CORRIDOR	RR	1	3'-0"	6'-8"	1 3/4"	STEEL	STEEL	PAINTED	PRIVACY/ADA	D	STEEL	ВВ	-	Υ	N	1 HR FIRE RATED]
115	STERILIZATION	CORRIDOR	R 1	3'-0"	6'-8"	1 3/4"	STEEL	STEEL	PAINTED	ADA	С	STEEL	CC	-	Y	Y	1 HR FIRE RATED	
116	OBGYN	CORRIDOR	1	3'-0"	6'-8"	1 3/4"	STEEL	STEEL	PAINTED	ADA	С	STEEL	ВВ	-	Υ	N	1 HR FIRE RATED	Interior
117	OBGYN	CORRIDOR	1	3'-0"	6'-8"	1 3/4"	STEEL	STEEL	PAINTED	ADA	D	STEEL	ВВ	-	Υ	N	1 HR FIRE RATED	
(KK)	DOCTORS	CORRIDOR	R 1	3'-0"	6'-8"	1 3/4"	GLASS	GLASS	-	KEY PAD	С	-	KK	-	Υ	N	CLOSER ON HINGE	Interior Door Interior
119	EXAM ROOM	CORRIDOR	R 1	3'-0"	6'-8"	1 3/4"	STEEL	STEEL	PAINTED	KEY PAD	С	STEEL	ВВ	-	Υ	N	1 HR FIRE RATED	Right Hand Inswing Left Hand
120	EXAM ROOM	CORRIDOR	R 1	3'-0"	6'-8"	1 3/4"	STEEL	STEEL	PAINTED	ADA	С	STEEL	ВВ	-	Y	N	1 HR FIRE RATED	
121	EXAM ROOM	CORRIDOR	1	3'-0"	6'-8"	1 3/4"	STEEL	STEEL	PAINTED	ADA	D	STEEL	ВВ	-	Y	N	1 HR FIRE RATED]
122	NURSES STATION	CORRIDOR	1	3'-0"	0'-42"	1 3/4"	WOOD	WOOD	PAINTED	LATCH	С	STEEL	DD	-	N	N	HALF DOOR	
123	EXAM ROOM	CORRIDOR	1	3'-0"	6'-8"	1 3/4"	STEEL	STEEL	PAINTED	ADA	D	STEEL	ВВ	-	Y	N	1 HR FIRE RATED	BURGLAR INTRUSION NOTES:
124	EXAM ROOM	CORRIDOR	1	3'-0"	6'-8"	1 3/4"	STEEL	STEEL	PAINTED	ADA	С	STEEL	ВВ	-	Y	N	1 HR FIRE RATED	 1. ALL LOCKS ON EXTERIOR DO 2. ENTRANCE GLASS DOORS S
125	LAB	CORRIDOR	1	3'-0"	6'-8"	1 3/4"	STEEL	STEEL	PAINTED	KEY PAD	D	STEEL	ВВ	-	Υ	N	1 HR FIRE RATED	DOOR DEADBOLT OR A PIN NOT
126	EXAM ROOM	CORRIDOR	1	3'-0"	6'-8"	1 3/4"	STEEL	STEEL	PAINTED	ADA	D	STEEL	ВВ	-	Y	N	1 HR FIRE RATED	REINFORCED IN THE STRIKE AND
127	EXAM ROOM	CORRIDOR	1	3'-0"	6'-8"	1 3/4"	STEEL	STEEL	PAINTED	ADA	С	STEEL	ВВ	-	Y	N	1 HR FIRE RATED	OUTSIDE.
128	STORAGE	CORRIDOR	1	3'-0"	6'-8"	1 3/4"	STEEL	STEEL	PAINTED	KEY PAD	D	STEEL	ВВ	-	Υ	N	1 HR FIRE RATED	3. HINGES ON EXTERIOR OUT
129	MED STORAGE	NURSES	1	3'-0"	6'-8"	1 3/4"	WOOD	WOOD	PAINTED	LOCK	-	STEEL	EE	-	Υ	N	POCKET DOOR	4. GLASS IN EXTERIOR DOORS
201	CORRIDOR	OUTSIDE	1	3'-0"	6'-8"	1 3/4"	STEEL	STEEL	PAINTED	ADA	В	STEEL	CC	-	Υ	Y	2 HR FIRE RATED EXTERIOR IMPACT	5. ENTRANCE GLASS DOORS S
202	CORRIDOR	OUTSIDE	1	3'-0"	6'-8"	1 3/4"	STEEL	STEEL	PAINTED	Keyed/w Bypa	ss A	STEEL	CC	-	Υ	Y	2 HR FIRE RATED EXTERIOR IMPACT	AND SO AS TO COMPLY WIT
203	LOBBY	OUTSIDE	2	8'-0"	7'-00"	1 3/4"	SLIDER	ALUMINUM	ANODIZED		-	ALUM.	AA	-	AUTO	Y	STANLEY AUTO SLIDER- IMPACT GLASS]
			_						•	-					•	-		

WINDOWS SCHEDULE - G.C. to verify Field Measures prior to Order

WINDOW WINDOW CT ROUGH OPENING

DOOR NOTES:

1008.1.8 DOOR OPERATIONS, EXCEPT AS SPECIFICALLY PERMITTED IN THIS SECTION EGRESS DOOR SHALL BE READILY OPENABLE FROM THE EGRESS SIDE USE OF A KEY OR SPECIAL KNOWLEDGE OR EFFORT.

DWARE, DOOR HANDLES, PULLS, LATCHES, LOCKS AND OTHER OPERATING DEVICES ON DOORS REQUIRED TO BE ACCESSIBLE BY CHAPTER 11 EQUIRE TIGHT GRASPING, TIGHT PINCHING OR TWISTING OF THE WRIST TO OPERATE.

DWARE HEIGHT. A LATCH OR OTHER FASTENING DEVICE ON A DOOR SHALL BE PROVIDED WITH A RELEASING DEVICE HAVING AN OBVIOUS METHOD UNDER ALL LIGHTING CONDITIONS. THE RELEASING MECHANISM FOR ANY LATCH SHALL BE LOCATED AT LEAST 34 INCHES (864 MM) AND NOT INCHES (1219 MM) ABOVE THE FINISHED FLOOR. DOORS SHALL BE OPERABLE WITH NOT MORE THAN ONE RELEASING OPERATION. HARDWARE, HANDLES, PULLS, LATCHES, LOCKS, AND OTHER OPERATING DEVICES ON ACCESSIBLE DOORS SHALL HAVE A SHAPE THAT IS EASY TH ONE HAND AND DOES NOT REQUIRE TIGHT GRASPING, TIGHT PINCHING, OR TWISTING OF THE WRIST TO OPERATE. LEVER-OPERATED PUSH-TYPE MECHANISMS, AND U-SHAPED HANDLES ARE ACCEPTABLE DESIGNS. WHEN SLIDING DOORS ARE FULLY OPEN, OPERATING HARDWARE OSED AND USABLE FROM BOTH SIDES. HARDWARE REQUIRED FOR ACCESSIBLE DOOR PASSAGE SHALL BE MOUNTED NO HIGHER THAN 48 INCHES

ORS SWING TYPES

B | Exterior Door

Left Hand Outswing

Interior Door

Left Hand Inswing

THE ELECTRIC DOOR STRIKE SHALL FAIL SAFE (OPEN) IN CASE OF LOSS OF POWER OF THE CONTROL CIRCUIT OR FIRE ALARM ACTUATION, AND THE DOOR HARDWARE SHALL ALLOW THE DOOR TO OPEN FROM INSIDE LOCATION AT ANY TIME. PROVIDE CONTROL WIRING AS REQUIRED.

THE MAGLOCK SHALL FAIL SAFE (OPEN)IN CASE OF LOSS OF POWER ON THE CONTROL CIRCUIT OR FIRE ALARM ACTUATION. THE DOOR ARRANGEMENT SHALL BE SUCH THAT THE MAGLOCK DISCONNECTS (OPENS) FROM INSIDE LOCATION AT ANY TIME AFTER DEPRESSING THE PUCH TO EXIT BUTTON. PROVIDE CONTROL WIRING AS REQUIRED AND COMPLY WITH NFPA 101 2012 SRTICLE 7.2.1.6.2.

CKS ON EXTERIOR DOORS SHALL BE CAPABLE OF RESISTING A FORCE OF 300 LBS. APPLIED IN ANY MOVABLE DIRECTION.


NCE GLASS DOORS SHALL BE PROVIDED WITH:


BOLT OR A PIN NOT REMOVABLE OR OPERABLE FROM THE EXTERIOR AT THE JAMB, SILL, HEAD OR MEETING MULLIONS. THESE DOORS SHALL BE D IN THE STRIKE AND LOCK AREA TO MAINTAIN BOLT STRENGTH EFFECTIVENESS IF NECESSARY AND SUCH DOORS SHALL HAVE READY ENTRY FROM

S ON EXTERIOR OUT SWINGING DOORS SHALL HAVE NON-EXPOSED SCREWS AND NON-OPERABLE PINS.

IN EXTERIOR DOORS SHALL COMPLY WITH THE AMERICAN NATIONAL STANDARDS INSTITUTES, STANDARD Z97.1

NCE GLASS DOORS SHALL BE INSTALLED AND CONSTRUCTED SO THAT NO PANEL CAN BE LIFTED FROM THE BOTTOM WHEN IN THE LOCKED POSITION AS TO COMPLY WITH THE ARCHITECTURAL ALUMINUM MANUFACTURERS ASSOCIATION STANDARD FOR FORCED ENTRY RESISTANCE, AAMA 13303.3

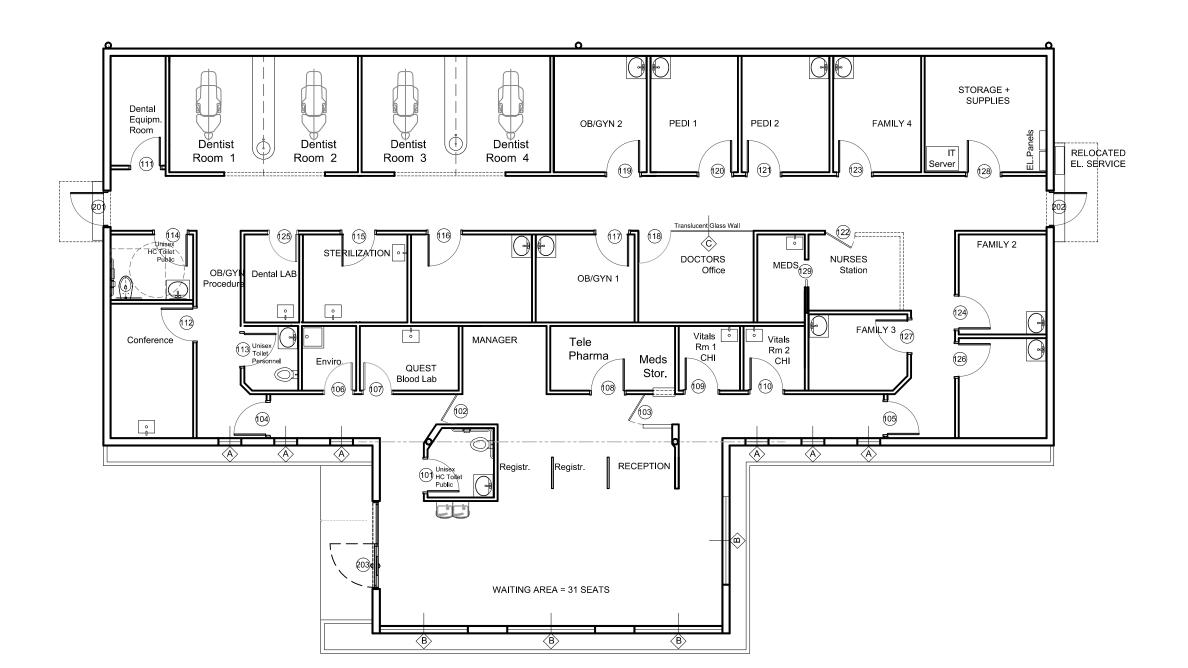

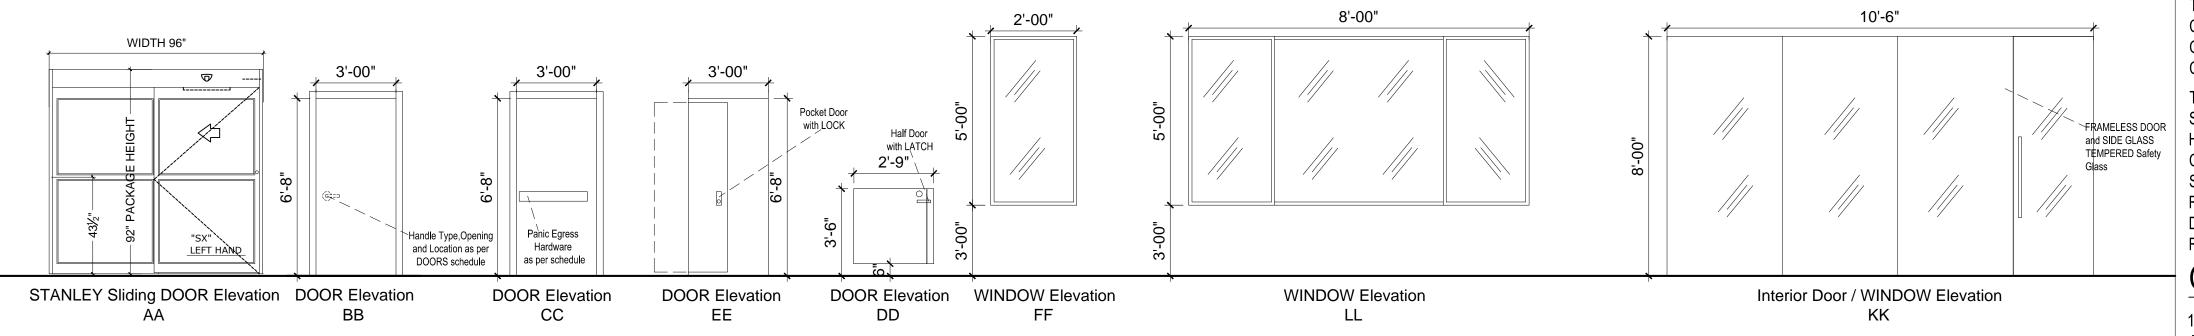

DOORS GENERAL NOTES:

- 1. ALL P.T. WD. BUCKS TO BE ANCHORED W/ 1\" LONG HARDENED COIL NAILS OF .099" DIAMETER @ 8" 0.C. (STAGGERED). 2. STOREFRONT WINDOWS TO BE FASTENED TO FILLED CELL OR CONCRETE AND THRU WD. BUCKS AS PER PRODUCT APPROVAL. 4. P.T. WD. BUCK MAY BE TRIMMED AS REQUIRED SUCH THAT THE MIN. THICKNESS IS NOT LESS THAN \"
- 5. BACKBED THE WOOD BUCK WITH SEALANT BEFORE FASTENING AND SET THE STOREFRONT FRAMES IN A BED OF SEALANT ON ALL FOUR (4) SIDES.
- 3. SHOULD SHIMS BE REQUIRED BETWEEN BUCK AND WINDOW, THEY ARE TO BE \" MAX. THICKNESS. ANCHORAGE OF WINDOW TO MASONRY OR CONCRETE MUST STILL COMFORM TO PRODUCT APPROVAL IN REGARDS TO DEPTH OF PENETRATION OF ANCHORS 6. CONTRACTOR SHALL SUBMIT PRODUCT APPROVALS FOR ALL DOORS, STOREFRONTS, & SHUTTERS (WITH ARCHITECT'S APPROVED STAMP) TO BLDG. DEPT. PRIOR TO INSTALLATION.

STOREFRONT NOTES:

- 1. ALL DOOR HARDWARE TO HAVE LEVER HANDLES (SINGLE ACTION RELEASE W/OUT INTERIOR KEY LOCKS), MAXIMUM CLOSER PULL FORCE TO BE 5 LB.
- 2. ALL DOOR HARDWARE SHALL BE HANDICAPPED ACCESSIBLE.
- 3. ALL RATED DOORS SHALL HAVE AUTO CLOSERS.
- 4. DOORS IN MEANS OF EGRESS SHALL HAVE PANIC HARDWARE AND AUTO-CLOSERS. LOCKS SHALL NOT REQUIRE THE USE OF A KEY, A TOOL, OR SPECIAL KNOWLEDGE OR EFFORT FOR OPERATION FROM THE EGRESS SIDE.
- 5. ALL RATED DOORS SHALL HAVE MATCHING RATED ASSEMBLIES. 6. DOORS AND HARDWARE SHALL COMPLY WITH N.F.P.A. 101, & F.B.C., 2017 EDITION.
- 7. ALL EGRESS DOORS SHALL HAVE PANIC HARDWARE PER F.B.C. 1019.7 & N.F.P.A. 101.
- 8. ALL FIRST FLOOR STOREFRONT DOORS SHALL HAVE DADE COUNTY PRODUCT APPROVED WITHOUT THE USE OF HURRICANE SHUTTERS 9. ALL SECOND FLOOR STOREFRONT ASSEMBLIES SHALL BE DADE COUNTY PRODUCT APPROVED WITHOUT THE USE OF HURRICANE
- 10. ALL STOREFRONT WINDOWS, TRANSOMS AND SIDELIGHTS SHALL BE IMPACT RESISTANT WITHOUT THE USE OF HURRICANE SHUTTERS. 11. ALL EXTERIOR LOUVERS SHALL MEET OR EXCEED DESIGN WIND PRESSURES.
- 12. ALL EXTERIOR FLUSH DOORS SHALL HAVE DADE COUNTY PRODUCT APPROVED IMPACT SYSTEM.
- 13. CONTRACTOR SHALL SUBMIT PRODUCT APPROVALS FOR ALL DOORS AND STOREFRONTS (WITH ARCHITECT'S APPROVED STAMP) TO BLDG. DEPT. PRIOR TO ISSUANCE OF PERMIT
- 14. CONTRACTOR TO INSTALL FRAME AS PER PRODUCT APPROVAL
- 15. DOORS SHALL BE ARRANGED TO BE OPENED READILY FROM THE EGRESS SIDE WHENEVER THE BUILDING IS OCCUPIED. LOCKS, IF PROVIDED SHALL NOT REQUIRE THE USE OF A KEY, TOOL, SPECIAL KNOWLEDGE OR EFFORT FOR OPERATION FROM THE INSIDE OF THE BUILDING.

ANCHORING NOTES:

1. IF REQUIRED, ALL P.T. WD. BUCKS TO BE 1/2" ANCHORED W/ 1" LONG HARDENED COIL NAILS OF .099" DIAMETER @ 8" 0.C. (STAGGERED). 2. WINDOWS / DOORS TO BE FASTENED TO CONCRETE AND THRU WOOD BUCKS AS PER PRODUCT APPROVAL.

3. SHOULD SHIMS BE REQUIRED BETWEEN WALL AND WINDOW, THEY ARE TO BE 1/4" MAX. THICKNESS. ANCHORAGE OF WINDOW TO CONCRETE MUST STILL COMFORM TO PRODUCT APPROVAL IN REGARDS TO DEPTH OF PENETRATION OF ANCHORS.

4. P.T. WD. BUCK MAY BE TRIMMED AS REQUIRED SUCH THAT THE MIN. THICKNESS IS NOT LESS THAN 1/2".

5. BACKBED THE WOOD BUCK WITH SEALANT BEFORE FASTENING AND SET THE WINDOW IN A BED OF SEALANT ON ALL FOUR (4) SIDES.

HARDWARE SCHEDULE

IMPACT RESISTANT DOORS WITH PRODUCT APPROVED HARDWARE TO INCLUDE WEATHER STRIPPING, PANIC EXIT DEVICE WITH RIM CYLINDER OR PULL WITH THUMB LATCH AND CLOSER WITH HOLD OPEN DEVICE - 180 DEGREE OPENING, THRESHOLD, RAIN DRIP CAP, FLOOR STOP.

THE FOLLOWING SCHEDULE IS TO BE USED AS A GENERAL GUIDE. SPECIAL OR UNUSUAL CONDITIONS NOT COVERED WILL HAVE HARDWARE OF SIMILAR TYPE AND QUALITY TO MEET JOB CONDITIONS, AND IT IS THE CONTRACTOR'S RESPONSIBILITY TO SEE THAT ALL HARDWARE IS SUPPLIED TO MEET PROJECT REQUIREMENTS. ALL CLOSERS SHALL BE CAPABLE OF OPENING DOORS 180 DEGREES. SEE DOOR SCHEDULE FOR ASSEMBLY FIRE

GLAZING NOTES:

1. ALL GLAZING FOR INTERIOR FIXED PANELS, OPERABLE DOORS AND INTERIOR WINDOWS TO BE SAFETY GLASS. 2. ALL P.T. WD. BUCKS TO BE ANCHORED W/ 2" LONG HARDENED COIL NAILS OF .099" DIAMETER @ 8" 0.C. (STAGGERED)



ARCHITECTURA GROUP MIAMI

ARCHITECTURE INTERIOR DESIGN PLANNING AA26001885 ID 00003873

1920 E HALLANDALE BLVD., PH-11 HALLANDALE, FLORIDA 33009 PH: 954-558-3024 E-MAIL: argroupinc@aol.com AGMiami.Inc@Gmail.com

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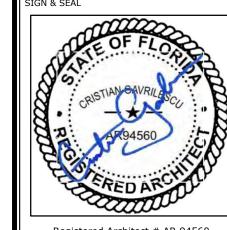
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CONTRACTOR SHALL VERIFY AND BE
RESPONSIBLE FOR DIMENSIONS AND CONDITIONS OF THE JOB AND ARCHITECTURA GROUP MIAMI TO BE NOTIFIED IN WRITING O ANY VARIATION FROM THE DIMENSIONS CONDITIONS AND SPECIFICATIONS APPEARI ON THESE PLANS (c) 2020.

Description

CHI - COMMUNITY HEALTH of SOUTH

FLORIDA

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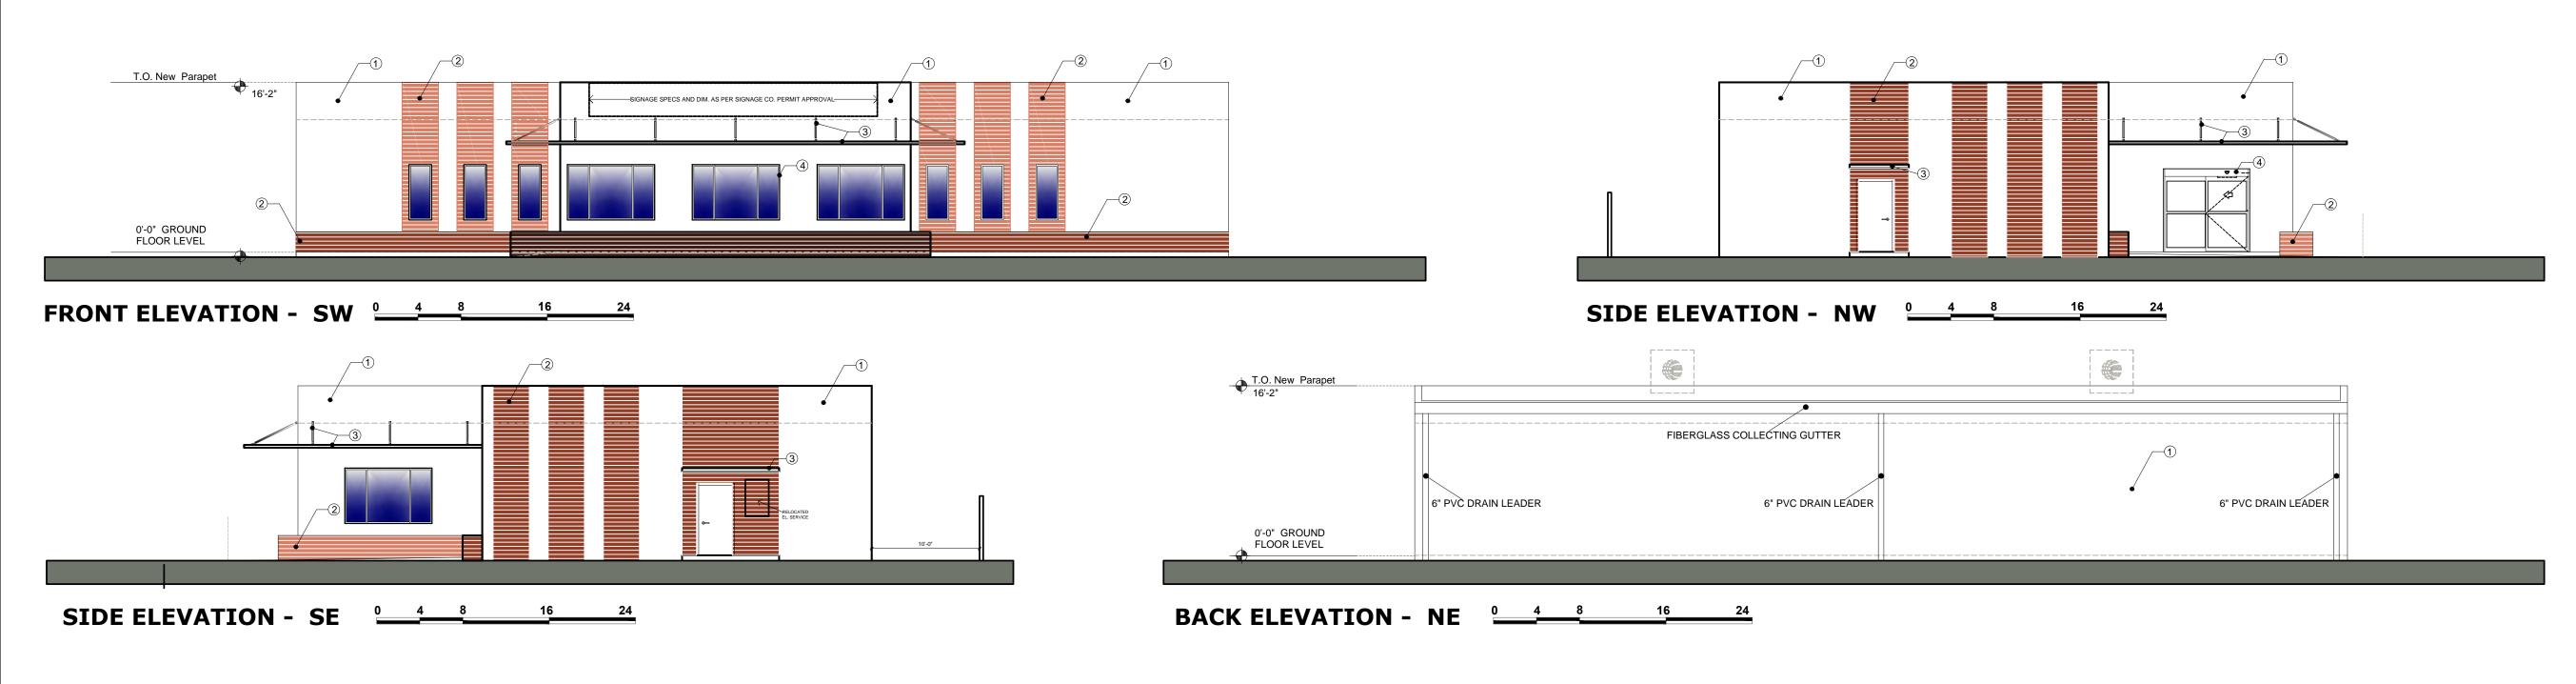
Registered Architect # AR 94560


DOORS AND WINDOWS SCHEDULES

Drawn by	N.P.
Checked by	E.P.
Project Number	269.20
Issued for	PERMIT
Issue date	Sheet #
06.01.20	A1 10
Scale NTS	A1.10



FRONT ELEVATION - SW 0 4 8 16 24



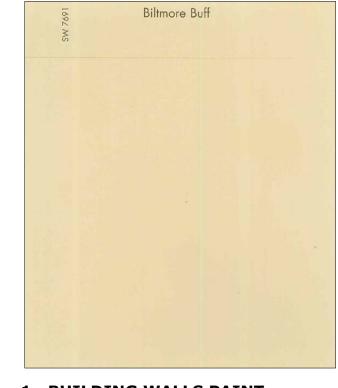

1. BUILDING WALLS PAINT: SHERWIN WILLIAMS 7691 - Biltmore Buff Semi Gloss



2. VERTICAL ACCENT STRIPS ON WALLS AND PLANTERS WRAP:
"WOOD PATTERN" - PORCELAIN TILES
6" X 36" SLATS



3. EXTERIOR DOORS AND FRAMES AND STEEL CANOPY STRUCTURE COLOR: SW 0072 - DEEP MAROON - SEMI GLOSS



4. WINDOWS FRAMES AND FRONT ENTRANCE DOOR COLOR:
DARK BRONZE ANODIZED



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Issue		


No.	Date	Description

Client

CHI - COMMUNITY HEALTH of SOUTH FLORIDA

KEY WEST Medical Center
RENOVATION


CICN 9, CEA

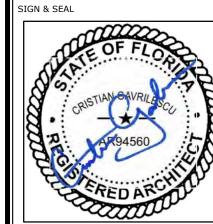

Registered Architect # AR 94560

ELEVATIONS

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Project Number	269.20
Issued for	PERMIT
Issue date	Sheet #
06.01.20	A2 01
Scale	A2.01

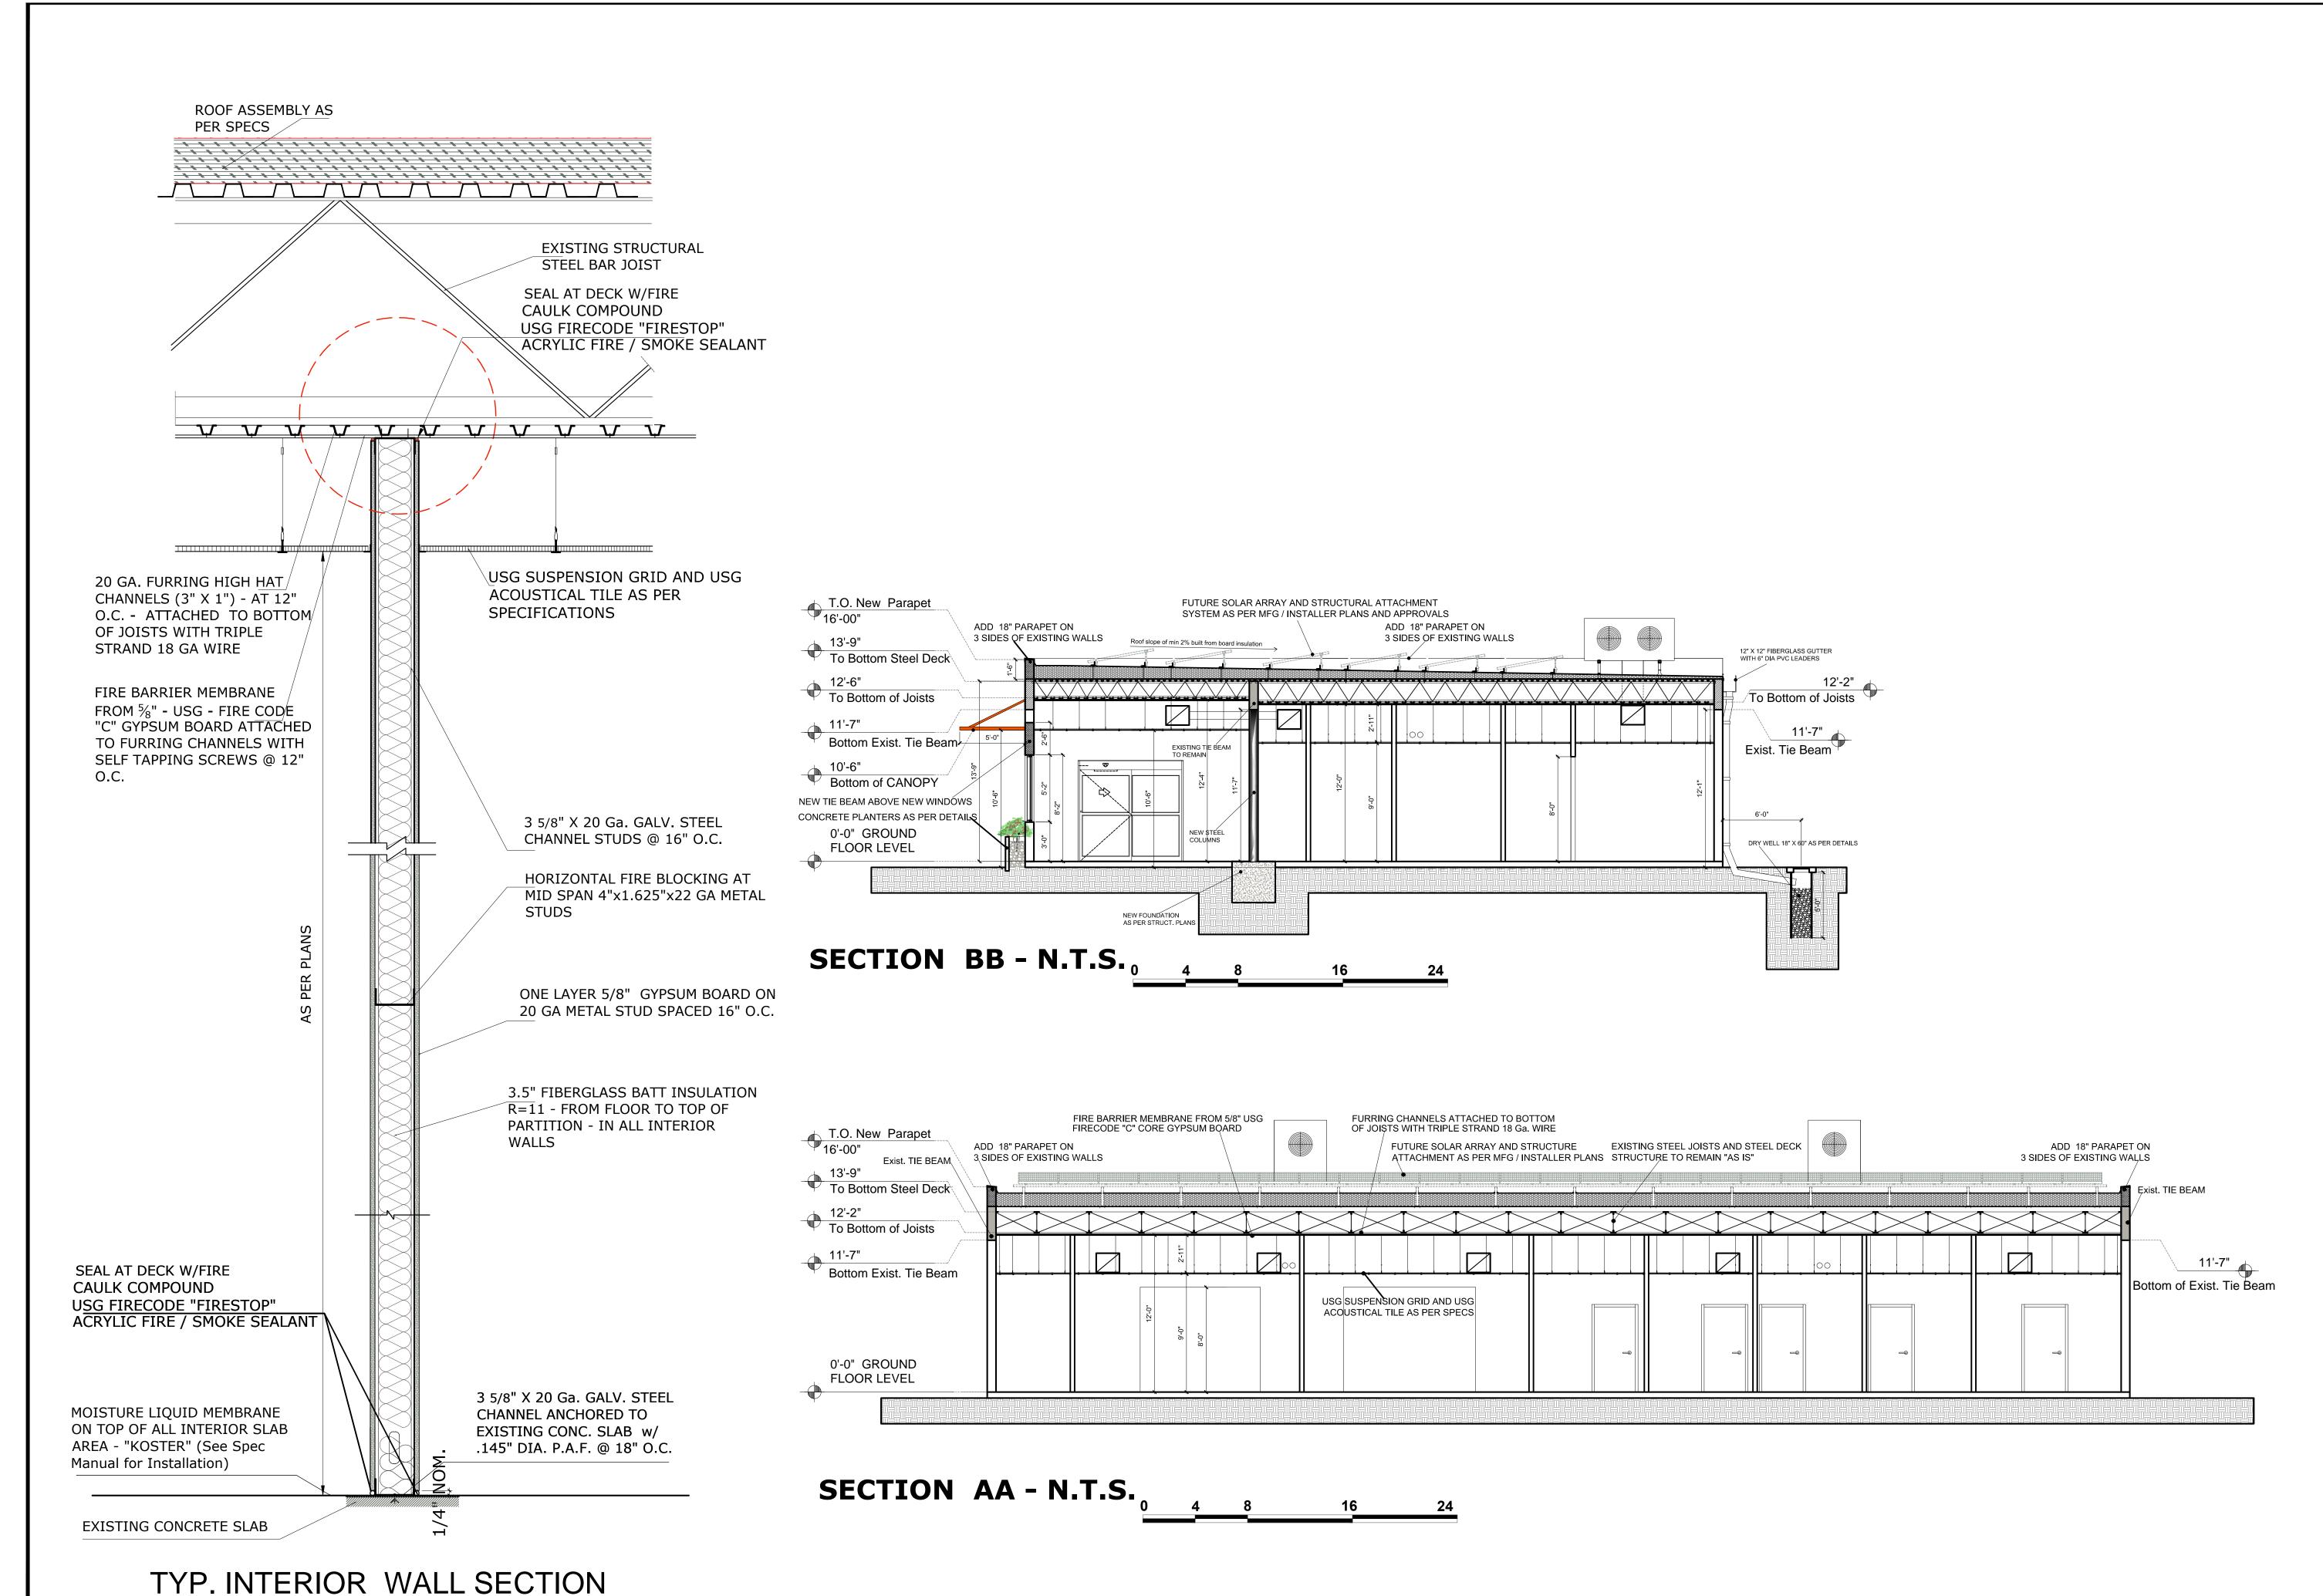

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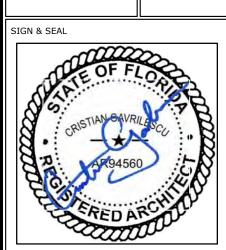
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Issue		
No.	Date	Description

CHI - COMMUNITY
HEALTH of SOUTH
FLORIDA

HI KEY WEST Medical Center

RENOVATION



Registered Architect # AR 9456


SECTIONS

and

TYPICAL WALL


SECTIONS

Drawn by	N.P.
Checked by	E.P.
Project Number	269.20
Issued for	PERMIT
Issue date	Sheet #
06.01.20	A3.01
Scale NTS	A3.UI

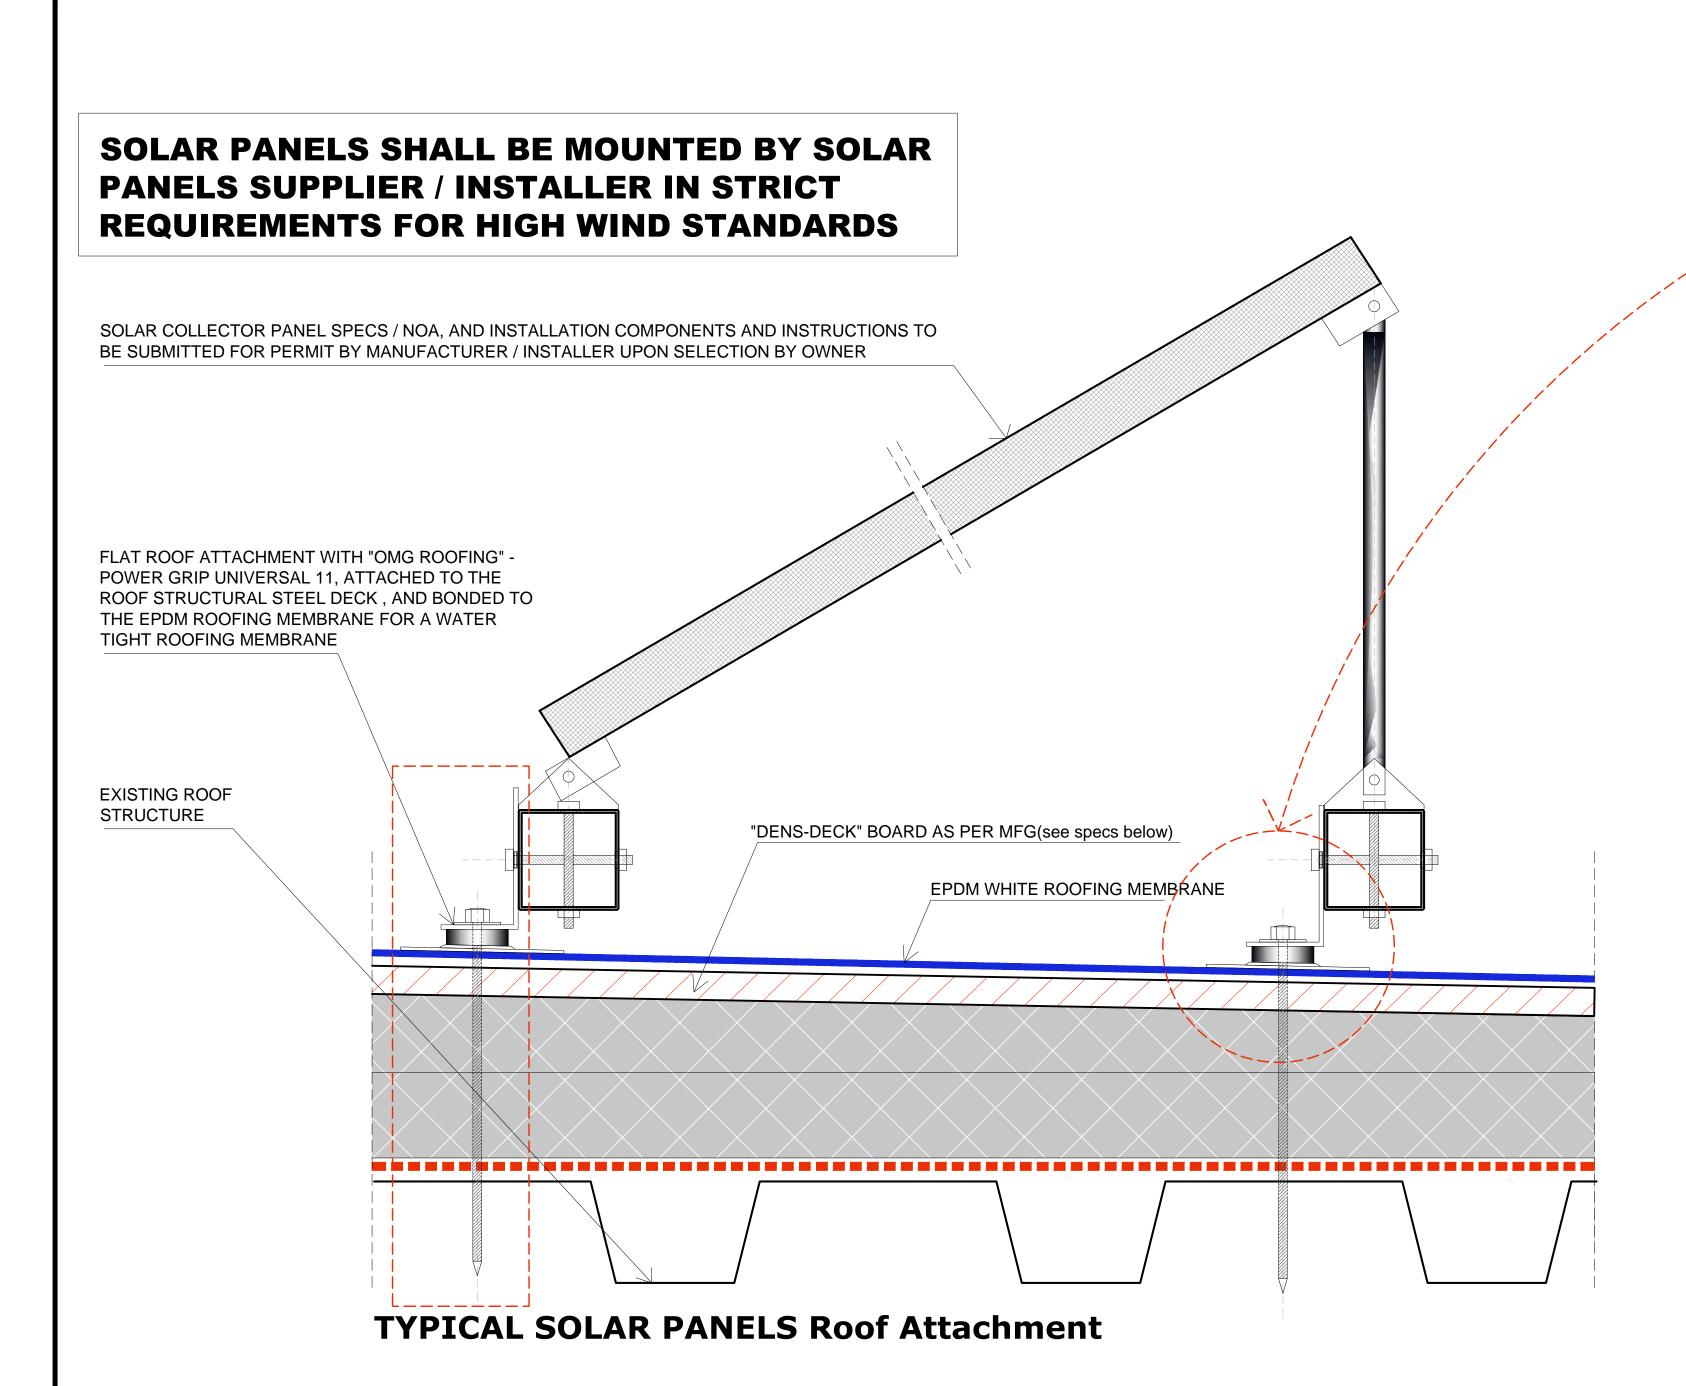

DensDECK PRIME for 180 PSF Wind Uplift

System Type and Description	Wind-Uplift PSF	Product ¹	# of fasteners (4' x 8' board)
Fully Adhered EPDM and Thermoplastic Membranes	FM 60	1/4" (6.4 mm) DensDeck®	12
uny Aunereu Er Divi anu Thermopiasuc iviembranes	FM 60/75/90	1/4" (6.4 mm) DensDeck Prime	12
A. Single ply Membrane	FM 60	1/2" (12.7 mm) DensDeck	10
3. Min. 1/4" (6.4 mm)	FM 60/75/90	1/2" (12.7 mm) DensDeck Prime	10
Dens Deck® Roof Board	FM 60/75/90	5/8" (15.9 mm) DensDeck	8
C. Insulation C	FM 60/75/90	5/8" (15 9 mm) Dens Deck Prime	Q.
D. Min. 1/4" (6.4 mm)	FM 180*	5/8" (15.9 mm) DensDeck Prime	24
DensDeck Roof D F	FM 285**	1/2" (12./ mm) DensDeck Prime	32
Board (optional) E. Classified Steel Deck F. Fastener (see chart) Single ply and EPDM will include both reinforced and nonreinforced.		rced 45 mil TPO was used to achieve an FN eBack® was used to achieve an FM 285 rat	

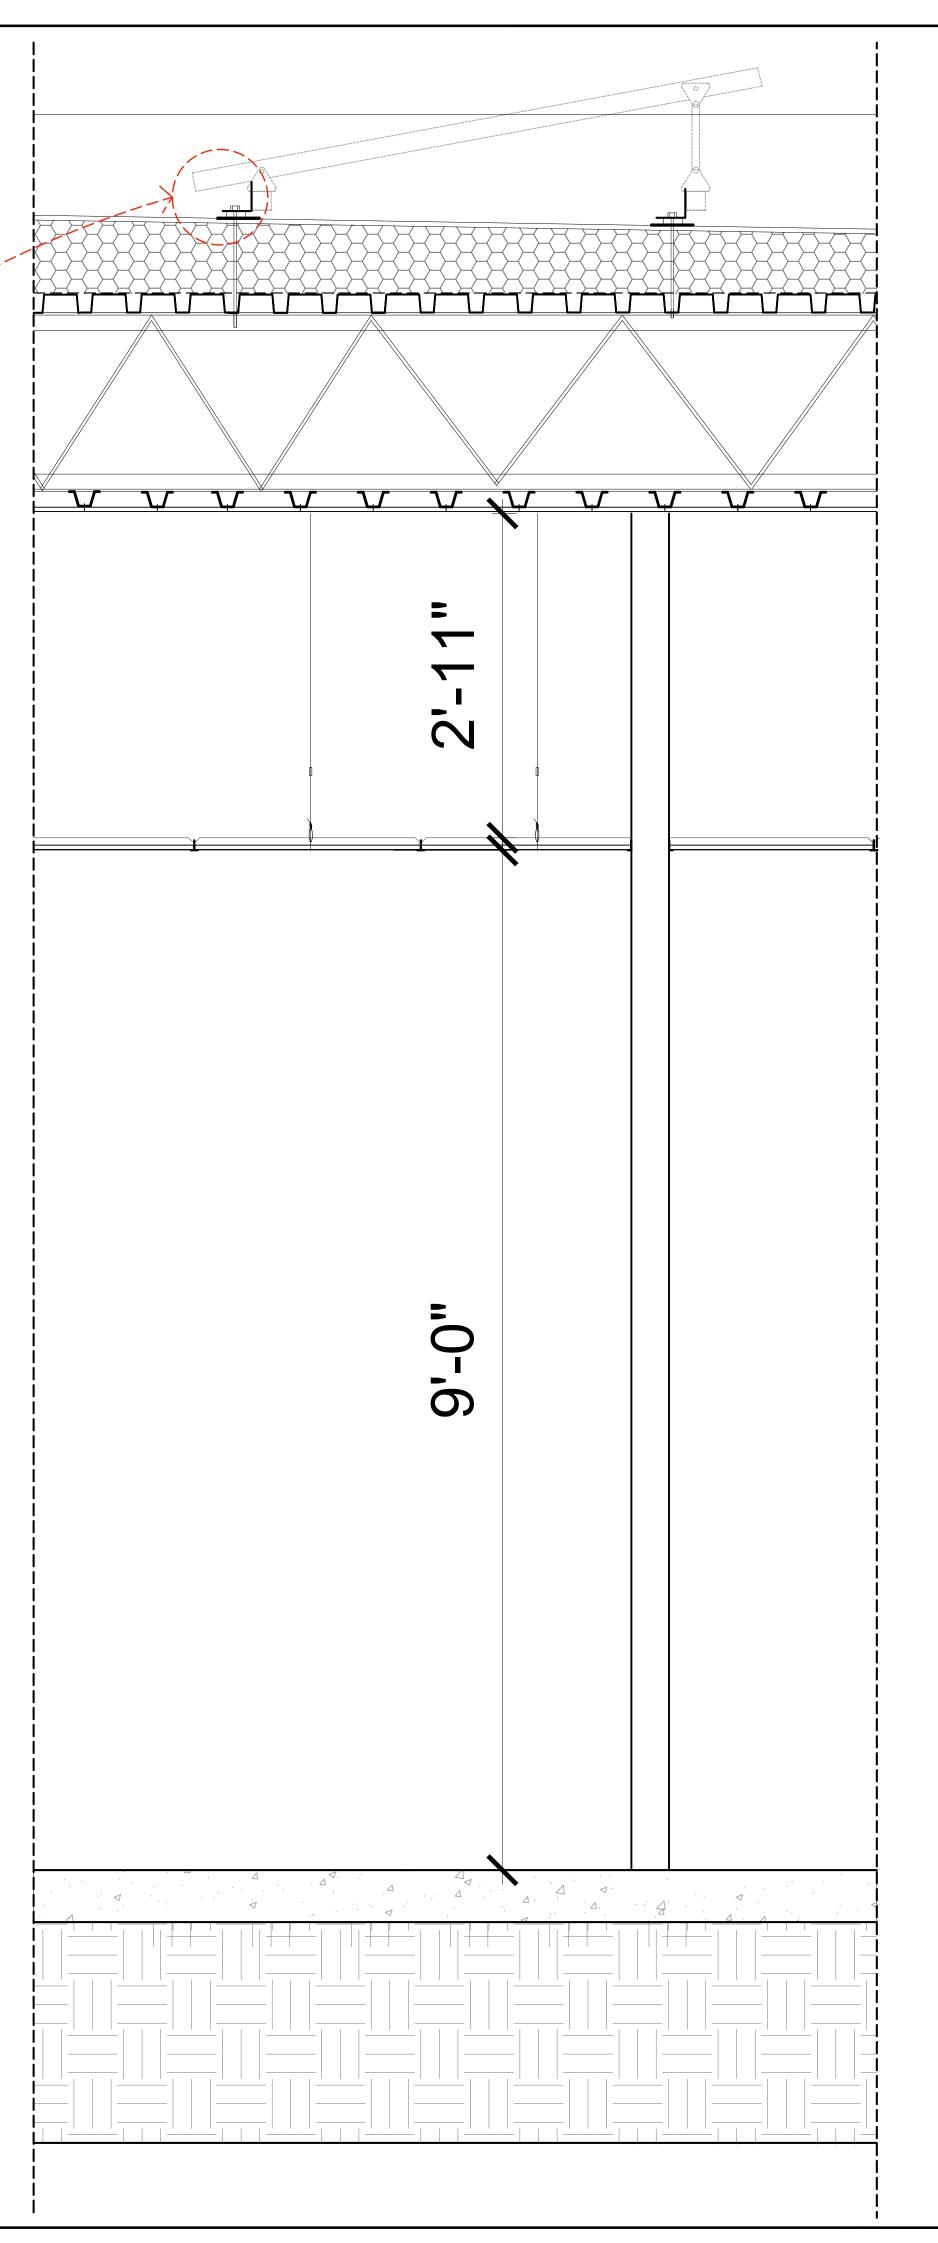



ARCHITECTURA GROUP MIAMI

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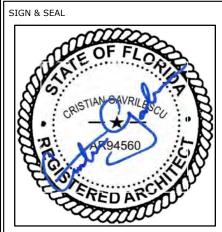
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No.	Date	Description

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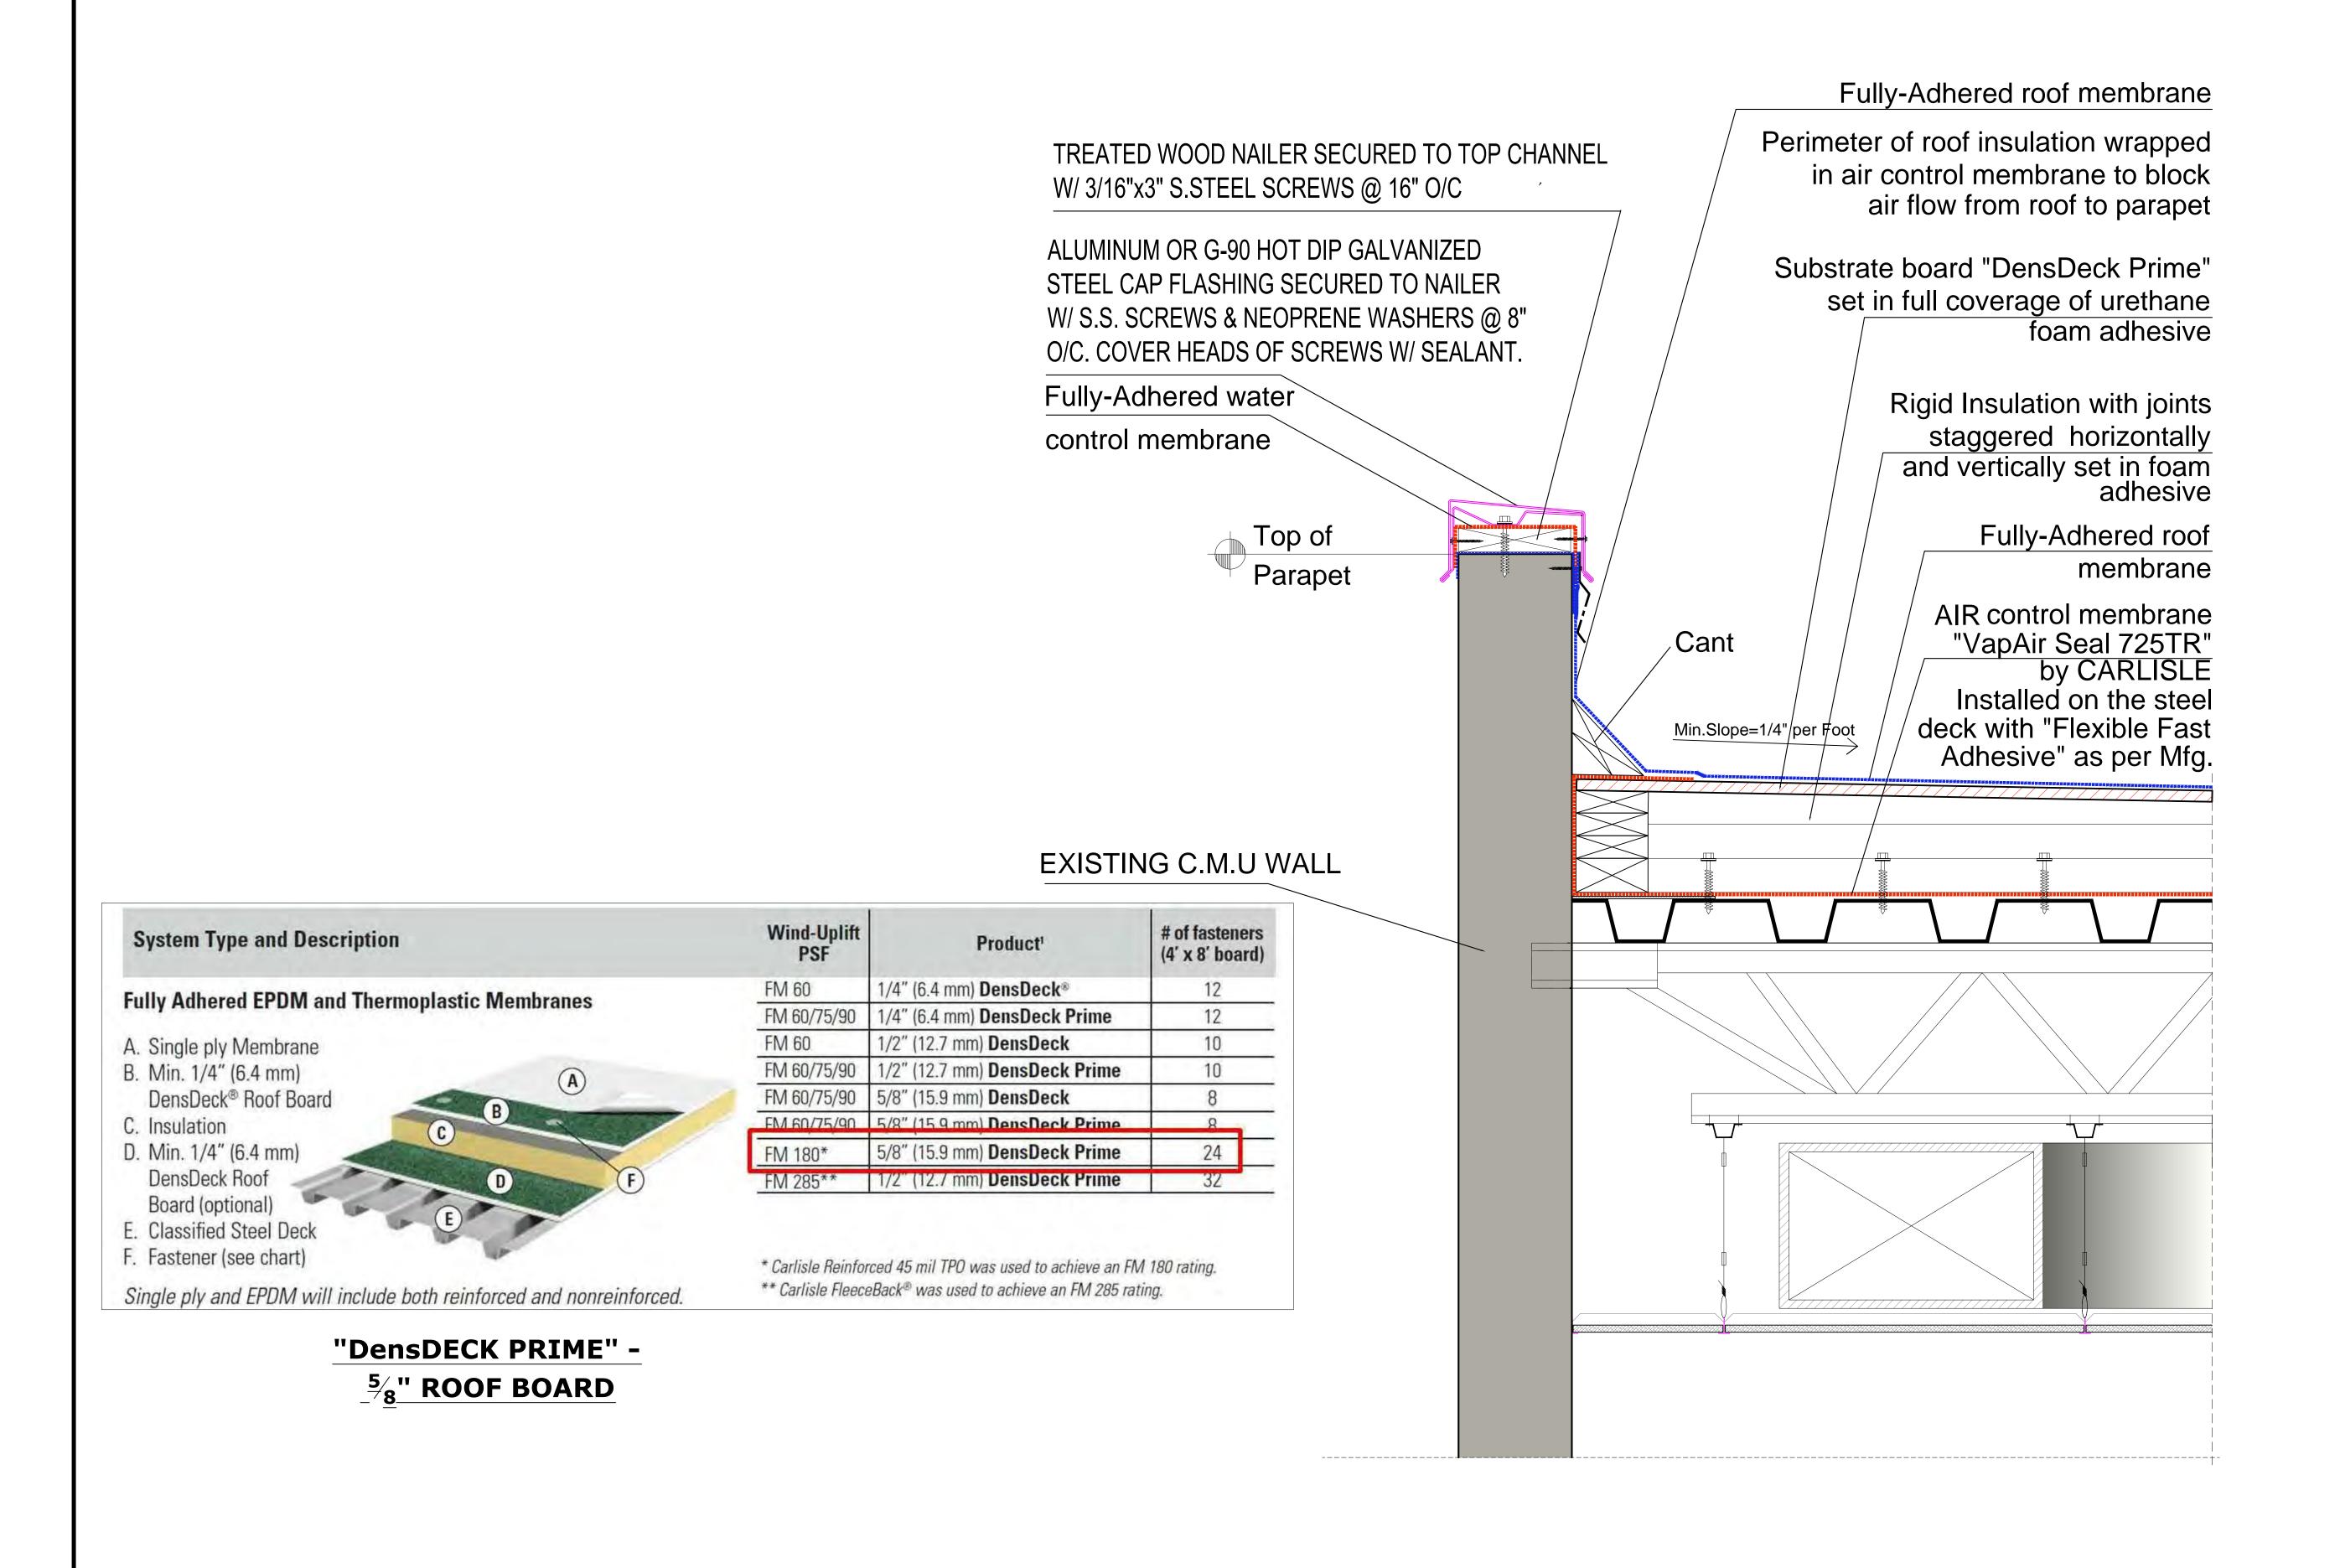
FLORIDA



SOLAR PANELS Roof Attachment DETAILS and

Drawn by		N.P.	
Checked by		E.P.	
Project Number		269.20	
Issued for		PERMIT	
Issue date	Sheet #		
06.01.20	_		

A3.02



TYP. PARAPET SECTION



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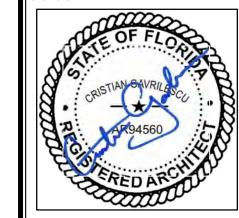
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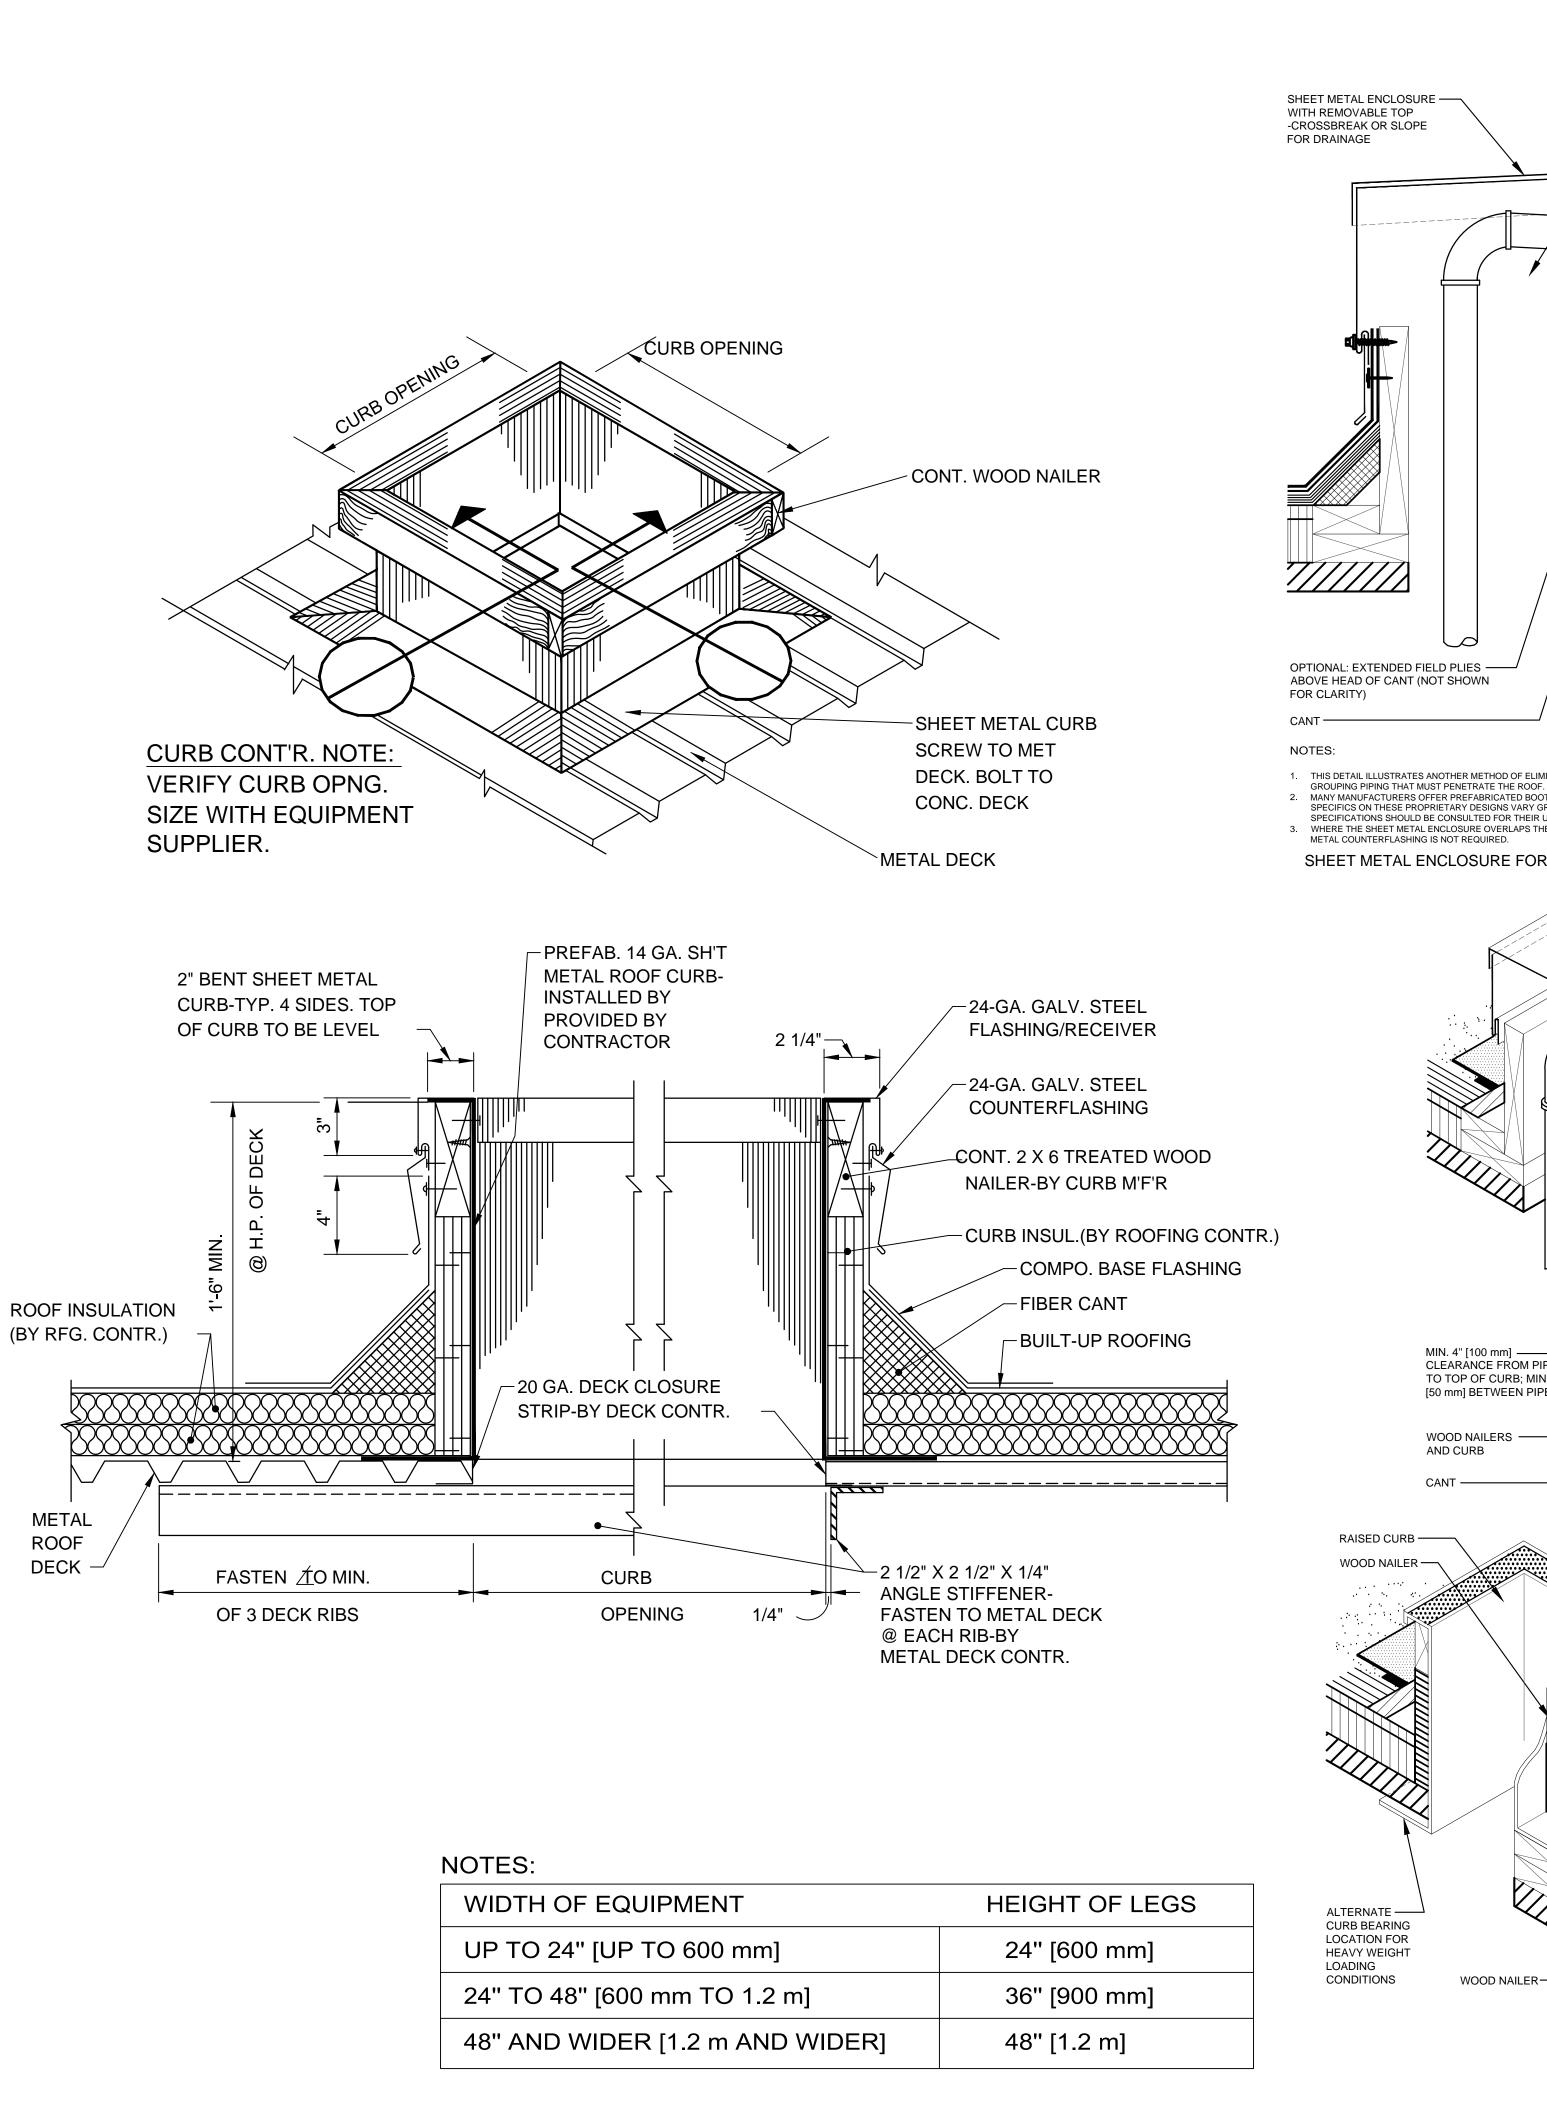
Issue		
No.	Date	Description


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ROOFING / PARAPET DETAILS


269.20 **PERMIT** 06.01.20 A3.03







- 1. THIS DETAIL ILLUSTRATES ANOTHER METHOD OF ELIMINATING PITCH POCKETS AND AN OPTIONAL METHOD OF
- 2. MANY MANUFACTURERS OFFER PREFABRICATED BOOTS AND OTHER MATERIALS FOR THIS PURPOSE. SPECIFICS ON THESE PROPRIETARY DESIGNS VARY GREATLY, AND INDIVIDUAL MANUFACTURERS'
- SPECIFICATIONS SHOULD BE CONSULTED FOR THEIR USE. 3. WHERE THE SHEET METAL ENCLOSURE OVERLAPS THE BASE FLASHING AT LEAST 3" [75 mm], THE REMOVABLE SHEET

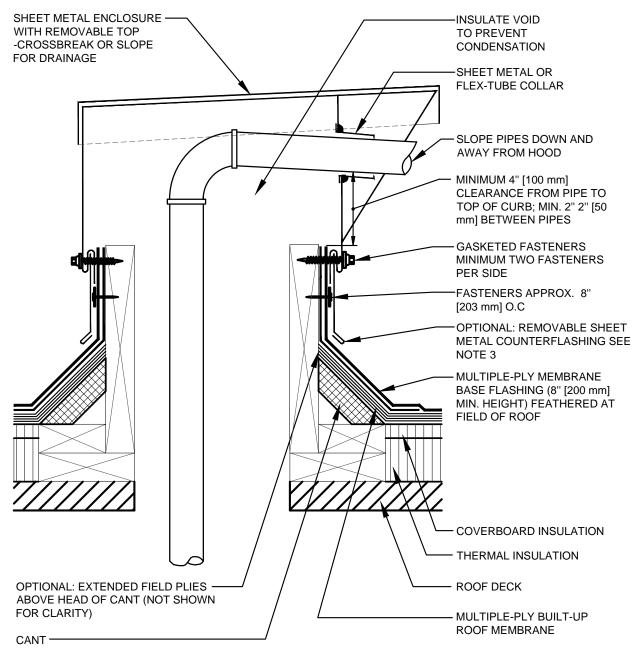SHEET METAL ENCLOSURE FOR PIPING THROUGH ROOF DECK

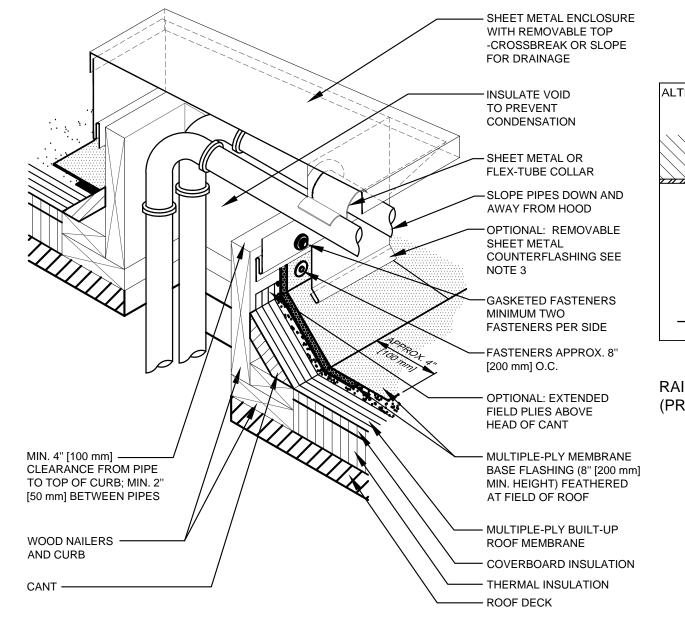


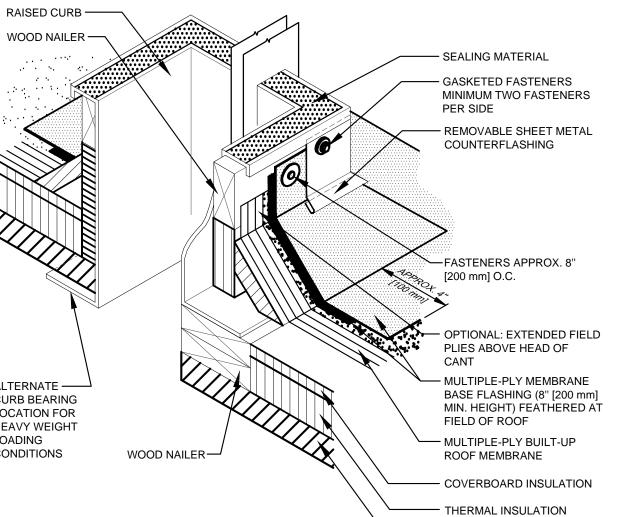

ROOF DECK

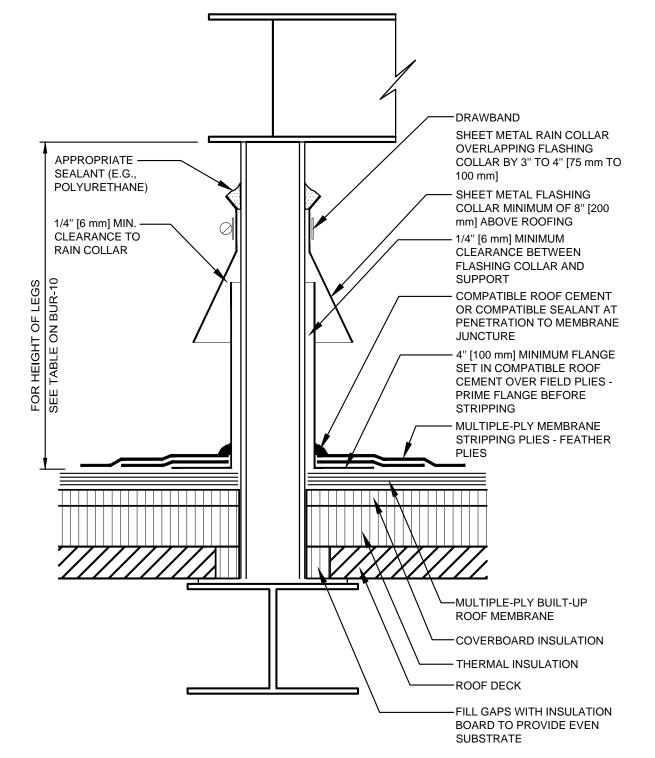


EQUIPMENT SUPPORT STAND AND TYPICAL RAIN COLLAR PENETRATION DETAIL NOT DRAWN TO SCALE

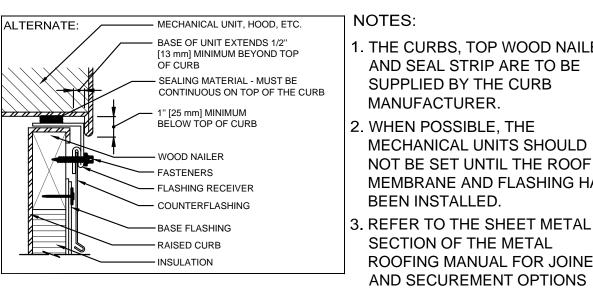

THE CURBS, TOP WOOD NAILER, AND SEAL STRIP ARE TO BE SUPPLIED BY THE CURB MANUFACTURER. . WHEN POSSIBLE, THE MECHANICAL UNITS SHOULD

MEMBRANE AND FLASHING HAVE BEEN INSTALLED. REFER TO THE SHEET METAL SECTION OF THE METAL **ROOFING MANUAL FOR JOINERY** AND SECUREMENT OPTIONS

FOR SHEET METAL. RAISED CURB DETAIL FOR ROOFTOP AIR HANDLING UNITS AND DUCTS (PREFABRICATED METAL CURB) NOT DRAWN TO SCALE

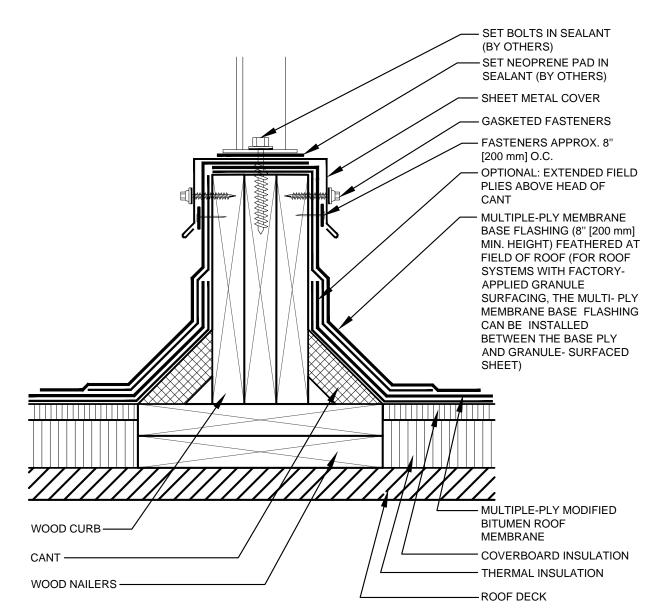



ARCHITECTURA **GROUP MIAMI**

ARCHITECTURE INTERIOR DESIGN PLANNING AA26001885 ID 00003873

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Description


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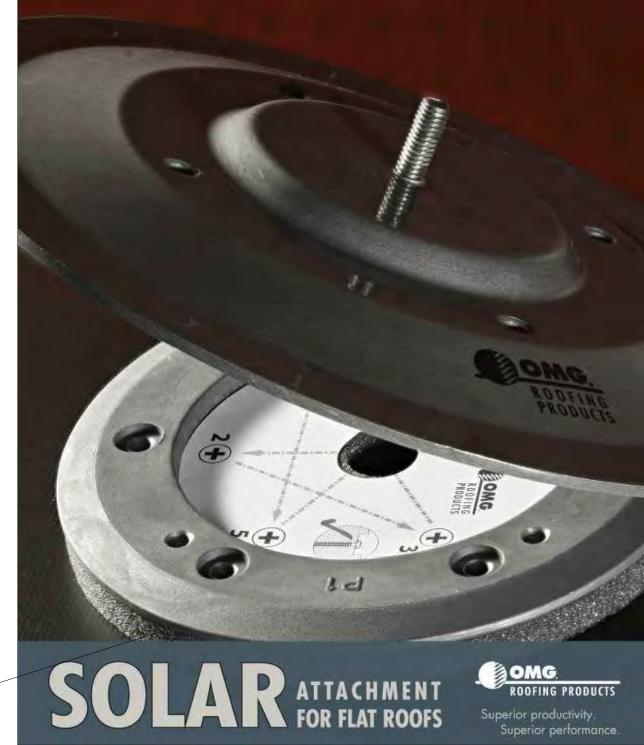
WEST RENO

Registered Architect # AR 94560

VARIOUS EQUIPMENT CURB DETAILS

Drawn by	N.P.
Checked by	E.P.
Project Number	269.20
Issued for	PERMIT
Issue date	Sheet #
06.01.20	A3.04
Scale	A3.U4



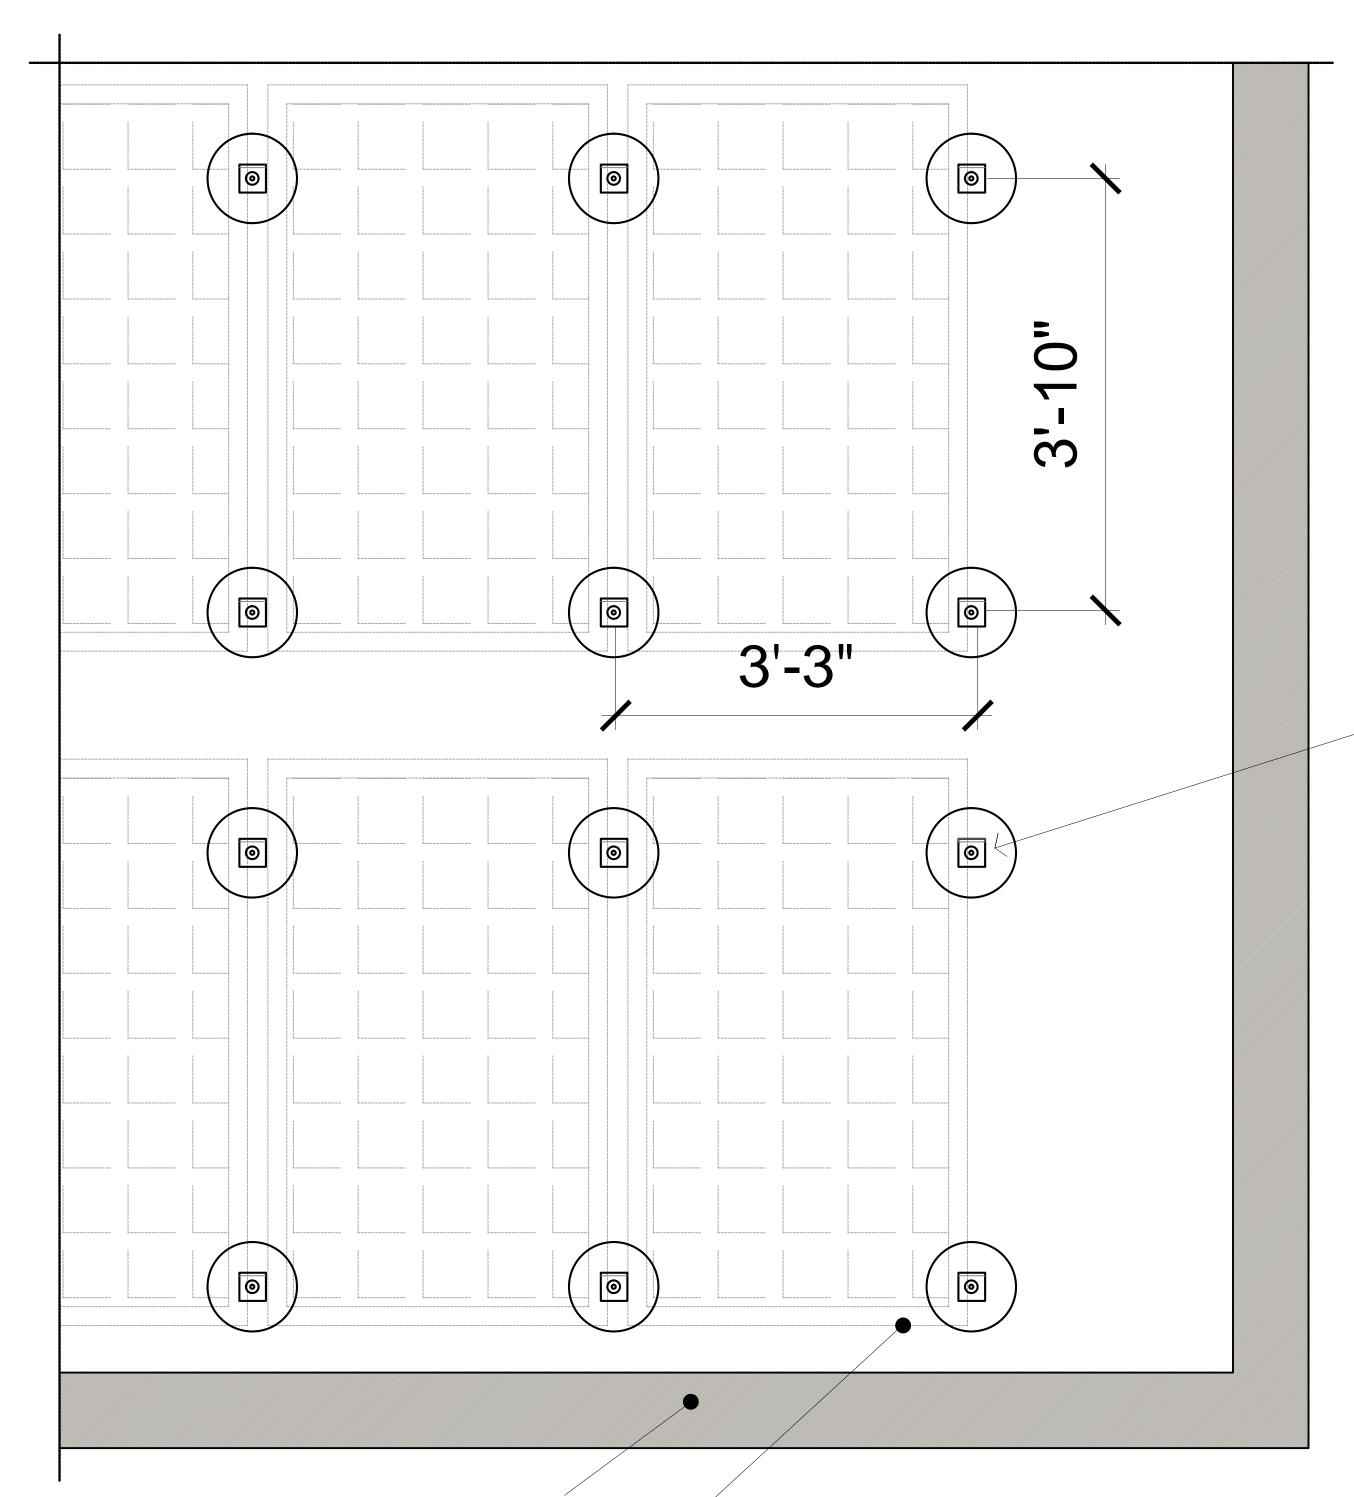

"OMG" SOLAR ATTACHMENT FOR FLAT ROOFS SYSTEM





ROOF PARAPET AS PER PLANS

FUTURE SOLAR PANELS AND SUPPORT SYSTEMS BY OTHERS

NOTE:

ROOF CONTRACTOR TO COORDINATE WITH OMG MFG. AND SOLAR ARRAY SUPPLIER / INSTALLER THE TYPE AND SPACING BETWEEN THE "POWER GRIP" SUPPORT DISKS AND INSTALLATION PROCEDURES AND INTERGATION WITH THE EPDM ROOF MEMBRANE



ARCHITECTURA GROUP MIAMI

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ssue		
No.	Date	Description

CHI - COMMUNITY
HEALTH of SOUTH

FLORIDA

KEY WEST Medical Center RENOVATION

SIGN & SEAL

OF FLOOR

CRISTIAN GAVRILACO

ARS 94560


SUPPORTS FOR
SOLAR GRID
SPECIFICATIONS

Drawn by
N.P.
Checked by
E.P.
Project Number
269.20
Issued for
PERMIT
Issue date

06.01.20

Scale
NTS

A3.05

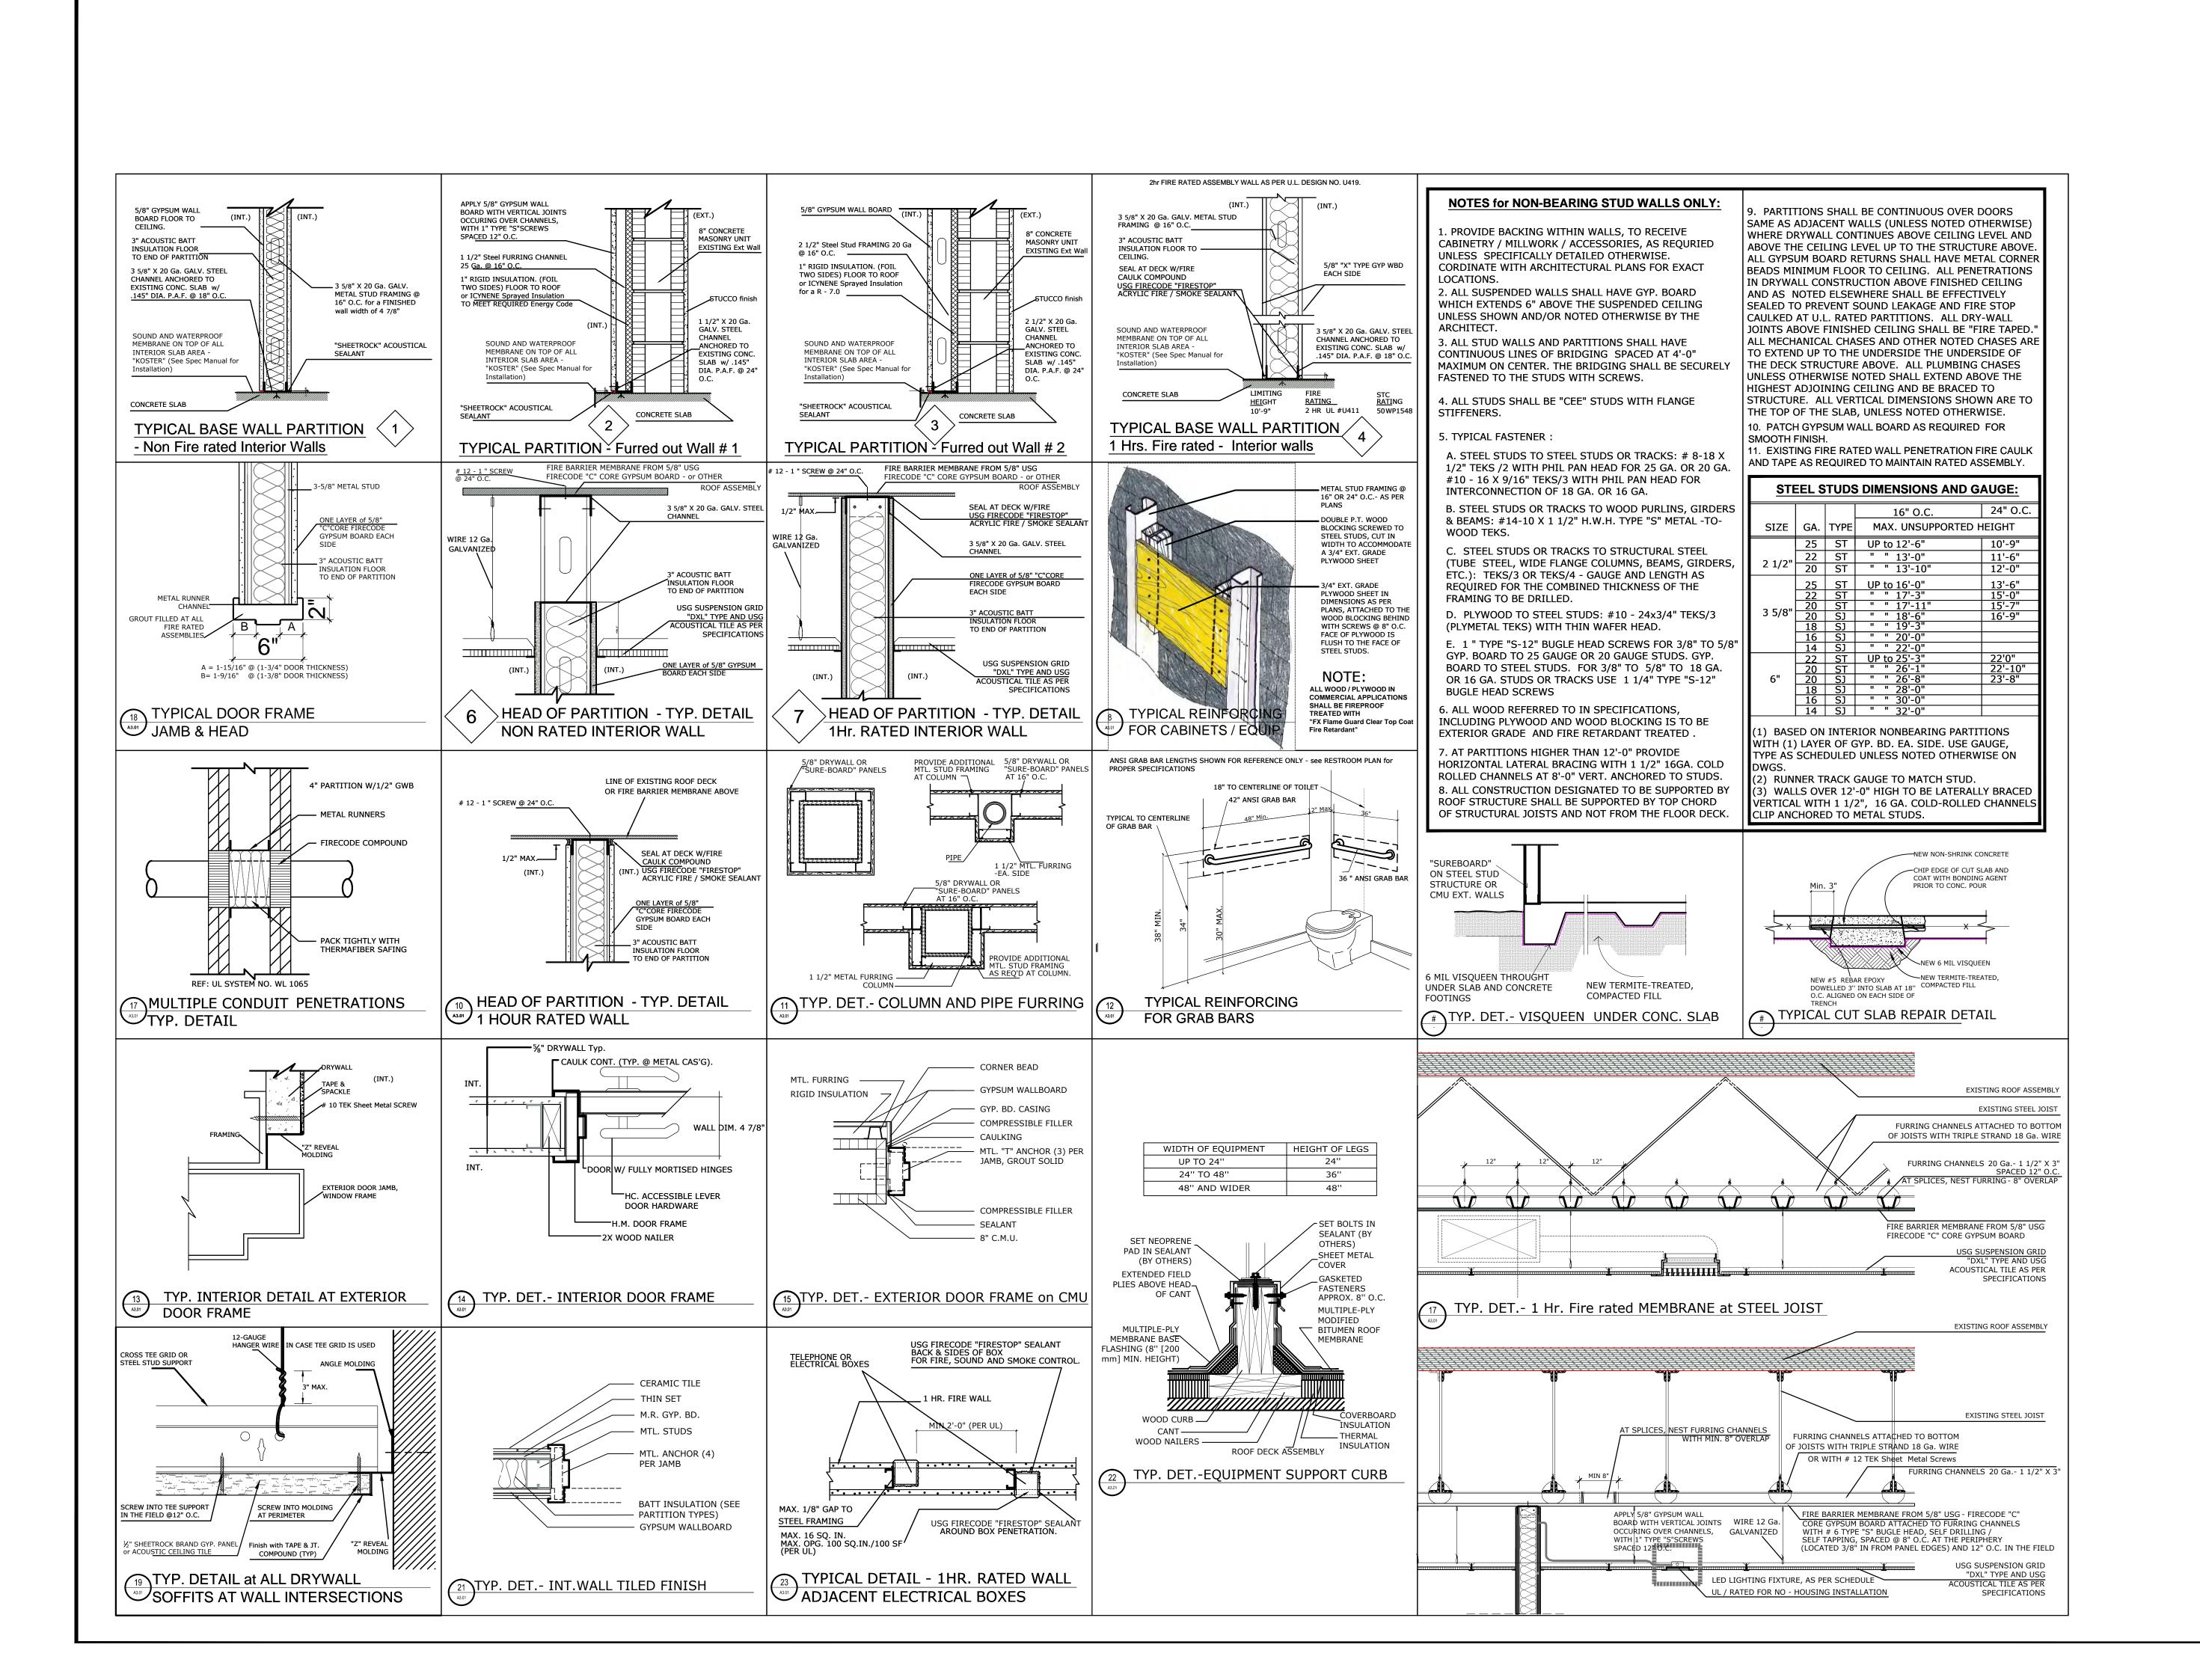



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ARCHITECTURE
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ID 00003873

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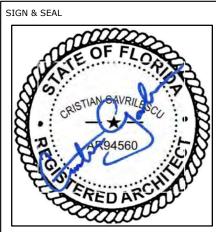
Date

Date Description

CHI - COMMUNITY
HEALTH of SOUTH

FLORIDA

/EST Medical Center ENOVATION



Registered Architect # AR 94560

TYPICAL DETAILS

Drawn by	N.P.
Checked by	E.P.
Project Number	269.20
Issued for	PERMIT
Issue date	Sheet #
06.01.20	A3.05
Scale	HJ.UJ

Scale NTS Limit the size of the deflection joint to no more than 1 inch in width. If larger sizes of deflection joint occur, please contact manufacturer for additional detail information.

Apply PorousPrep over raw edge of sheathing board.

FastFlash or

Non-Gassing

Polyethylene

Backer Rod ~

PorousPrep

Consolidate the cut

edges ofsheathing

Maximum 1" Deflection Joint

with PorousPrep

Foam

Concrete Slab

Joint & Seam Filler

Install non-gassing polyethylene foam backer rod into joint opening in preparation to receive Joint & Seam Filler.

Apply Joint & Seam Filler into opening, over-filling the joint to provide enough material to tool excess on both sides of the joint, about 1 inch on either side.

After Joint & Seam Filler has skinned over, apply a 4-inch-wide application of FastFlash banding over the Joint & Seam Filler in a bridge-joint configuration.

After FastFlash has skinned over, apply Cat 5 or another water- and air-resistive barrier over entire joint.

Cat 5, Spray Wrap MVP or VB

oint & Seam Fil

Non-Gassing

Backer Rod

Polyethylene Foam

Maximum 1"

FastFlash

Deflection Joint

Stud Track

PorousPrep

Concrete

Stud Wall

Slab

Consolidate and seal any raw, cut gypsum board edges by brushing or spraying on a thin uniform coat of PorousPrep.

Along the top edge of the non-vented parapet, apply a bead of FastFlash or Joint & Seam Filler to the seams between the back of the sheathing and the structural member, and 1 inch over the vertical Apply a thick bead of FastFlash or Joint & Seam Filler to the joint face on both sides of the parapet. Spread the wet product to create a seamless transition. Allow to skin over.


Apply a thick bead of FastFlash or Joint & Seam Filler down the center of the structural member. Wet-set the wood blocking. Mechanically fasten the wood blocking. Spot the head of all fasteners

that penetrate the wood blocking. Allow to skin over.

between the wood blocking and the top of the wall. Use a dry trowel or spatula to tool and seal the joint. Create a profile that directs bulk water away from the joint. Allow to skin over.

Blocking and Support for Coping FastFlash — Sheathing Wall OPTIONAL Waterproofing Coping FastFlash or Isolation Paper Joint & Seam Filler FastFlash Cat 5, Spray Wrap MVP or VB & Support for Coping


TYP. DETAILS FOR WATERPROOFING WITH "PROSOCO" R-GUARD / FastFlash Liquid Membrane

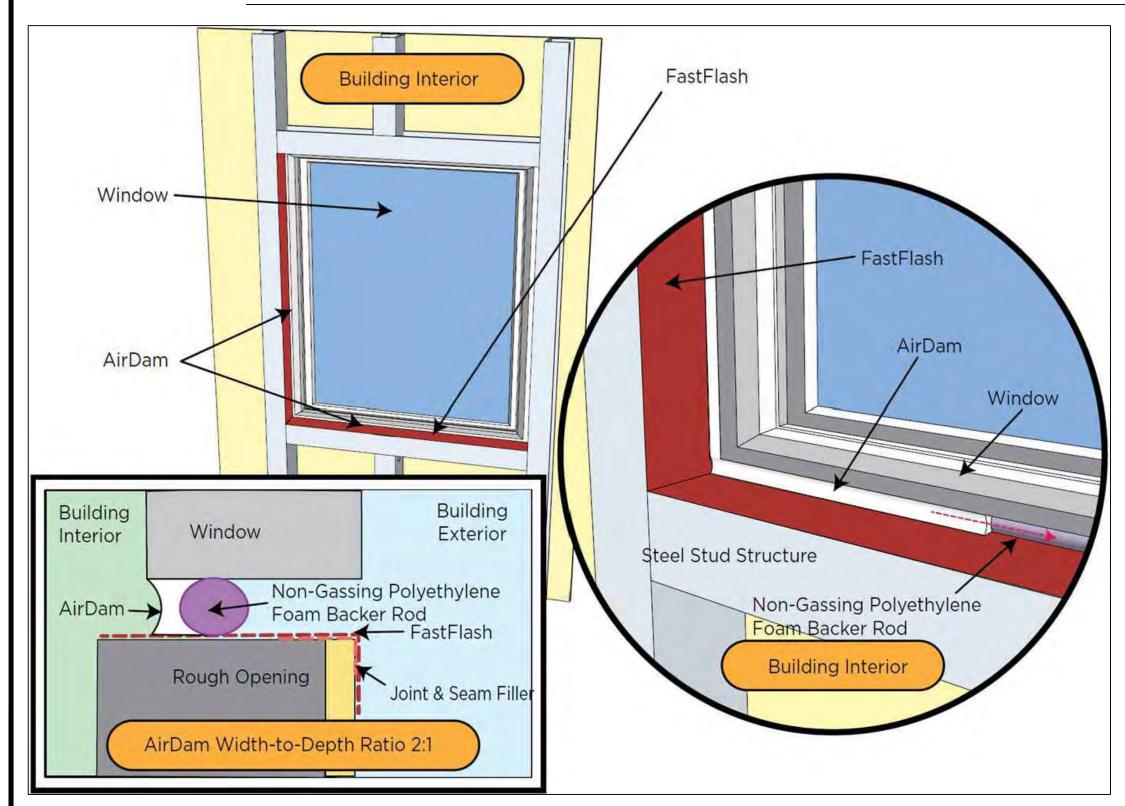

Tooled Joint

Tooled Joint

Joint & Seam Filler

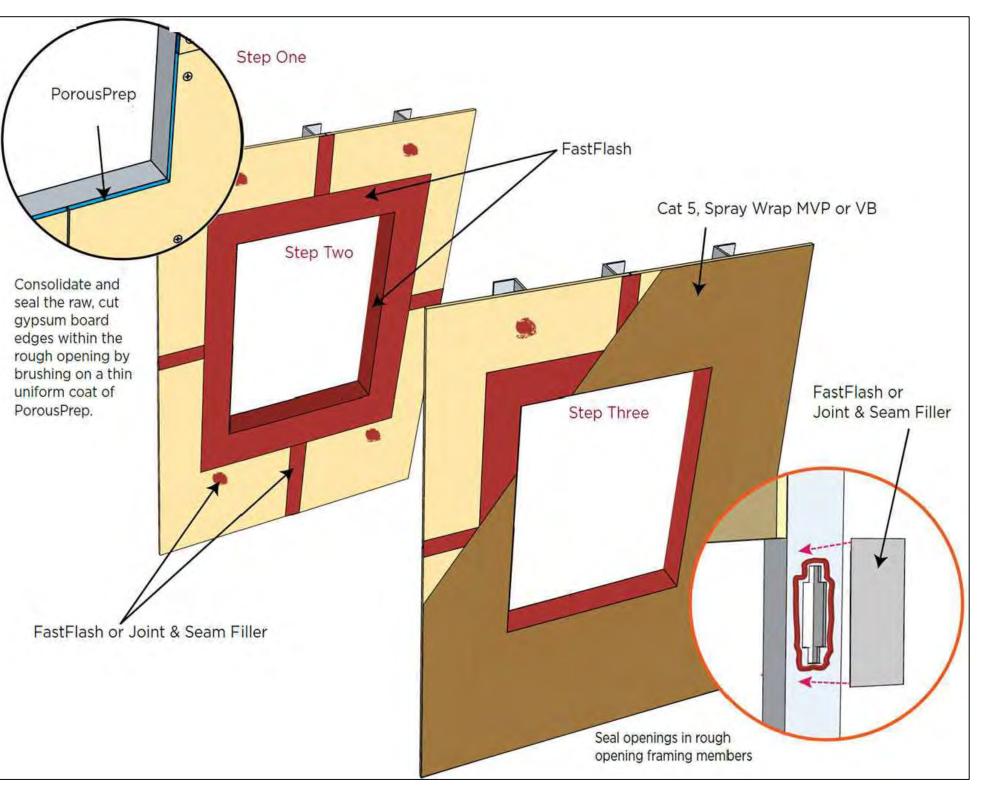



Spray Wrap MVP Product Data Sheet R-Guard Spray Wrap MVP

TYPICAL TECHNICAL DATA

FORM	batter like, semi-gel liquid pink color
SPECIFIC GRAVITY	1.40
pH	8,5 - 9.5
WT/GAL	11.69 lbs
ACTIVE CONTENT	no data
TOTAL SOLIDS	63-68%
VOC CONTENT	<18 g/L
FLASH POINT	not applicable
FREEZE POINT	32° F (0° C)
SHELF LIFE	2 years in tightly sealed, unopened container

Protect people, vehicles, property, plants and all other surfaces not intended for application. To ensure best results, apply to clean surfaces free of contaminants. Chemical residues, surface oxidation, surface coatings or films may adversely affect adhesion. Pressure-treated wood and other contaminated surfaces should be cleaned with an Isopropyl Alcohol wipe and allowed to flash-off before application of R-Guard products. Painted surfaces are not acceptable for application. Roofing systems must be capped and sealed or top of walls protected from water intrusion both before and after air barrier system installation. Water intrusion may interfere with bonding of air barrier waterproofing materials and/or detrimentally impact the performance of such materials.

preferred method for cleaning oxidation is with water and low-pressure cleaning. Concrete Surfaces: Concrete must be in place 3-7 days and free of any curing compounds or form release agents before permeable R-Guard products are applied. Brick/Masonry Surfaces: Mortar joints in CMU construction must have a minimum 3 day cure before being treated with R-Guard products. If joints are not struck flush, multiple coats may be required.

If considering use on insulated concrete forms, the

Sheathing: Remove and replace damaged sheathing. Surfaces to be coated must be continuous. On exterior sheathing, treat cracks with R-Guard Joint & Seam Filler and/or R-Guard FastFlash®, as needed. Sheathing gaps must be less than ¼ inch. For gaps larger than ¼ inch, apply FastFlash® with backer rod, or Joint & Seam Filler. Gap wood-based sheathing per manufacturer's recommendations.

typically 1/8 inch minimum. Consult a structural engineer for all moving cracks, and repair as needed.

Fill, Bridge & Flash 1. Fill surface defects and over driven fasteners with Joint & Seam Filler and/or FastFlash®.

2. Seal cut edges of gypsum board sheathing in rough openings, and where appropriate, with fast-drying R-Guard PorousPrep. Gun and spread Joint & Seam Filler and/or FastFlash® into all inside corners, cracks, open joints and seams, as needed. 3. Use FastFlash® to coat the improved rough opening

and out onto the exterior wall assembly face 4-6 inches (100–152 mm), creating a continuous waterproof membrane free of voids or pinholes. 4. Let all joint and seam fillers and rough opening treatments skin over before application. See individual product data sheets and R-Guard

Installation Guidelines for more information.

Surface and ambient air temperatures should be 25-100°F (-3°C to 38°C). Air and substrate temps must be at least 25°F (-3°C) and rising, and remain so for a minimum of 24 hours. Do not apply at temperatures below 25°F (-3°C). Wind and high temperatures will accelerate drying.

Hot Weather Conditions/Precautions: If air or surface temperatures exceed 95°F (35°C), apply to shaded surfaces and before daytime air and surface temperatures reach their peak. Hot surfaces may be cooled with a mist of fresh water. Surfaces may be damp but must be free of standing water before application. Keep containers closed and out of direct sunlight when not in use. Cover open pails with a wet towel as needed to prevent skinning.

Cold Weather Conditions/Precautions: Product may be applied to frost-free substrates at surface and air temperatures of 25°F (-3°C). Keeping material stored in a heated environment prior to use will help in these conditions.

Mix Spray Wrap MVP with a low-speed drill and clean mixing paddle. When roller applying, a maximum ¾ inch (19 mm) nap roller is recommended. R-Guard Spray Wrap MVP is compatible with

GRACO and Titan airless spray equipment with the following specifications: • Minimum 1.5–2 gallons output Immersion Feed • *Minimum hose diameter of 3/8-inch. NOTE: A ¼-inch x 3-foot whip hose may be used for

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R.Guard FastFlash®

Product Data Sheet R-Guard FastFlash*

YPICAL TECHNICAL DATA FastFlash*

FORM	viscous paste, mild odor red color
SPECIFIC GRAVITY	1.40 - 1.55
pH	not applicable
WT/GAL	11.75 - 12.5 lbs
TOTAL SOLIDS	99%
VOC CONTENT	30 g/L maximum
FLASH POINT	>200° F (>93° C)
FREEZE POINT	not applicable
SHELF LIFE	1 year in tightly sealed, unopened container

nred Properties	
Hardness, Shore A	35-45
Tensile Strength	>150 psi
Elongation at Break	>350% ASTM D 41
Water Vapor Transmission	21 perms ASTM E 96
Corrosive Properties	Non-corrosive

*Elongation per ASTM D 412 is not a requirement

of the Air Barrier Association of America's (ABAA) Acceptance Criteria for Liquid Applied Membranes nor is it a requirement of the International Code Council Evaluation Service's Acceptance Criteria for Water-Resistive Coatings used as Water-Resistive Barriers over exterior Sheathing (ICC-ES AC212). Elongation is not a requirement of the AAMA 714 Specification for Liquid Applied Flashing used to Create a Water-Resistive Seal Around Exterior Wall Openings. There is no data to support that certain levels of elongation must be achieved to perform as a fluid applied WRB or as a fluid applied flashing. Specifications should be based upon performance test results like those equired from the referenced organizations. Refer to the R-Guard FastFlash® Product Test Results documen for a complete list of performance test results.

o ensure best results, apply to clean surfaces free of contaminants. Chemical residues, surface oxidation, surface coatings or films may adversely affect adhesion. Pressure-treated wood and other contaminated surfaces should be cleaned with an Isopropyl Alcohol wipe and allowed to flash-off before application of R-Guard products.

way to the 3-foot whip hose.

Concrete must be in place 3-7 days and free of any curing compounds or form release agents before permeable R-Guard products are applied. Mortar joints in CMU construction must have a minimum 3 day cure before being treated with R-Guard

If considering use on insulated concrete forms, the preferred method for cleaning is with water and

Protect people, vehicles, property, plants and all other surfaces not intended to receive FastFlash Remove and replace damaged sheathing. In rough openings, and where appropriate, prepare all raw gypsum board edges with R-Guard PorousPrep. Apply to raw gypsum board edges in a thin, uniform coat according to published application instructions. Do not over apply. Allow to dry tack-free before application of R-Guard FastFlash or other products.

Any gaps or joints greater than 1 inch should be structurally repaired or readied for R-Guard SureSpan EX transition extrusion. Ensure positive drainage at all rough openings. Roofing systems must be capped and sealed or top of walls protected from water intrusion both before and after air barrier system installation. Water intrusion may interfere with bonding of air barrier waterproofing materials and/or detrimentally impact the performance of such materials.

Surface and ambient temperatures between 32 F

(0°C) and 110°F (43°C) are required for proper curing and drying of material to take place. Hot Weather Conditions/Precautions. When air or surface temperatures exceed 95°F (35°C), apply product to the shady side of structure before daytime air and surface temperatures reach their peak. Hot surfaces may be cooled with a mist of fresh water. Keep containers closed and out of direct sunlight when not in use. Do not apply when substrate temperature exceeds 110°F (43°C). Cold Weather Conditions/Precautions: Product may be applied to frost-free substrates at temperatures below 32°F (0°C). Product will not begin to cure until temperatures reach 32°F (0°C) and remain above freezing. Keeping material stored in a heated environment prior to use and misting applied

material with warm, fresh water will help in these

Low Humidity Conditions/Precautions: The process of curing may take longer when lower humidity levels occur. A light misting of fresh water over the treated surface will accelerate curing if necessary.

Product Data Sheet • Page 2 of 5 • Item #70400-70405 - 070119 • 02019 PROSOCO, Inc. • www.prosoco.com



CHI - COMMUNITY

HEALTH of SOUTH FLORIDA

architectura

ARCHITECTURA

GROUP MIAMI

ARCHITECTURE

INTERIOR DESIGN

PLANNING

AA26001885

ID 00003873

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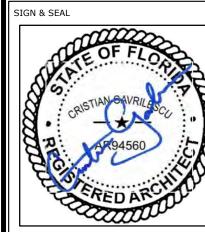
GROUP MIAMI TO BE NOTIFIED IN WRITING O

ANY VARIATION FROM THE DIMENSIONS CONDITIONS AND SPECIFICATIONS APPEARING ON THESE PLANS (c) 2020.

Description

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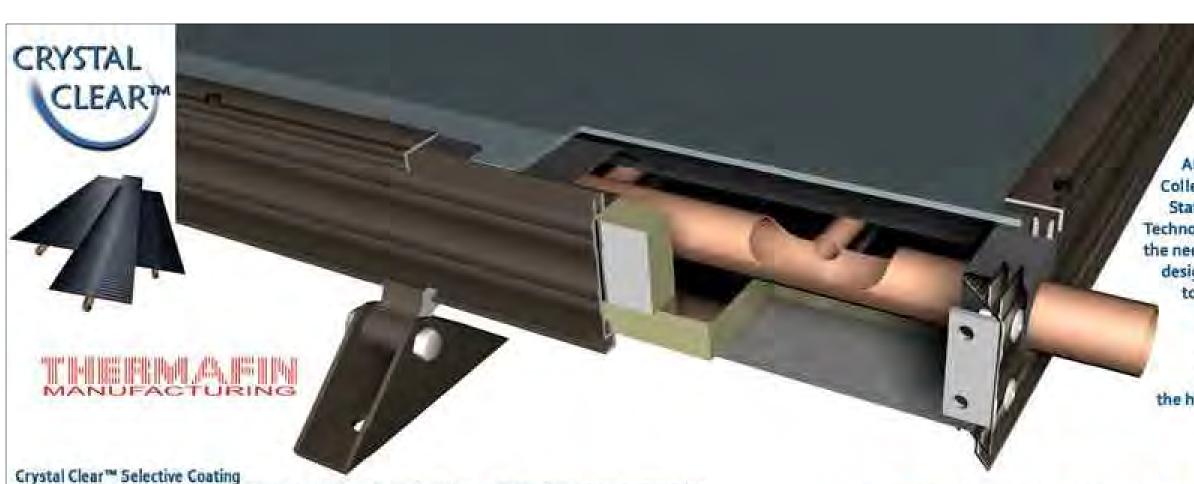


Registered Architect # AR 94560

WINDOWS AND **DOORS OPENINGS** WATERPROOFING

Drawn by	N.P.
Checked by	E.P.
Project Number	269.20
Issued for	PERMIT
Issue date	Sheet #
06.01.20	A4.01
Scale	M4.UI

DETAILS



AE-Series "Flat Panel" Solar Thermal Collectors, manufactured in The United States of America by Alternate Energy Technologies (AET), are designed to meet the needs of any solar system. Our expert design team will assist in sizing any job to provide hot water, space heating, radiant floor heating or industria process heat. AET is dedicated to building our AE-Series Collectors from the finest materials and with the highest standards of craftsmanship

The Crystal Clear ** Solar-Selective coating is technically a Quartz Encapsulated Bimetallic Alloy. Thousands of nanocrystalline growth projections dramatically increase the surface area of the absorber plate for maximum solar radiation absorption and performance. Crystal Clear™ has been tested for over 14.50 hours at 61.7* F continuously with minimal visible or physical degradation of its thermal characteristics. Furthermore, Crystal Geor™ enhances the thermal performance of the absorbers by an additional 3%. The finished coating hosts an Absorptivity of > 0.96 & Emissivity of < 0.08

THERMAFIN™ Absorbers

AET Introduced THERMAFIN™ absorbers into the AE-Series collecors in 1996. Through extensive research and development, we have employed the best heat transfer method in the world today. THERMAFIN's high-frequency, forge weld process molecularly bonds the fin to the tube providing long-lasting performance and durability while allowing the highest heat conduction. The high-frequency welded joints will not weaken, expand, or pull apart and are backed by a written 30 year quarantee.

Electrostatically Painted C-Channel Construction

Our AE-Series Collector frames are fabricated in our state-of-the-art manufacturing plant located in Jacksonville, Florida. Crafted using aluminum extrusions with electrostatically applied bronze polyester paint and securely fastened with aircraft. grade pin grip rivets, AE-Series Collectors are built to withstand the most demanding environments.

COULUTION	1 Jan - 2 / 14	W. LECK	A SOLUTION	1.1-69/1	1337	All-An
Length (in)	85.187	97.187	77.187	85.187	97.187	121.18
Width (in)	35.187	35.187	47.187	47.187	47.187	47.187
Height (in)	3.137	3.137	3.137	3.137	3.137	3.137
Gross Area (ft²)	20.8	23.7	25.3	27.9	31.8	39.7
Fluid Capacity (gals)	0.70	0.76	0.90	0.96	1.05	1.22
Dry Weight (lbs)	74	84	90	99	113	153

All AE-Series Collectors Feature:

- Wind load tested to allowable loads of 51 PSF
- Crystal Clear™ selective coatings
- Extruded aluminum frame and battens
- Thermax™ polyisocyanurate foam insulation
- Aircraft aluminum pin grip rivets
- *30+ year design life
- *10 year warranty
- *Proudly made in the U.S.A.
- THERMAFIN ™ absorber plates









AE-Series Solar Collectors • Manufactured by Alternate Energy Technologies (AET), LLC

Glazing:

Low-Iron tempered glass, exclusively using our "High-T" tempered glass, with a total solar energy transmission

Collector Frame and Battens: Type 6063-T6 extruded aluminum

frame and battens with electrostatic bronze plate finish that facilitates long life and strength.

Insulation:

Polyisocyanurate foam board insulation. Foll-faced, glass fiberreinforced, rigid board Thermax sheathing (1-1/4" in the bed / 3/4" in the sidewalls).

Mounting Hardware:

The variable"Quick Lock" mounting hardware reduces mounting time and makes it simple for anyone to install. The Quick Lock System allows the highest flexibility in mounting and is tested to allowable loads of 51 PSF. Mounting possibilities include: Pitched roof, Flat roof, Ground, Balcony, and Facade mounting.

Design Life: 30 Years Warranty: 10 Years Working Pressure: 165 PSI Flow Rate: 0.5 to 1.8 GPM (recommended)

AE-Series Collectors

with exclusive - selective "Crystal Clear" inside



SPECIFICATIONS						
Collector	AE-21	AE-24	AE-26	AE-28	AE-32	AE-40
Length (in)	85.187	97.187	77.187	85.187	97.187	121.187
Width (in)	35.187	35.187	47.187	47.187	47.187	47.187
Height (in)	3.137	3.137	3.137	3.137	3,137	3.137
Gross Area (ft²)	20.8	23.7	25.3	27.9	31.8	39.7
Fluid Capacity (gals)	0.70	0.76	0.90	0.96	1.05	1.22
Dry Weight (lbs)	74	84	90	99	113	153

Absorber Plate:

Manufactured by ThermafinTH Mfg., a 100% copper absorber plate, the fin and the riser tube are molecularly bonded by highfrequency forge welding.

Absorber Coating:

Exclusively by Thermafin™ Mfg., a Selective "Crystal Clear" Coating. $\alpha = 0.96$ $\epsilon = 0.08$

Gasket Grommets:

A UV durable EPDM, U-channel gasket with molded corners which prohibits water penetration and assures long life. Extruded Silicone Grommet with 1-1/8" Bore.

Corner Bracket:

Architectural aluminum angles inside with aircraft-grade pin grip rivets to ensure high stability.

Fasteners:

5056 Aluminum rivets secure the backsheet. Batten screws are 18-8 SS, 10-24 x 3/8", hex head screws, and black oxide coated.

Backsheet:

Type 3105-H14, 0.019" stucco embossed aluminum sheet (bronze) pop-riveted to aluminum frame.

NOTE:

SOLAR PANEL SHALL BE MOUNTED IN STRICT REQUIREMNTS OF AET SOLAR MSC SERIES HIGH WIND STANDARDS

CODE APPROVALS

AE-Series Collectors have been designed and constructed to meet major applicable nationwide codes, including the following:

Solar Rating and Certification Corporation SRCC Standard 100 - Test Methods and Minimum Standards for Certifying Solar Collectors (ASHRAE Std 93-1986)

Florida Solar Energy Center - Test Methods and Minimum Standards for Solar Collectors (ASHRAE Std 93-1986)

Miami Testing Laboratory Wind Load Test (ASTM E 3300) Certification No. 94-1028.01

International Association of Plumbing Mechanical Official (IAPMO) Uniform Solar Energy Code (USEC) File No. S-5038

International Testing

Bodycote Materials Testing Canada Inc. Report No. 02-08-0513

TÜV Bayern Sachen e.V. (DIN 4757) Report No. 28600399

Bundesforschungs - und Prüfzentrum Arsenal ÖNORM M 7714 - Order No. M 4 015

AE-Series Collectors Mounting Hardware Options Flush Mount Standard Mount Rack Mount System System System Tilt Mount Assembly 1" Aluminum Square Tube -(strut) Installation Side View AET's exclusive "Quick Lock" mounting systems allow for virtually any collector orientation and mounting. Collectors can be mounted to any roof, vertical wall, fascia boards, preconstructed racks or ground mount systems. The framewall and mount have been certified to withstand allowable loads of 51 PSF. The framewall will accept the mounts anywhere around the collector without drilling or tapping, so the integrity of the framewall is not

violated. The rear struts can be cut to any length allowing proper elevation and orientation.

architectura miami

ARCHITECTURA **GROUP MIAMI**

ARCHITECTURE INTERIOR DESIGN PLANNING AA26001885 ID 00003873

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RESPONSIBLE FOR DIMENSIONS AND
CONDITIONS OF THE JOB AND ARCHITECTURA GROUP MIAMI TO BE NOTIFIED IN WRITING O ANY VARIATION FROM THE DIMENSION CONDITIONS AND SPECIFICATIONS APPEARI ON THESE PLANS (c) 2020.

Description

CHI - COMMUNITY HEALTH of SOUTH

FLORIDA

WEST RENOV



Registered Architect # AR 94560

SOLAR WATER HEATER **SPECIFICATIONS**

Drawn by	N.P.
Checked by	E.P.
Project Number	269.20
Issued for	PERMIT
Issue date	Sheet #
06.01.20	Δ4 Ω2
Scale	A4.02